

SAINT FRANCIS HIGH SCHOOL

MODIFICATION TO THE CENTER FOR INNOVATION & DINING COMMONS PROJECT

ORIGINALLY APPROVED PER PERMIT #2017-346

1885 MIRAMONTE AVENUE  
MOUNTAIN VIEW, CA 94040



HMC Architects

3445011000

2495 Natomas Park Drive, Studio 100  
Sacramento, CA 95833  
T 916 325 1100 / www.hmcarchitects.com



Consultant:

Agency Approval:

File No.:

Facility:  
Saint Francis High School  
1885 Miramonte Ave  
Mountain View, CA 94040

Project:  
Modification to the Center for Innovation & Dining Commons

Sheet Title:  
COVER SHEET

PLANNING SUBMITTAL

Date: 02/04/2022	Client Project No: 3445011000
Sheet:	





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MODIFICATION TO THE CENTER FOR INNOVATION & DINING COMMONS PROJECT

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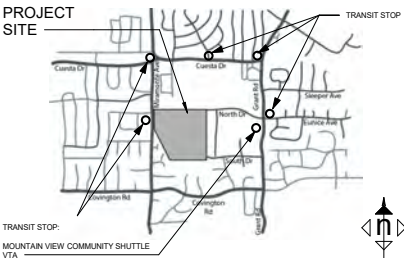
04/15/2022

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OWNER	ARCHITECT	CIVIL	LANDSCAPE	ELECTRICAL	SHEET INDEX																																																				
SAINT FRANCIS HIGH SCHOOL 1885 MIRAMONTE AVE. MOUNTAIN VIEW, CA 94040 (408) 437-7000	HMC ARCHITECTS 2495 NATOMAS PARKDRIVE, STUDIO 100, SACRAMENTO, CA 95833 (916)-325-1100	BKF ENGINEERS 1730 NORTH FIRST STREET, SUITE 600 SAN JOSE, CA 95112 (408) 467-9100	MTW GROUP 2707 K STREET, STE. 201, SACRAMENTO 95816 (916) 369-3990	TL ELECTRIC INC. 2239 OLD MIDDLEFIELD RD., STE. #A. MOUNTAIN VIEW, CA 94043 (650) 967-7254	<b>GENERAL:</b> G0.00 COVER SHEET G0.10 PROJECT INFORMATION AND SHEET INDEX G0.11 SYMBOLS AND ABBREVIATIONS  <b>ARCHITECTURAL RENDERINGS AND PERSPECTIVES:</b> A0.1A SITE SECTIONS A0.1B STREET SCAPE ELEVATIONS A0.1C NEIGHBORHOOD AND CAMPUS CONTEXT IMAGES A0.2 BIRDS EYE VIEW A0.3 DESIGN RENDERINGS A0.4 DESIGN RENDERINGS  <b>ARCHITECTURAL DRAWINGS:</b> A1.0 SITE PLAN -AS APPROVED PER PERMIT # PL2017-346 A1.1 OVERALL SITE PLAN A1.2A EXISTING PARKING PLAN A1.2B EXISTING PARKING PLAN W/ PROPOSED BUILDING A1.3A EXISTING ZONING ORDINANCE GRAPHIC CALCULATION A1.3B PROPOSED ZONING ORDINANCE GRAPHIC CALCULATION A1.3C GRAPHIC FLOOR AREA CALCULATION A1.4 ENLARGED SITE PLAN A1.5 CIRCULATION SITE PLAN A1.6 FIRE ACCESS SITE PLAN A1.7 VISION TRIANGLE DIAGRAMS A1.8 DIAGRAMATIC BUILDING SECTIONS A2.1A BUILDING 100 - FIRST FLOOR PLAN A2.2A BUILDING 100 - SECOND FLOOR PLAN A4.1A BUILDING 100 - ROOF PLAN A5.1A BUILDING 100 - EXTERIOR ELEVATIONS A5.1A.1 BUILDING 100 - (E) EXTERIOR ELEVATIONS (PL2017-346) A5.1A.2 BUILDING 100 - EXTERIOR ELEVATIONS A5.2A BUILDING 100 - ENLARGED EXTERIOR MATERIAL PATTERN DETAIL A5.3A MATERIAL BOARD A6.1A BUILDING 100 - BUILDING SECTIONS A10.1 DETAILS / MATERIAL TRANSITIONS A10.2 DETAILS / MATERIAL TRANSITIONS A10.3 DETAILS / MATERIAL TRANSITIONS A10.4 DETAILS / MATERIAL TRANSITIONS  <b>LANDSCAPE DRAWINGS:</b> L0.0 SITE PAVING & AMENITIES COLOR PLAN L0.1 HERITAGE TREE AND EXISTING LANDSCAPE PLAN L0.2 SITE DIMENSIONS L0.3 SITE PAVING AND AMENITIES PLAN L0.4 SITE MATERIAL BOARD L0.5 SITE INSTALLATION DETAILS L1.1 TREE PLANTING PLAN L2.1 TURF/SHRUBS PLANTING PLAN L3.1 LANDSCAPE IRRIGATION PLAN L4.1 LANDSCAPE PLANTING DETAILS L4.2 LANDSCAPE IRRIGATION DETAILS  <b>CIVIL DRAWINGS:</b> C2.2 ON-SITE STORMWATER MANAGEMENT AND GRADING PLAN C2.4 ON-SITE UTILITY PLAN C3.1 ON-SITE EROSION CONTROL PLAN  <b>ELECTRICAL DRAWINGS:</b> EP1.1 ELECTRICAL ONSITE LIGHTING PHOTOMETRIC PLAN EP1.2 ELECTRICAL ONSITE LIGHTING FIXTURE CUT SHEETS EP1.3 ELECTRICAL ONSITE PARKING LIGHTING FIXTURE CUT SHEETS  <b>DAYLIGHT STUDY DRAWINGS:</b> A20.1 DAYLIGHT STUDY A20.2 DAYLIGHT STUDY A20.3 DAYLIGHT STUDY A20.4 SOLAR RADIATION STUDY A20.5 SHADOW STUDY A20.6 SHADOW STUDY  <b>FIRE AND BUILDING CODE DRAWINGS:</b> A30.1 CODE ANALYSIS A30.2 EXITING/CODE ANALYSIS - FIRST FLOOR A30.3 EXITING/CODE ANALYSIS - SECOND FLOOR  TOTAL COUNT: 62																																																				
PROJECT DATA	PROPOSED BUILDING MODIFICATIONS	APPLICABLE CODES	PROJECT DESCRIPTION	CONSTRUCTION PHASING																																																					
EXISTING BUILDINGS PREVIOUSLY APPROVED UNDER PERMIT NUMBER 2017-346 (SEE ORIGINAL APPROVED SET PROJECT DATA ONLY PROPOSED INFORMATION)  NO. OF STORIES: Building 100: 1 Building 300: 1  SQUARE FOOTAGE: Building 100: 21,425 sf Building 300: 20,924 sf Total 42,349 sf  FOOTPRINT BUILDING 100 21,425 sf BUILDING 300 20,924 sf Total 42,349 sf  SITE SQUARE FOOTAGE: Footprint Coverage: 186,439 sf Total Building Areas: 287,335 sf	OCCUPANCY TYPE: A-2, E, B & S-2 CONSTRUCTION TYPE: II - A AUTOMATIC SPRINKLERS THROUGHOUT: YES NO. OF STORIES: 2 F.A.R. SQUARE FOOTAGE: PL-2017-346 PER FLOOR: (Bldg 300) (Bldg 100 + W.Ctr. + Dbl. Vol.)   Proposed 1st Floor (29,430 gsf) * + (18,048 gsf) * + 8,711 = 56,189 2nd Floor (30,093 gsf) * + ( 9,547 gsf) * + 8,016 + 5,718 = 53,374 Total 59,523 sf * + 27,595sf * + 16,727 + 5,718 = 109,563  FOOTPRINT (Bldg 1st Flr. outline) Building 100 (PL-2017-346 & Welcome Center)* 26,759 sf Building 300 (PL-2017-346)* 29,430 sf Total 56,189 sf  SITE SQUARE FOOTAGE: Footprint Coverage: 203,172 sf Total Building Areas: 362,312 sf  BUILDING SQUARE FOOTAGE W/ CANOPY & TRELLIS Building 100 (PL-2017-346)* 36,342 gsf Building 300 (PL-2017-346)* 60,581 gsf Proposed Welcome Center 17,657 gsf Total 114,580 gsf  *NO PROPOSED CHANGES	THE DESIGN OF THIS PROJECT CONFORMS TO THE REQUIREMENTS OF THE CALIFORNIA CODE OF REGULATIONS (C.C.R.)-WITH LATEST ADOPTED AMENDMENTS  2019 CALIFORNIA ADMINISTRATIVE CODE  2019 CALIFORNIA BUILDING CODE WITH MOUNTAIN VIEW CITY CODE AMENDMENTS (2018 INTERNATIONAL BUILDING CODE)  2019 CALIFORNIA ELECTRICAL CODE (2017 NATIONAL ELECTRICAL CODE, NEC)  2019 CALIFORNIA MECHANICAL CODE (2018 UNIFORM MECHANICAL CODE, UMC)  2019 CALIFORNIA PLUMBING CODE (2018 UNIFORM PLUMBING CODE, UPC)  2019 CALIFORNIA GREEN BUILDING STANDARDS CODE (MOUNTAIN VIEW CITY CODE AMENDMENTS)  2019 CALIFORNIA FIRE CODE WITH MOUNTAIN VIEW CITY CODE AMENDMENTS (2018 INTERNATIONAL FIRE CODE, IFC)  TITLE 24 (PART 6) CALIFORNIA ENERGY CODE (2019 EDITION)  TITLE 24 HANDICAPPED ACCESSIBILITY REGULATIONS (2019 EDITION)	1. ADDITIONAL ADMINISTRATION SPACE TO BUILDING 100 FROM APPROVED PERMIT (PL-2017-346)	PHASE 1A: DEMOLITION OF EXISTING BUILDING 300 AND CONSTRUCTION OF CENTER FOR INNOVATION  PHASE 1B: DEMOLITION OF EXISTING BUILDING 100 AND CONSTRUCTION OF DINING COMMONS AND SITE IMPROVEMENTS  NO CHANGES TO CONSTRUCTION PHASING TO APPROVED PERMIT NO. PL-2017-346.  DEFERRED APPROVALS  1. FIRE SPRINKLER SYSTEM 2. AUTOMATIC FIRE ALARM SYSTEM 3. GLASS RAILING SYSTEM 4. STOREFRONT SYSTEMS 5. ELEVATOR																																																					
ZONING INFORMATION	SAINT FRANCIS HIGH SCHOOL CENTER FOR INNOVATION & DINING COMMONS APN. 193-29-012 ZONING PERMIT # PL-2017-346  DATA TABLE FOR COMPLIANCE WITH R-1 DEVELOPMENT STANDARDS <table><tr><th></th><th>R-1-7.5</th><th>SAINT FRANCIS HIGH SCHOOL</th><th>WELCOME CENTER (PROPOSED)</th></tr><tr><td>LOT AREA</td><td>6,000 SF MINIMUM (INTERIOR LOT) 7,000 SF MINIMUM (CORNER LOT)</td><td>1,087,415 SF (24.96 AC.)</td><td>1,087,415 SF (24.96 AC.)</td></tr><tr><td>LOT WIDTH</td><td>60' MINIMUM (INTERIOR LOT) 70' MINIMUM (CORNER LOT)</td><td>689'</td><td>689'</td></tr><tr><td>DENSITY</td><td>1 DWELLING PER PARCEL</td><td>N/A</td><td>N/A</td></tr><tr><td>BLDG. COVERAGE</td><td></td><td>17.8% OF LOT AREA 194,461 sf 194,461 / 1,087,415 = .178</td><td>18.6% OF LOT AREA 203,172 sf 203,172 / 1,087,415 = .186</td></tr><tr><td>FLOOR AREA RATIO</td><td>10,000 SF AND MORE LOT AREA: .40</td><td>.317 345,585 sf 345,585 / 1,087,415 = .317</td><td>.327 362,312 sf 362,312 / 1,087,415 = .333</td></tr><tr><td>SETBACKS FRONT SIDES REAR</td><td>20' MINIMUM 10' MINIMUM &amp; 25' TOTAL FOR BOTH SIDES 20' MINIMUM &amp; 40' MAXIMUM, REQUIRED</td><td>117'-1" +/- 308' (S), 52'-6" (N) +/- 738'</td><td>117'-1" +/- 308' (S), 52'-6" (N) +/- 738'</td></tr><tr><td>HEIGHT (MEASURED FROM T.O.C. ALONG MIRAMONTE)</td><td>28' MAXIMUM FOR 2-STORIES</td><td>BUILDING 100: ROOF 27' - 0"; PARAPET 33' - 0" BUILDING 300: ROOF 27' - 4 3/4"; PARAPET 36' - 11 1/4"</td><td>WELCOME CENTER: ROOF 27' - 0"; PARAPET 33' - 0"</td></tr><tr><td>LANDSCAPING</td><td>50% OF THE REQUIRED FRONT SETBACKS</td><td>+60.9%</td><td>+60.9%</td></tr><tr><td>PARKING</td><td>PARKING STUDY REQUIRED</td><td>PARKING STUDY REQUIRED 712 (ON CAMPUS) 490: SFHS PROPERTY 210: LEASE AGREEMENT WITH EL CAMINO HOSPITAL 12: AGREEMENT WITH VILLA SIENNA</td><td>PARKING STUDY REQUIRED 712 (ON CAMPUS) 490: SFHS PROPERTY 210: LEASE AGREEMENT WITH EL CAMINO HOSPITAL 12: AGREEMENT WITH VILLA SIENNA</td></tr><tr><td>ACCESSIBLE PARKING:</td><td></td><td>2% OF TOTAL COUNT (OF 712)= 15 REQUIRED 15 ACCESSIBLE PARKING STALLS PROVIDED</td><td>2% OF TOTAL COUNT (OF 712)= 15 REQUIRED 15 ACCESSIBLE PARKING STALLS PROVIDED</td></tr><tr><td>BICYCLE PARKING</td><td></td><td>63 STALLS EXISTING (NO CHANGE)</td><td>88 NEW STALLS; 151 TOTAL STALLS</td></tr><tr><td>ENROLLMENT</td><td></td><td>1,760 STUDENTS</td><td>0 STUDENTS ADDED, NO CHANGE IN ENROLLMENT</td></tr></table>						R-1-7.5	SAINT FRANCIS HIGH SCHOOL	WELCOME CENTER (PROPOSED)	LOT AREA	6,000 SF MINIMUM (INTERIOR LOT) 7,000 SF MINIMUM (CORNER LOT)	1,087,415 SF (24.96 AC.)	1,087,415 SF (24.96 AC.)	LOT WIDTH	60' MINIMUM (INTERIOR LOT) 70' MINIMUM (CORNER LOT)	689'	689'	DENSITY	1 DWELLING PER PARCEL	N/A	N/A	BLDG. COVERAGE		17.8% OF LOT AREA 194,461 sf 194,461 / 1,087,415 = .178	18.6% OF LOT AREA 203,172 sf 203,172 / 1,087,415 = .186	FLOOR AREA RATIO	10,000 SF AND MORE LOT AREA: .40	.317 345,585 sf 345,585 / 1,087,415 = .317	.327 362,312 sf 362,312 / 1,087,415 = .333	SETBACKS FRONT SIDES REAR	20' MINIMUM 10' MINIMUM & 25' TOTAL FOR BOTH SIDES 20' MINIMUM & 40' MAXIMUM, REQUIRED	117'-1" +/- 308' (S), 52'-6" (N) +/- 738'	117'-1" +/- 308' (S), 52'-6" (N) +/- 738'	HEIGHT (MEASURED FROM T.O.C. ALONG MIRAMONTE)	28' MAXIMUM FOR 2-STORIES	BUILDING 100: ROOF 27' - 0"; PARAPET 33' - 0" BUILDING 300: ROOF 27' - 4 3/4"; PARAPET 36' - 11 1/4"	WELCOME CENTER: ROOF 27' - 0"; PARAPET 33' - 0"	LANDSCAPING	50% OF THE REQUIRED FRONT SETBACKS	+60.9%	+60.9%	PARKING	PARKING STUDY REQUIRED	PARKING STUDY REQUIRED 712 (ON CAMPUS) 490: SFHS PROPERTY 210: LEASE AGREEMENT WITH EL CAMINO HOSPITAL 12: AGREEMENT WITH VILLA SIENNA	PARKING STUDY REQUIRED 712 (ON CAMPUS) 490: SFHS PROPERTY 210: LEASE AGREEMENT WITH EL CAMINO HOSPITAL 12: AGREEMENT WITH VILLA SIENNA	ACCESSIBLE PARKING:		2% OF TOTAL COUNT (OF 712)= 15 REQUIRED 15 ACCESSIBLE PARKING STALLS PROVIDED	2% OF TOTAL COUNT (OF 712)= 15 REQUIRED 15 ACCESSIBLE PARKING STALLS PROVIDED	BICYCLE PARKING		63 STALLS EXISTING (NO CHANGE)	88 NEW STALLS; 151 TOTAL STALLS	ENROLLMENT		1,760 STUDENTS	0 STUDENTS ADDED, NO CHANGE IN ENROLLMENT
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*SEE SHEETS A1.3A, A1.3B, AND A1.3C FOR GRAPHIC AREA CALCULATIONS																																																									

EVCS CALCULATION (NEW PARKING)	SITE PARKING TABULATION		
PROPOSED PARKING (BLDG 100 & 300) 100 TOTAL	VEHICLE PARKING		
2019 MOUNTAIN VIEW GREEN BUILDING AND REACH CODES			
TABLE A5.106.5.3.2			
Total Number of Actual Parking Spaces	Number of Required EV Charging Spaces <sup>1</sup>	Type of EV Charger	
0-9	1	EV2 Installed <sup>2</sup>	
10 or more	15%	EV2 Installed <sup>3(a)</sup>	
100 or more	1 for every 100 spaces on-site <sup>4</sup>	Level 3/ DC Fast Charger	
<sup>1</sup> Calculation for spaces shall be rounded up to the nearest whole number. <sup>2</sup> EV Ready shall be provided for all non EV installed spaces on-site. <sup>3(a)</sup> IEE 1572 (IEC Type 1) or alternative approved by the chief building official. <sup>4</sup> Each installed Level 3 Charger shall be included in the 15% required installed spaces.			
CALIFORNIA BUILDING CODE 2019			
TABLE 11B-228.3.2.1			
ELECTRIC VEHICLE CHARGING STATIONS FOR PUBLIC USE AND COMMON USE			
TOTAL NUMBER OF EVCS AT A FACILITY <sup>1</sup>	MINIMUM NUMBER (by type) OF EVCS REQUIRED TO COMPLY WITH SECTION 11B-812 <sup>2</sup>		
	Van Accessible	Standard Accessible	Automobile
1 to 4	1	0	0
5 to 25	1	1	0
26 to 50	1	1	1
51 to 75	1	2	2
76 to 100	1	3	3
101 and over	1 plus 1 for each 300 or fraction thereof, over 100	1 plus 1 for each 50 or fraction thereof, over 100	1 plus 1 for each 50 or fraction thereof, over 100
<sup>1</sup> Where an EV charger can simultaneously charge more than one vehicle, the number of EVCS provided shall be considered equivalent to the number of electric vehicles that can be simultaneously charged.			
100 PROPOSED PARKING = 15 EVCS REQUIRED SPACE 15 EVCS PROVIDED: 1 SINGLE CHARGING SPACE (LEVEL 3 TYPE) 7 MULTIPLE CHARGING SPACE (LEVEL 2 TYPE)  2 EVCS VAN ACCESSIBLE PROVIDED (1 VAN ACCESSIBLE REQ'D) 1 EVCS STANDARD ACCESSIBLE PROVIDED (1 STANDARD ACCESSIBLE REQ'D)  NOTE: PARKING TABULATION IS SHOWN FOR REFERENCE FROM APPROVED PERMIT PL-2017-346. NO PROPOSED CHANGES TO THIS SUBMITTAL.			

VICINITY MAP



Consultant:

Agency Approval:

File No.:

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Mountain View, CA 94040

Project:  
Modification to the Center for Innovation & Dining Commons

Sheet Title:  
PROJECT INFORMATION AND SHEET INDEX

PLANNING SUBMITTAL

Date: 02/04/2022 Client Project No: 3445011000

Sheet:

G0.10.





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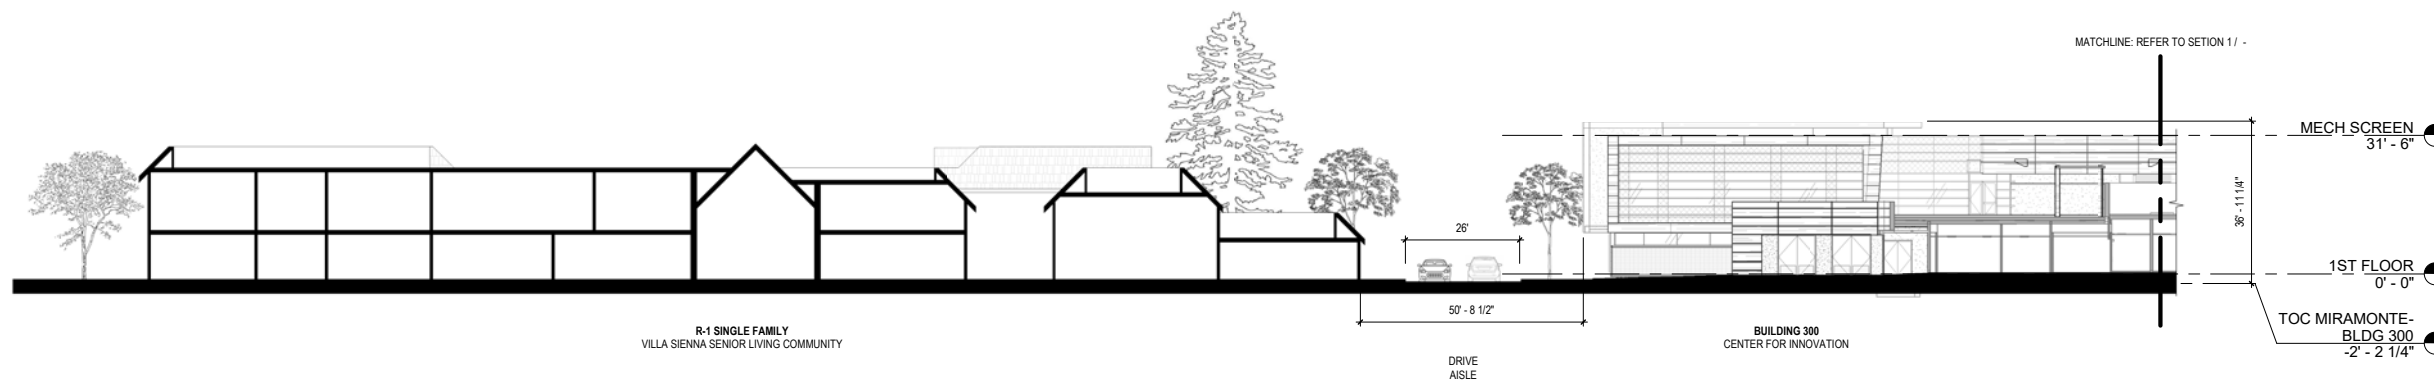
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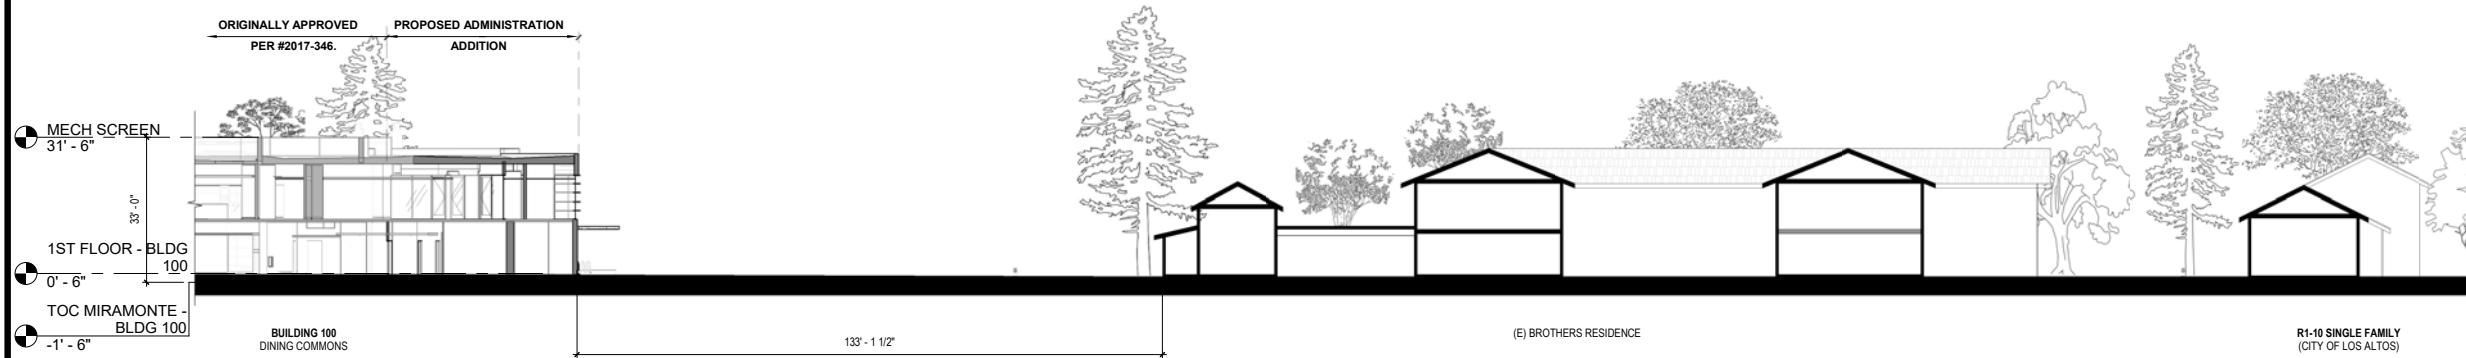
Keynotes:



SITE SECTION **3**  
1" = 70'-0"

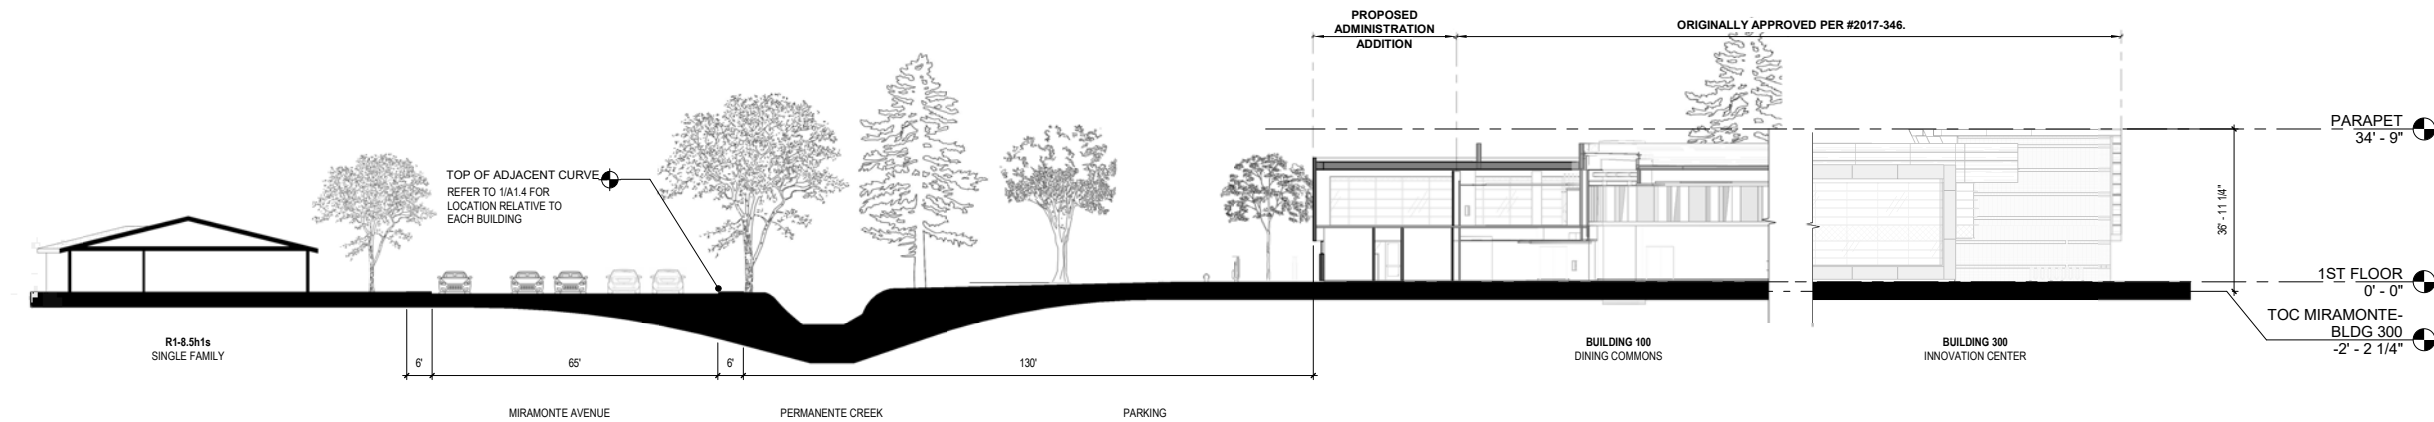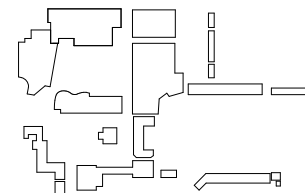

SITE SECTION - N-S- SEGMENT A **2**  
NO PROPOSED CHANGE FOR REFERENCE ONLY 1" = 20'-0"



SITE SECTION - N-S- SEGMENT B **1**  
1" = 20'-0"

Agency  
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**SITE SECTIONS**

**PLANNING SUBMITTAL**

Date: 02/04/2022 Client Project No: 3445011000

Sheet:

**A0.1A**





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Keynotes:



STREETSCAPE ELEVATION - OPPOSITE MIRAMONTE

2

12" = 1'-0"

**BUILDING 300 RENDERINGS ARE INCLUDED FOR REFERENCE. NO MODIFICATIONS PROPOSED**

Key Plan:



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**STREETSCAPE ELEVATIONS**

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**A0.1B**







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Sheet Title:  
**NEIGHBORHOOD AND CAMPUS CONTEXT IMAGES**

**PLANNING SUBMITTAL**

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Sheet:

**A0.1C**



LIBRARY - NW CORNER **7**



LIBRARY - WEST **8**



VILLA SIENNA **9**



VILLA SIENNA **10**



EL CAMINO PARKING GARAGE **11**



SINGLE FAMILY HOME ACROSS MIRAMONTE **12**



SINGLE FAMILY HOME ACROSS MIRAMONTE **13**



VIEW FROM SW CORNER OF QUAD **1**



MAIN QUAD SCULPTURE **2**



THEATER BUILDING - NORTH FACADE **3**



THEATER BUILDING - WEST FACADE **4**



ALUMNI GYMNASIUM **5**



BURNS FAMILY PAVILLION **6**







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BIRDS EYE VIEW

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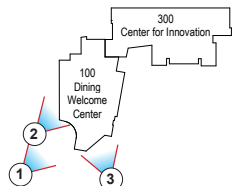
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Rendering legend:



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DESIGN RENDERINGS

**PLANNING SUBMITTAL**

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Sheet:

**A0.3**






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**A0.4**







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EXISTING SITE PLAN LEGEND

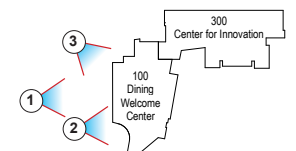- EXISTING BUILDING TO REMAIN
- DEMOLISH EXISTING LANDSCAPING, TREES, PAVEMENT, IRRIGATION SYSTEMS, BENCHES, FENCES, SIGNAGE AND EXTRAS. CONTRACTOR TO COORDINATE THE SCOPE OF DEMOLITION AREA WITH THE NEW SCOPE OF WORK AND ALL OTHER CONSULTANTS.
- PARKING AREAS LOCATED ON ADJACENT PROPERTY LEASED BY SFHS FROM EL CAMINO HOSPITAL.
- PROPERTY LINE

BUILDING AREA TABULATION

EXISTING BUILDINGS ONLY		
	FOOTPRINT (SF)	AREA (SF)
BUILDING 100	18,048	36,342
BUILDING 200	16,354	29,000
BUILDING 300	29,430	60,581
BUILDING 400	3,676	3,676
BUILDING 500	11,273	22,143
BUILDING 600	14,261	26,121
AQUATIC CENTER	4,780	4,780
HOME GRANDSTANDS	13,841	25,910
VISITORS GRANDSTANDS	6,120	6,120
ANDRE HOUSE	2,003	4,006
CONCESSIONS STAND	1,100	1,100
THEATRE	16,106	20,326
RASKOB & PRACTICE GYM	39,559	79,819
BROTHER'S RESIDENCE	9,959	17,710
ATHLETIC STORAGE	783	783
STORAGE	2,368	2,368
BATTING CAGES	4,800	4,800
TOTAL	194,461	345,585
LOT AREA :	1,087,415 SF (24.96 AC)	
(E) BUILDING COVERAGE:	194,461 / 1,087,415 = 0.178	
(E) F.A.R.:	345,585 / 1,087,415 = 0.317 < 0.4	

GENERAL NOTE

REFER TO SHEETS A1.2A AND 1.2B FOR EXISTING AND PROPOSED GRAPHIC PARKING COUNTS

Key Plan:



Agency Approval:

File No.:

Facility:  
Saint Francis High School  
1885 Miramonte Ave  
Mountain View, CA 94040

Project:  
Modification to the Center for Innovation & Dining Commons



Sheet Title:  
SITE PLAN - AS APPROVED PER PERMIT  
#PL2017-346

PLANNING SUBMITTAL

Date: 02/04/2022 Client Project No: 3445011000

Sheet:

A1.0

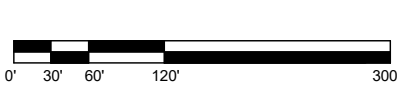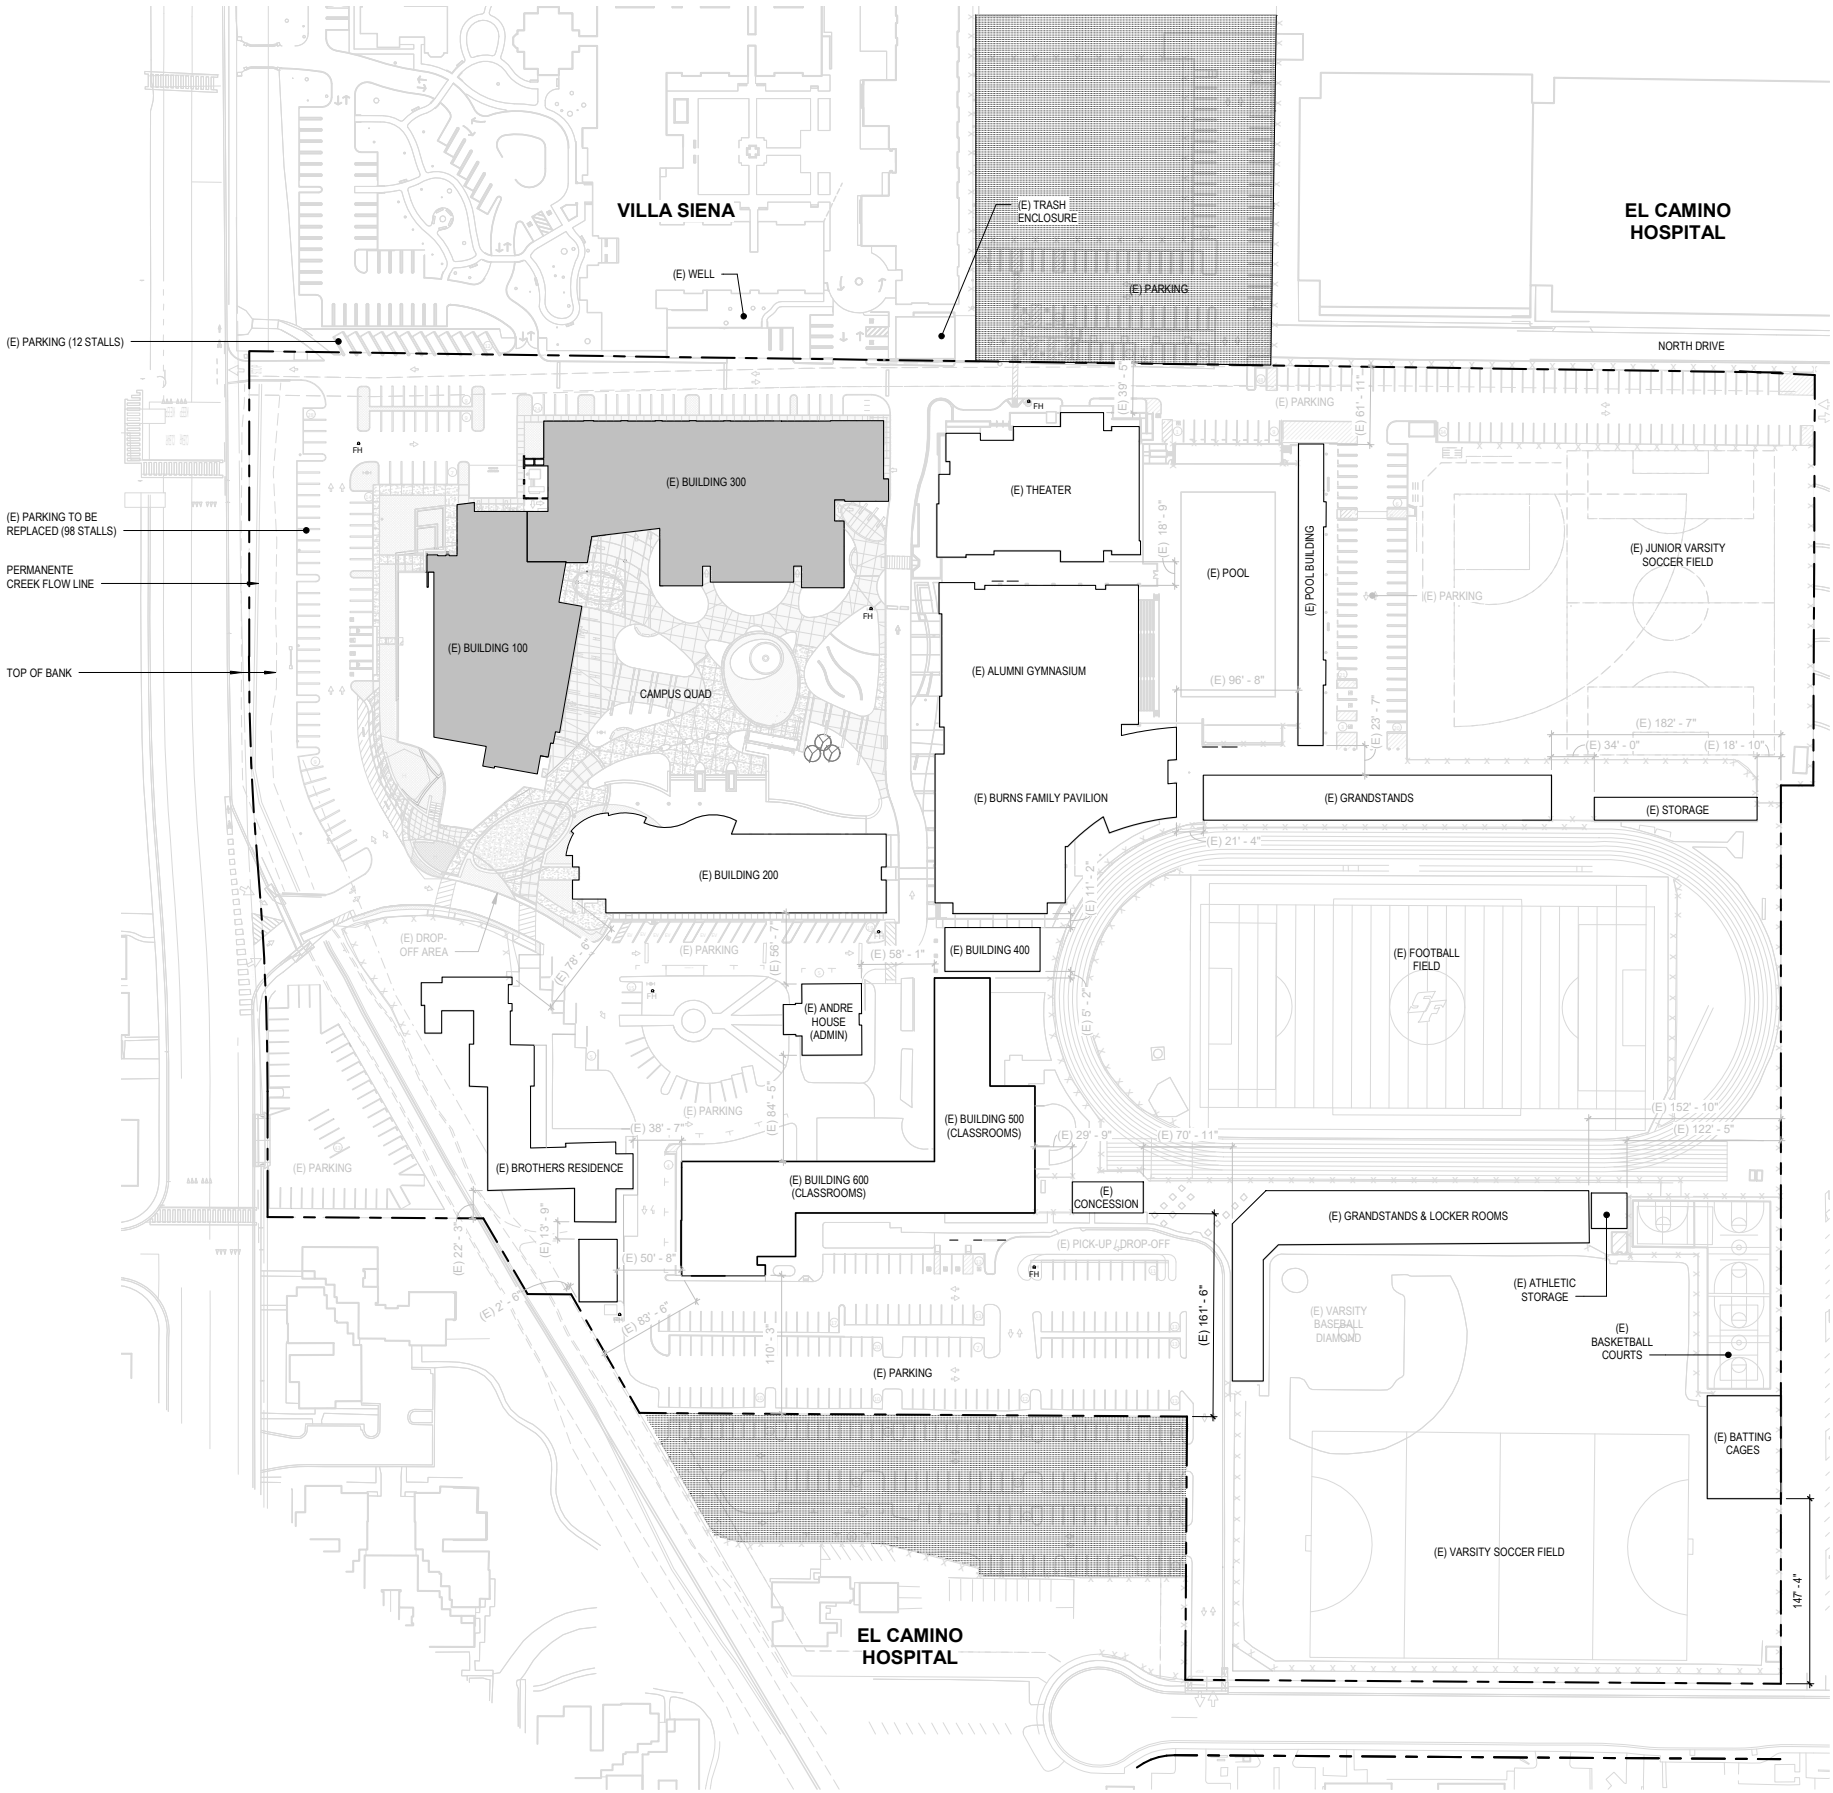

APPROVED SITE PLAN (#PL2017-346)

1  
1" = 70'-0"

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SITE PLAN LEGEND

- EXISTING BUILDINGS
- NEW BUILDINGS
- PARKING AREAS LOCATED ON ADJACENT PROPERTY, LEASED BY SFHS FROM EL CAMINO HOSPITAL
- PROPERTY LINE
- (E) CHAIN LINK FENCE LINE & GATE, 6'-0" HIGH
- (E) WOOD FENCE, 6'-0" HIGH

**GENERAL NOTE**  
REFER TO SHEETS A1.2A AND 1.2B FOR EXISTING AND PROPOSED GRAPHIC PARKING COUNTS

BUILDING AREA TABULATION

EXISTING BUILDINGS	FOOTPRINT (SF)	AREA (SF)
BUILDING 100	18,048	36,342
BUILDING 200	16,354	29,000
BUILDING 300	29,430	60,581
BUILDING 400	3,676	3,676
BUILDING 500	11,273	22,143
BUILDING 600	14,261	26,121
AQUATIC CENTER	4,780	4,780
HOME GRANDSTANDS	13,841	25,910
VISITORS GRANDSTANDS	6,120	6,120
ANDRE HOUSE	2,003	4,006
CONCESSIONS STAND	1,100	1,100
THEATRE	16,106	20,326
BURNS PAVILION	39,559	79,819
BROTHER'S RESIDENCE	9,959	17,710
ATHLETIC STORAGE	783	783
STORAGE	2,368	2,368
BATTING CAGES	4,800	4,800
TOTAL	194,461	345,585

PROPOSED BUILDING	FOOTPRINT (SF)	AREA (SF)
WELCOME CENTER	8,711	16,727
GRAND TOTAL	203,172	362,312

LOT AREA: 1,087,415 SF (24.96 AC)  
BUILDING COVERAGE: 203,172 / 1,087,415 = .186  
F.A.R.:  $(E)345,585 + (N)16,727 = 362,312$  SF  
 $362,312 / 1,087,415 = 0.333 < 0.4$   
SEE SHEET G0.10 FOR SQUARE FOOTAGE ANALYSIS

Key Plan:



Agency Approval:

File No.:

Facility:  
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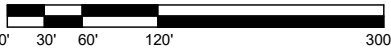
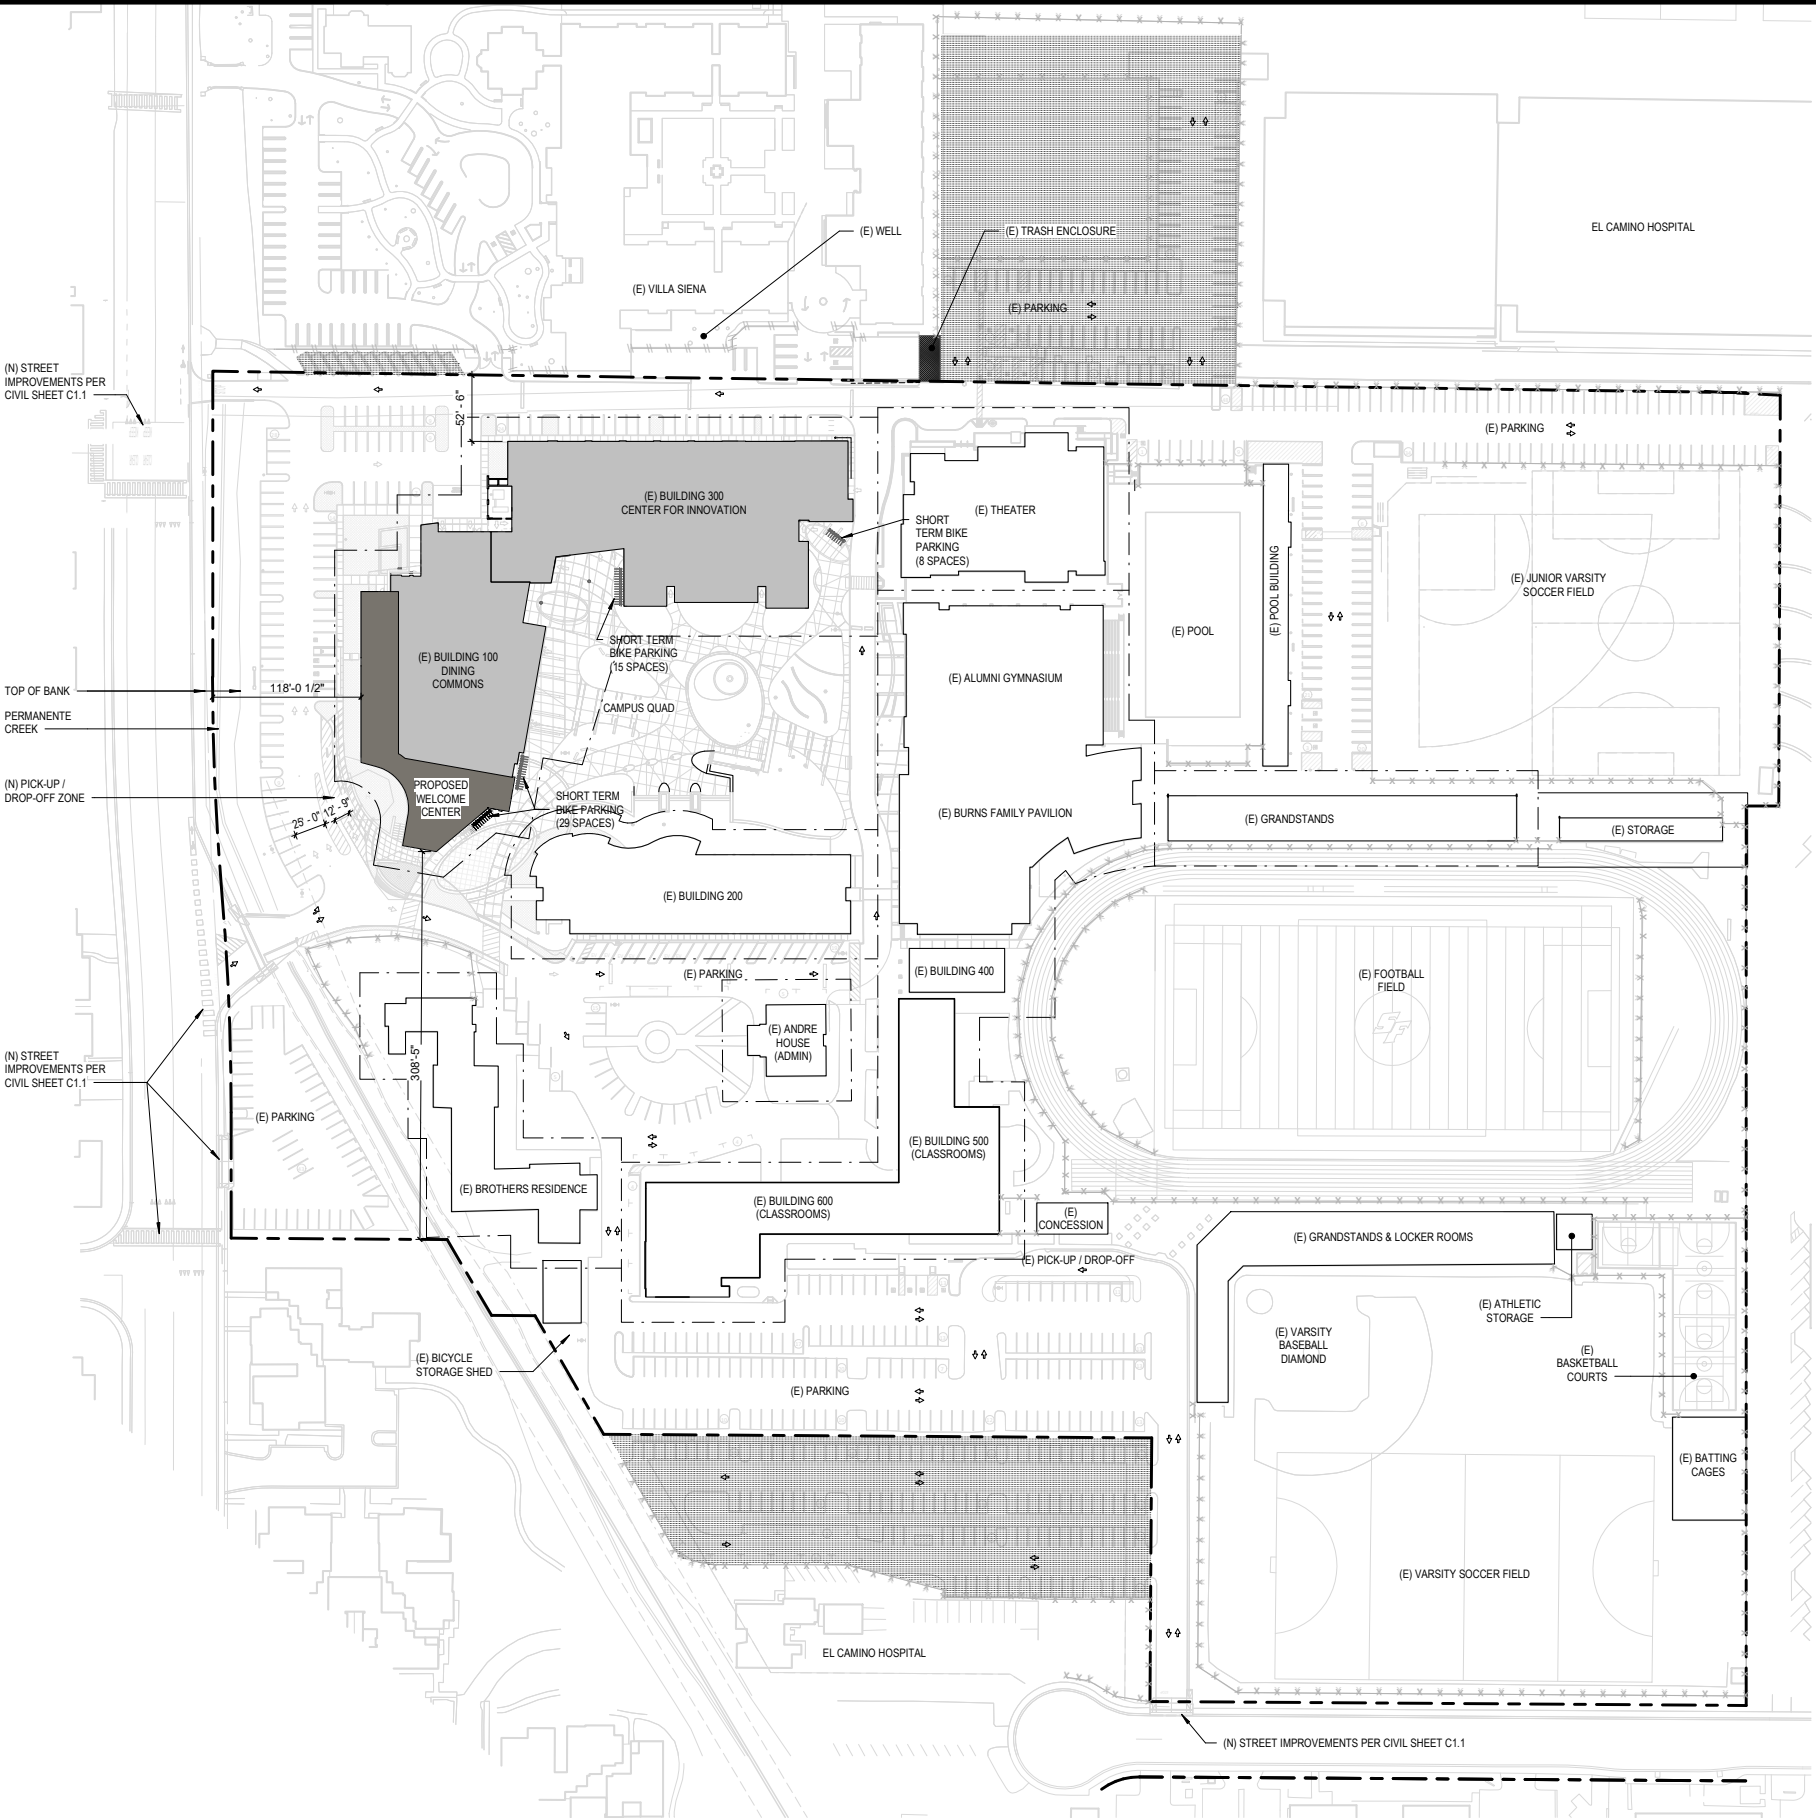
Project:  
Modification to the Center for Innovation & Dining Commons

Sheet Title:  
OVERALL SITE PLAN

PLANNING SUBMITTAL

Date: 02/04/2022 Client Project No: 3445011000

Sheet:



OVERALL SITE PLAN

1


1" = 70'-0"

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A1.1



NO PARKING MODIFICATIONS TO THE APPROVED PERMIT #PL2017-346

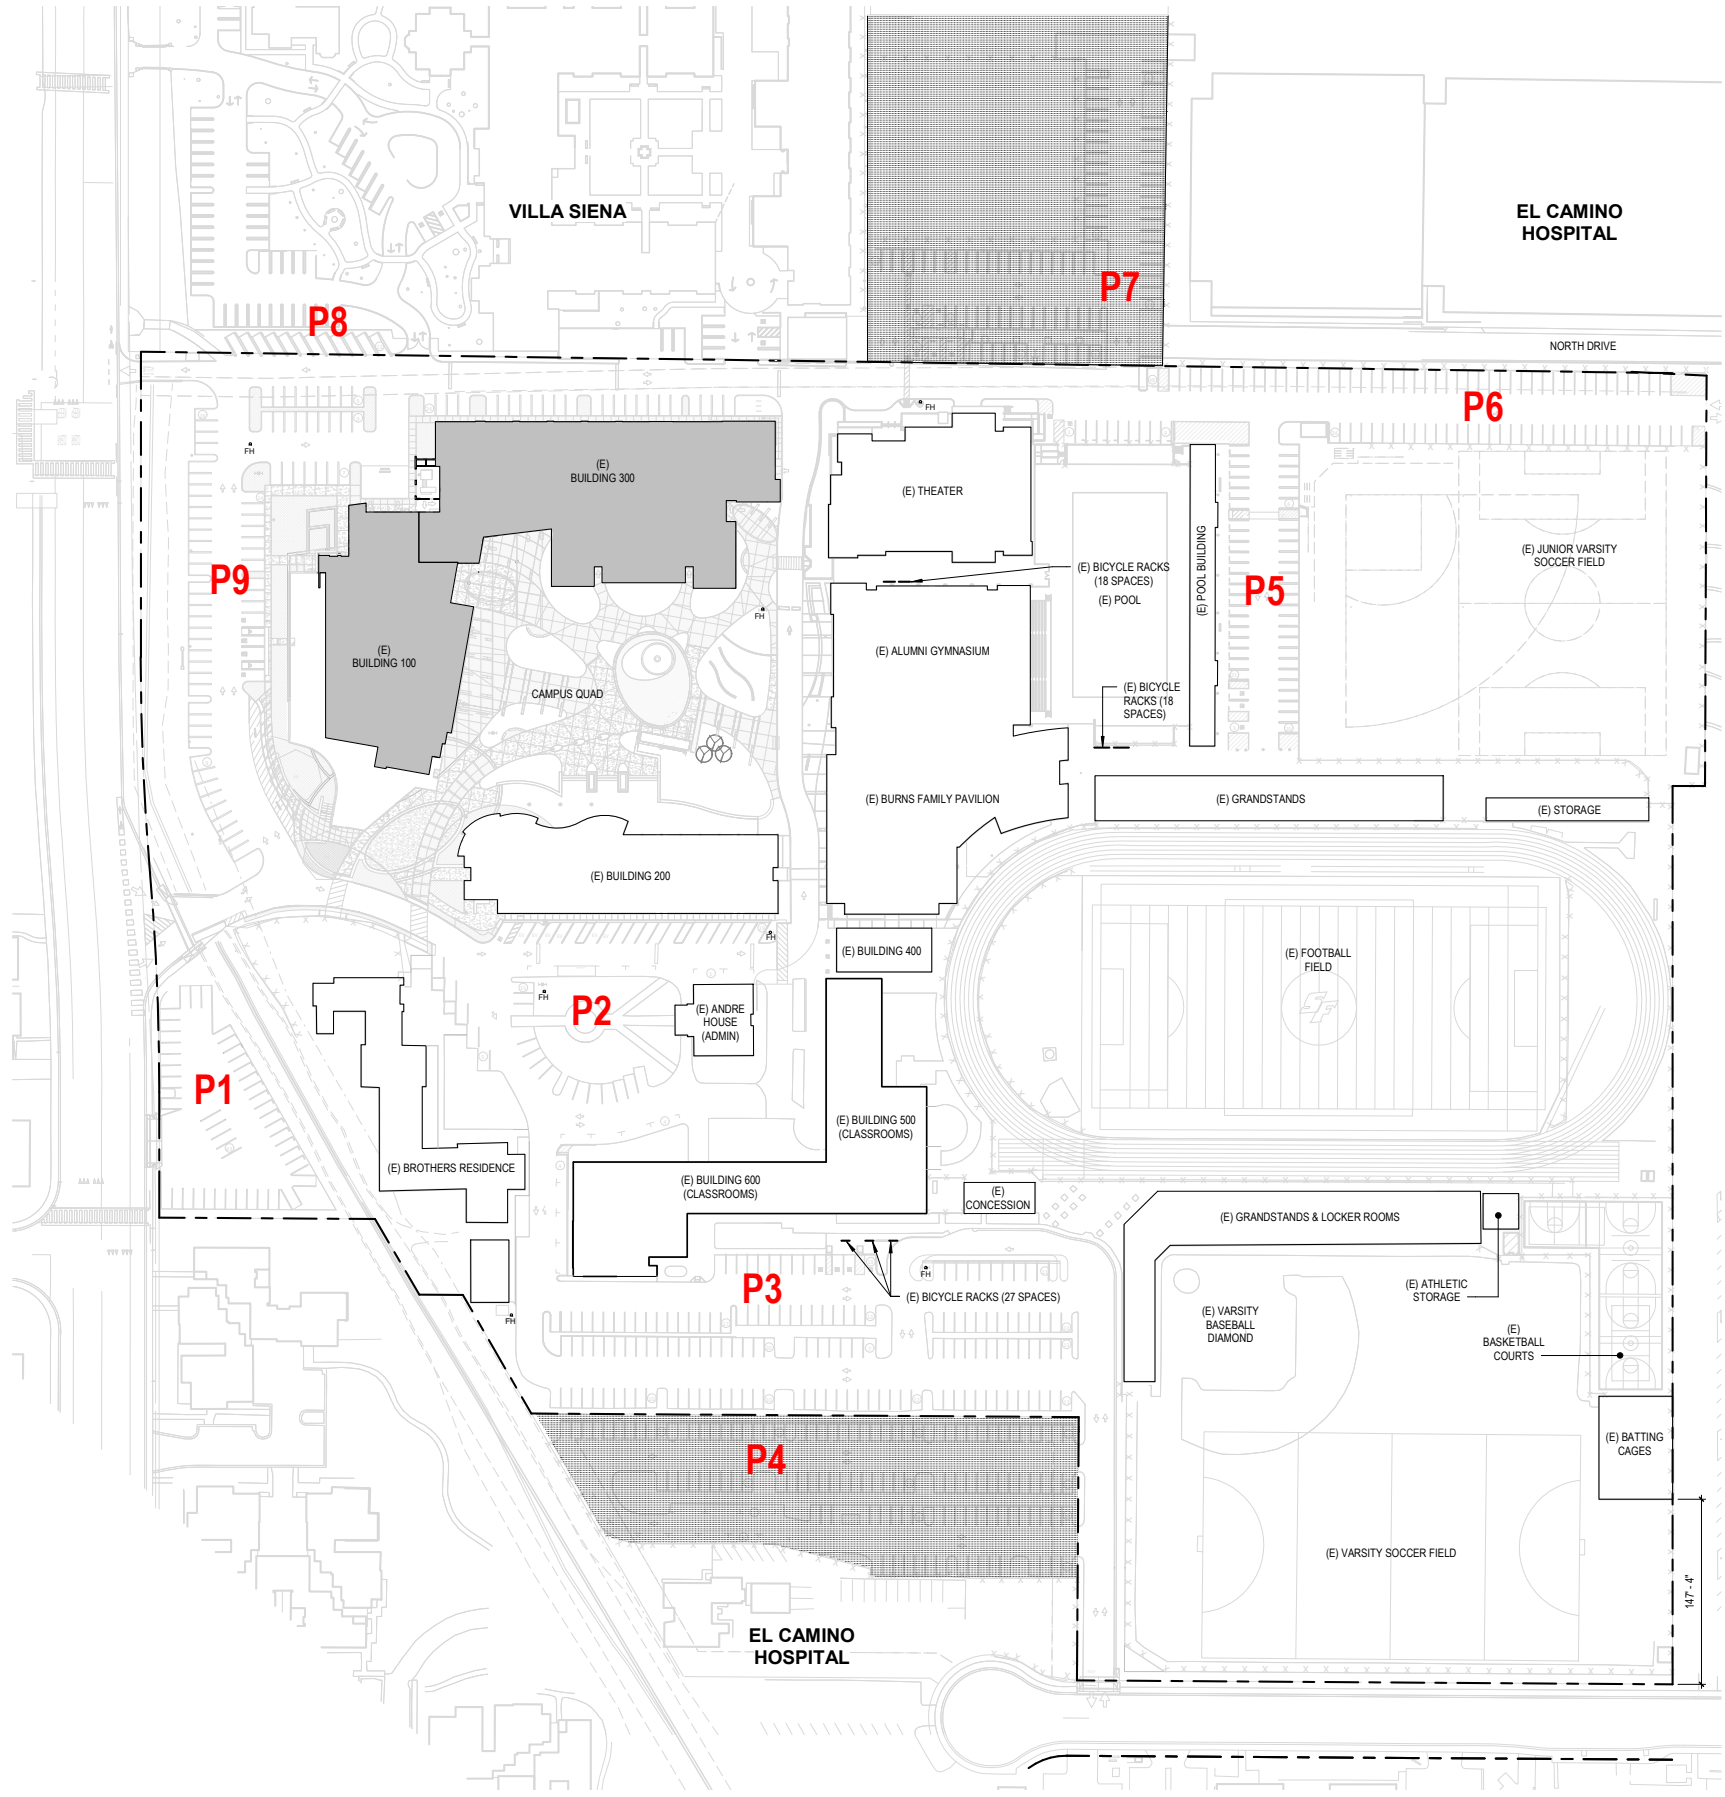

SITE PARKING TABULATION

VEHICLE PARKING				
		ADA	EV	NOTE
P1	43 STALLS	-	-	(E)
P2	52 STALLS	1	6	(E)
P3	152 STALLS	4	-	(E)
P4	129 STALLS	-	-	LEASED
P5	50 STALLS	3	-	(E)
P6	92 STALLS	1	-	(E)
P7	82 STALLS	5	-	LEASED
P8	12 STALLS	-	-	LEASED
SUB TOTAL	612 STALLS	14	6	(E)
P9	97 STALLS	1	-	(E) TO BE DEMOLISHED
TOTAL	709 STALLS	15	6	
BICYCLE PARKING				
	63 STALLS	-	-	



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Keynotes:

Key Plan:

Agency Approval:

File No.:

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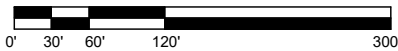
Project:  
Modification to the Center for Innovation & Dining Commons

Sheet Title:  
EXISTING PARKING PLAN

PLANNING SUBMITTAL

Date: 02/04/2022 Client Project No: 3445011000

Sheet:



EXISTING PARKING PLAN

1

1" = 70'-0"

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A1.2A





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Keynotes:

Key Plan:

Agency  
Approval:

File No.:

Facility:  
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Project:  
**Modification to the Center for Innovation & Dining Commons**

Sheet Title:  
**EXISTING PARKING PLAN W/ PROPOSED BUILDING**

**PLANNING SUBMITTAL**

Date: 02/04/2022

Client Project No: 3445011000

Sheet:

A1.2B

NO VEHICLE PARKING MODIFICATIONS TO THE APPROVED PERMIT #PL2017-345



SITE PARKING TABULATION

VEHICLE PARKING

		ADA	EV	NOTE
P1	43 STALLS		-	*
P2	52 STALLS	1	6	(E)
P3	152 STALLS	4	-	(E)
P4	129 STALLS	-	-	LEASED
P5	50 STALLS	3	-	(E)
P6	92 STALLS	1	-	(E)
P7	82 STALLS	5	-	LEASED
P8	12 STALLS	-	-	LEASED
SUB TOTAL	612 STALLS	14	6	(E)
P9	100 STALLS	4	12	
TOTAL	712 STALLS	18	18	

BICYCLE PARKING

(E) 63 STALLS	-	-	
(N) 88 STALLS	-	-	

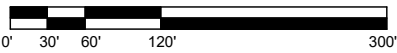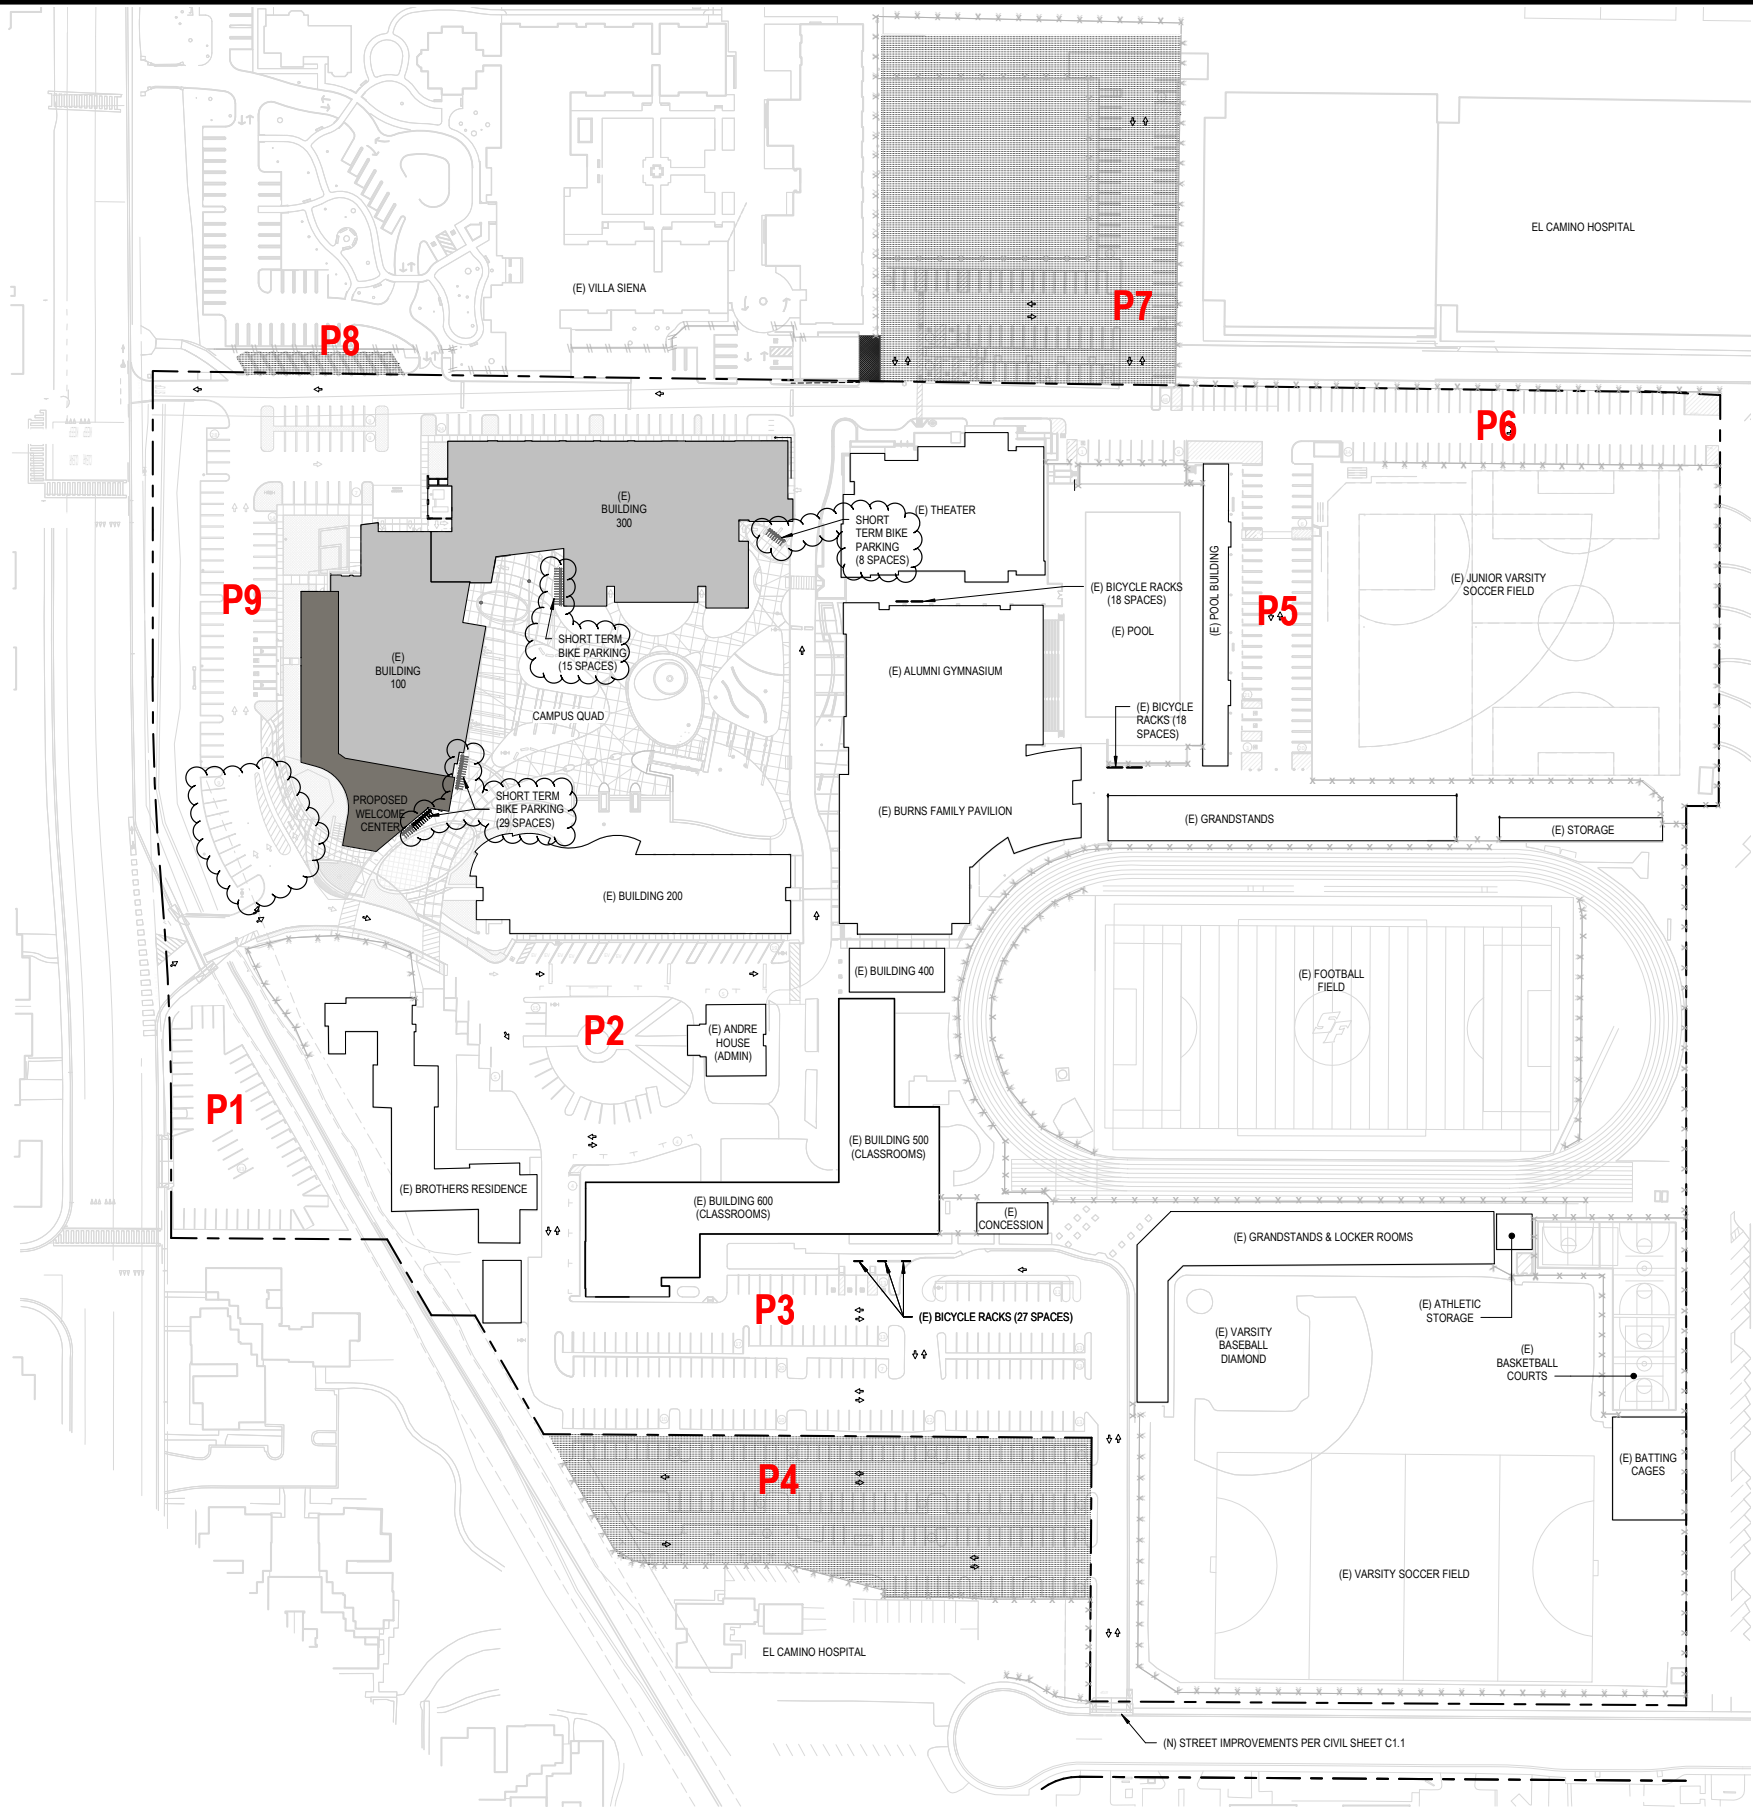

NEW PARKING PLAN

1  
1" = 70'-0"

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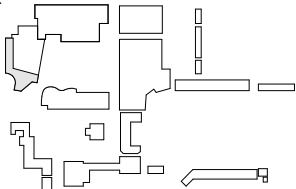
SITE PLAN LEGEND

- EXISTING BUILDINGS
- NEW BUILDINGS
- PARKING AREAS LOCATED ON ADJACENT PROPERTY, LEASED BY SFHS FROM EL CAMINO HOSPITAL
- PROPERTY LINE
- (E) CHAIN LINK FENCE LINE & GATE, 6'-0" HIGH
- (E) WOOD FENCE, 6'-0" HIGH

GENERAL NOTE

REFER TO SHEETS A1.2A AND 1.2B FOR EXISTING AND PROPOSED GRAPHIC PARKING COUNTS

Key Plan:



Agency Approval:

File No.:

Facility:  
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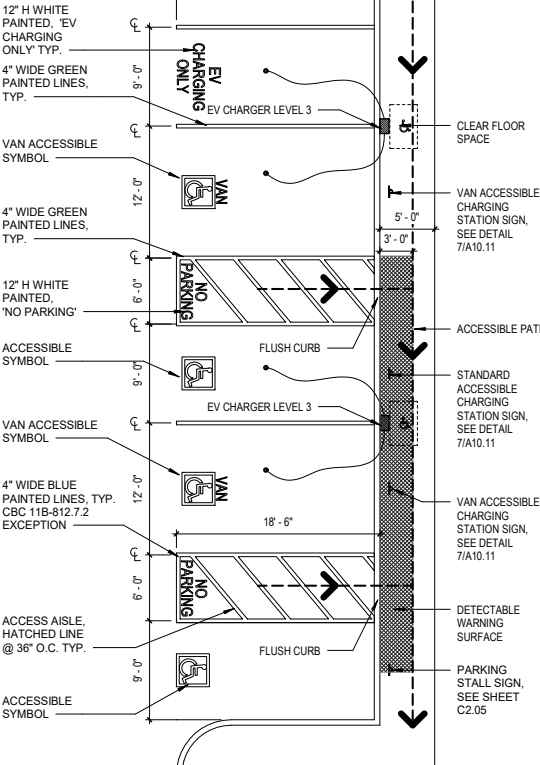
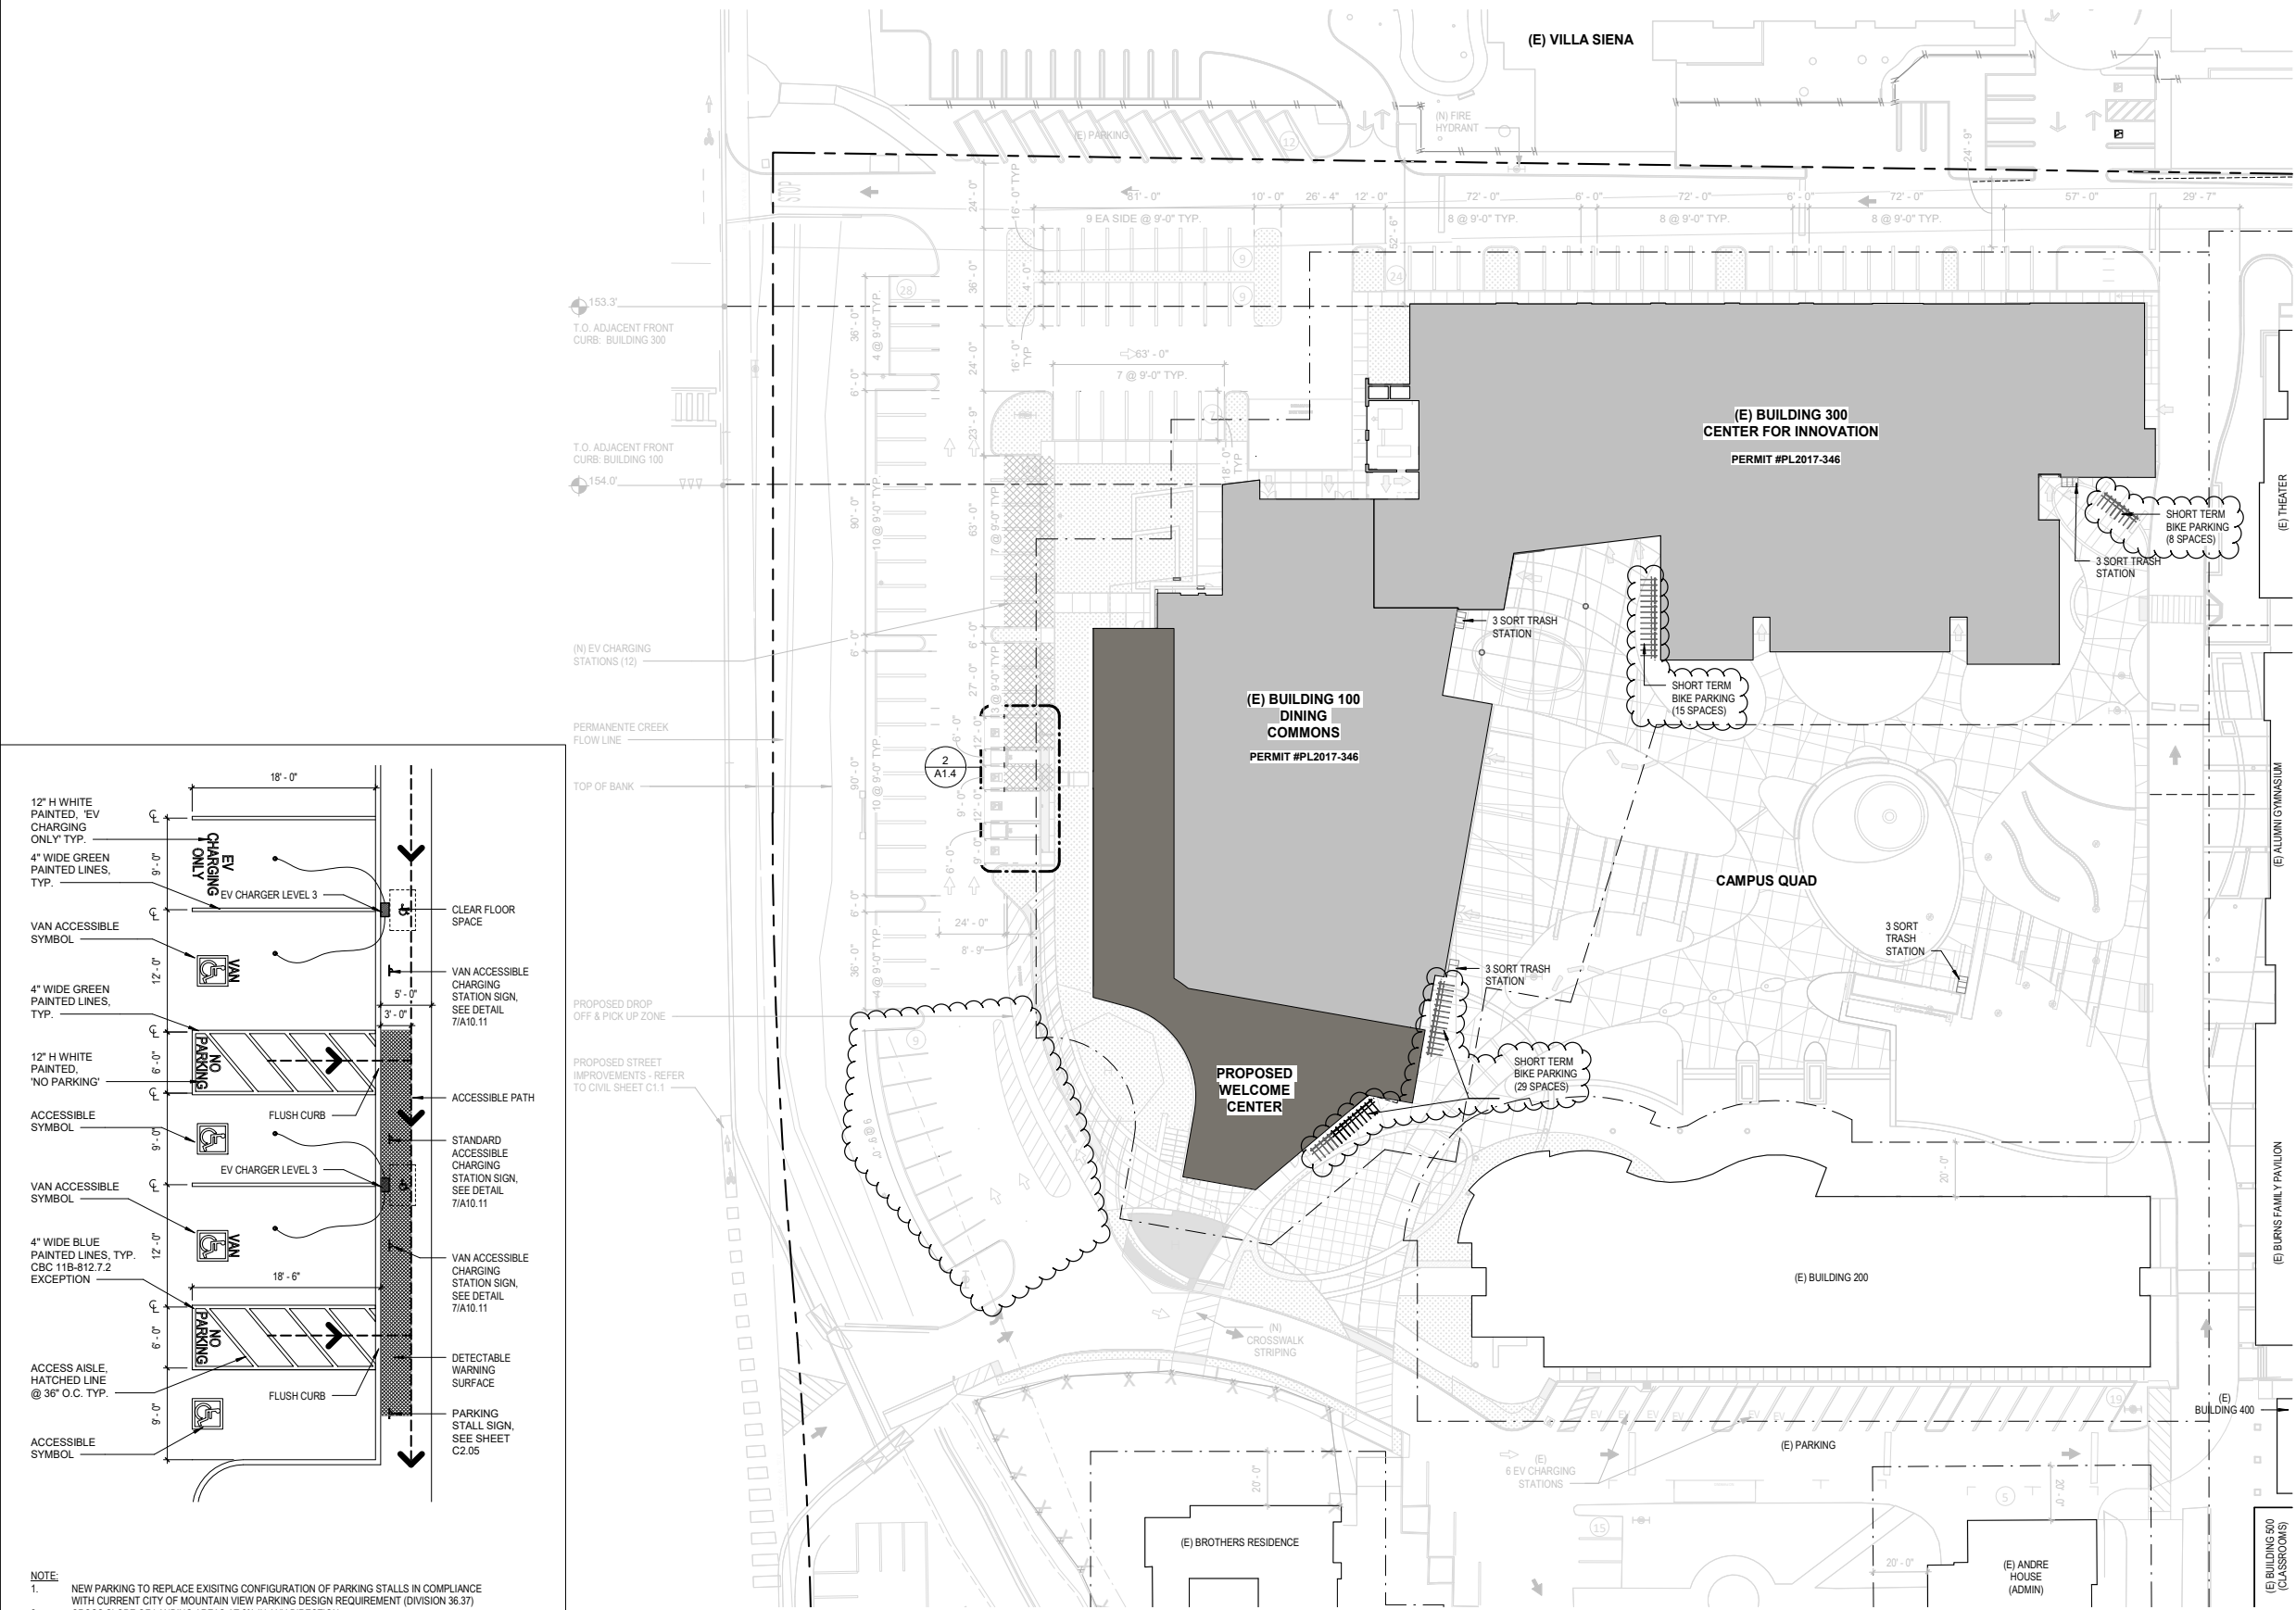
Project:  
Modification to the Center for Innovation & Dining Commons

Sheet Title:  
ENLARGED SITE PLAN

PLANNING SUBMITTAL

Date: 02/04/2022 Client Project No: 3445011000

Sheet:



- NOTE:
- NEW PARKING TO REPLACE EXISTING CONFIGURATION OF PARKING STALLS IN COMPLIANCE WITH CURRENT CITY OF MOUNTAIN VIEW PARKING DESIGN REQUIREMENT (DIVISION 36.37)
  - CROSS SLOPE OF LANDING AREAS AT 2% IN ANY DIRECTION
  - GRADE BREAKS AT THE TOP AND BOTTOM OF CURB RAMP RUN. SURFACE SLOPES THAT MEET AT GRADE BREAKS SHALL BE FLUSH

ENLARGED PLAN - ACCESSIBLE STALLS - BLDG 100

2

1/8" = 1'-0"

ENLARGED SITE PLAN

1

1" = 30'-0"

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A1.4





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Keynotes:

Key Plan:

Agency  
Approval:

File No.:

Facility:  
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Project:  
**Modification to the Center for Innovation &  
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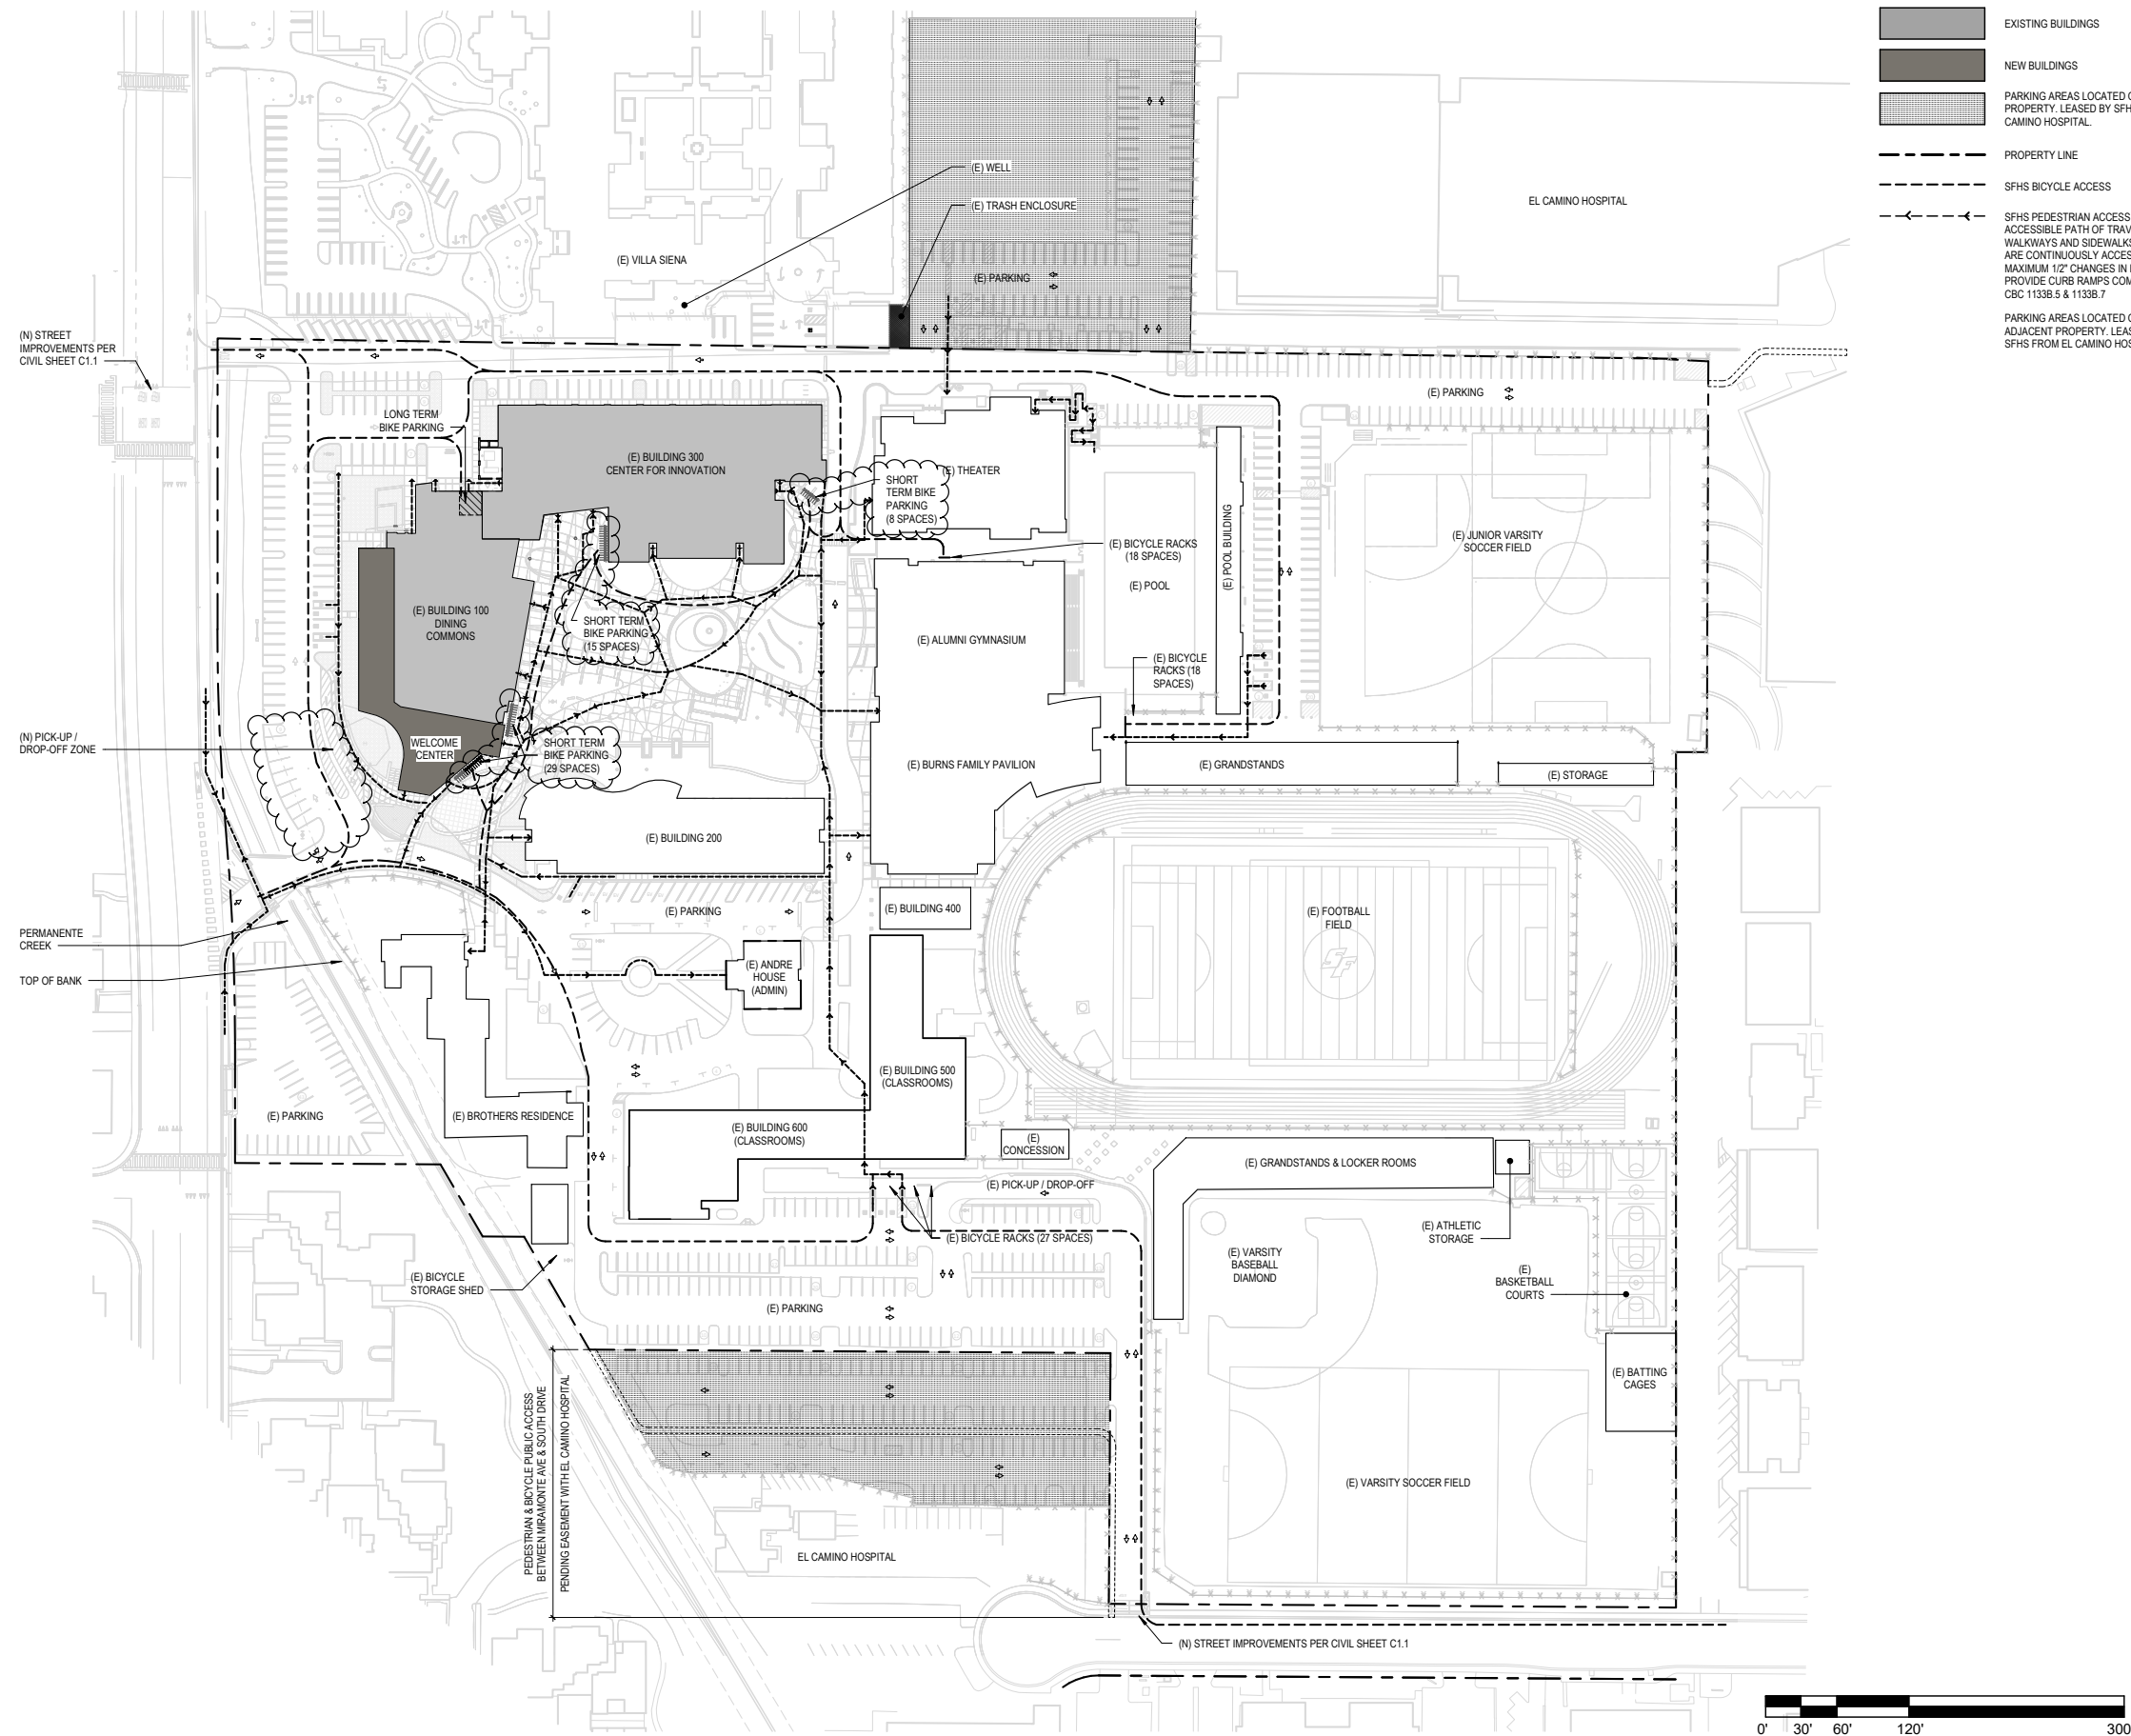
Sheet Title:  
**CIRCULATION SITE PLAN**

**PLANNING SUBMITTAL**

Date: 02/04/2022

Client Project No: 3445011000

Sheet:



A1.5



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**Keynotes:**

### Key Plans:

Agency  
Approval

File No.:

**Facility:**  
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Project:  
**Modification to the Center for Innovation & Dining Commons**

Sheet Title:  
**FIRE ACCESS SITE PLAN**

## PLANNING SUBMITTAL



**Date:** 02/04/2022

Client Project No: 3445011000
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Sheet:

AN	<b>1</b> 1" = 80'-0"
----	-------------------------

## A1.6

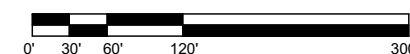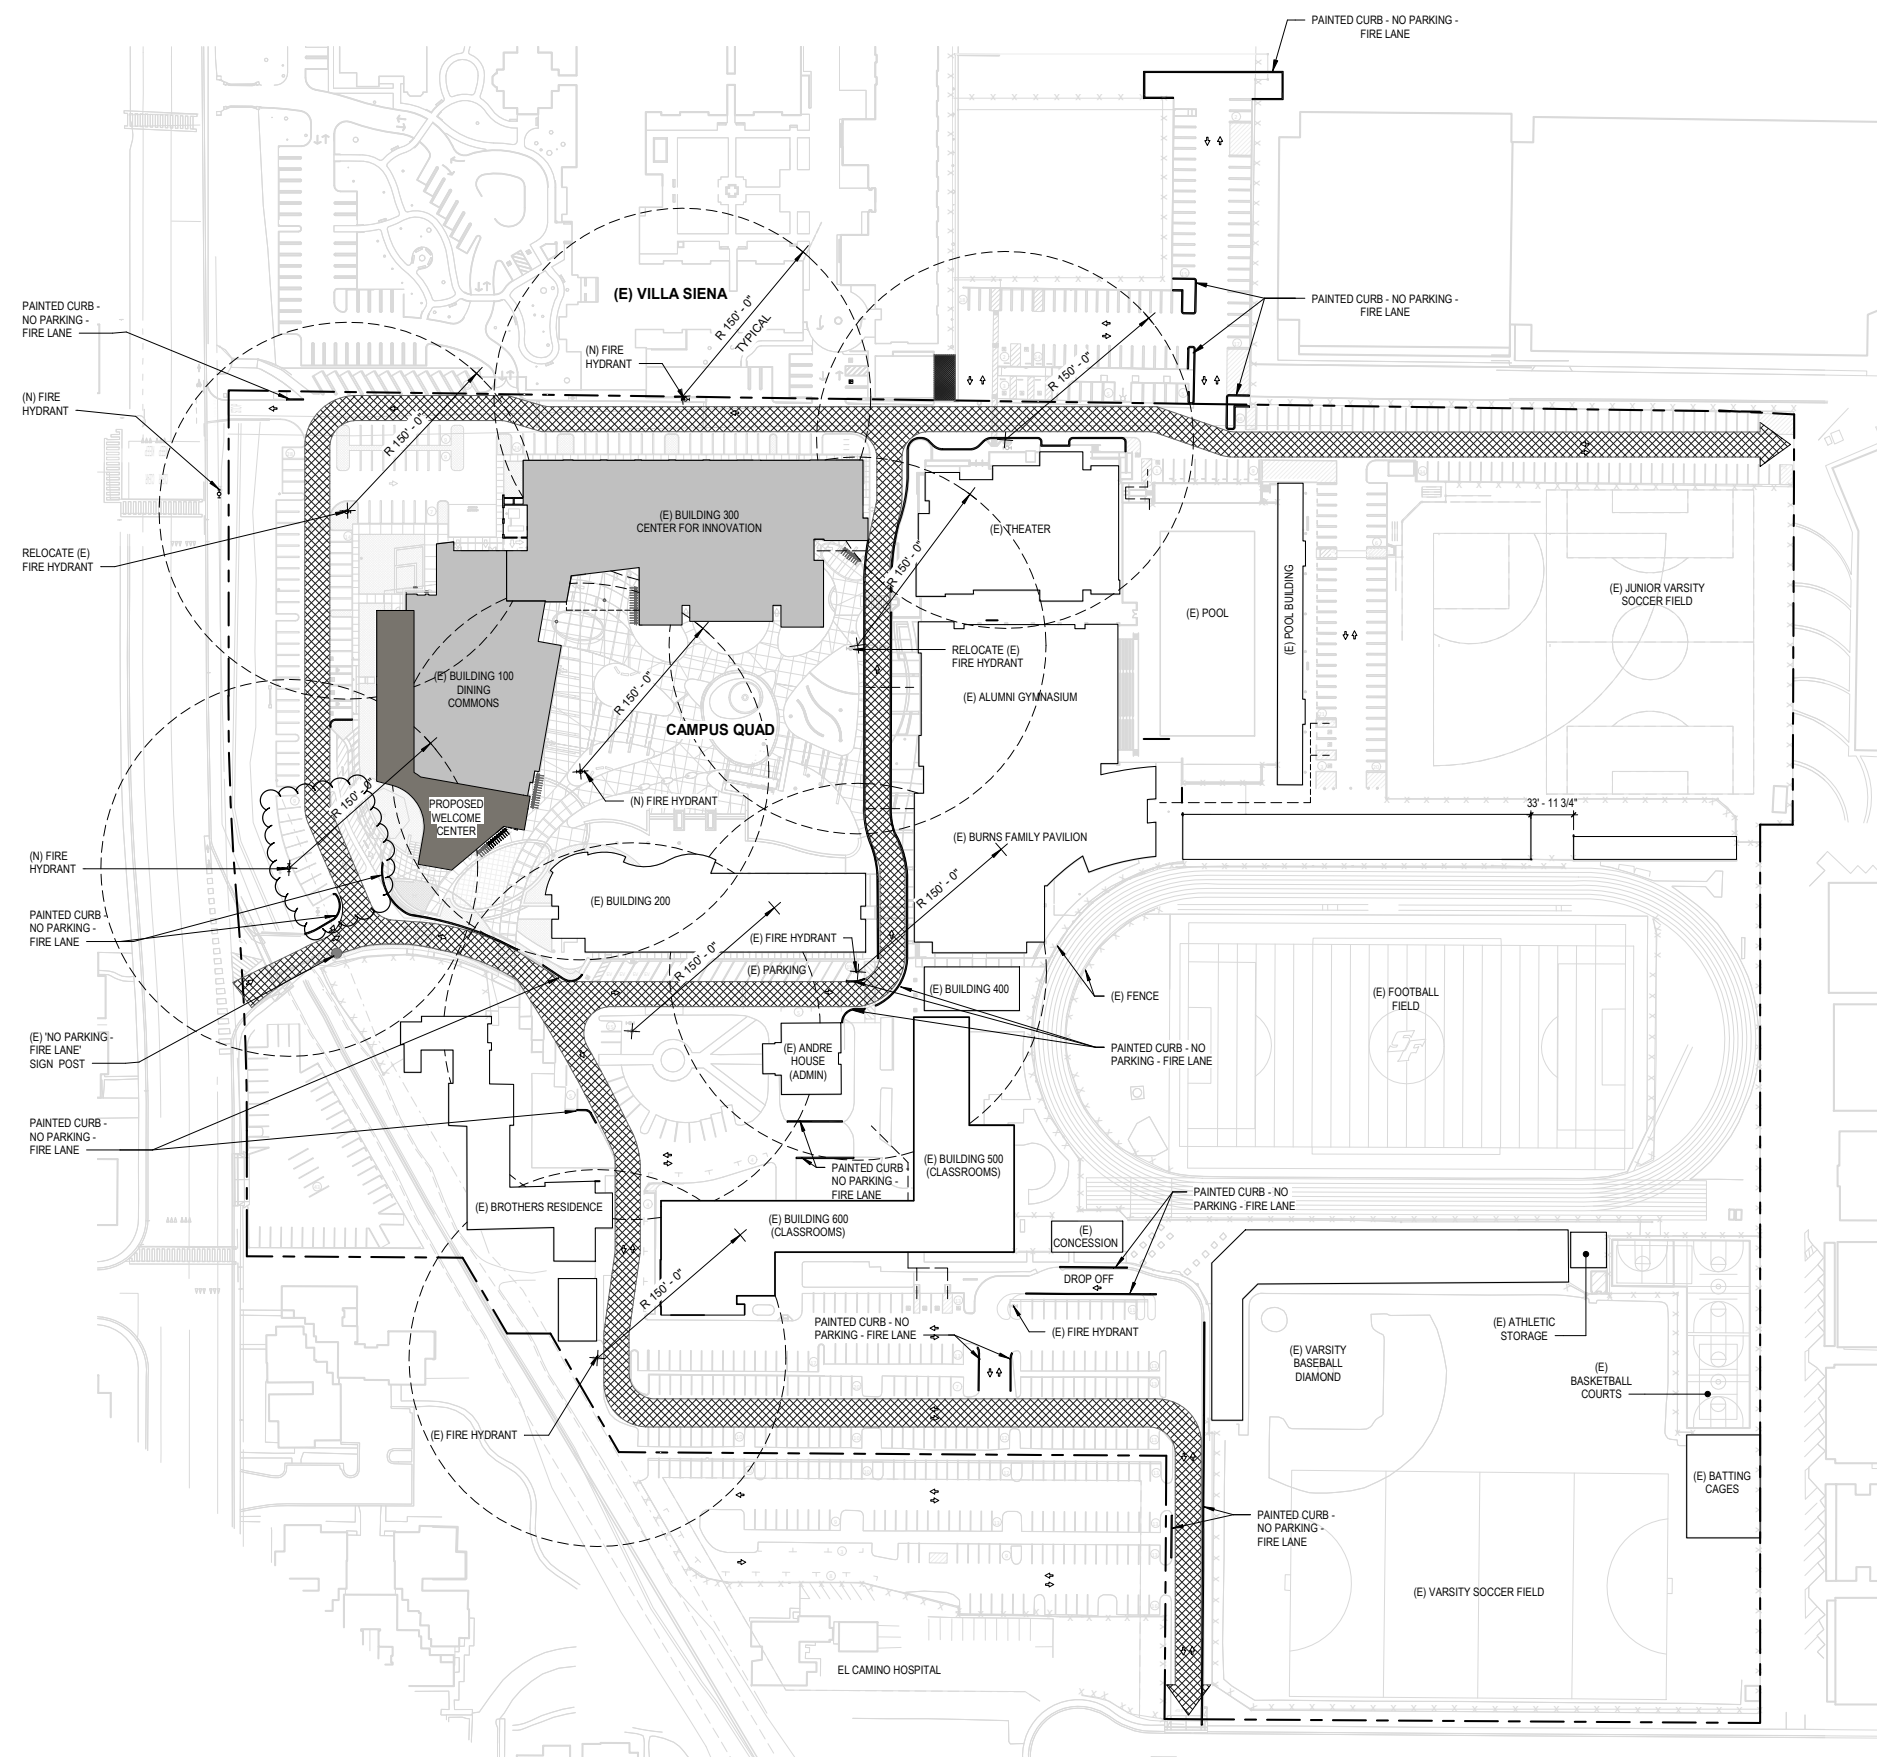

### PROPOSED OVERALL SITE PLAN





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NO MODIFICATIONS FROM PRIOR  
APPROVED SUBMITTAL 2017-346

Agency  
Approval:

File No.:

Facility:  
**Saint Francis High School**  
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Mountain View, CA 94040

Project:  
**Modification to the Center for Innovation &  
Dining Commons**



Sheet Title:  
**DIAGRAMATIC BUILDING SECTIONS**  
NO MODIFICATIONS FROM PRIOR APPROVED SUBMITTAL 2017-346

**PLANNING SUBMITTAL**

Date: 02/04/2022

Client Project No: 3445011000

Sheet:

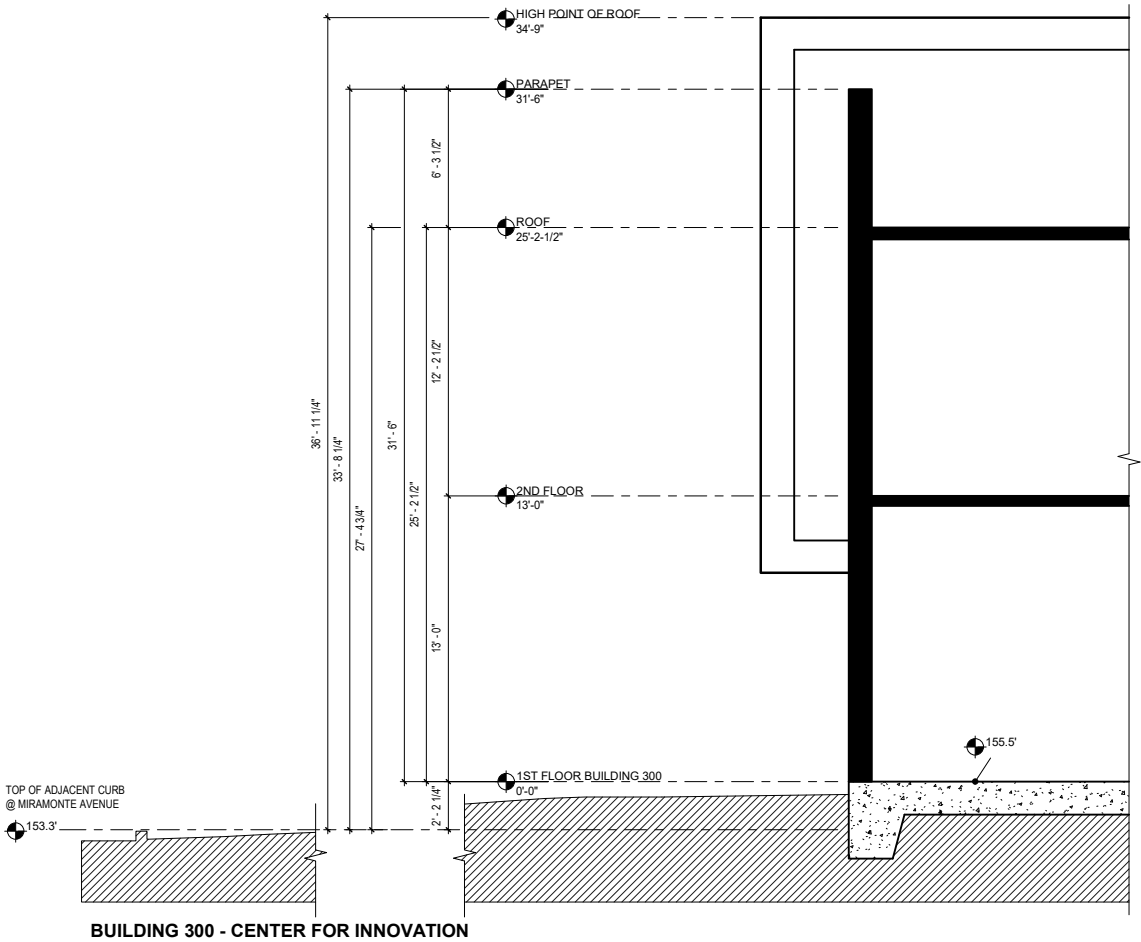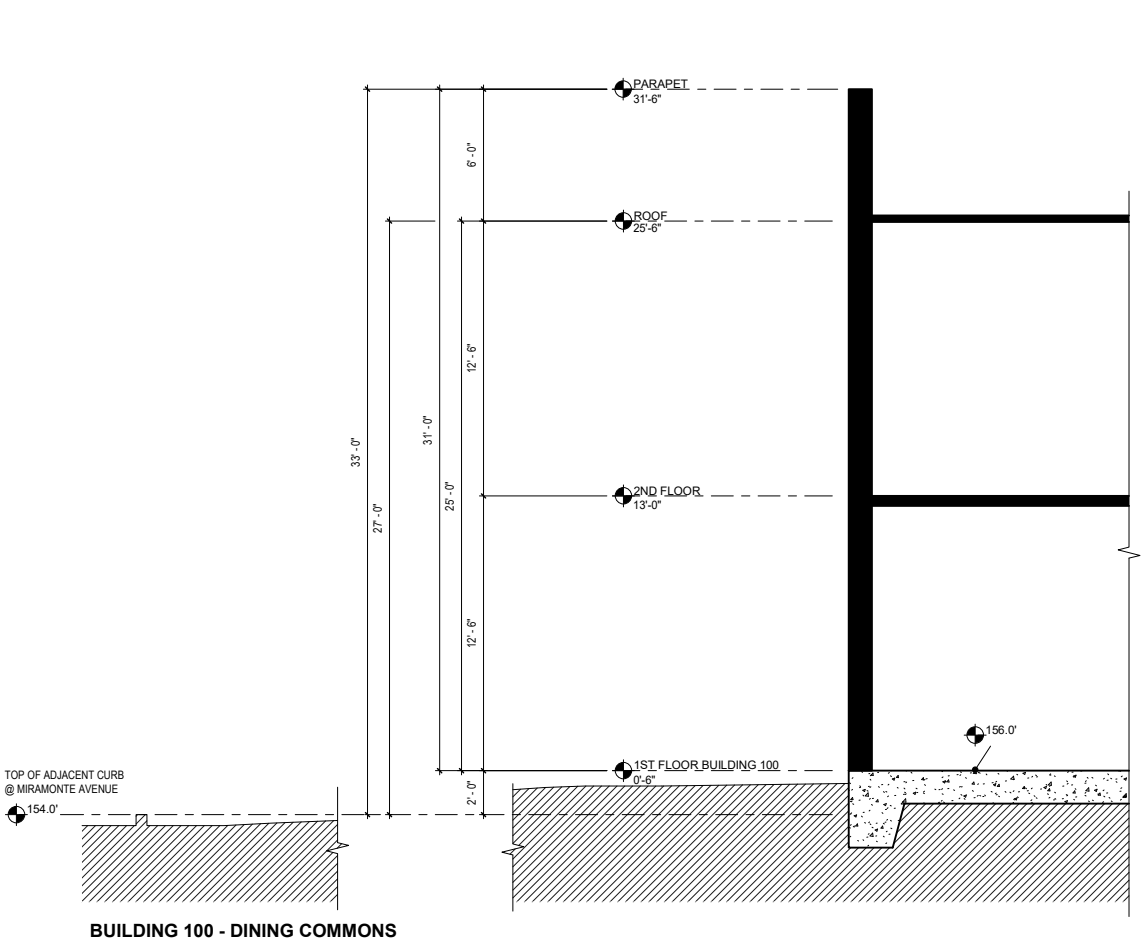

BUILDING SECTIONS

1

1/4" = 1'-0"

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A1.8






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Keynotes:

Key Plan:



Agency  
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Facility:  
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Mountain View, CA 94040



Project:  
**Modification to the Center for Innovation &  
Dining Commons**

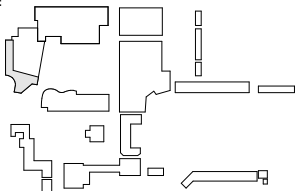Sheet Title:  
**BUILDING 100 - FIRST FLOOR PLAN**

**PLANNING SUBMITTAL**

Date: 02/04/2022 Client Project No: 3445011000

Sheet:

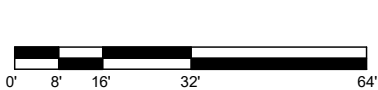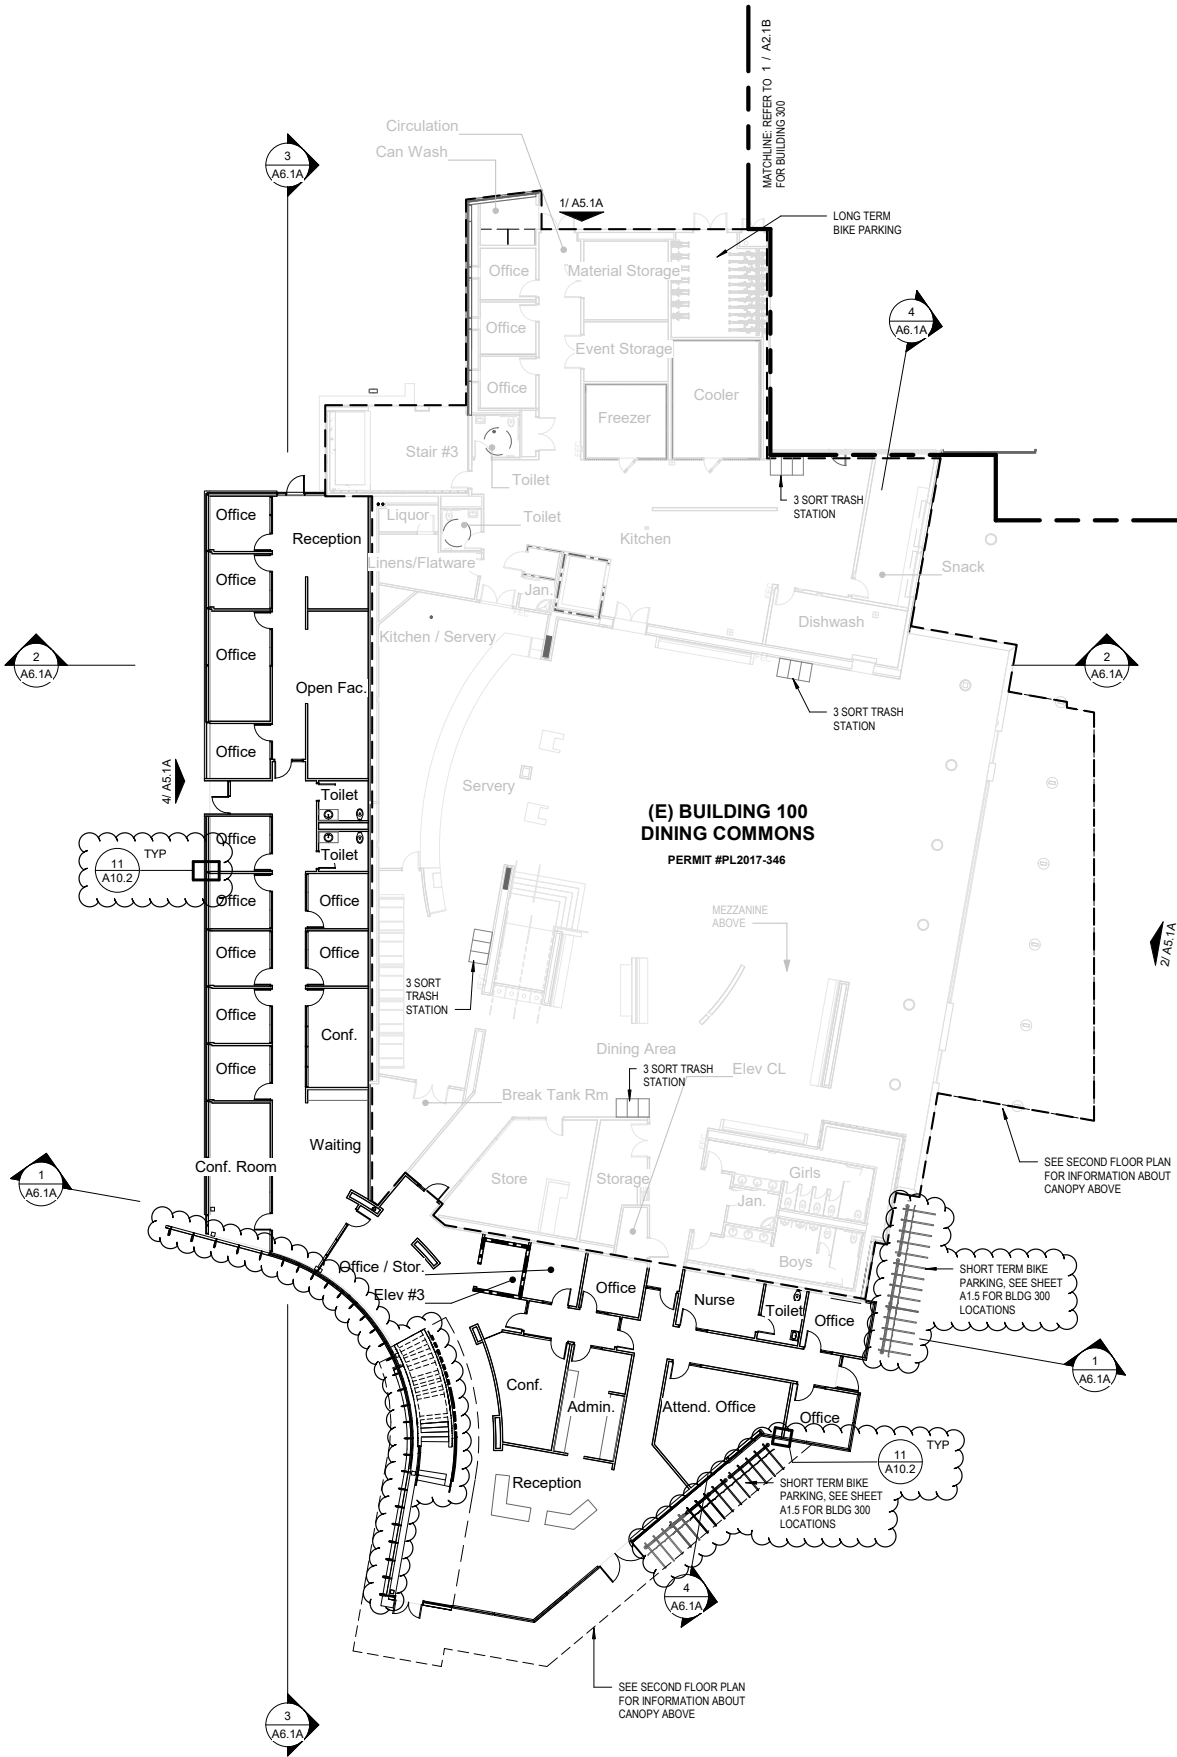

FIRST FLOOR PLAN

**1**  
1/16" = 1'-0"

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**A2.1A**






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Keynotes:

Key Plan:



Agency  
Approval:

File No.:

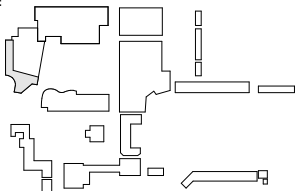Facility:  
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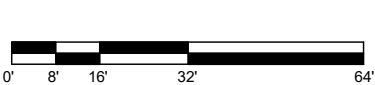
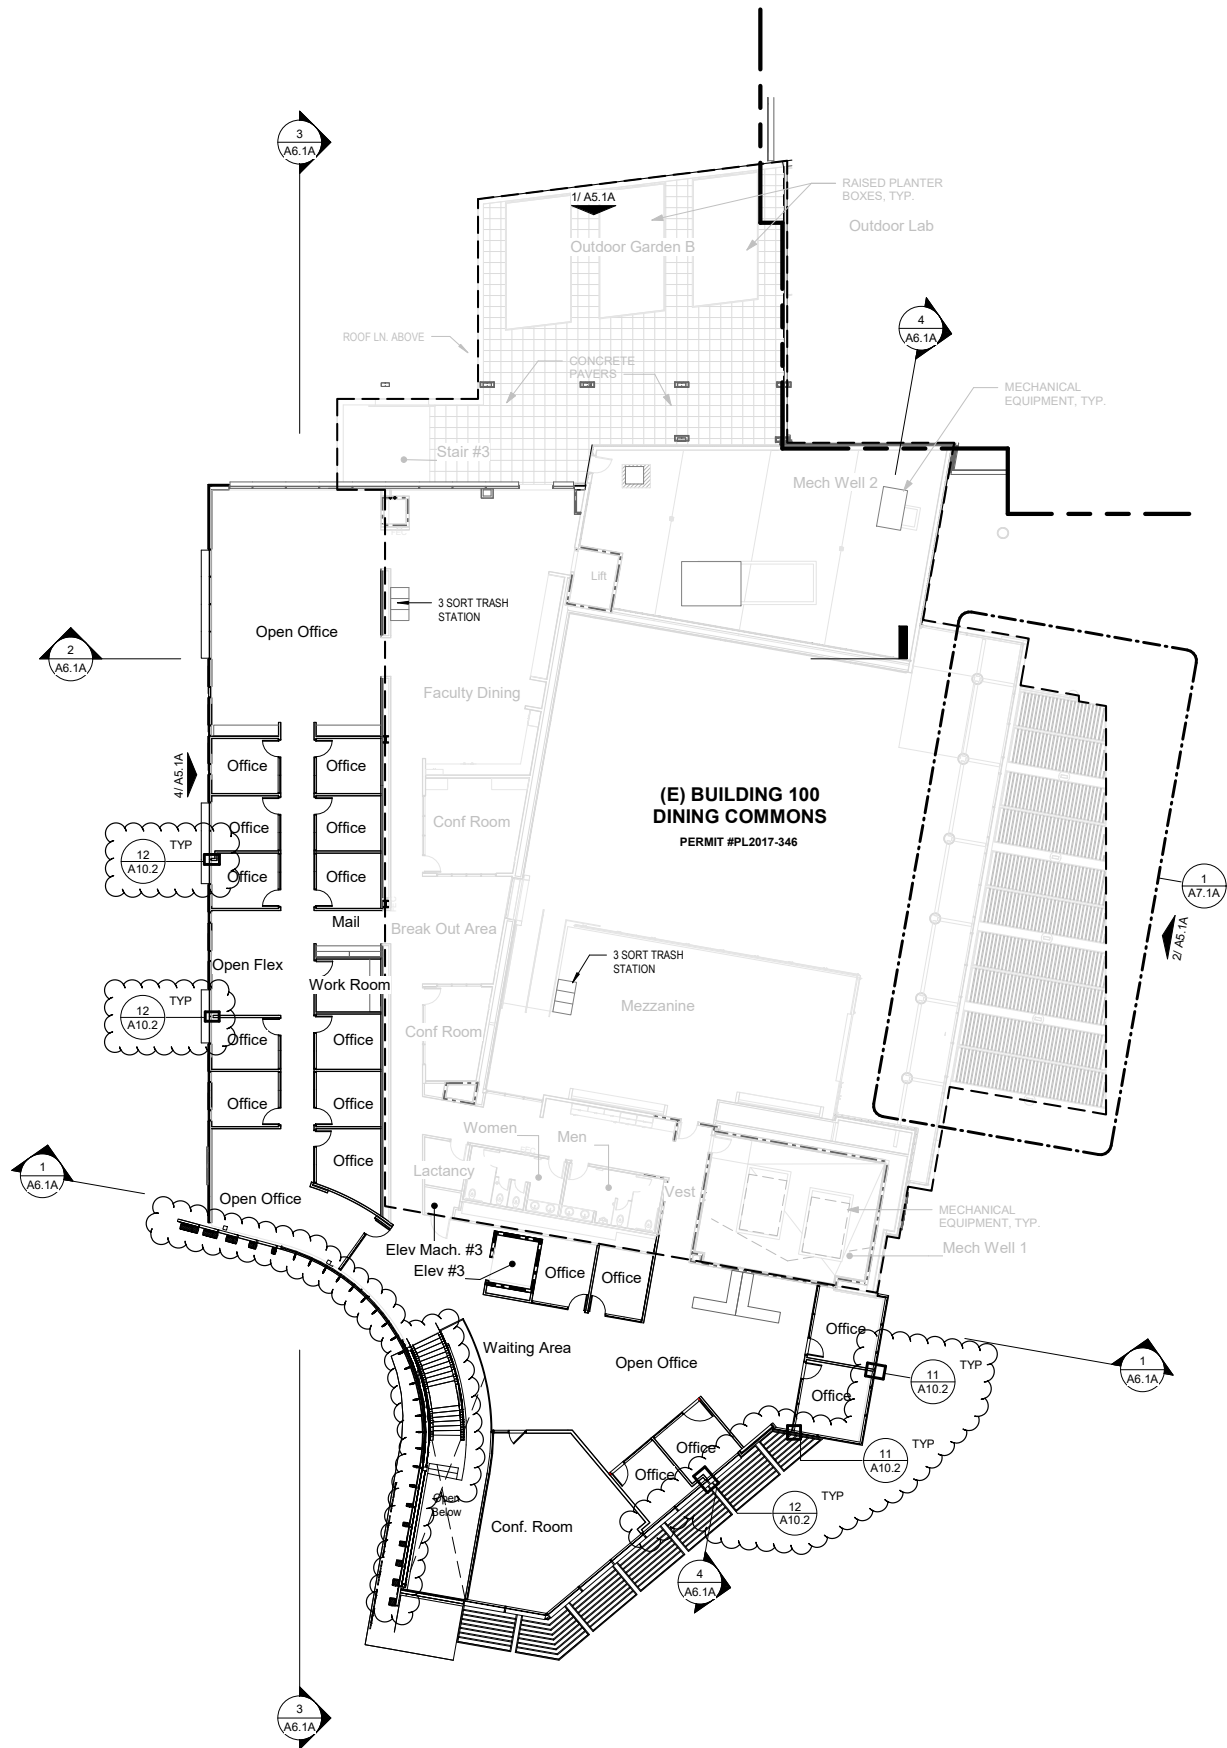
Project:  
**Modification to the Center for Innovation &  
Dining Commons**

Sheet Title:  
**BUILDING 100 - SECOND FLOOR PLAN**

**PLANNING SUBMITTAL**

Date: 02/04/2022 Client Project No: 3445011000

Sheet:



BUILDING 100 - 2ND FLOOR PLAN

1

1/16" = 1'-0"

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A2.2A






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- Keynotes:
- 05.15 ROOF ACCESS LADDER
  - 07.01 SINGLE-PLY TPO MEMBRANE ROOFING
  - 07.09 MECHANICAL EQUIPMENT SCREEN  
W/ACM PANEL, REFER TO 5/A10.41



Agency  
Approval:

File No.:  
  
Facility:  
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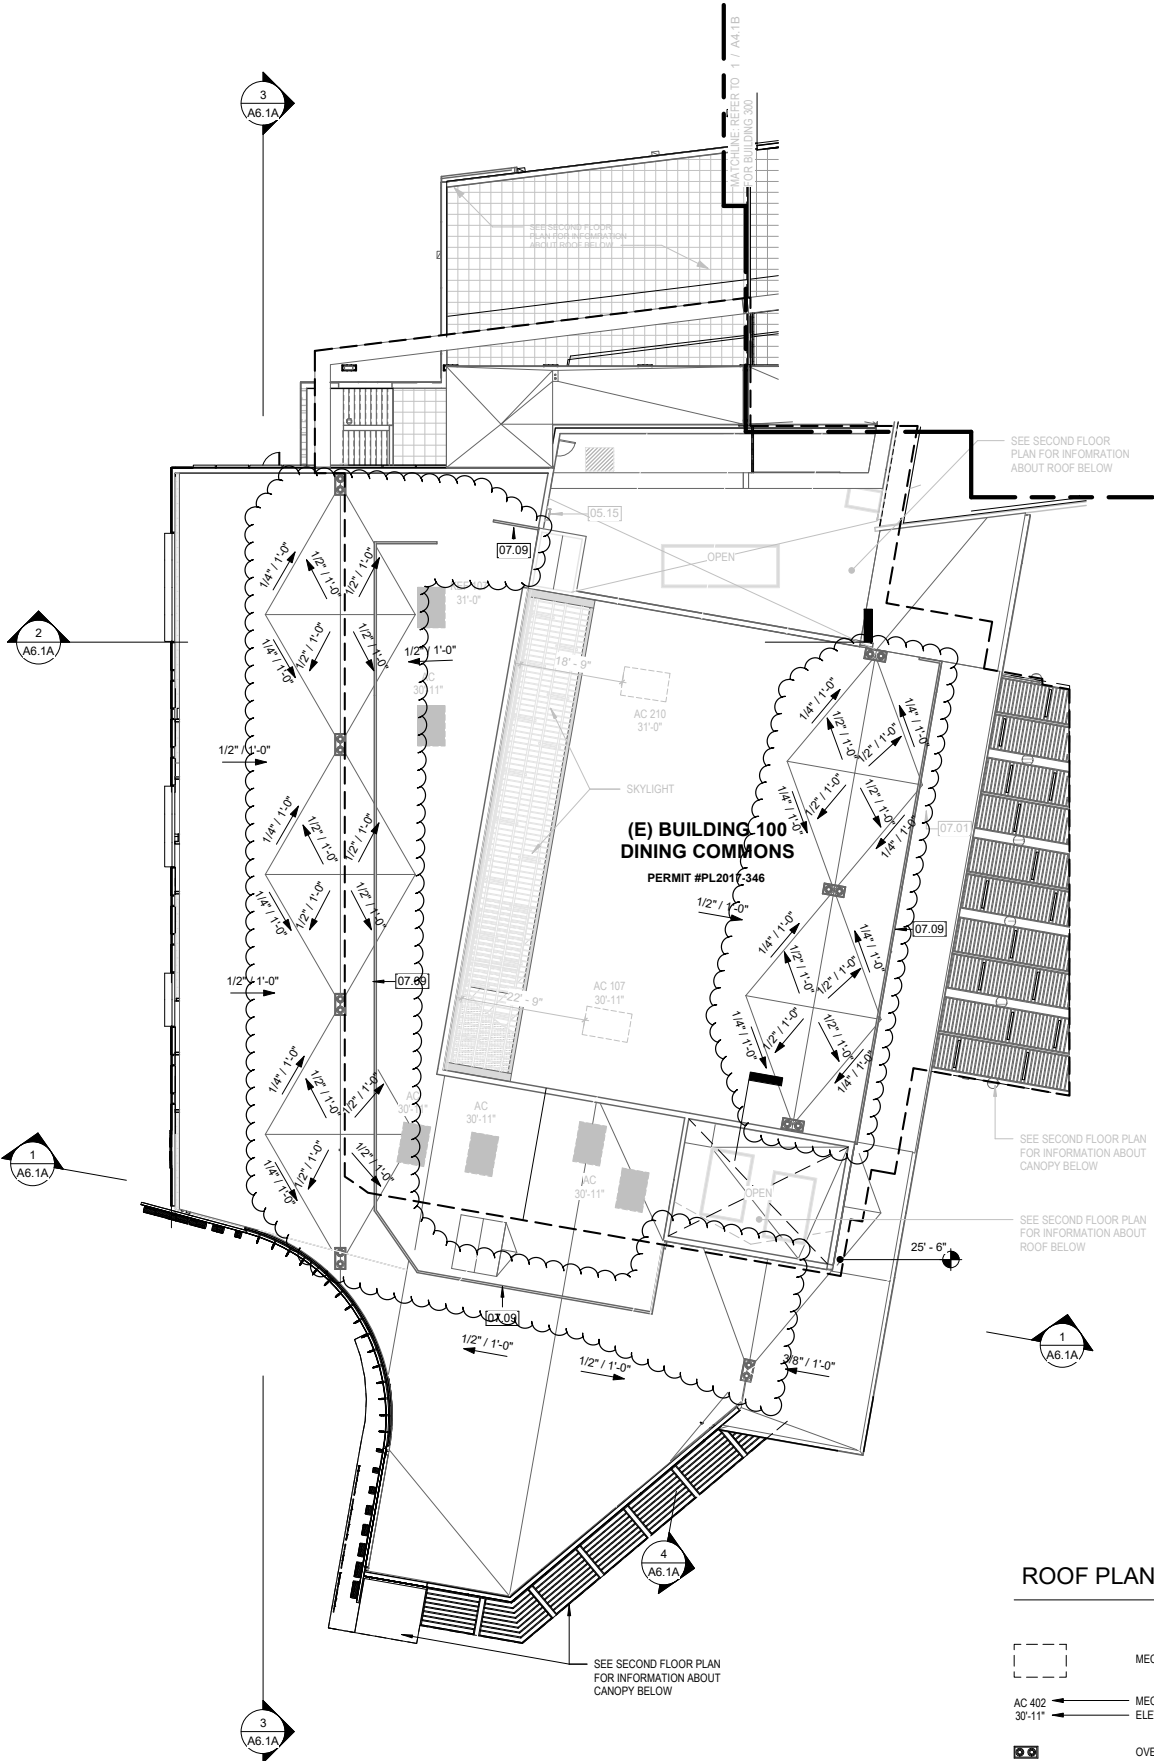
Project:  
**Modification to the Center for Innovation & Dining Commons**

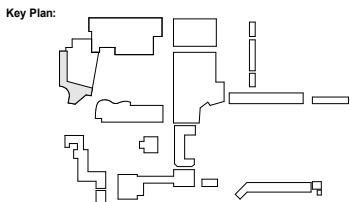Sheet Title:  
**BUILDING 100 - ROOF PLAN**

**PLANNING SUBMITTAL**

Date: 02/04/2022 Client Project No: 3445011000

Sheet:



ROOF PLAN LEGEND

- MECHANICAL EQUIPMENT
- MECHANICAL EQUIPMENT TAG  
ELEVATION @ TOP OF UNIT
- OVERFLOW ROOF DRAIN



BUILDING 100 - ROOF PLAN


1

1/16" = 1'-0"

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A4.1A



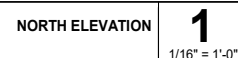

Sheet:

## A5.1A





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EXTERIOR FINISH LEGEND

<b>CONCRETE</b>	
C-1	CONCRETE
COLOR:	STANDARD CONCRETE COLOR
C-2	ACCENT CONCRETE (HARDSCAPE ONLY)
COLOR:	DAVIS COLOR - 677 TAUPE
<b>VENEER MASONRY SYSTEM</b>	
BR-1	FIELD BRICK
MFQ:	PACIFIC CLAY PRODUCTS
TYPE:	ROMAN BRICK VENEER, STACK BOND COURSE
COLOR:	SUNSET RED
SIZE:	7-5/8"W x 2-1/4"H x 3-1/2"D
BR-2	ACCENT BRICK (WINDOW SILLS)
MFQ:	PACIFIC CLAY PRODUCTS
TYPE:	ROMAN BRICK VENEER, SOLDIER BOND
COLOR:	SUNSET RED
SIZE:	7-5/8"W x 2-1/4"H x 3-1/2"D
<b>THERMAL AND MOISTURE PROTECTION</b>	
FCF-1	FIBER CEMENT FACADE PANELS
MFQ:	EQUITONE
STYLE:	TECTIVA
COLOR:	TE20
SIZE:	8mm (5/16") THICKNESS, PANEL SIZE VARIES
MP-1	COMPOSITE METAL PANELS & COLUMN COVERS
MFQ:	ALCOA ARCHITECTURAL PRODUCTS
STYLE:	REYNOBOND
COLOR:	COLORWELD 500XL - BRIGHT SILVER METALLIC
MP-2	COMPOSITE METAL PANEL
MFQ:	ALCOA ARCHITECTURAL PRODUCTS
STYLE:	REYNOBOND
COLOR:	COLORWELD 500 - PEWTER
<b>EXTERIOR DOORS / FRAMES</b>	
HM-1	HOLLOW METAL DOORS / FRAMES
FINISH:	PAINT, SEMI GLOSS
COLOR:	TO MATCH "DUNN EDWARDS 'PLAY ON GRAY' D65228"
<b>ALUMINUM ENTRANCES, STOREFRONTS, AND CURTAIN WALL SYSTEMS</b>	
AL-1	ALUMINUM ENTRANCES, STOREFRONTS, AND CURTAIN WALL
SYSTEMS:	ALUMINUM ENTRANCES, STOREFRONTS, AND CURTAIN WALL
FINISH:	CLEAR ANODIZED
GLAZING:	GL-1, GL-2
<b>GLAZING</b>	
GL-1	INSULATING GLASS UNIT
MFQ:	VIRACON
STYLE:	VE1-45 LOW-E, INSULATING GLASS
GL-2	SPANDREL GLASS
MFQ:	VIRACON
STYLE:	1" INSULATING SPANDREL UNIT
<b>PORTLAND CEMENT PLASTER</b>	
CP-1	CEMENT PLASTER
MFQ:	LA HABRA STUCCO
STYLE:	EXTERIOR STUCCO COLOR COAT
COLOR:	TO MATCH "KELLY MOORE 'HAVERS' TRAW' KIM177-1"
CP-2	CEMENT PLASTER
MFQ:	LA HABRA STUCCO
STYLE:	EXTERIOR STUCCO COLOR COAT / SMOOTH FINISH
PRODUCT:	20/30 FLOAT - BASE 100
COLOR:	BAY RIDGE 81593
<b>ARCHITECTURAL MESH SYSTEMS</b>	
MS-1	ARCHITECTURAL MESH SHADE SYSTEM
MFQ:	CAMBRIDGE ARCHITECTURAL
MATERIAL:	STEEL MESH, 41% OPEN
COLOR:	STAINLESS STEEL
MS-2	VINE SCREEN MESH SYSTEM
MATERIAL:	STEEL WELDED WIRE - POWDER COATED
COLOR:	BAY GRAY
<b>CANOPY LOUVERS</b>	
SC-1	LOUVER SUNSCREEN SYSTEM
MATERIAL:	ALUMINUM
COLOR:	TERRA COTTA

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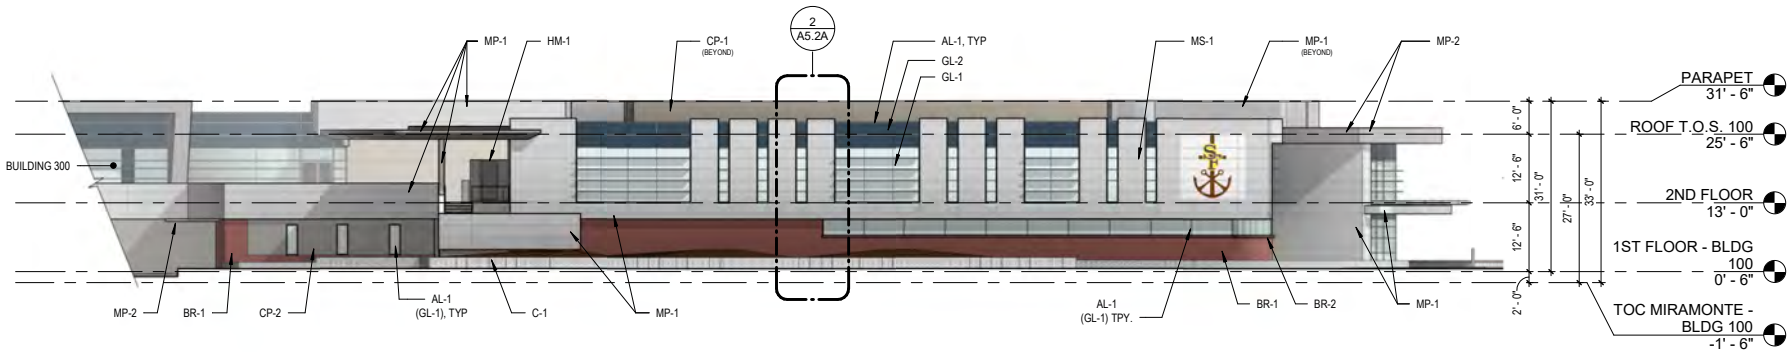
Project:  
**Center for Innovation & Dining Commons**

Sheet Title:  
**BUILDING 100 - (E) EXTERIOR ELEVATIONS**  
FOR REFERENCE - APPROVED PL# 2017-346

PLANNING SUBMITTAL


Date: 11/24/2020 Client Project No: 3445011000

Sheet:




WEST ELEVATION  
(EXISTING ELEVATION PER PL2017-346)

4  
1/16" = 1'-0"

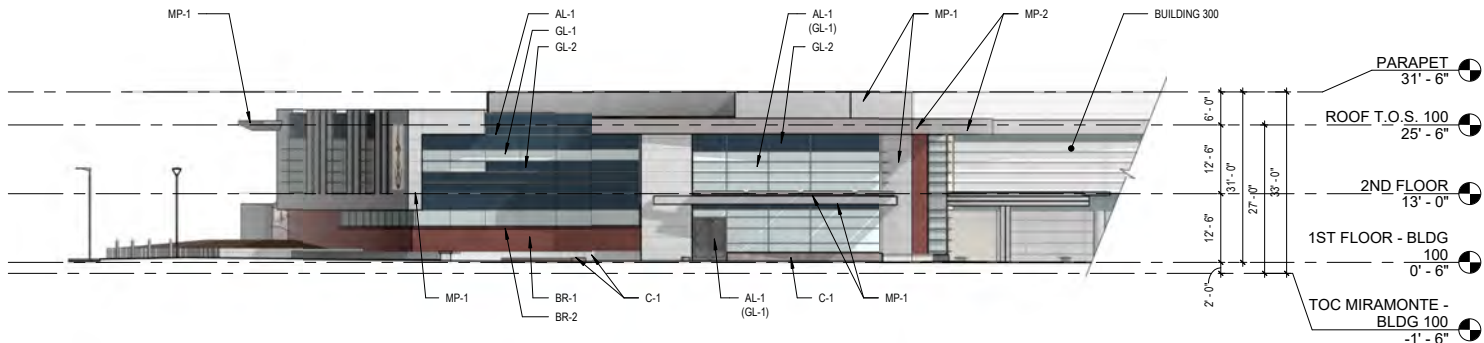


SOUTH ELEVATION  
(EXISTING ELEVATION PER PL2017-346)

3  
1/16" = 1'-0"

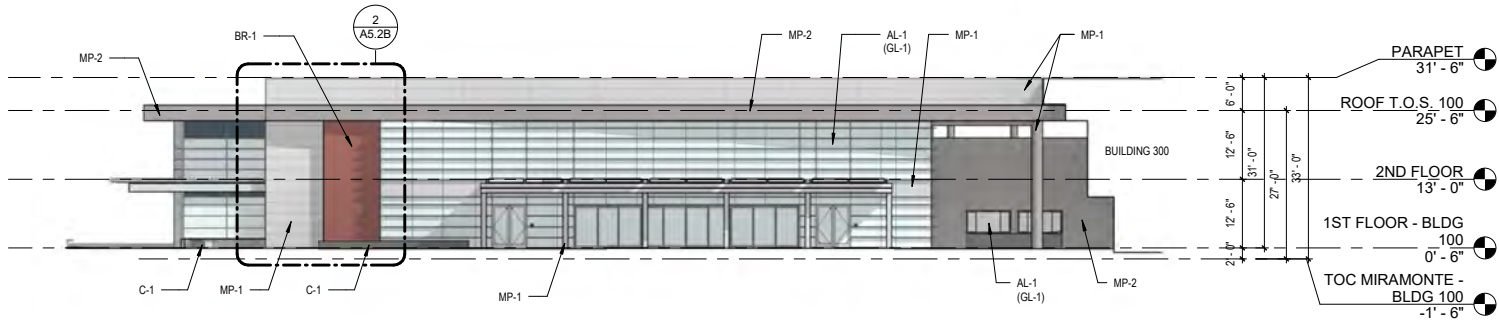


EAST ELEVATION  
(EXISTING ELEVATION PER PL2017-346)

2  
1/16" = 1'-0"

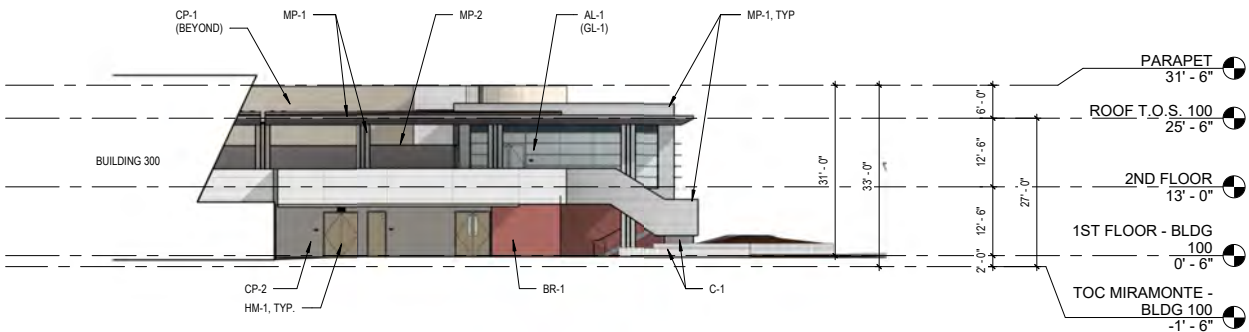

NORTH ELEVATION  
(EXISTING ELEVATION PER PL2017-346)

1  
1/16" = 1'-0"

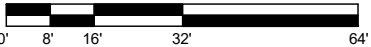





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EXTERIOR FINISH LEGEND

<b>CONCRETE</b>	
C-1	CONCRETE
COLOR:	STANDARD CONCRETE COLOR
<b>C-2</b>	
COLOR:	ACCENT CONCRETE (HARDSCAPE ONLY)
	DAVIS COLOR - 677 TAUPE
<b>VENEER MASONRY SYSTEM</b>	
BR-1	FIELD BRICK
MP-1	PACIFIC CLAY PRODUCTS
MP-2	PACIFIC CLAY PRODUCTS
MP-3	ROMAN BRICK VENEER, STACK BOND COURSE
MP-4	ROMAN BRICK VENEER, SOLDIER BOND
MP-5	SUNSET RED
MP-6	7-5/8"W x 2-1/4"H x 3-1/2"D
<b>THERMAL AND MOISTURE PROTECTION</b>	
FC-1	FIBER CEMENT FACADE PANELS
FC-2	EQUITONE
FC-3	TECTIVA
FC-4	TE20
FC-5	8mm (5/16") THICKNESS, PANEL SIZE VARIES
<b>MP-1</b>	
MP-2	COMPOSITE METAL PANELS & COLUMN COVERS
MP-3	ALCOA ARCHITECTURAL PRODUCTS
MP-4	REYNOLBOND
MP-5	COLORWELD 500XL - BRIGHT SILVER METALLIC
<b>MP-2</b>	
MP-3	COMPOSITE METAL PANEL
MP-4	ALCOA ARCHITECTURAL PRODUCTS
MP-5	REYNOLBOND
MP-6	COLORWELD 500 - PEWTER
<b>EXTERIOR DOORS / FRAMES</b>	
HM-1	HOLLOW METAL DOORS / FRAMES
HM-2	PAINT, SEMI GLOSS
HM-3	TO MATCH "DUNN EDWARDS" PLAY ON GRAY DE5228"
<b>ALUMINUM ENTRANCES, STOREFRONTS, AND CURTAIN WALL SYSTEMS</b>	
AL-1	ALUMINUM ENTRANCES, STOREFRONTS, AND CURTAIN WALL
AL-2	SYSTEMS
AL-3	CLEAR ANODIZED
AL-4	GL-1, GL-2
<b>GLAZING</b>	
GL-1	INSULATING GLASS UNIT
GL-2	VIRACON
GL-3	VEI-45 LOW-E, INSULATING GLASS
<b>GL-2</b>	
GL-3	SPANDREL GLASS
GL-4	VIRACON
GL-5	1" INSULATING SPANDREL UNIT
<b>PORTLAND CEMENT PLASTER</b>	
CP-1	CEMENT PLASTER
CP-2	LA HABRA STUCCO
CP-3	EXTERIOR STUCCO COLOR COAT
CP-4	TO MATCH "KELLY MOORE HAVERS TRAW" KIM 177-1"
<b>CP-2</b>	
CP-3	CEMENT PLASTER
CP-4	LA HABRA STUCCO
CP-5	EXTERIOR STUCCO COLOR COAT / SMOOTH FINISH
CP-6	20/30 FLOAT - BASE 100
CP-7	BAY RIDGE 81593
<b>ARCHITECTURAL MESH SYSTEMS</b>	
MS-1	ARCHITECTURAL MESH SHADE SYSTEM
MS-2	CAMBRIDGE ARCHITECTURAL
MS-3	STEEL MESH, 41% OPEN
MS-4	STAINLESS STEEL
<b>MS-2</b>	
MS-3	VINE SCREEN MESH SYSTEM
MS-4	STEEL WELDED WIRE - POWDER COATED
MS-5	BAY GRAY
<b>CANOPY LOUVERS</b>	
SC-1	LOUVER SUNSCREEN SYSTEM
SC-2	ALUMINUM
SC-3	TERRA COTTA
<b>SCHOOL LOGO</b>	
AL-2	ANODIZED ALUMINUM

Facility:  
Saint Francis High School  
1885 Miramonte Ave  
Mountain View, CA 94040

Project:  
Modification to the Center for Innovation & Dining Commons


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BUILDING 100 - EXTERIOR ELEVATIONS

PLANNING SUBMITTAL


Date: 02/04/2022 Client Project No: 3445011000

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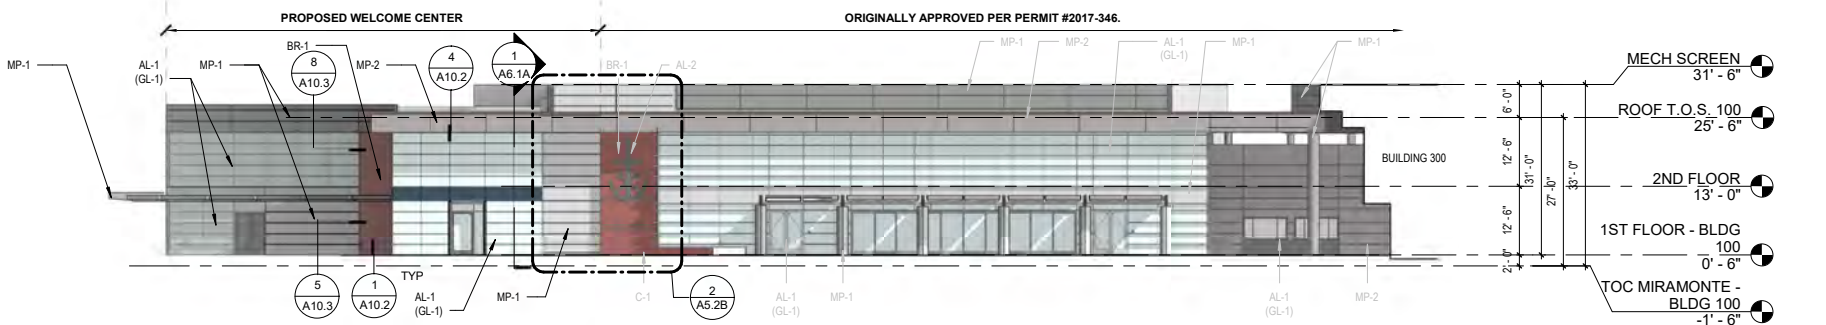
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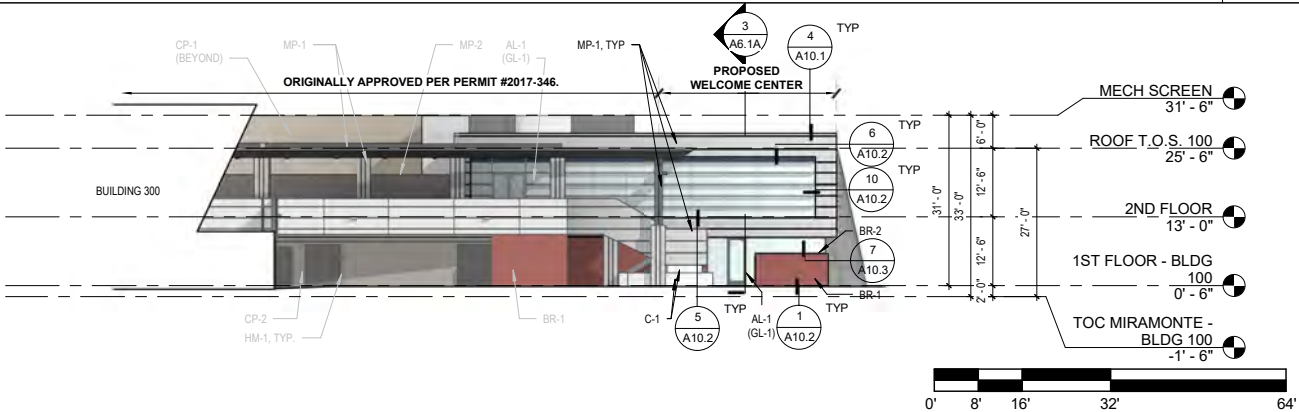
WEST ELEVATION 4  
1/16" = 1'-0"

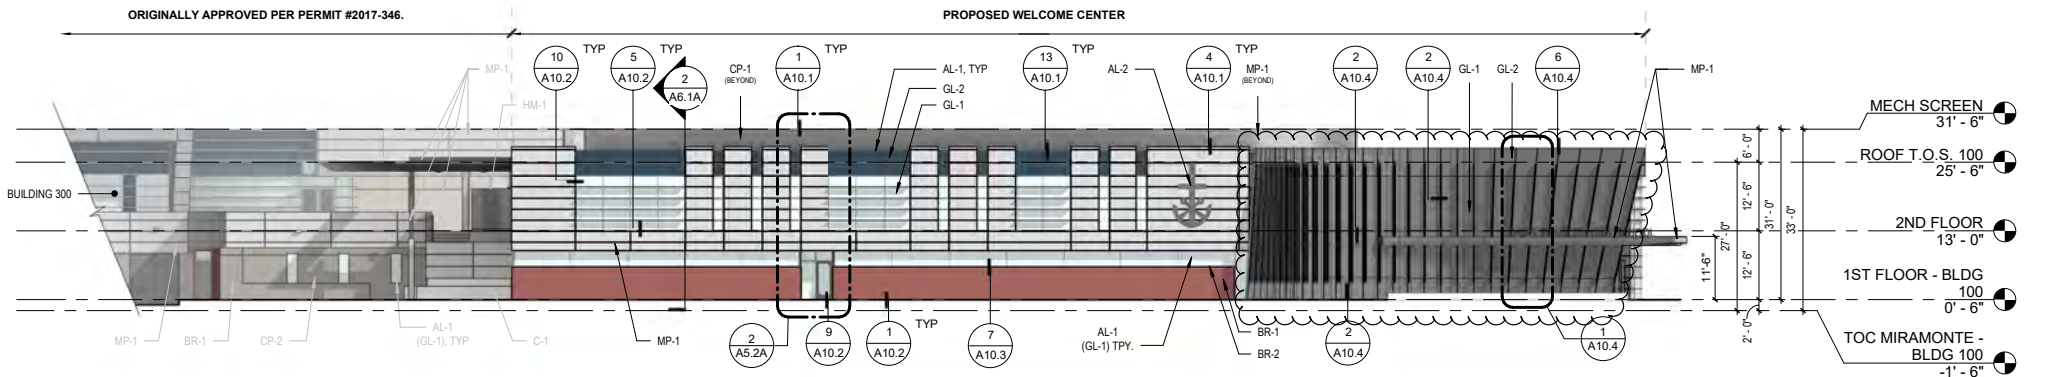

SOUTH ELEVATION 3  
1/16" = 1'-0"

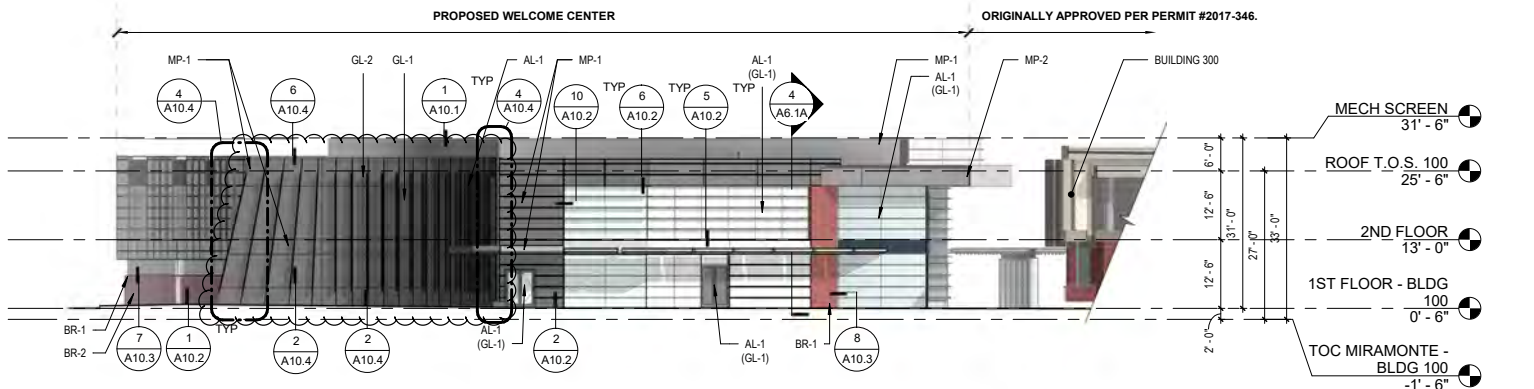

EAST ELEVATION 2  
1/16" = 1'-0"



NORTH ELEVATION 1  
1/16" = 1'-0"





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EXTERIOR FINISH LEGEND

<b>CONCRETE</b>	
C-1 COLOR:	CONCRETE STANDARD CONCRETE COLOR
C-2 COLOR:	ACCENT CONCRETE (HARDSCAPE ONLY) DAVIS COLOR - 677 TAUPE
<b>VENEER MASONRY SYSTEM</b>	
BR-1 MFG: TYPE: COLOR: SIZE:	FIELD BRICK PACIFIC CLAY PRODUCTS ROMAN BRICK VENEER, STACK BOND COURSE SUNSET RED 7-5/8"W x 2-1/4"H x 3-1/2"D
BR-2 MFG: TYPE: COLOR: SIZE:	ACCENT BRICK (WINDOW SILLS) PACIFIC CLAY PRODUCTS ROMAN BRICK VENEER, SOLDIER BOND SUNSET RED 7-5/8"W x 2-1/4"H x 3-1/2"D
<b>THERMAL AND MOISTURE PROTECTION</b>	
FCF-1 MFG: STYLE: COLOR: SIZE:	FIBER CEMENT FACADE PANELS EQUITONE TECTIVA TE20 8mm (5/16") THICKNESS, PANEL SIZE VARIES
MP-1 MFG: STYLE: COLOR:	COMPOSITE METAL PANELS & COLUMN COVERS ALCOA ARCHITECTURAL PRODUCTS REYNOBOND COLORWELD 500XL - BRIGHT SILVER METALLIC
MP-2 MFG: STYLE: COLOR:	COMPOSITE METAL PANEL ALCOA ARCHITECTURAL PRODUCTS REYNOBOND COLORWELD 500 - PEWTER

<b>EXTERIOR DOORS / FRAMES</b>	
HM-1 FINISH: COLOR:	HOLLOW METAL DOORS / FRAMES PAINT, SEMI GLOSS TO MATCH "DUNN EDWARDS 'PLAY ON GRAY' D66228"

<b>ALUMINUM ENTRANCES, STOREFRONTS, AND CURTAIN WALL SYSTEMS</b>	
AL-1 FINISH: GLAZING:	ALUMINUM ENTRANCES, STOREFRONTS, AND CURTAIN WALL SYSTEMS CLEAR ANNOXIDIZED GL-1, GL-2

GL-1 MFG: STYLE:	INSULATING GLASS UNIT VIRACON VE1-45 LOW-E, INSULATING GLASS
GL-2 MFG: STYLE:	SPANDREL GLASS VIRACON 1" INSULATING SPANDREL UNIT

<b>PORTLAND CEMENT PLASTER</b>	
CP-1 MFG: STYLE: COLOR:	CEMENT PLASTER LA HABRA STUCCO EXTERIOR STUCCO COLOR COAT TO MATCH "KELLY MOORE 'HAVERSTRAW' KM177-1"
CP-2 MFG: STYLE: PRODUCT: COLOR:	CEMENT PLASTER LA HABRA STUCCO EXTERIOR STUCCO COLOR COAT / SMOOTH FINISH 2030 FLOAT - BASE: 100 BAY RIDGE #1593

<b>ARCHITECTURAL MESH SYSTEMS</b>	
MS-1 MFG: MATERIAL: COLOR:	ARCHITECTURAL MESH SHADE SYSTEM CAMBRIDGE ARCHITECTURAL STEEL MESH, 41% OPEN STAINLESS STEEL

MS-2 MATERIAL: COLOR:	VINE SCREEN MESH SYSTEM STEEL WELDED WIRE - POWDER COATED BAY GRAY
-----------------------------	--

<b>CANOPY LOUVERS</b>	
SC-1 MATERIAL: COLOR:	LOUVER SUNSCREEN SYSTEM ALUMINUM TERRA COTTA

<b>SCHOOL LOGO</b>	
AL-2	ANNOXIDIZED ALUMINUM

Facility:  
**Saint Francis High School**  
1885 Miramonte Ave  
Mountain View, CA 94040

Project:  
**Modification to the Center for Innovation & Dining Commons**


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**BUILDING 100 - ENLARGED EXTERIOR MATERIAL PATTERN DETAIL**

**PLANNING SUBMITTAL**

Date: 02/04/2022 Client Project No: 3445011000

Sheet:

A5.2A

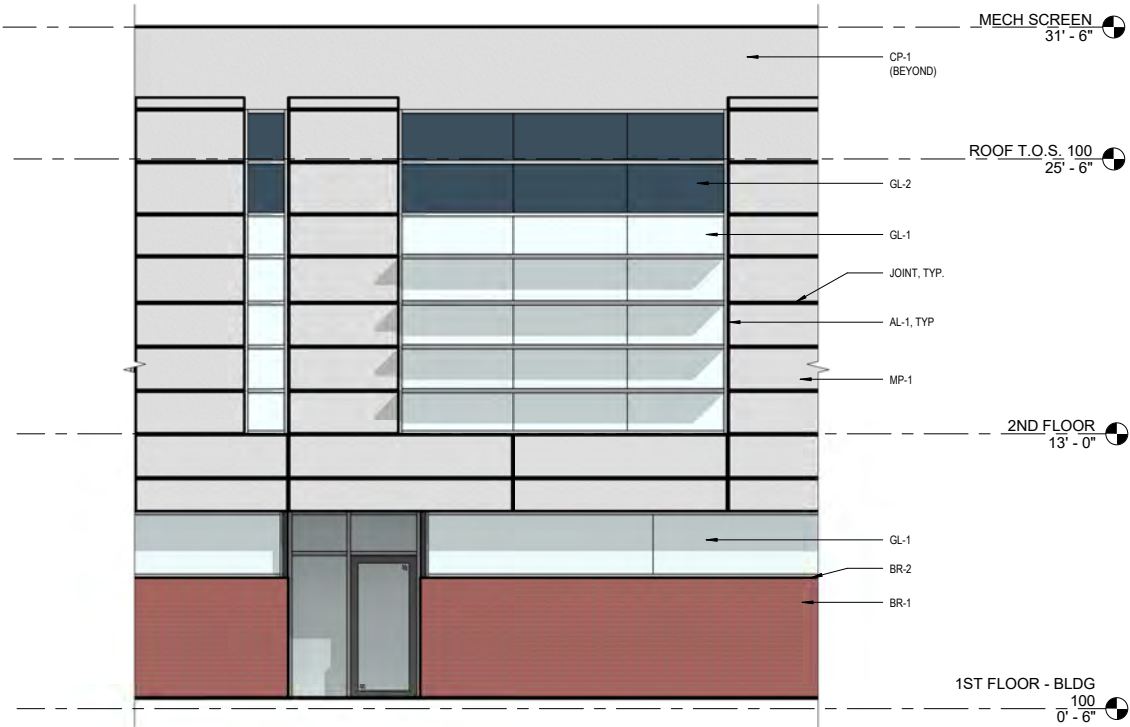


WEST ELEVATION - ENLARGED

2

(NO MODIFICATIONS TO PROPOSED BUILDING MATERIALS FOR PROPOSED WELCOME CENTER ADDITION)

1/4" = 1'-0"

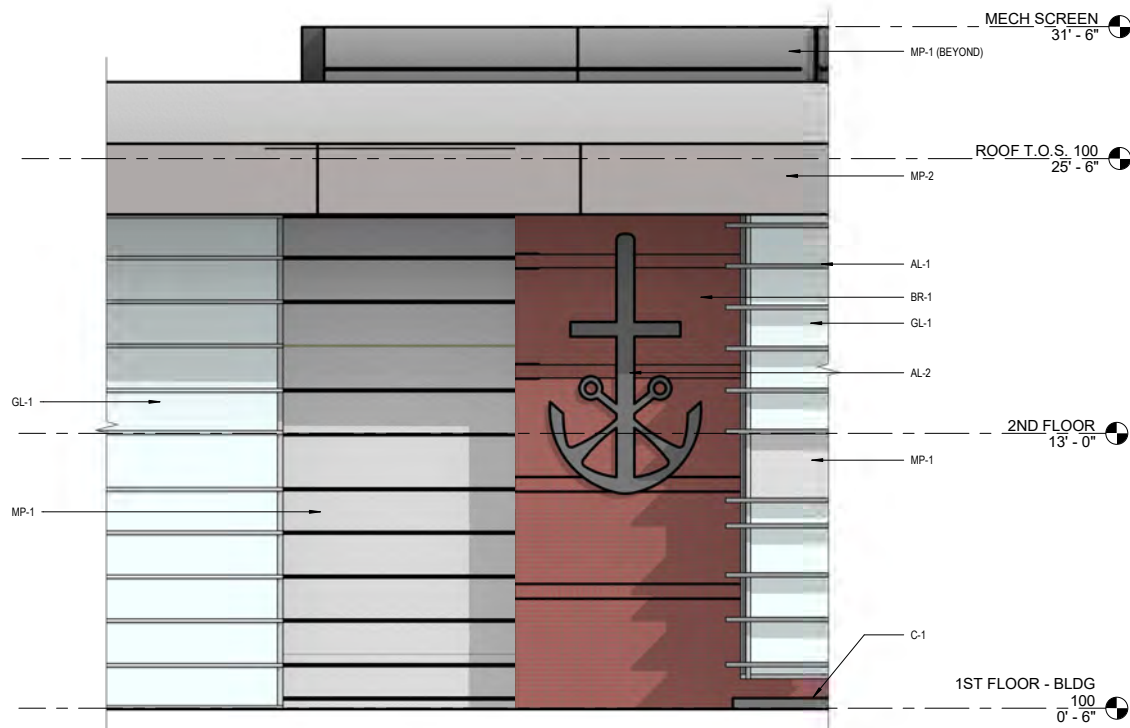

EAST ELEVATION - ENLARGED

1

(NO MODIFICATIONS TO PROPOSED BUILDING MATERIALS FOR PROPOSED WELCOME CENTER ADDITION)

1/4" = 1'-0"





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Keynotes:

Key Plan:

Agency  
Approval:

File No.:

Facility:  
Saint Francis High School  
1885 Miramonte Ave  
Mountain View, CA 94040

Project:  
Modification to the Center for Innovation & Dining Commons

Sheet Title:  
MATERIAL BOARD

PLANNING SUBMITTAL

Date: 02/04/2022 Client Project No: 3445011000

Sheet:

A5.3A

EXTERIOR FINISH LEGEND

<b>CONCRETE</b>	
C-1	CONCRETE
COLOR:	STANDARD CONCRETE COLOR
<b>C-2</b>	
COLOR:	ACCENT CONCRETE (HARDSCAPE ONLY)
	DAVIS COLOR - 677 TAUPE
<b>VENEER MASONRY SYSTEM</b>	
BR-1	FIELD BRICK
MFG:	PACIFIC CLAY PRODUCTS
TYPE:	ROMAN BRICK VENEER, STACK BOND COURSE
COLOR:	SUNSET RED
SIZE:	7-5/8"W x 2-1/4"H x 3-1/2"D
BR-2	ACCENT BRICK (WINDOW SILLS)
MFG:	PACIFIC CLAY PRODUCTS
TYPE:	ROMAN BRICK VENEER, SOLDIER BOND
COLOR:	SUNSET RED
SIZE:	7-5/8"W x 2-1/4"H x 3-1/2"D
<b>THERMAL AND MOISTURE PROTECTION</b>	
FCF-1	FIBER CEMENT FACADE PANELS
MFG:	EQUITONE
STYLE:	TECTIVA
COLOR:	TE20
SIZE:	8mm (5/16") THICKNESS, PANEL SIZE VARIES
MP-1	COMPOSITE METAL PANELS & COLUMN COVERS
MFG:	ALCOA ARCHITECTURAL PRODUCTS
STYLE:	REYNOBOND
COLOR:	COLORWELD 500XL - BRIGHT SILVER METALLIC
MP-2	COMPOSITE METAL PANEL
MFG:	ALCOA ARCHITECTURAL PRODUCTS
STYLE:	REYNOBOND
COLOR:	COLORWELD 500 - PEWTER
<b>EXTERIOR DOORS / FRAMES</b>	
HM-1	HOLLOW METAL DOORS / FRAMES
FINISH:	PAINT, SEMI GLOSS
COLOR:	TO MATCH "DUNN EDWARDS "PLAY ON GRAY" DE6228"
<b>ALUMINUM ENTRANCES, STOREFRONTS, AND CURTAIN WALL SYSTEMS</b>	
AL-1	ALUMINUM ENTRANCES, STOREFRONTS, AND CURTAIN WALL SYSTEMS
FINISH:	CLEAR ANNOXIDIZED
GLAZING:	GL-1, GL-2
<b>GLAZING</b>	
GL-1	INSULATING GLASS UNIT
MFG:	VIRACON
STYLE:	VE1-45 LOW-E, INSULATING GLASS
GL-2	SPANDREL GLASS
MFG:	VIRACON
STYLE:	1" INSULATING SPANDREL UNIT
<b>PORTLAND CEMENT PLASTER</b>	
CP-1	CEMENT PLASTER
MFG:	LA HABRA STUCCO
STYLE:	EXTERIOR STUCCO COLOR COAT
COLOR:	TO MATCH "KELLY MOORE "HAVERSTRAW" KM1177-1"
CP-2	CEMENT PLASTER
MFG:	LA HABRA STUCCO
STYLE:	EXTERIOR STUCCO COLOR COAT / SMOOTH FINISH
PRODUCT:	2030 FLOAT - BASE 100
COLOR:	BAY RIDGE 81993
<b>ARCHITECTURAL MESH SYSTEMS</b>	
MS-1	ARCHITECTURAL MESH SHADE SYSTEM
MFG:	CAMBRIDGE ARCHITECTURAL
MATERIAL:	STEEL MESH, 41% OPEN
COLOR:	STAINLESS STEEL
MS-2	VINE SCREEN MESH SYSTEM
MATERIAL:	STEEL WELDED WIRE - POWDER COATED
COLOR:	BAY GRAY
<b>CANOPY LOUVERS</b>	
SC-1	LOUVER SUNSCREEN SYSTEM
MATERIAL:	ALUMINUM
COLOR:	TERRA COTTA
<b>SCHOOL LOGO</b>	
AL-2	ANNOXIDIZED ALUMINUM

(NO MODIFICATIONS TO PROPOSED BUILDING MATERIALS FOR PROPOSED WELCOME CENTER ADDITION)



C-1  
CONCRETE

C-2  
ACCENT CONCRETE

BR-1  
FIELD BRICK

BR-2  
ACCENT BRICK (SILL)

FCF-1  
FIBER CEMENT FACADE PANEL

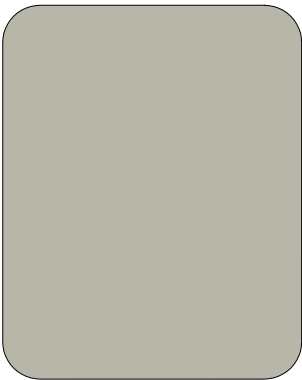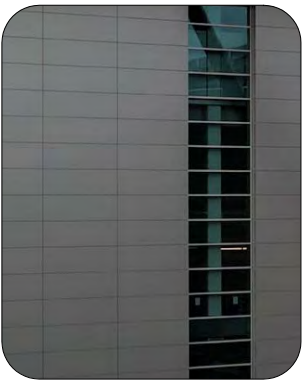

(NO MODIFICATIONS TO PROPOSED BUILDING MATERIALS FOR PROPOSED WELCOME CENTER ADDITION)



MP-1  
COMPOSITE METAL PANELS & COLUMN COVERS

MP-2  
COMPOSITE METAL PANELS

HM-1  
HOLLOW METAL DOORS / FRAMES

AL-1  
ALUMINUM ENTRANCES, STOREFRONTS & CURTAIN WALLS

GL-1  
INSULATING GLASS UNIT

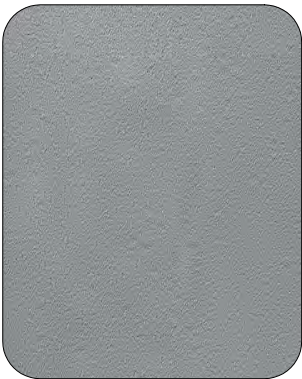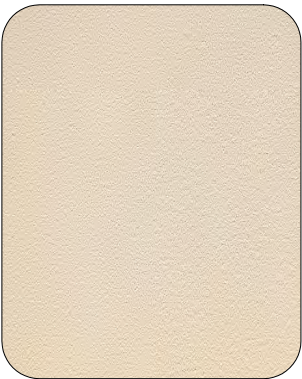

(NO MODIFICATIONS TO PROPOSED BUILDING MATERIALS FOR PROPOSED WELCOME CENTER ADDITION)

GL-2  
SPANDREL GLASS

CP-1  
CEMENT PLASTER

CP-2  
CEMENT PLASTER

MS-1  
ARCHITECTURAL MESH SHADE SYSTEM

MS-2  
VINE SCREEN MESH SYSTEM

SC-1  
LOUVER SUNSCREEN SYSTEM (COLOR ONLY)





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Keynotes:

Key Plan:

Agency  
Approval:

File No.:

Facility:  
Saint Francis High School  
1885 Miramonte Ave  
Mountain View, CA 94040


Project:  
Modification to the Center for Innovation &  
Dining Commons

Sheet Title:  
BUILDING 100 - BUILDING SECTIONS


PLANNING SUBMITTAL

Date: 02/04/2022 Client Project No: 3445011000


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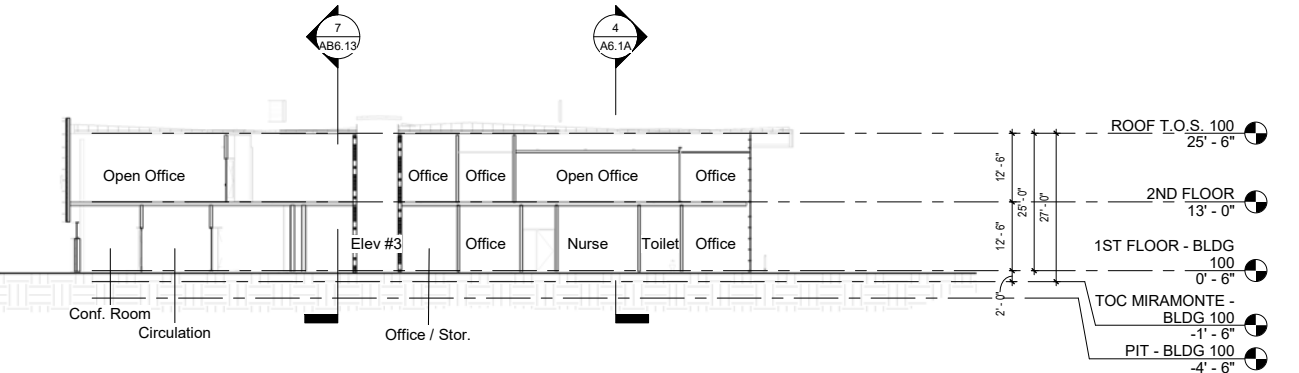
BUILDING 100 - SECTION 5  
3  
1/16" = 1'-0"

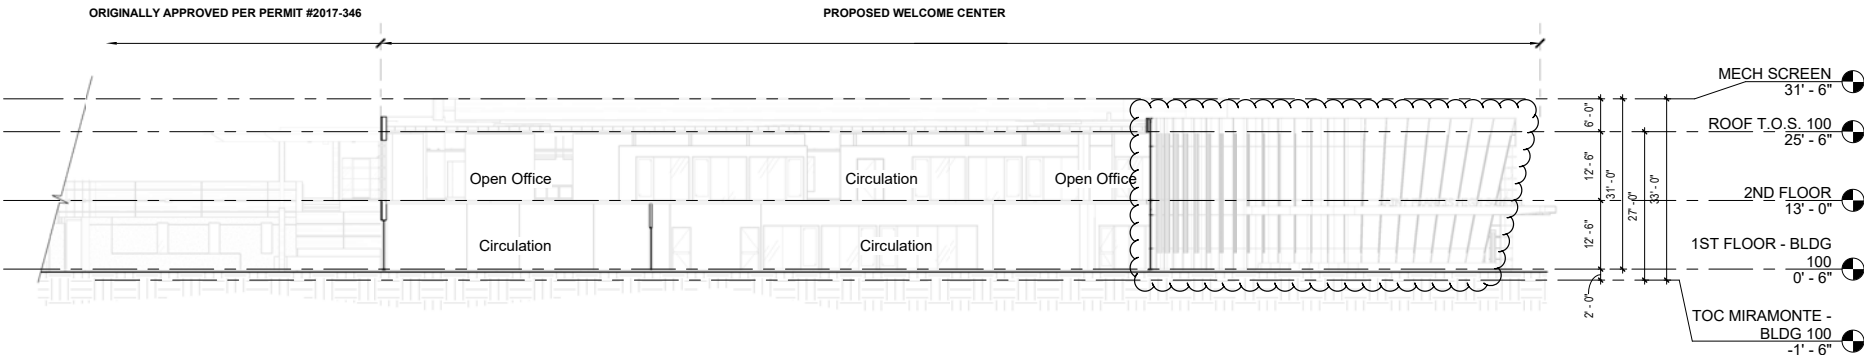

BUILDING 100 - SECTION 2  
2  
1/16" = 1'-0"

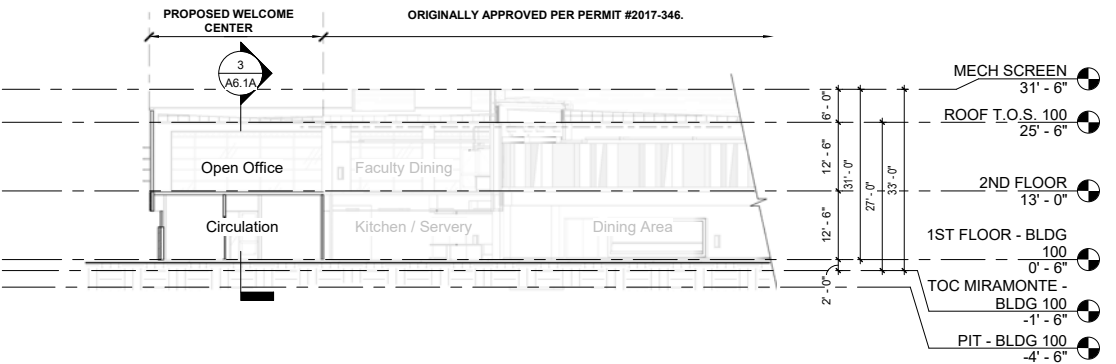

BUILDING 100 - SECTION 4  
4  
1/16" = 1'-0"

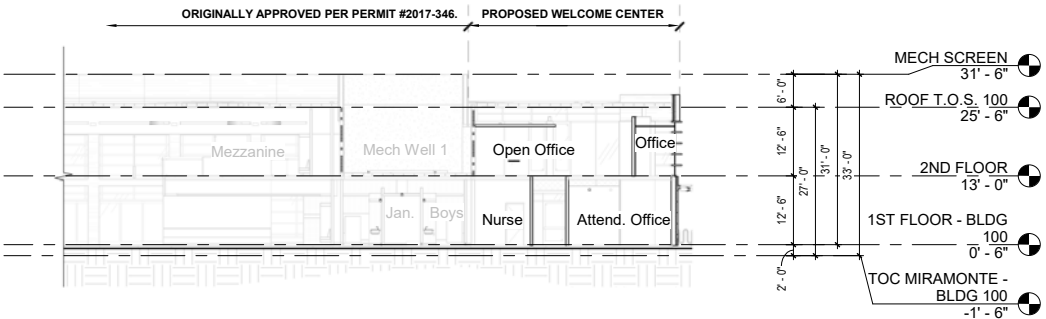

BUILDING 100 - SECTION 1  
1  
1/16" = 1'-0"






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Keynotes:

Key Plan:



Consultant:

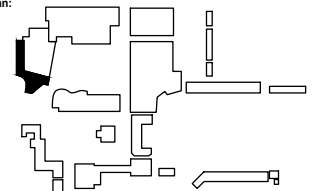

Agency  
Approval:

File No.:

Facility:  
Saint Francis High School  
1885 Miramonte Ave  
Mountain View, CA 94040

Project:  
Modification to the Center for Innovation &  
Dining Commons

Sheet Title:  
Site Paving and Amenities Color Plan

PLANNING SUBMITTAL


Date: 02/18/2022 Client Project No: 3445011000

Sheet:

L0.0



KEY	SITE PAVING AND AMENITIES LEGEND
	TREES - NOT ALL SYMBOLS SHOWN
	SHRUB/GROUNDCOVER AREA
	ACCENT PAVING COLOR: DAVIS COLOR 677 TAUPE FINISH: SALT MEDIUM
	CONCRETE PAVING COLOR: NO COLOR FINISH: BROOM
	BLACK RIVER ROCKS
	ASPHALT
	24"x60" BLUESTONE PAVERS
	LANDSCAPE WALLS WITH BRICK CAP
	LANDSCAPE WALLS WITH CONCRETE CAP
	LIGHT POLE LOCATION
	DENOTES BUILDING ENTRANCE
	LIMITS OUTSIDE OF WELCOME CENTER REVIEW SCOPE

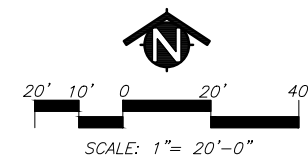



21-43

**MTW** group  
LANDSCAPE ARCHITECTURE  
AND PLANNING  
2707 K Street, Suite 201  
Sacramento, CA 95816  
916 369-3990





KEY	PROJECT AREA TREE LIST LEGEND
	TREES WITHIN PROJECT AREA TO BE RETAINED OR RELOCATED
	TREES WITHIN PROJECT AREA TO BE REMOVED


NOTE:

FOR HERITAGE TREES DESIGNATION, SEE "HERITAGE" COLUMN ON EACH CORRESPONDING CHART.


HERITAGE TREE PLACEMENT NOTE:

INCLUDED IN THIS DESIGN WILL BE THE REMOVAL OF 1 HERITAGE AND 1 NON-HERITAGE TREE (#43 & #44). THE REMOVAL OF THESE TREES IS A RESULT OF THE CONFLICT BETWEEN EXISTING TREE LOCATIONS, BUILDING MODIFICATIONS, AND NEW SITE WORK PLACEMENT. SEE SHEET L1.1 FOR TREE REPLACEMENTS.

21-43

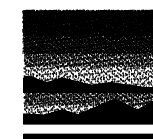

**MTW** *group*  
LANDSCAPE ARCHITECTURE  
AND PLANNING  
2707 K Street, Suite 201  
Sacramento, CA 95816  
916 369-3990

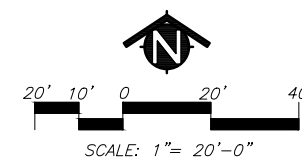






HMC Architects

3445011000


2495 Natomas Park Drive, Studio 100  
Sacramento, CA 95833  
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Keynotes:


KEY	SITE DIMENSIONS LEGEND
	LIMITS OUTSIDE OF WELCOME CENTER REVIEW SCOPE

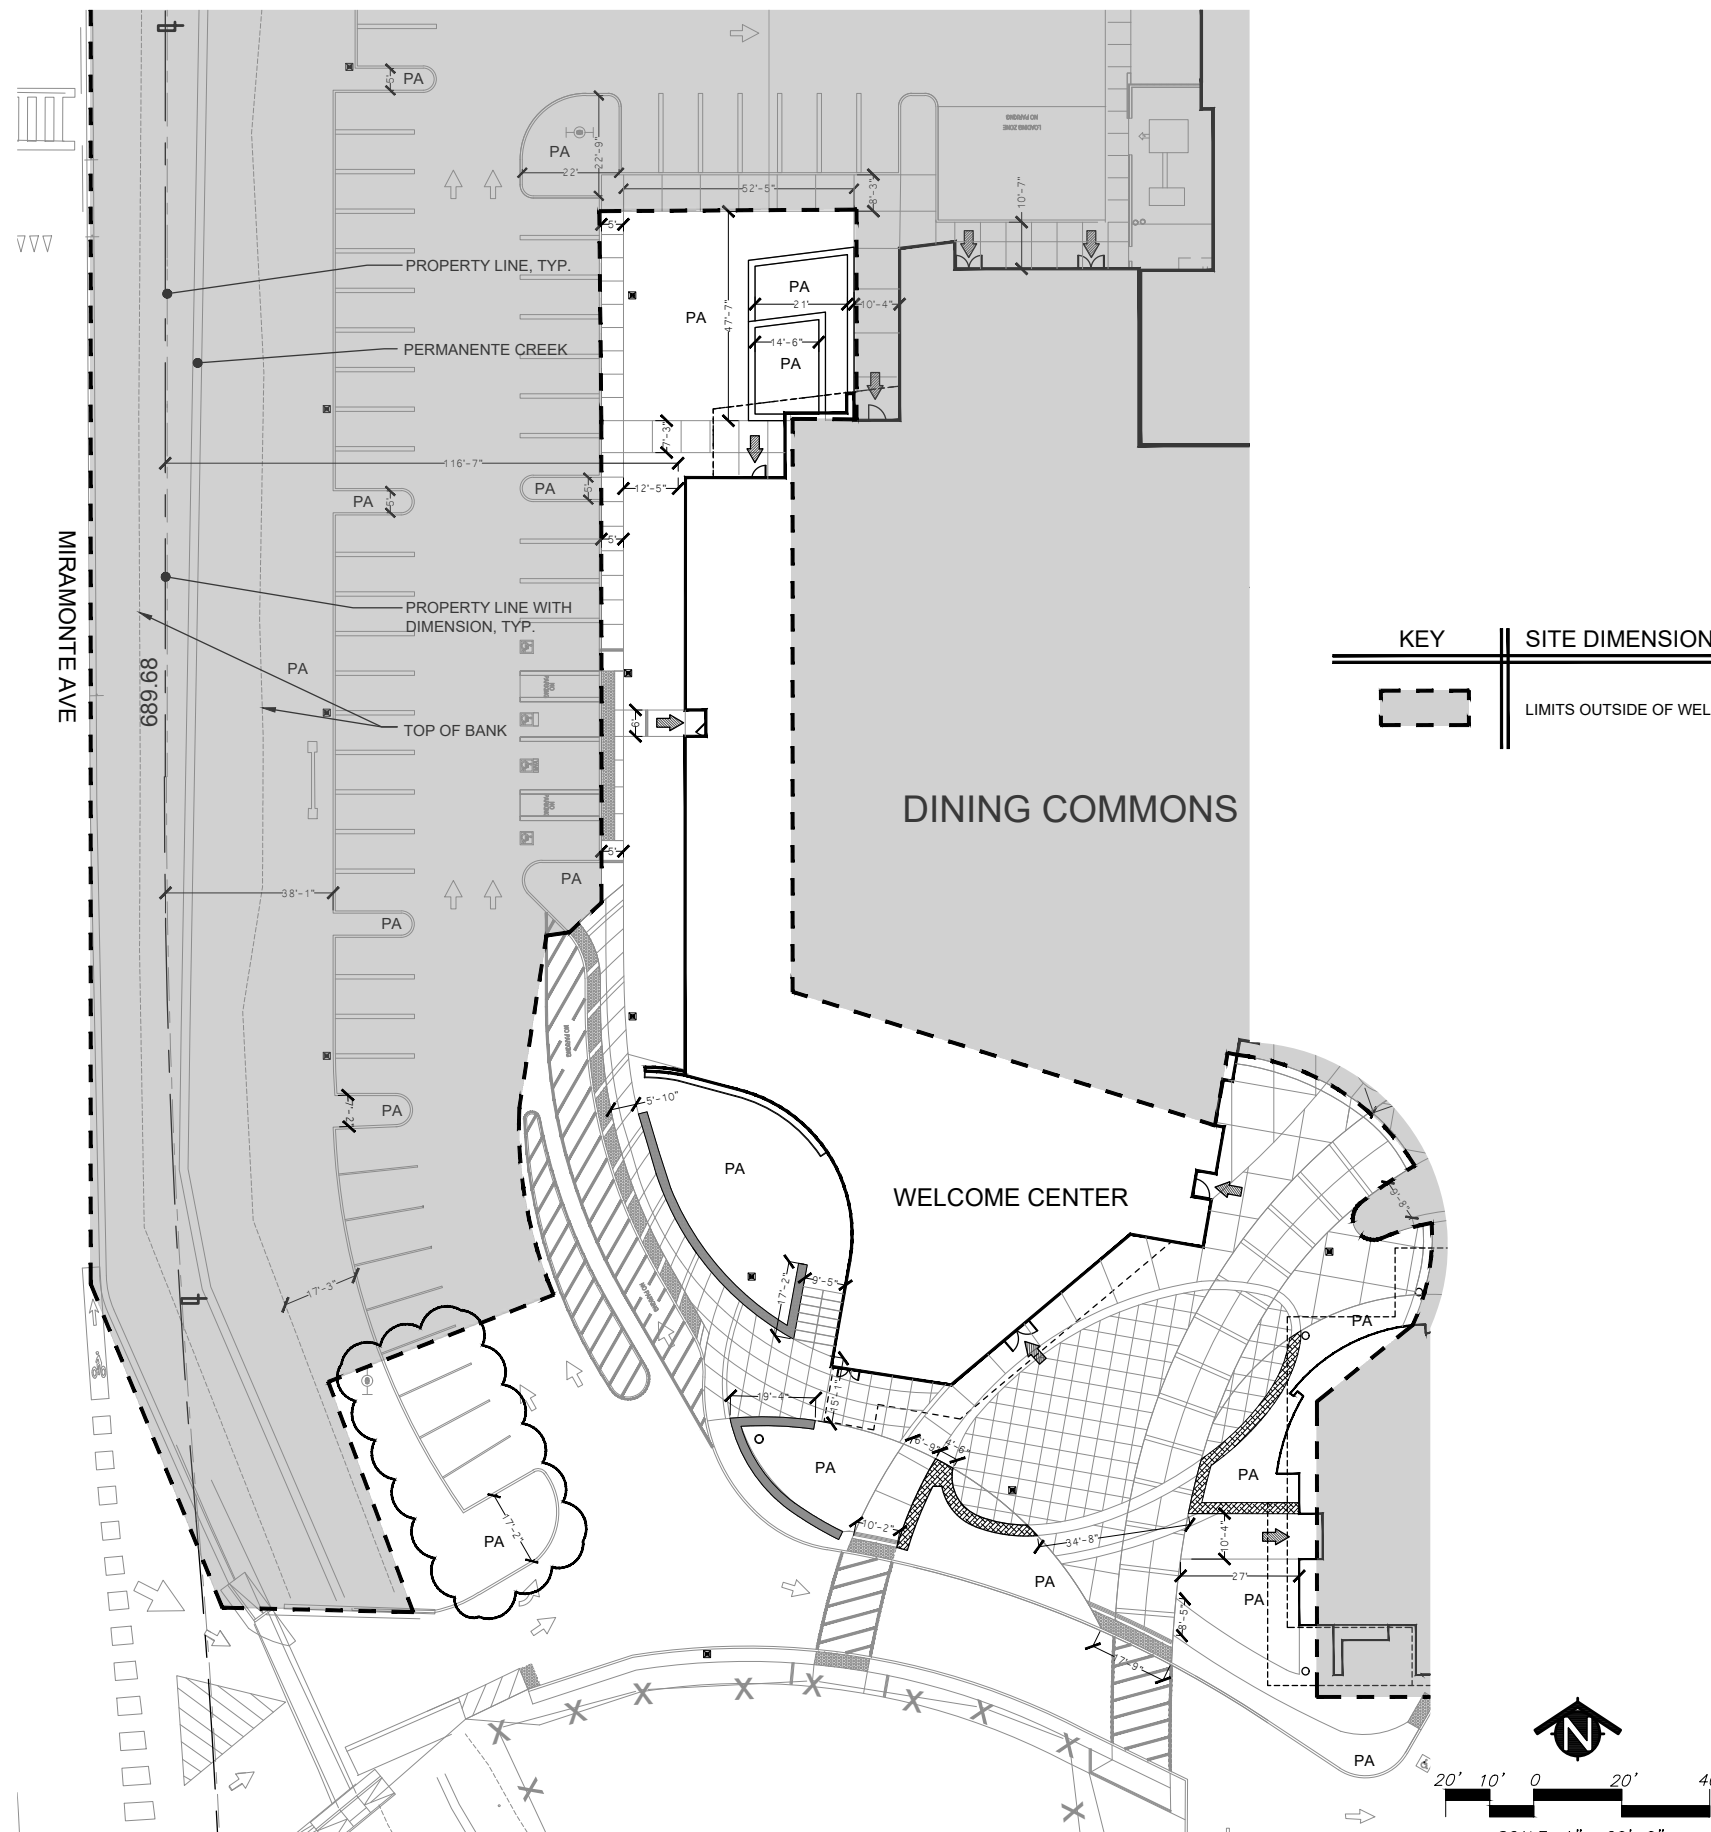

Key Plan:

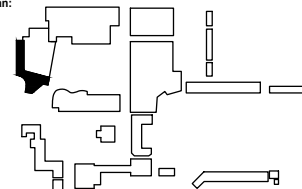

Consultant:

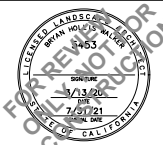

Agency  
Approval:

File No.:

Facility:  
**Saint Francis High School**  
1885 Miramonte Ave  
Mountain View, CA 94040

Project:  
**Modification to the Center for Innovation & Dining Commons**


Sheet Title:  
**Site Dimensions**

**PLANNING SUBMITTAL**

Date: 02/18/2022 Client Project No: 3445011000

Sheet:

21-43

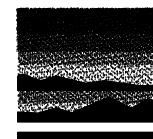

**MTW** group  
LANDSCAPE ARCHITECTURE  
AND PLANNING  
2707 K Street, Suite 201  
Sacramento, CA 95816  
916 369-3990

L0.2






HMC Architects

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Sacramento, CA 95833  
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Keynotes:

Key Plan:



Consultant:

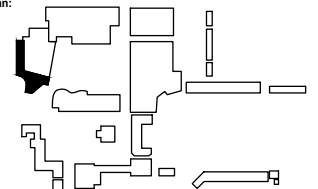

Agency

Approval:

File No.:

Facility:

Saint Francis High School  
1885 Miramonte Ave  
Mountain View, CA 94040

Project:

Modification to the Center for Innovation & Dining Commons

Sheet Title:

Site Paving and Amenities Plan


PLANNING SUBMITTAL

Date: 02/18/2022

Client Project No: 3445011000

Sheet:

L0.3

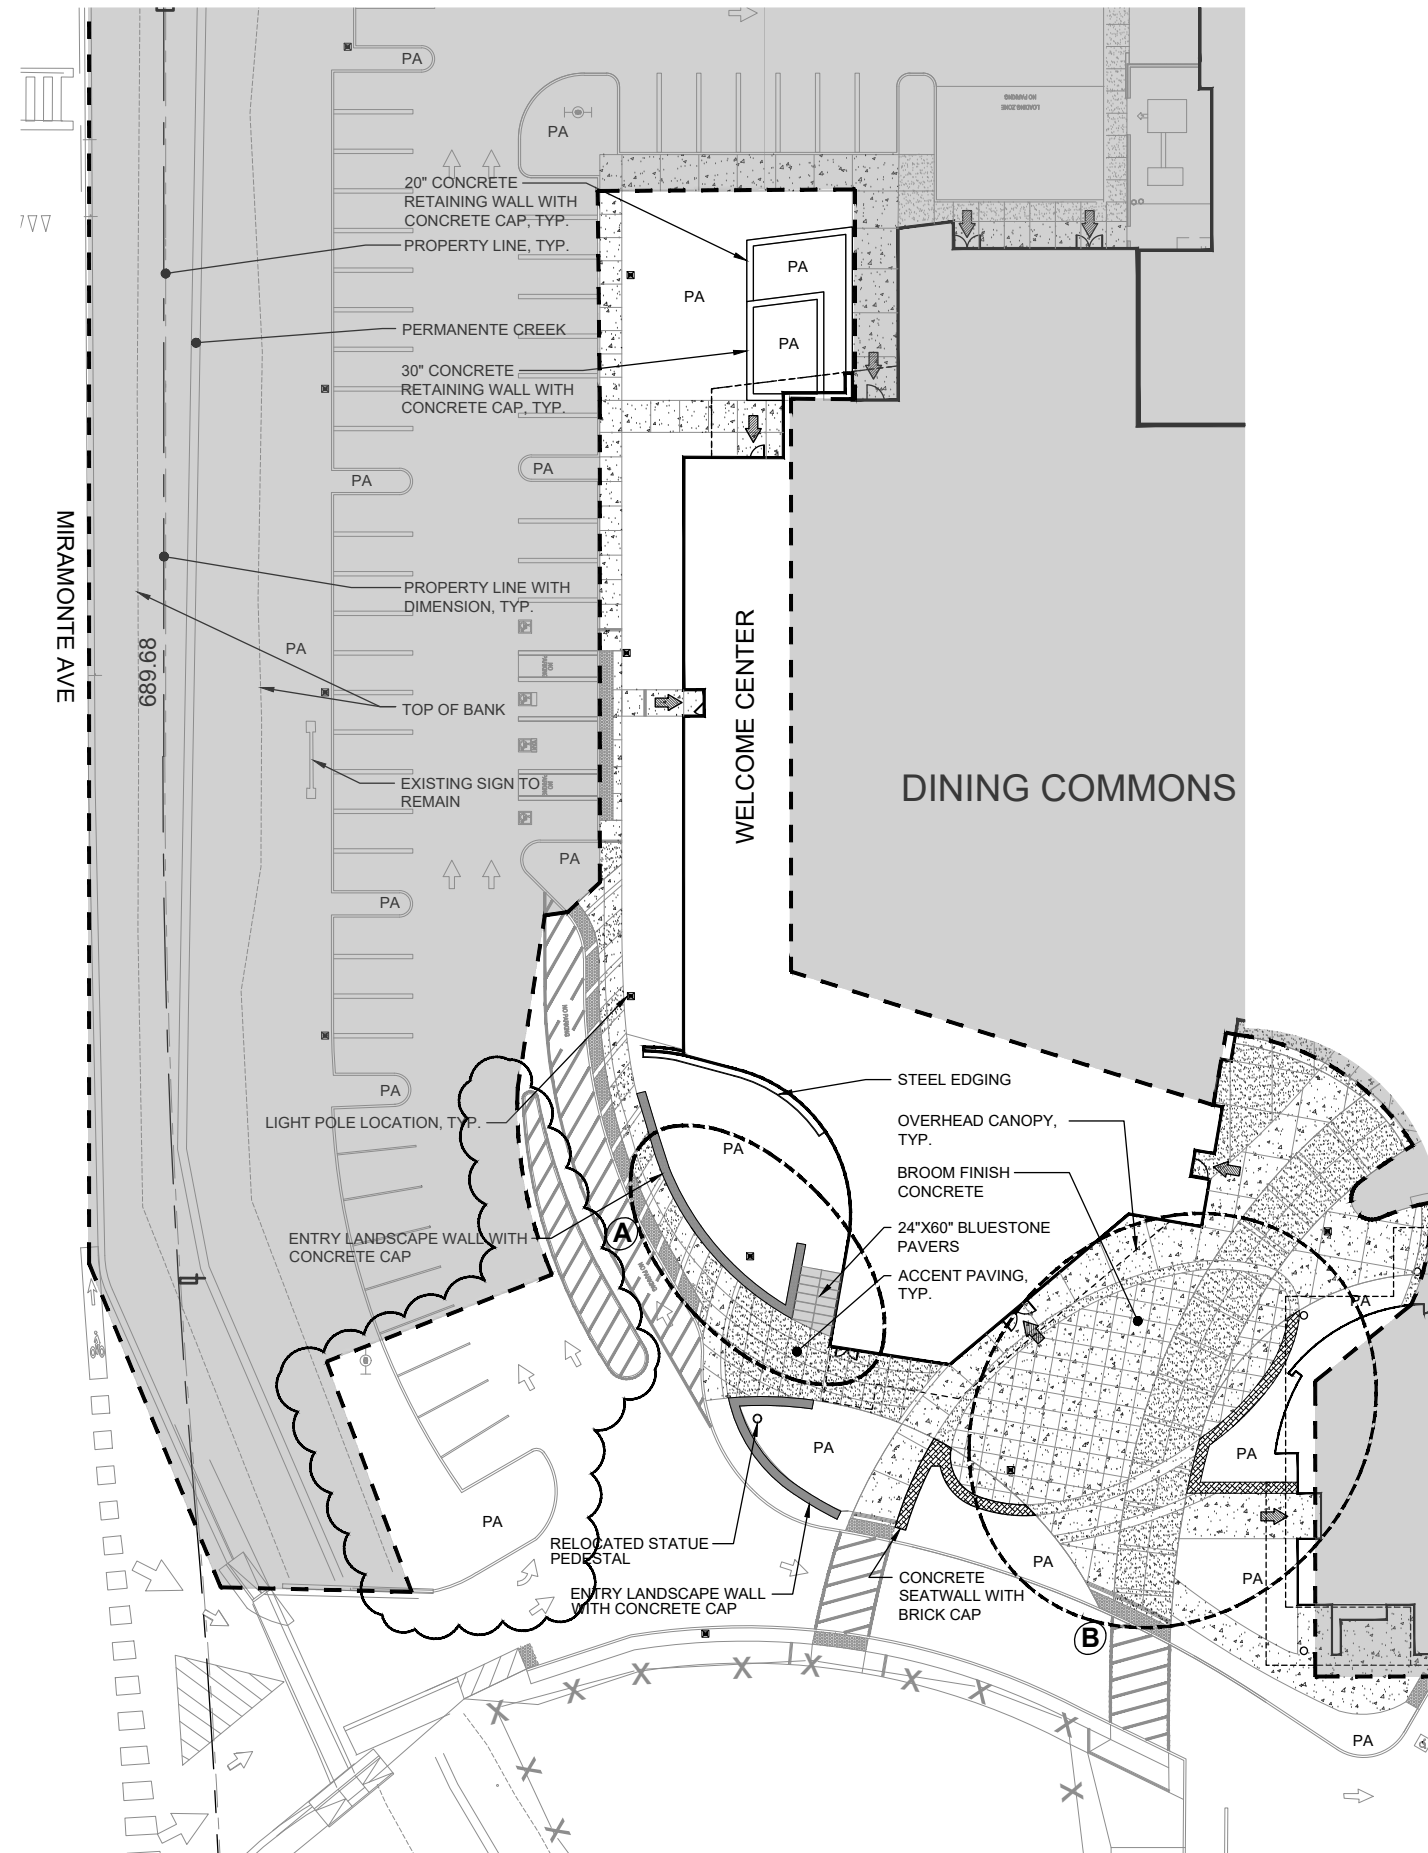

KEY	SITE PAVING AND AMENITIES LEGEND
	ACCENT PAVING COLOR: DAVIS COLOR 677 TAUPE FINISH: SALT MEDIUM
	CONCRETE PAVING COLOR: NO COLOR FINISH: BROOM
	EXISTING PAVING BUILDING 300 SCOPE OF WORK
	24"x60" BLUESTONE PAVERS MANUFACTURER: BUECHEL STONE
	CONCRETE SEATWALL WITH BRICK CAP 18" AND 30" WIDE, 18" TALL COLOR: DAVIS COLOR 6804 CLIFFSIDE BROWN
	ENTRY LANDSCAPE WALL WITH CONCRETE CAP 30" WIDE, 18" TALL COLOR: NO COLOR
	CONCRETE RETAINING WALL WITH CONCRETE CAP RETAINING WALLS: 18" WIDE, 20" AND 30" TALL COLOR: NO COLOR
	LIGHT POLE LOCATION SEE ELECTRICAL PLANS FOR PRODUCT INFORMATION
	STEEL EDGING
	DENOTES BUILDING ENTRANCE
	PLANTING AREA
	LIMITS OUTSIDE OF WELCOME CENTER REVIEW SCOPE

#### LANDSCAPE DESIGN NARRATIVE:

THE EMPHASIS OF THE LANDSCAPE DESIGN IS TO DEVELOP A CONCEPT THAT WILL BLEND INTO THE EXISTING CAMPUS, PROVIDE NEW OUTDOOR GATHERING SPACES AND SUPPORT A HEALTHY AND SAFE LEARNING ENVIRONMENT FOR THE STUDENTS. THE LANDSCAPE WILL BE DESIGNED IN A FASHION THAT COMPLIMENTS THE NEW BUILDING ARCHITECTURE, EASY TO MAINTAIN FOR THE DISTRICT MAINTENANCE, AND PLEASING TO THE STUDENTS AND STAFF.


#### PLANT PALETTE:

THE PLANT PALETTE WILL CONSIST OF DROUGHT TOLERANT MATERIAL THAT IS NATIVE TO THE REGION TO ENSURE MAXIMUM CHANCE OF THRIVING AND SAVING WATER AT THE SAME TIME. TREES WILL BE 24" BOX SIZE AND LARGER TO PROVIDE SUBSTANTIAL TREES FOR FUTURE SHADING AND DURABILITY. SHRUBS WILL BE A MINIMUM OF 5-GALLON SIZE FOR DURABILITY AND GIVE A MORE FINISHED LOOK TO THE LANDSCAPE.

PLANT MATERIAL WILL BE A MIXTURE OF EVERGREEN, DECIDUOUS, AND ACCENT PLANTS WITH ATTRIBUTES THAT WILL HELP TO BALANCE, ACCENTUATE, SCREEN, AND ENHANCE THE PROJECT. SPECIFIC SPECIES AND/OR PLANTS WILL BE CHOSEN FOR USE IN SPACES UNIQUELY AND CREATIVELY DESIGNED TO ACCEPT THEIR MATURE SIZE. THE DESIRED RESULT WILL BE AN AESTHETICALLY-PLEASING, FULLY FUNCTIONAL LANDSCAPE WITH MINIMAL MAINTENANCE NEEDS.

#### OUTDOOR GATHERING SPACE FUNCTIONS:

- (A) STUDENT PICK-UP/DROP-OFF AREA:  
DESIGNATED AREA FOR STUDENTS TO CONGREGATE WHILE WAITING TO BE PICKED-UP. AREA INCLUDES SOME SEATING AND TREE SHADE FOR STUDENTS TO WAIT FOR THEIR RIDES COMFORTABLY.
- (B) ENTRY PLAZA:  
MAIN ENTRY TO CAMPUS WITH LANDSCAPE WALLS AND PERMANENT SEATING FOR SMALL GROUPS. THE MAIN ENTRY ALSO ACTS AS THE NEXUS TO CONNECT THE STUDENT PICK-UP/DROP-OFF AREA, BUILDING ENTRANCES, STUDENT QUAD, AND THE FUTURE INSTRUCTIONAL BUILDING TO THE SOUTH.

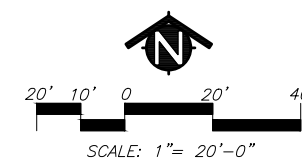

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PAVING



BROOM FINISH CONCRETE  
NO COLOR



ACCENT SALT FINISH CONCRETE  
DAVIS COLOR: TAUPE



24" X 60" BLUESTONE PAVERS  
MANUFACTURER: BUECHEL STONE

SITE AMENITIES

LIGHT POLES



MANUFACTURER: GARDCO  
PRODUCT NAME: PUREFORM  
MODEL #: NW-G2  
COLOR: BRONZE


LANDSCAPE MATERIALS

BLACK RIVER ROCK



MANUFACTURER: GARDCO  
PRODUCT NAME: PUREFORM  
MODEL #: NW-G2  
COLOR: BRONZE

CONCRETE SEATWALL

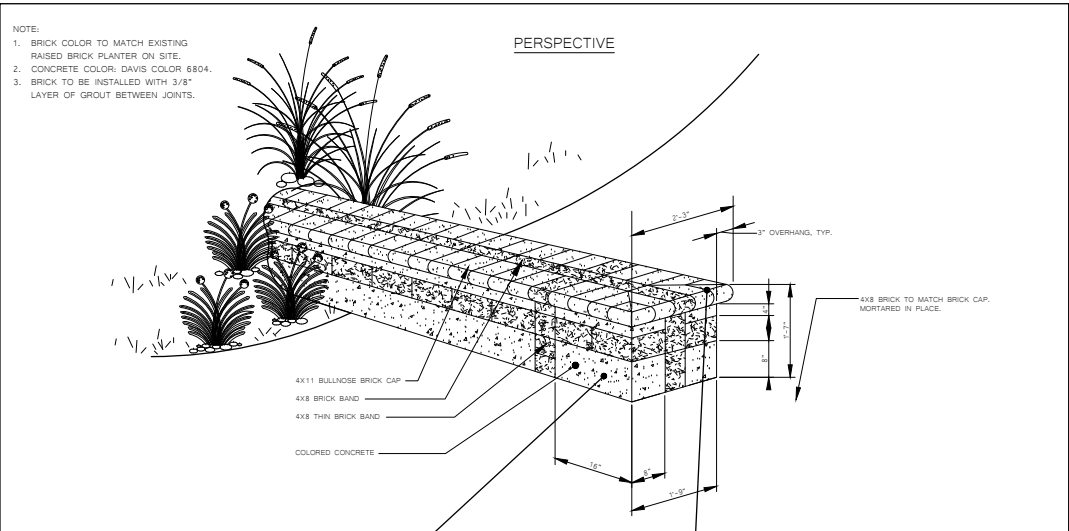


COLORED CONCRETE  
DAVIS COLOR: CLIFFSIDE BROWN



BRICK CAP  
MATCH EXISTING RAISED BRICK  
PLANTER

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HMC Architects

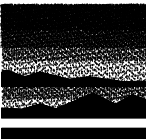3445011000

2495 Natomas Park Drive, Studio 100  
Sacramento, CA 95833  
T 916 325 1100 / www.hmcarchitects.com

Keynotes:

Key Plan:



Consultant:



Agency  
Approval:

File No.:

Facility:  
**Saint Francis High School**  
1885 Miramonte Ave  
Mountain View, CA 94040

Project:  
**Modification to the Center for Innovation & Dining Commons**

Sheet Title:  
**Site Material Board**

**PLANNING SUBMITTAL**

Date: 02/18/2022 Client Project No: 3445011000

Sheet:

L0.4






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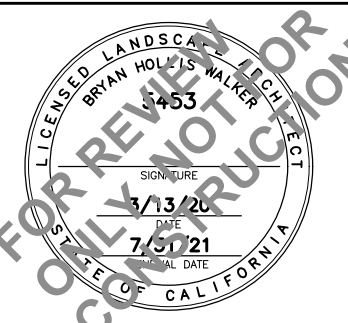
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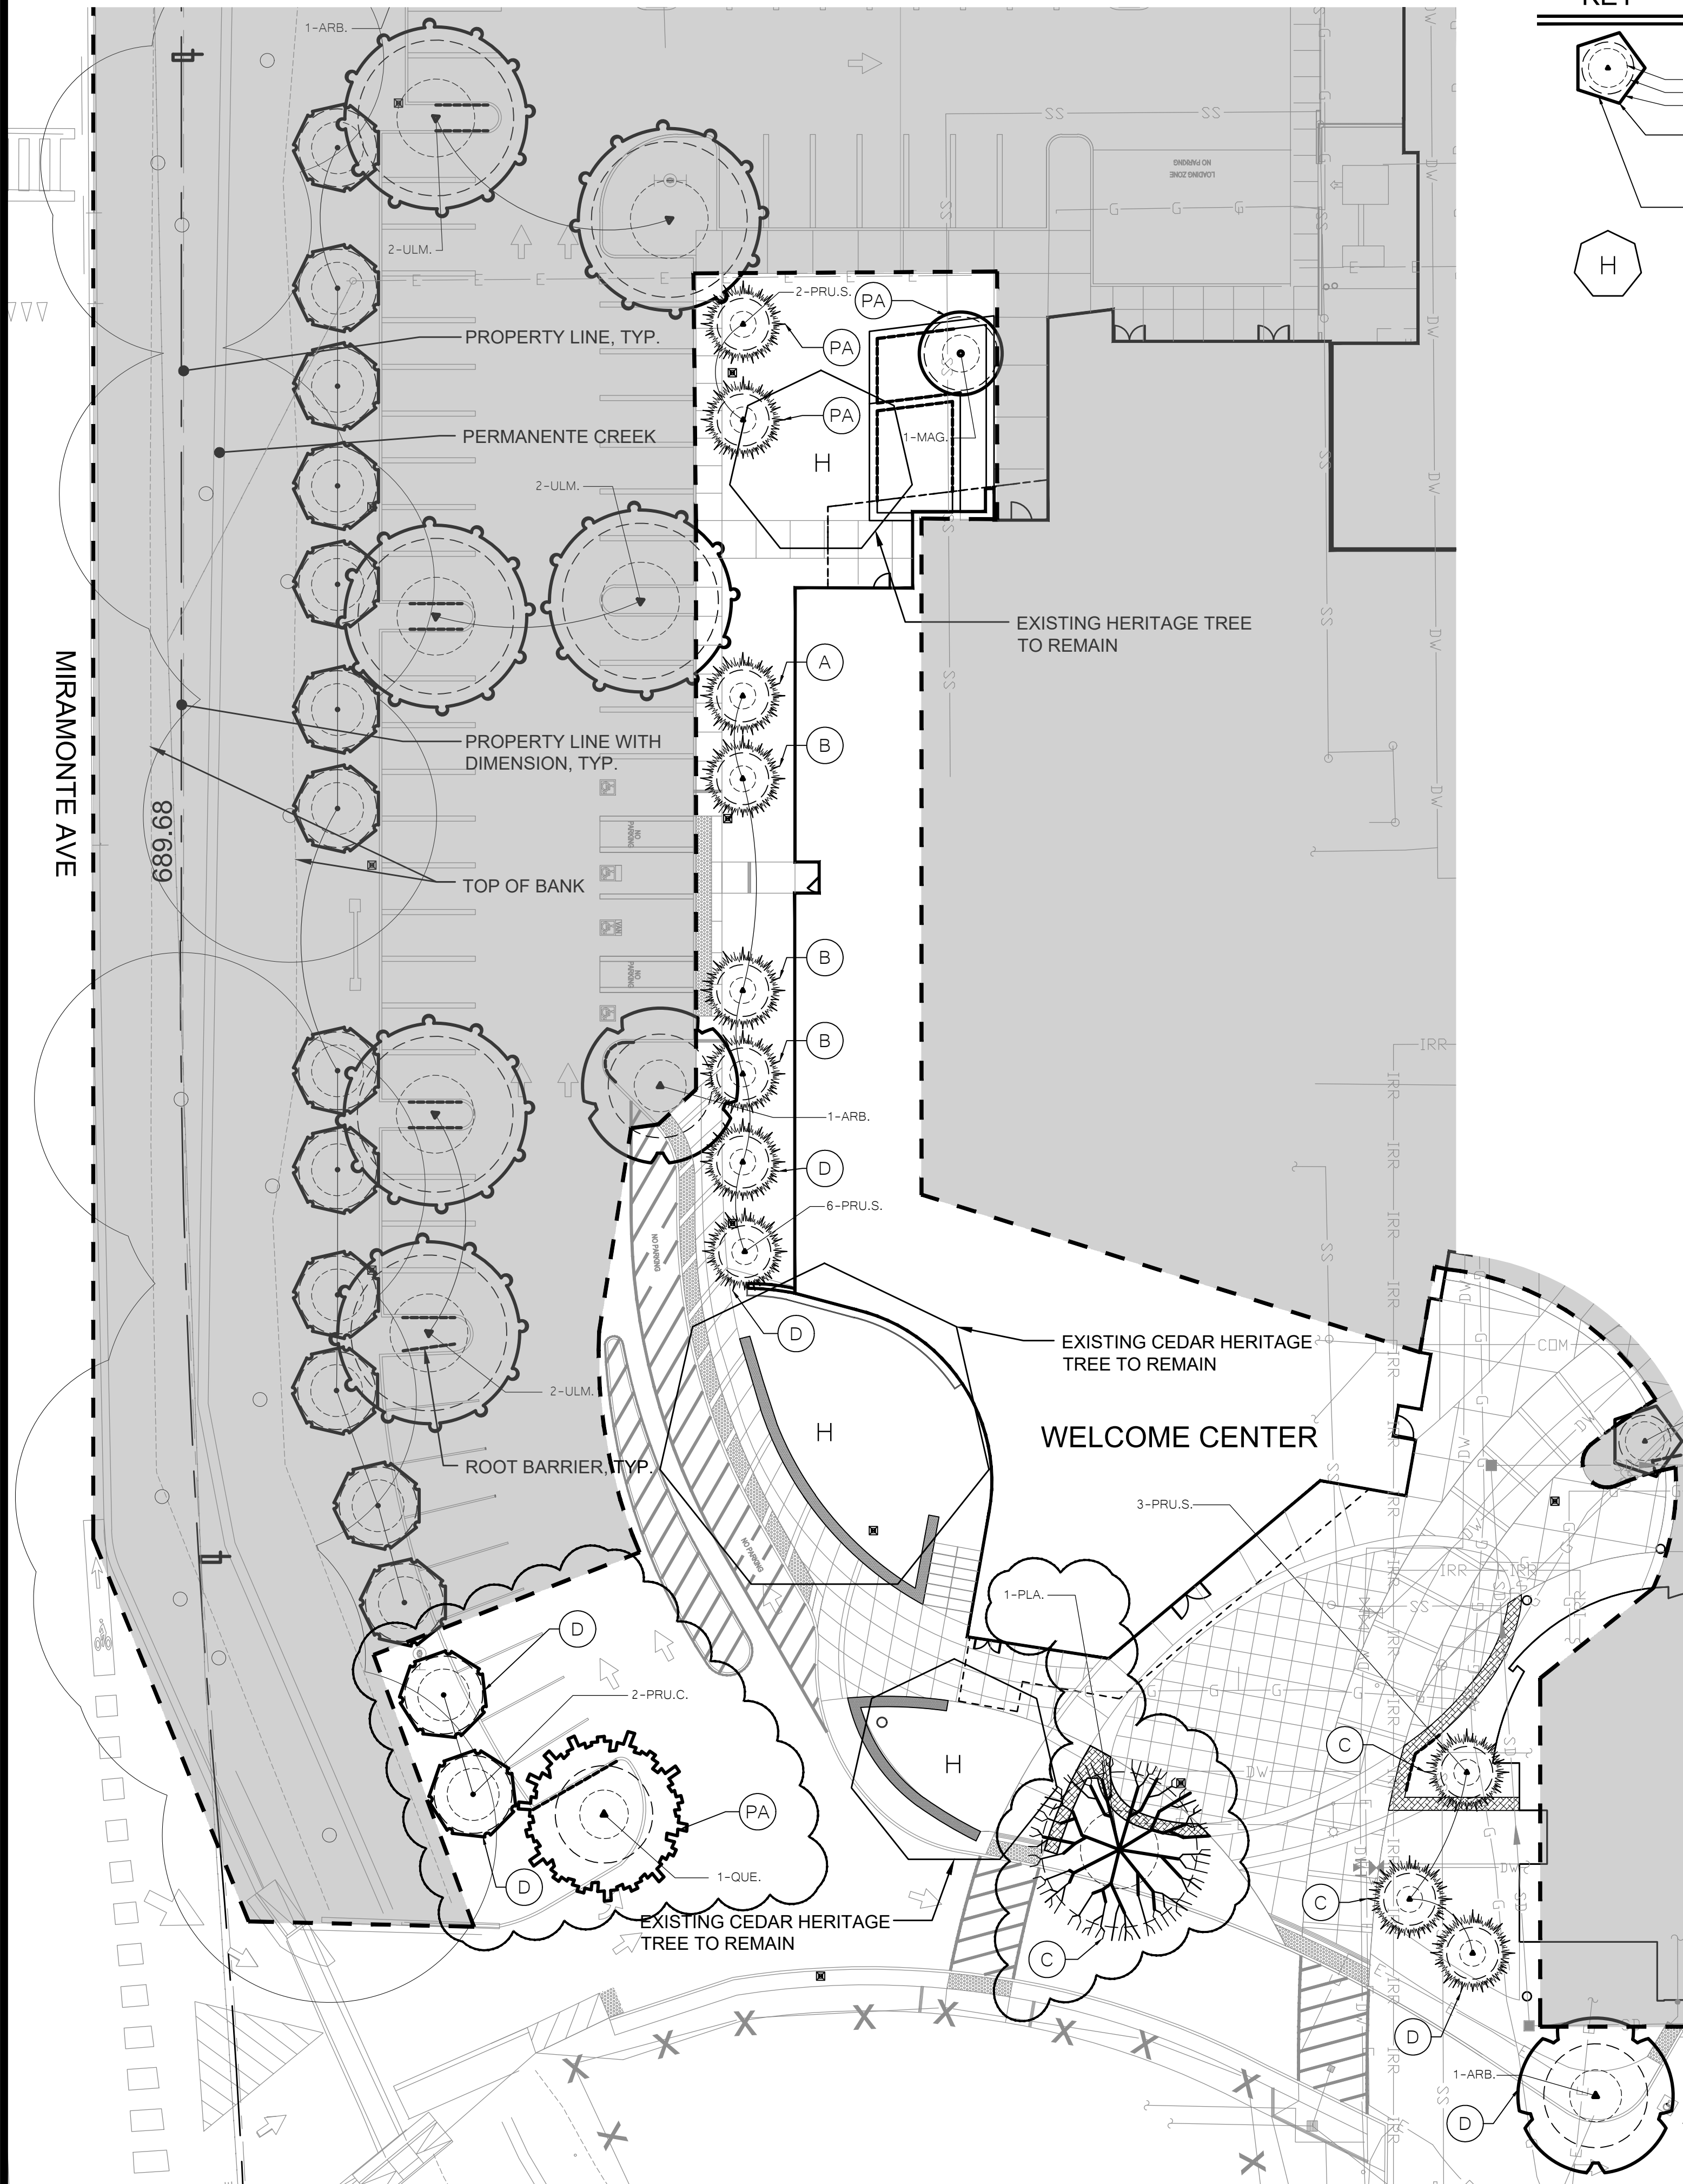
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Tree Planting Plan

PLANNING SUBMITTAL


Date: 02/18/2022 Client Project No: 3445011000

Sheet:

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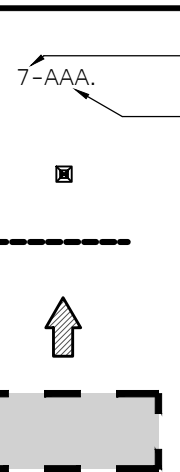
KEY

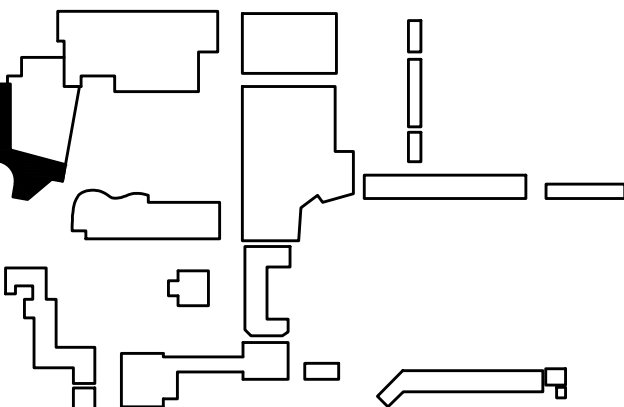

TREE LEGEND

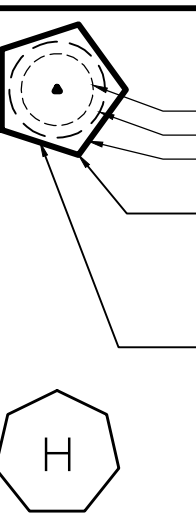TREES - NOT ALL SYMBOLS SHOWN  
TOTAL NEW TREES IN WELCOME CENTER ADDITION: 12  
5 YEAR CANOPY  
10 YEAR CANOPY  
EDGE OF TREE SYMBOL REPRESENTS TREE AT MATURITY  
A B  
C D  
PA  
INDICATES NEW TREE REPLACEMENT TAG ID, SEE REPLACEMENT CHART BELOW FOR QUANTITIES  
INDICATES PREVIOUSLY APPROVED PL-2017-346 PROPOSED TREE  
H  
EXISTING HERITAGE TREES TO REMAIN  
3 TOTAL WITHIN PROJECT AREA  
SYMBOL SIZE VARIES

KEY



TREE LEGEND

PLANT QUANTITY  
PLANT KEY  
LIGHT POLE LOCATION  
ROOT BARRIER, INSTALL WHERE SHOWN ON PLANS  
BUILDING ENTRANCE  
LIMITS OUTSIDE OF WELCOME CENTER REVIEW SCOPE

WELCOME CENTER ADDITION SCOPE TREE MATERIAL LIST

SIZE	QUANTITY	KEY	BOTANICAL NAME ... COMMON NAME
TREES:			
24" BOX	1	ARB.	ARBUTUS 'MARINA' ... MARINA STRAWBERRY TREE
24" BOX	1	PLA.	PLATANUS RACEMOSA ... CALIFORNIA SYCAMORE
24" BOX	2	PRU.C.	PRUNUS CERASIFERA 'KRAUTER VESUVIUS' ... FLOWERING PLUM
24" BOX	9	PRU.S.	PRUNUS SERRULATA 'KWANZAN' ... FLOWERING CHERRY
TOTAL	13		

WELCOME CENTER TREE REPLACEMENT CHART

EXISTING TREES PROPOSED FOR REMOVAL				NEW TREE REPLACEMENTS	
BOTANICAL NAME ... COMMON NAME	QUANTITY	HERITAGE REPLACEMENT	STANDARD REPLACEMENT	QUANTITY	TREE REPLACEMENT TAG
(2 TO 1 RATIO)				(1 TO 1 RATIO)	
BETULA PENDULA ... EUROPEAN WHITE BIRCH (#43)	1			1	A
BETULA PENDULA ... EUROPEAN WHITE BIRCH (#44)	1	HERITAGE	STANDARD	3	B
PREVIOUSLY APPROVED PL-2017-346 PROPOSED TREES				NEW TREE REPLACEMENTS	
BOTANICAL NAME ... COMMON NAME	QUANTITY	HERITAGE REPLACEMENT	STANDARD REPLACEMENT	QUANTITY	TREE REPLACEMENT TAG
(2 TO 1 RATIO)				(1 TO 1 RATIO)	
CERCIS OCCIDENTALIS ... WESTERN REDBUD	2			3	C
ULMUS PARVIFLORA ... CHINESE ELM	2	HERITAGE	STANDARD	6	D

WELCOME CENTER ADDITION TREE CANOPY GROWTH TABLE

BOTANICAL NAME ... COMMON NAME	QUANTITY	CANOPY SIZE					GROWTH RATE
		SIZE AT PLANTING	COVERAGE AT 5YR	COVERAGE AT 10YR	COVERAGE AT MATURE		
ARBUTUS 'MARINA' ... MARINA STRAWBERRY TREE	1	5' x 19 S.F.	10' x 78 S.F.	20' x 314 S.F.	30' x 706 S.F.	2' PER YEAR	
PLATANUS RACEMOSA ... CALIFORNIA SYCAMORE	1	5' x 19 S.F.	15' x 176 S.F.	30' x 706 S.F.	30' x 706 S.F.	3' PER YEAR	
PRUNUS CERASIFERA 'KRAUTER VESUVIUS' ... FLOWERING CHERRY	2	3' x 7 S.F.	10' x 78 S.F.	15' x 176 S.F.	15' x 176 S.F.	2' PER YEAR	
PRUNUS SERRULATA 'KWANZAN' ... FLOWERING CHERRY	9	3' x 7 S.F.	10' x 78 S.F.	15' x 176 S.F.	15' x 176 S.F.	2' PER YEAR	
QUERCUS LOBATA ... VALLEY OAK	1	5' x 19 S.F.	15' x 176 S.F.	30' x 706 S.F.	30' x 706 S.F.	3' PER YEAR	
CANOPY COVERAGE TOTAL:	13	134 S.F.	1,288 S.F.	3,662 S.F.	4,054 S.F.		

NOTE: INFORMATION OBTAINED FROM THE CAL POLY URBAN ECOSYSTEMS INSTITUTE'S WEBSITE WAS USED TO DETERMINE TREE CANOPY GROWTH. TOTAL CANOPY COVERAGE WAS CALCULATED BY MULTIPLYING QUANTITY OF EACH TREE SPECIES BY THE CORRESPONDING SQUARE FOOTAGE FOR EACH GROWTH PERIOD AND ADDING TOTAL QUANTITIES.

\*NOTE: PER THE CITY OF MOUNTAIN VIEWS REQUEST, ONE PREVIOUSLY APPROVED TREE PROPOSAL HAS BEEN SUBSTITUTED FOR A NEW TREE REPLACEMENT SPECIES. SEE 'QUERCUS LOBATA ... VALLEY OAK' IN THE TREE CANOPY GROWTH TABLE ABOVE FOR UPDATED SHADE COVERAGE QUANTITIES REFLECTING THE ADDITION OF THE NEW TREE REPLACEMENT SPECIES SQUARE FOOTAGE. BECAUSE THE INITIAL TREE PROPOSAL HAS BEEN PREVIOUSLY APPROVED, 'QUERCUS LOBATA ... VALLEY OAK' IS NOT A PART OF THE WELCOME CENTER ADDITION SCOPE TREE MATERIAL LIST.

WELCOME CENTER ADDITION TREE CANOPY COVER CHART


TOTAL SITE S.F.	EXISTING TREE CANOPY COVER	% OF SITE	PROPOSED TREE CANOPY AT MATURE + REMAINING TREE CANOPY	% OF SITE
40,758 S.F.	6,287 S.F.	= 15.4%	9,707 S.F.	= 23.8%

EXISTING TREE CANOPY REMOVAL	REMAINING TREE CANOPY
634 S.F.	5,653 S.F.

TREE CANOPY AT PLANTING	%	TREE CANOPY AT 5 YRS	% OF SITE	TREE CANOPY AT 10 YEARS	% OF SITE	PROPOSED TREE CANOPY AT MATURE	% OF SITE
134 S.F.	=0.3%	1,288 S.F.	=3.2%	3,662 S.F.	=9.0%	4,054 S.F.	=9.9%

NOTE: INFORMATION ON THIS TABLE IS BASED ON ARBORIST REPORT DATED JANUARY 31ST, 2022.

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██████████

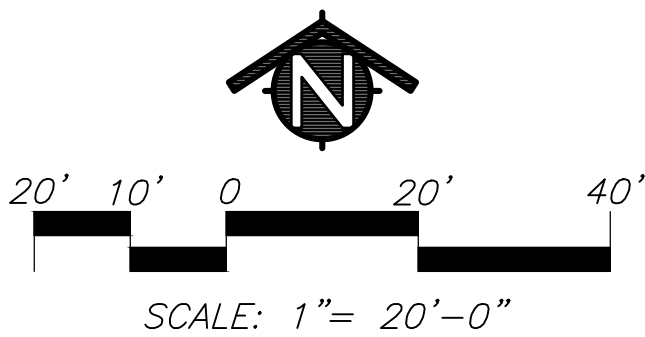**Keynotes:**

**Key Plan:**

**Consultant:**

Agency  
Approval

File No.:

Facility:  
**Saint Francis High School**  
1885 Miramonte Ave  
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Project:  
**Modification to the Center for Innovation & Dining Commons**


Sheet Title:  
**Turf/Shrub Planting Plan**

## PLANNING SUBMITTAL

<b>Date:</b> 02/18/2022	<b>Client Project No:</b> 3445011000
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Sheet:

## L2.1

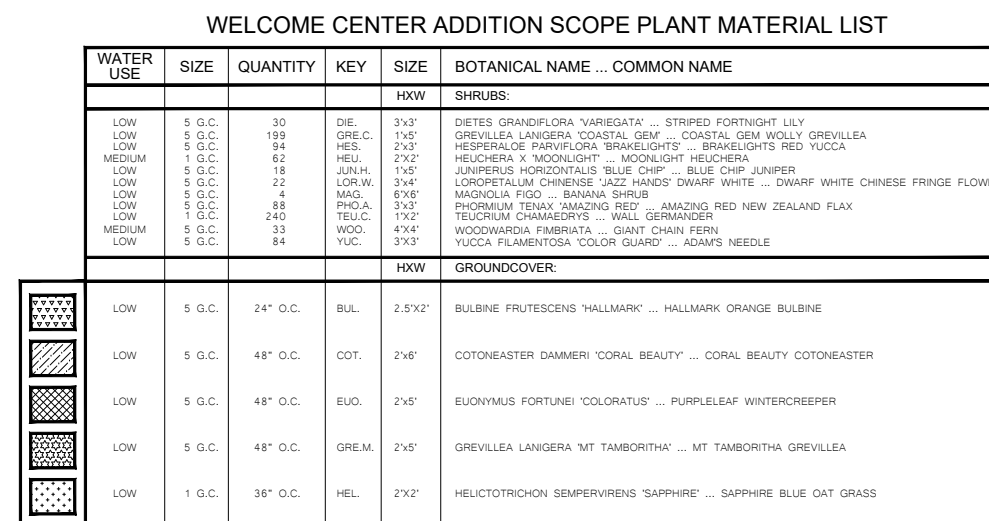

## KEY

LANDSCAPE LEGEND



TREE OUTLINE FOR REFERENCE



EXISTING HERITAGE TREES TO REMAIN - SYMBOL SIZE VARIES



**SHRUB/GROUNDCOVER**  
ALL PLANTERS TO RECEIVE 3" OF BARK MULCH.



EXISTING PLANTING TO REMAIN



STEEL EDGING




+ PLANT QUANTITY

+ PLANT KEY

+ PLANT KEY

### LIMITS OUTSIDE OF WELCOME CENTER REVIEW SCOPE

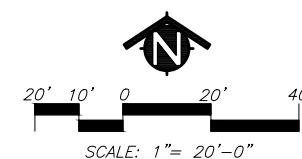

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