MONTECITO TOWNHOMES

MOUNTAIN VIEW, CALIFORNIA

A New Vibrant & Sustainable Town Home community PROPOSED SCOPE OF GREEN DESIGN

ENVIRONMENTAL INNOVATIONS IN DESIGN IS PLEASED. TO PROPOSE A NEW TWO AND THREE STORY SUSTAINABLE TOWN HOME PROJECT OVER PODIUM AT 1998 MONTECITO AVENUE DESIGNED IN A HIGHLY ATTRACTIVE AND SUSTAINABLE MANNER. A GATEWAY CENTER PIECE OF THE DESIGN IS A GENEROUS PARK WITH MANY TREES AND COMMON AMENITIES (TABLES, BENCHES), SHADED SEATING AREAS AND LANDSCAPED GARDENS. THESE HIGH PERFORMANCE AND HEALTH ENHANCING TOWN HOMES ARE DESIGNED TO CREATE A STRONG SENSE OF COMMUNITY WITH AN ARUNDANCE OF BEAUTIFULLY LANDSCAPED OPEN SPACE.

THE RESIDENTIAL CHARACTER OF THE NEIGHBORHOOD IS ENHANCED BY ENCLOSING THE MAJORITY OF THE AUTOMOBILE CIRCULATION AND ALL OF THE PARKING BELOW THE PODIUM DECK, WELL SCREENED FROM THE ADJACENT NEIGHBORS AND THE STREET. THE PROPOSED STYLING OF THE HOMES REFERENCES TRADITIONAL RESIDENTIAL FORMS AND DETAILING WHILE RENDERING THEM IN A CLEAN, BRIGHT, MODERN 'ECO-FUNCTIONAL' MANNER WITH CARE AND SENSITIVITY TO THE SURROUNDING ENVIRONMENT, SOLAR ORIENTATION, AND NEIGHBORING HOMES.

MASSING AND MATERIALS ARE IN KEEPING WITH NEIGHBORHOOD VOCABULARY; A SMALL "GATE HOUSE" PROVIDES ACCESS TO THE PODIUM GARDEN WHERE PORCHES ARE GROUPED AND POSITIONED TO MINIMIZE THE VISUAL BULK OF THE HOMES RELATIVE TO THE STREET. THE HOMES ARE GROUPED TOGETHER INTO FOUR BUILDINGS, SHIFTED AND POSITIONED TO CREATE VISUAL INTEREST. TWO STORY HOMES ARE GROUPED ALONG THE COMMON WALKWAYS AND SIDEWALKS. THE ELEVATIONS STEP BACK FROM ALL PROPERTY LINES TO RESPECT SETBACK REQUIREMENTS

THE BUILDING EXTERIORS ARE DESIGNED WITH A BLEND OF TRADITIONAL MATERIALS: SMOOTH TEXTURED ARTISAN SIDING SHINGLES AND TRIM BOARDS PAINTED WITH A PALETTE OF SOFT AND COMPLEMENTARY COLORS. WARM, STYLISH WOOD DETAILING OCCURS AT THE FENCING SURROUNDING THE PODIUM AND GREETS PEDESTRIANS WITH ACCENTS OF COLOR AND TEXTURE COMPLEMENTED BY WROUGHT IRON GATES. LANDSCAPED PLANTERS, AND OPEN ENTRY COURTS.

SUSTAINABLE FEATURES INCLUDE: PHOTOVOLTAIC ARRAYS, HEAT PUMP WATER HEATER, THERMALLY BROKEN WINDOW FRAMES WITH CARDINAL 180 DOUBLE LOW-E GLASS, AIR SEALING VAPOR BARRIER BUILDING WRAP, ENHANCED BUILDING INSULATION & HEAT RECOVERY VENTILATION SYSTEMS.



STREET VIEW FROM MONTECITO AVE

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A0.5A	EXISTING ADJACENT NEIGHBOURS
A0.5B	PERSPECTIVE
A0.5C	PERSPECTIVE
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A1.1	PODIUM PLAN IN COLOR
A1.2	SITE CONTEXT PLAN
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A1.4.1	BIRD'S EYE VIEW
A1.5	SITE PLAN TRANSIT LINKS
A3.1	GARAGE PLAN
A3.2	SITE PLAN
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A4.1	PROJECT ELEVATION
A4.2	BUILDING A ELEVATION
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Sheet List Sheet Name Number A4.3 BUILDING B ELEVATION A4.4 BUILDING C ELEVATION A5.0 SITE SECTIONS SITE SECTIONS ALONG WEST PROPERTY A5.2 WALL SECTIONS COLOR AND MATERIALS A6.2 ARCHITECTUAL ELEMENTS A6.3 ARCHITECTUAL ELEMENTS COLOR BOARD WINDOW DETAILS

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A7.1	BUILDING DETAILS
Surveyor	r
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Civil	•
C1	TENTATIVE MAP
C2	TENTATIVE MAP GARAGE
C3	SUBDIVISION MAP
C4	TREATMENT SHEET
Landsca	pe
L1.1	LANDSCAPE LAYOUT PLAN
L1.2	TREE INVENTORY PLAN
L1.3	TREE CANOPY PLAN
L2.1	PLANTING PLAN
L2.2	LANDSCAPE MATERIALS
L2.3	LANDSCAPE MATERIALS
L3.1	HYDROZONE PLAN

Grand total: 49

PROJECT DATA SUMMARY #1

MULTI FAMILY: R-2, TYPE 5-B PER CBC SECTION 509.4 PARKING UNDER PODIUM: S-2, TYPE 1A HORIZONTAL BUILDING SEPARATION: 3 HRS.
NFPA 13 AUTOMATIC FIRE SPRINKLERS PROVIDED @ GARAGE/STORAGE; AND, INTERIOR SMOKE ALARMS PROVIDED AT UNITS, PER FIRE PROTECTION DISTRICT WALLS SEPARATING DWELLING UNITS: 1 HR. FIRE PARTITION PER 709 ALL CONSTRUCTION SHALL COMPLY WITH 2013 CBC, CPC, CMC, CEC and 2013 CALIFORNIA ENERGY CODE, CALIFORNIA GREEN BUILDING STANDARD CODE, 2012 MUNICIPAL CODE, ALL LOCAL AMENDMENTS / ORDINANCES, & ALL LOCAL SUB-TRADE

FIRE DEPARTMENT NOTES:

- Install a NFPA 13 Fire sprinkler, NFPA 24 underground fire service and NPFA 72 fire alarm monitoring system under separate Fire permit.
- All fire sprinkler drains, including auxiliary, inspector's test and main drain, shall discharge to
- an approved landscape location or to the sanitary sewer system.

 Exit signs, emergency lighting, fire extinguishers, Fire Department lock box and address posting locations to be field verified by the Fire Inspector.

Provide emergency lighting in building including stairways.

The Geotechnical aspects of the construction including demolition and rough site grading atgrade foundation excavations, subgrade preparation and the installation of surface drainage control systems, should be performed in accordance with the recommendations presented in the goetechnical report prepared by Earth Systems Pacific. Earth Systems Pacific should be provided at least 48 hours advance notification of any goetechnical aspects of the construction and should be present to observe and test, as necessary, the earthwork, foundation, and drainage nstallation phases of the project.

- DEFERRED SUBMITTALS FOR THIS PROJECT INCLUDE, S.I.P. PANELS (STRUCT'L INSULATED PANEL SHOP DWGS.), PHOTOVOLTAIC ARRAY AND EVSE (electric vehicle charging stations) AND AUTOMATIC FIRE SPRINKLER SYSTEM.
- Special Inspections shall be required for: shop indent. & welding inspection & structural hardware tiedown system installation.

PROJECT DATA SUMMARY #2

55%

22,185

34

15

12

Floor

805

755

815

15 19'-1"

56.6%

22,819

2

47

15'-7" to 31' -0'

34-37

Floor

689

737

550

16'-2" to 34'-3"

21'-0" to 55'-6"

Floor

628

647

total

2122

2139

1365

ARCHITECT:

Environmental Innovations in Design

(650) 412-2356

(650) 793-2856

Email: stuart@eidarchitects.com

FID Architects

412 Olive Avenue

Palo Alto, CA 94306

Phone: (650) 226-8770

Units

Area:

Total

4244

10695

2730 3700

30351

(BELOW GRADE PARKING RE: A3.1)

"GREEN" & CONTEMPORARY CHARACTER

INOSECT	רות	SOIVIII	///\\\\\\\\\\\\\\\\\\\\\\\\\\\\\\\\\\\	π∠			ECO FUNCTIONAL
1998 - 2024 Montecito Av	e, Mountain V	iew					ARCHITECTURE
APN: 150.02.023	APN: 150.02	2.24					
Zoning:	R3-2.2						
Lot Dimensions:							412 OLIVE AVE PALO ALTO CA
Depth:	373.79						94306 · 2225
Width:	107.91					П	7,000 2220
Lot Area	40,335.68		.93 acres				650 - 226 - 8770
Podium parking w/ 1-2-3 story above							CED ARCO
	Allowed:	Proposed:					STORY TO SE
Density:§	15.88	17	* 1BMR				C-26427 X
§ City of Mountain View M	1unicipal Code	(Sec. A36.12.	030), 2009, T	able B-6			3/31/2015 RENEWAL
* 1 INCLUSIONARY HOUSII A3.2 FOR BMR LOCATION)		INCLUSIONAF	RY HOUSING(I	RE: A1.0 &			OF CALLEGE
Floor Area Ratio:	1.05	0.80					
Max Floor Area:	42,352.46	32,352.00					
Site Coverage:	35%	38.9%					- ≱
Max Coverage:	14,117	15,687	PER INCL	USIONARY HO BONUS	DUSING DENSITY		Avenu
							⋾
Auto-Dedicated Paving:	20%	4.5%					
Max Coverage:	8,067	1,827					O ,
							¬ +

Avenue Montecito 998-2024

ARCHITECTS

SHEET COVER

PLANNING RE-SUBMITT. 10 OCTOBER 2014 PLANNING RE-SUBMITT. 12 FEBRUARY 2015

PLANNING RE-SUBMIT

20 APRIL 2015

PROJ. NO. MCL DWG. SCALE: AS SHOWN MG, MK, TC, IJ

Monarch Consulting Arborists Felton, CA 95018

Email:

RECYCLING:

Recology Mountain View 650 Martin Avenue Santa Clara, CA 95050 Phone: (650) 967-3034 (650) 588-1102 Email: rmercado@recologv.com MECHANICAL/HVAC:

T.B.D

travis@precision-ec.com FIRE SPRINKLER /ALARM:

Precision Engineering & Const 901 Waltermire St Belmont, CA 94002

(650) 226-8640 (650) 367-1059

SURVEYOR: B&H Surveying

Farth System Pacific

San Jose, CA 95131

901 Waltermire St Belmont, CA 94002 Phone: (650) 637-1590 (650) 637-1059 Mobile

GEOTECHNICAL:

780 Montague Expwy, Ste. 205

(408) 934-9302 (408) 946-4569

bzehrbach@earthsvs.com

LANDSCAPE ARCHITECT:

T.B.D

Phone

Fax: Mobile:

Landarc Associates, Inc. 97 South Second Street, Suite 111 San Jose, CA 95113 Phone: (408) 361-8085

T24/GREEN RATER

/COMMISSIONING:

GENERAL CONTRACTOR:

286 Digital Drive

Open Area:

Regired Open Area:

Parking: 2 per unit

Accessible (van)

Setbacks, Site:

Height Limit:

Type 1

Гуре 4

Type 5

BMR - RE: Designat

Letter

STRUCTURAL

ENGINEER:

Morgan Hill, CA 95037 Phone: (408) 782-6898

VCS

uest Parking: (Units:

T.B.D Mobile

(408) 464-8387

Email: maxcheng@garlic.com

Hanford Capital Inc. 1131 De Anza Blvd San Jose, CA 95129 Email: howard.everspring@gmail.com

OWNER:

A0.0

VICINITY MAP GAS/ELECTRIC:

Email:

ARBORIST:

Phone: (831) 331-8982 Fax:

rick@monarcharborist.com

A4.2.1 BUILDING A ELEVATION

Email: jschroeder@dcengineering.net

DC Engineering 440 E. Corporate Drive

Meridian, Idaho 83642

(208) 571-5025

(208) 288-2182

Phone:

T.B.D

ELECTRICAL/PLUMBING: CIVIL ENGINEER:

dan@bhlandsurvev.com

Mobile: (209) 966-6030

Phone: (951) 662-6182

**DEFRERRED SUBMITTAL ITEM





412 OLIVE AVE PALO ALTO CA 4306 - 2225

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12. 1974 SAN LUIS AVE

1. 374 N. RENGSTOFF AVE

13. 1984 SAN LUIS AVE



11. 371 SIERRA AVE





9. 1943 MONTECITO AVE



8. 1983 MONTECITO AVE



10. 346 SIERRA AVE

4. 2079 MONTECITO AVE

3. 2083 MONTECITO AVE

2. N. RENGSTOFF AVE



5. 2075 MONTECITO AVE



6. 2025 MONTECITO AVE



7. 1991 MONTECITO AVE

PLANNING RE-SUBMITTA 10 OCTOBER 2014

PLANNING RE-SUBMITTA 12 FEBRUARY 2015

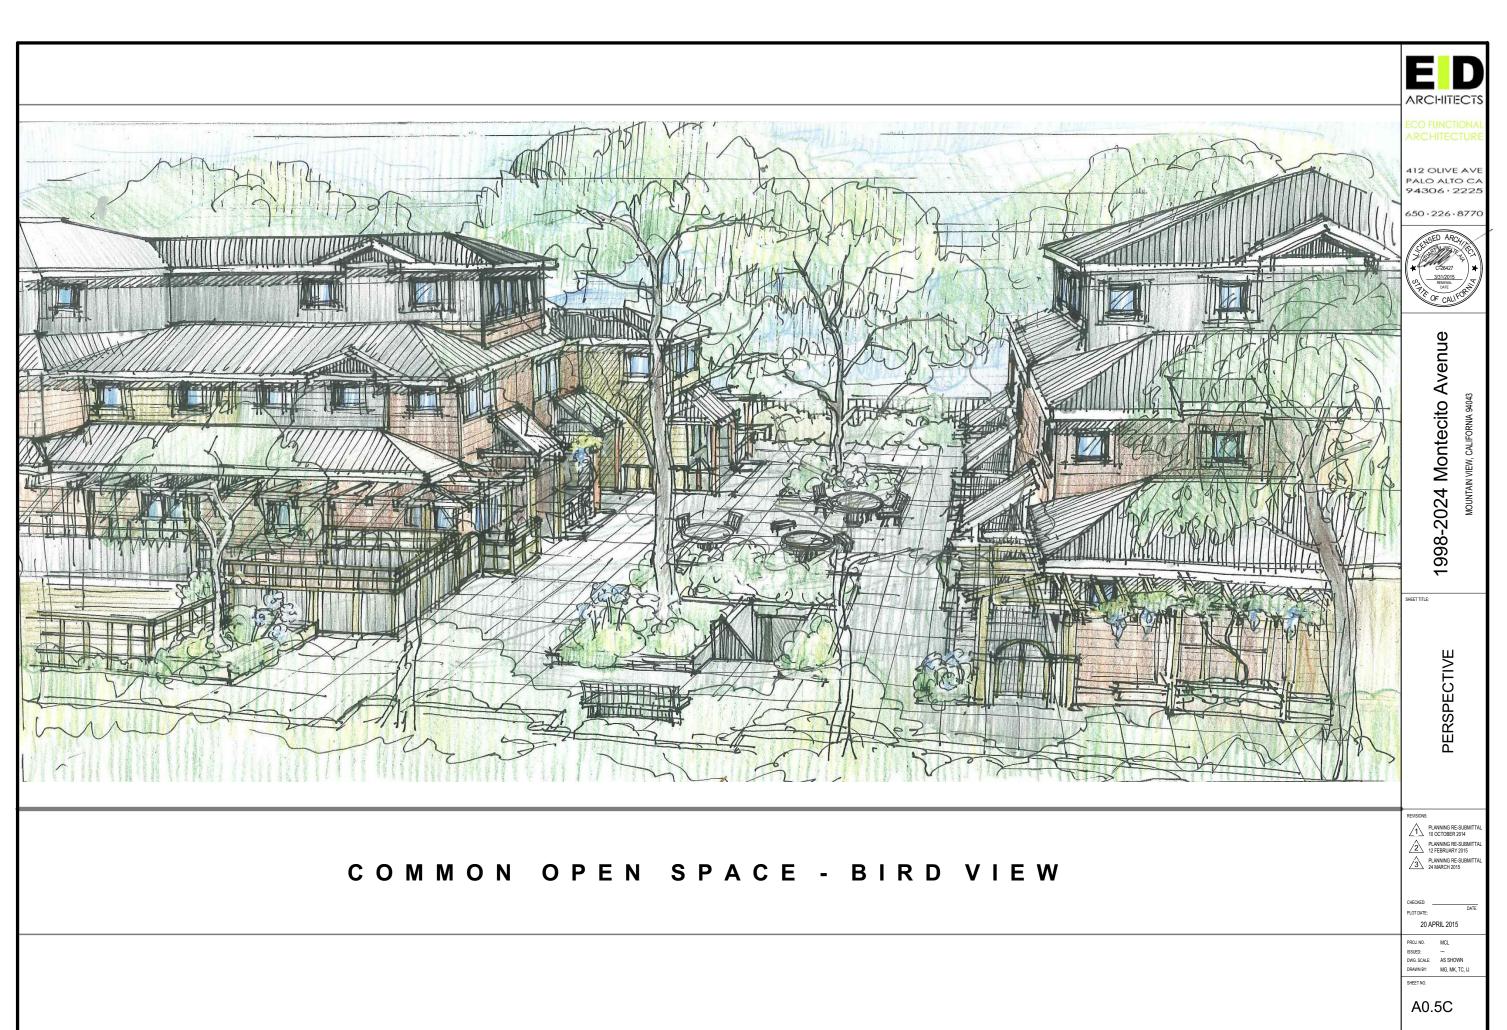
20 APRIL 2015

A0.5A

1998-2024 Montecito Avenue

EXISTING ADJACENT NEIGHBOURS





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1998-2024 Montecito Avenue

HEET TITLE:

LOT COVERAGE CALCULATIONS

PLANNING RE-SUBMITTA 10 OCTOBER 2014

PLANNING RE-SUBMITT. 12 FEBRUARY 2015 PLANNING RE-SUBMITTA 24 MARCH 2015

20 APRIL 2015

DWG. SCALE: AS SHOWN DRAWN BY: MG, MK, TC, IJ

A1.0

NOTE:

- 1. FOR INDIVIDUAL UNIT SQUARE FOOTAGE, SEE PROJECT SUMMARY CALCULATIONS AND FLOOR PLAN, SHEET A0.0.
- 2. SEE PLANS ABOVE FOR UNIT TYPE DESIGNATION.



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HEET TITLE:

COLOR PLAN IN PODIUM

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PLANNING RE-SUBMITTAL 12 FEBRUARY 2015

PLANNING RE-SUBMITTAL 24 MARCH 2015

20 APRIL 2015

DWG. SCALE: AS SHOWN DRAWN BY: MG, MK, TC, IJ

A1.1

1/16" = 1'-0"

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SHEET TITLE:

SITE CONTEXT PLAN

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10 OCTOBER 2014


PLANNING RE-SUBMITTAL
12 FEBRUARY 2015

PLANNING RE-SUBMITTAL
24 MARCH 2015

20 APRIL 2015

PROJ. NO. MCL
ISSUED: --DWG. SCALE: AS SHOWN
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A1.2



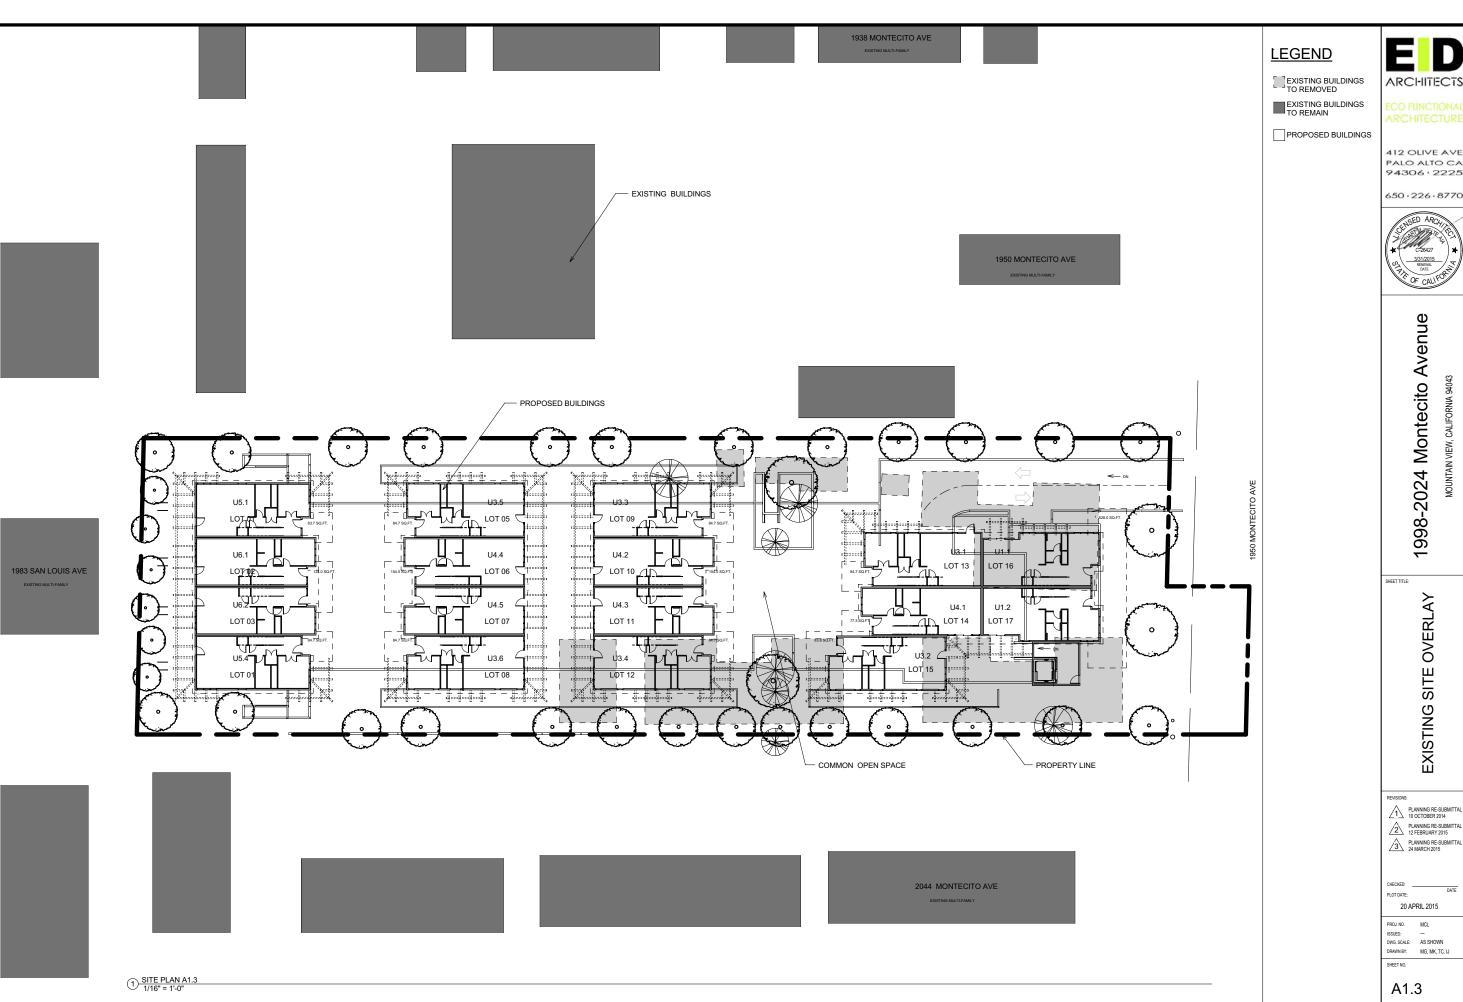



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STREETSCAPE ELEVATIONS

PLANNING RE-SUBMITTA 10 OCTOBER 2014

PLANNING RE-SUBMITTA 12 FEBRUARY 2015

DWG. SCALE: AS SHOWN
DRAWN BY: MG, MK, TC, IJ

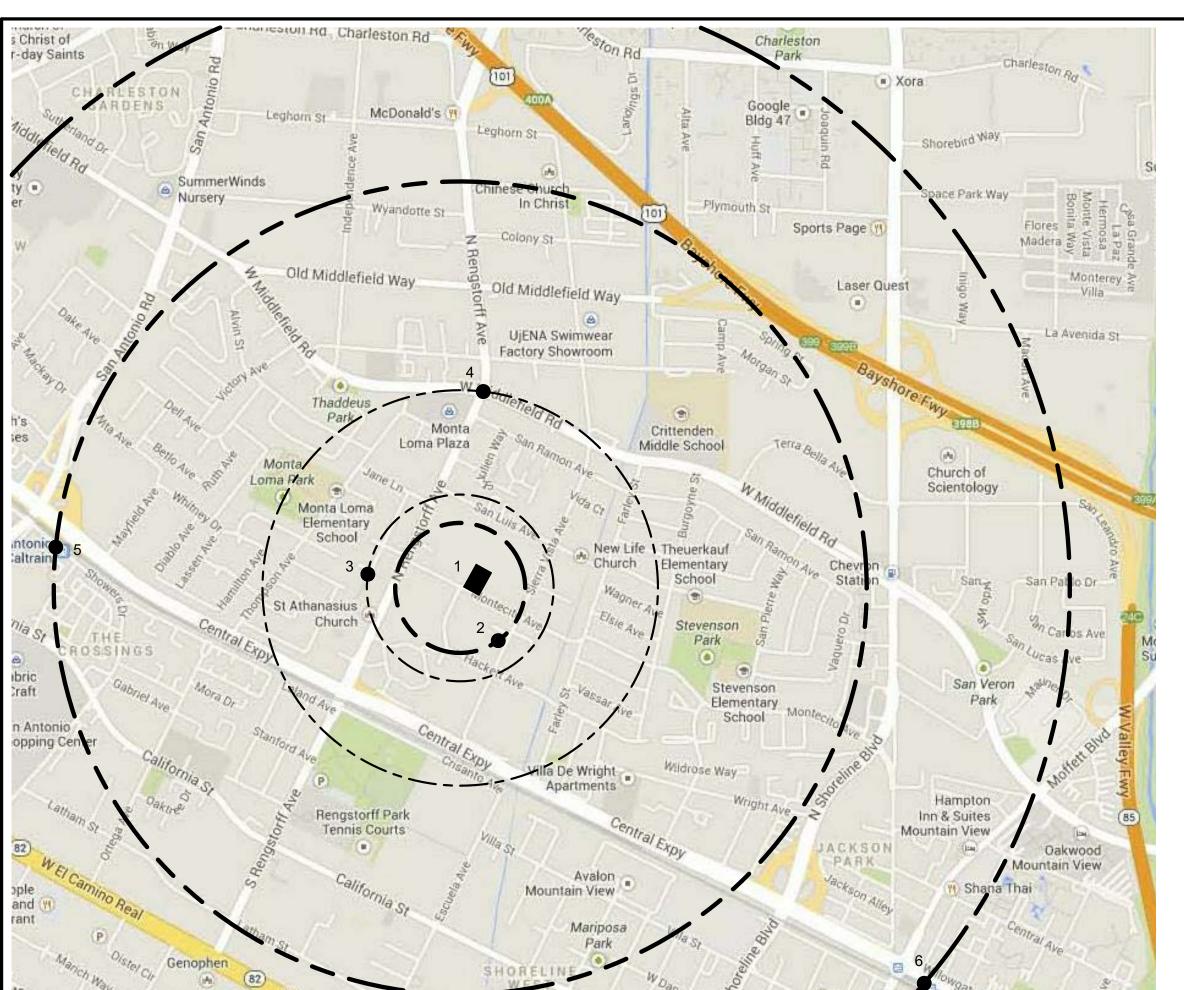
A1.4



PHOTOREALISTIC VIEW FROM MONTECITO AVE

20 APRIL 2015







CO FUNCTIONAL

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Avenue

1998-2024 Montecito Av

1. PROJECT LOCATION

1998 - 2024 MONTECITO AVENUE
MOUNTAIN VIEW, CA 94043

2. BUS 34

ABOUT 2 MINUTES WALK TO SIERRA VISTA AVENUE & MONTECITO AVENUE (0.1 MILE)

3. BUS 40

ABOUT 3 MINUTES WALK TO RENGSTOFF AVENUE & JEWELL PLACE (0.2 MILE)

4. BUS 32

ABOUT 10 MINUTES WALK TO MIDDLEFIELD ROAD & RENGSTOFF AVENUE (0.5 MILE)

5. CALTRAIN

ABOUT 21 MINUTES WALK TO SAN ANTONIO CALTRAIN STATION (1 MILE)

6. CALTRAIN

ABOUT 30 MINUTES WALK TO MOUNTAIN VIEW CALTR
STATION (1.5 MILE) GOOGLE SHUTTLE STOP AT

SITE PLAN TRANSIT LINKS

PLANNING RE-SUBMITTA 24 MARCH 2015

HECKED: DATE
OF DATE: DATE

PROJ. NO. MCL
ISSUED: --DWG. SCALE: AS SHOWN
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SHEET NO.

A1.5

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1998-2024 Montecito Avenue

MOUNTAIN VIEW, CALIFORNIA

SHEET TITLE:

GARAGE PLAN

PLANNING RE-SUBMITTA 10 OCTOBER 2014


PLANNING RE-SUBMITTA 12 FEBRUARY 2015

PLANNING RE-SUBMITTA 24 MARCH 2015


20 APRIL 2015

PROJ. NO. MCL ISSUED: ---DIWG. SCALE: AS SHOWN
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A3.1

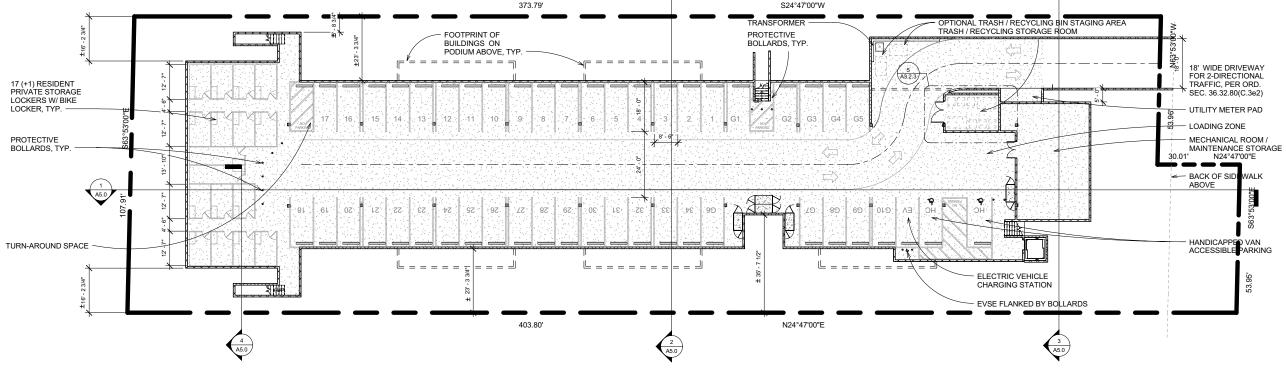

1/16" = 1'-0"



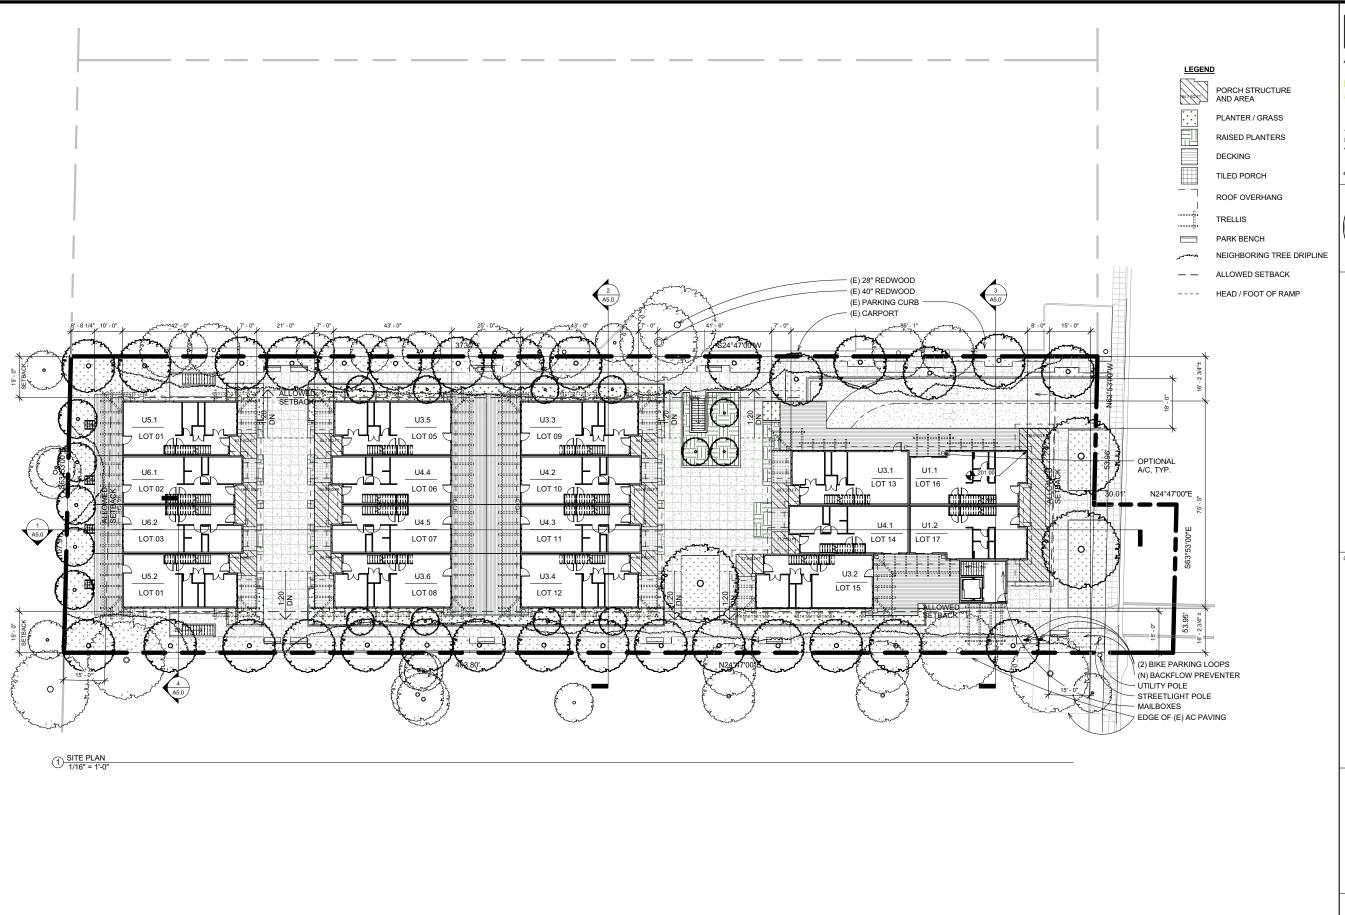

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1998-2024 Montecito Avenue

SHEET TITLE:

PLAN SITE

PLANNING RE-SUBMITTA 10 OCTOBER 2014

PLANNING RE-SUBMITTA 12 FEBRUARY 2015 PLANNING RE-SUBMITTA 24 MARCH 2015

20 APRIL 2015

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A3.2



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1998-2024 Montecito Avenue

SITE 2ND FLOOR PLAN OVERALL

PLANNING RE-SUBMITTAL
10 OCTOBER 2014

PLANNING RE-SUBMITTAL
12 FEBRUARY 2015

PLANNING RE-SUBMITTAL 24 MARCH 2015

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A3.2.1

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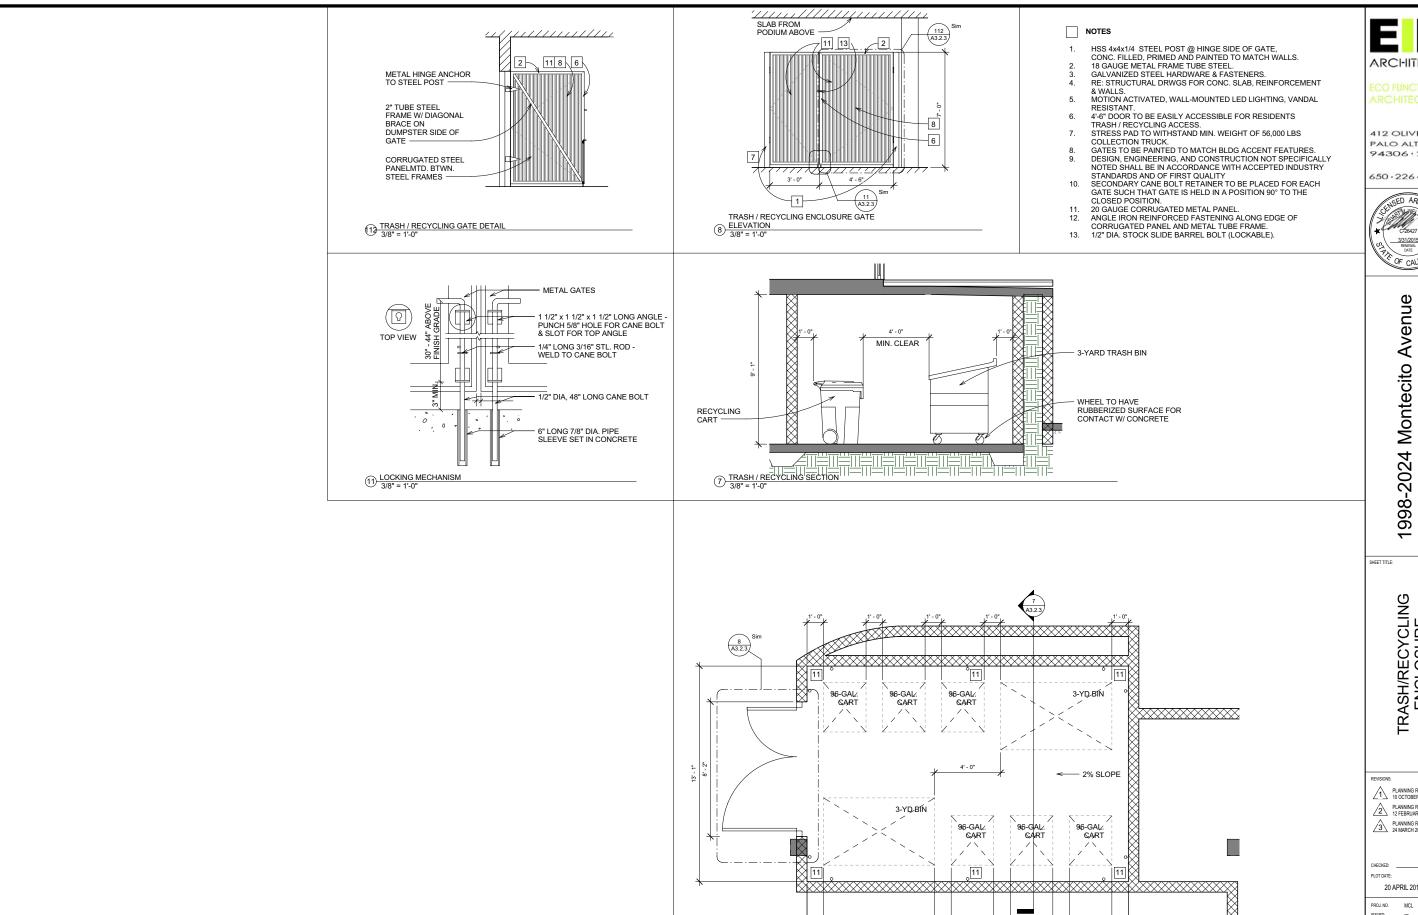
SITE 3RD FLOOR PLAN OVERALL

PLANNING RE-SUBMITTAL
10 OCTOBER 2014
2 PLANNING RE-SUBMITTAL
12 FEBRUARY 2015
PLANNING RE-SUBMITTAL
24 MARCH 2015

20 APRIL 2015

ISSUED: --DIWG. SCALE: AS SHOWN
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A3.2.2



5 TRASH / RECYCLING ENCLOSURE PLAN
3/8" = 1'-0"

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TRASH/RECYCLING ENCLOSURE


PLANNING RE-SUBMITTA 10 OCTOBER 2014 PLANNING RE-SUBMITT. 12 FEBRUARY 2015 PLANNING RE-SUBMITTA 24 MARCH 2015

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A3.2.3





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SHEET TITLE:

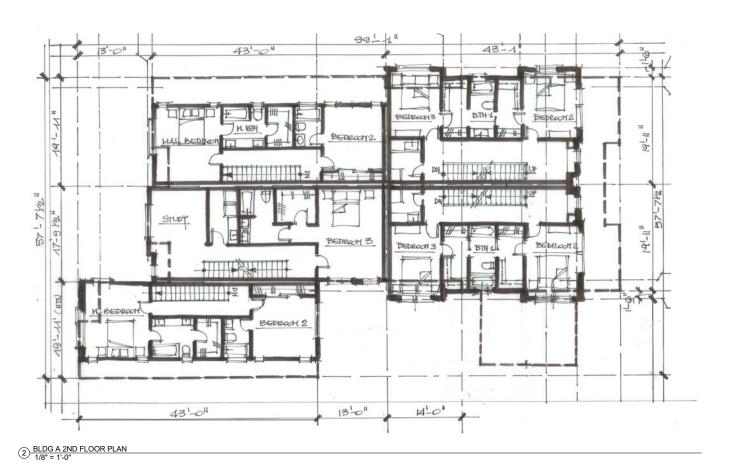FLOOR PLAN **BUILDING A**


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12 FEBRUARY 2015


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A3.3





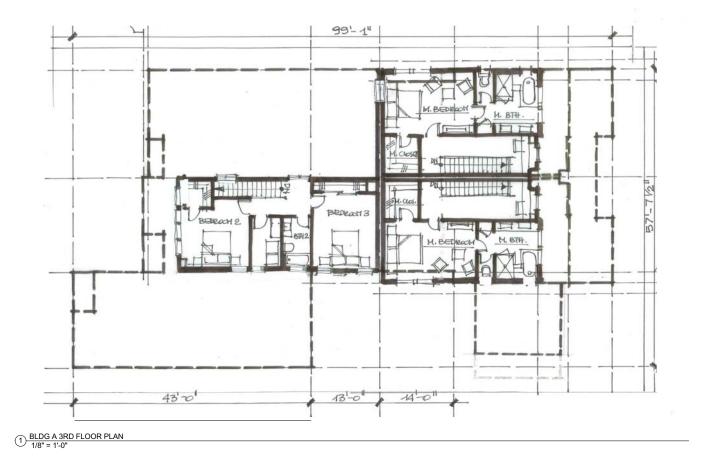

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BUILDING A FLOOR PLAN AND ROOF PLAN

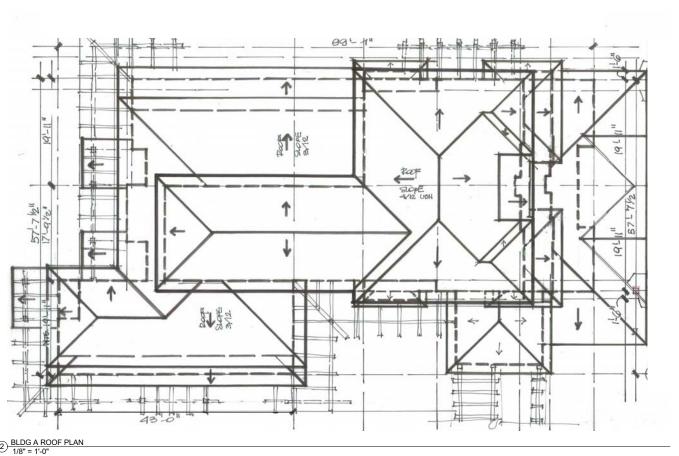PLANNING RE-SUBMITTAL
10 OCTOBER 2014


PLANNING RE-SUBMITTAL
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PLANNING RE-SUBMITTAL 24 MARCH 2015


20 APRIL 2015

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A3.4



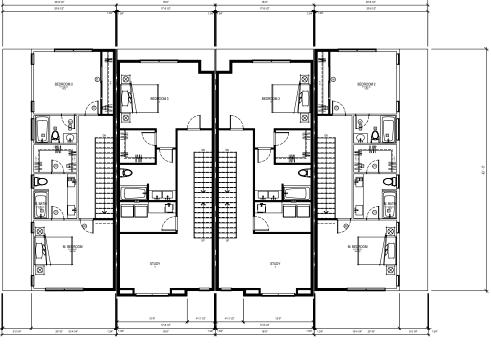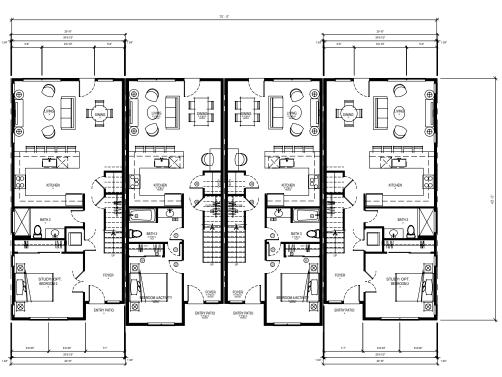2 BLDG B 2ND FLOOR PLAN 1/8" = 1'-0"



1) BLDG B 1ST FLOOR PLAN 1/8" = 1'-0"

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1998-2024 Montecito Avenue

SHEET TITLE:

BUILDING B

FLOOR PLAN

PLANNING RE-SUBMITTAL
10 OCTOBER 2014


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12 FEBRUARY 2015


PLANNING RE-SUBMITTAL 24 MARCH 2015

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A3.5



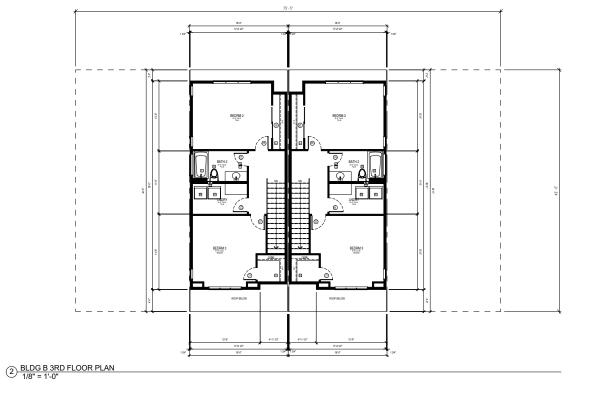
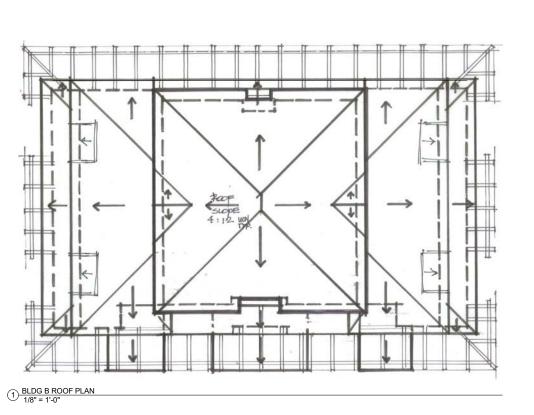
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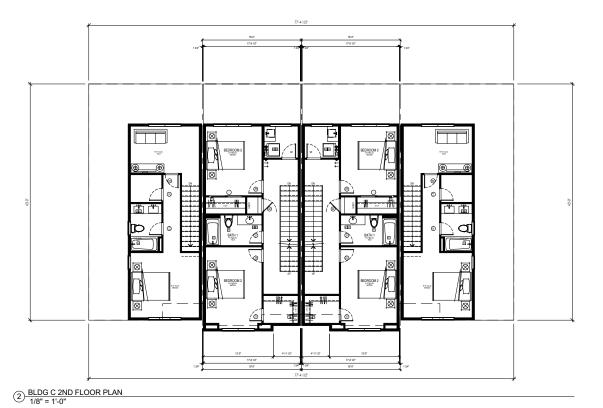
BUILDING B FLOOR PLAN AND ROOF PLAN


PLANNING RE-SUBMITTAL
10 OCTOBER 2014
2 PLANNING RE-SUBMITTAL
12 FEBRUARY 2015
PLANNING RE-SUBMITTAL
24 MARCH 2015

20 APRIL 2015

ISSUED: --DIWG. SCALE: AS SHOWN
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A3.6



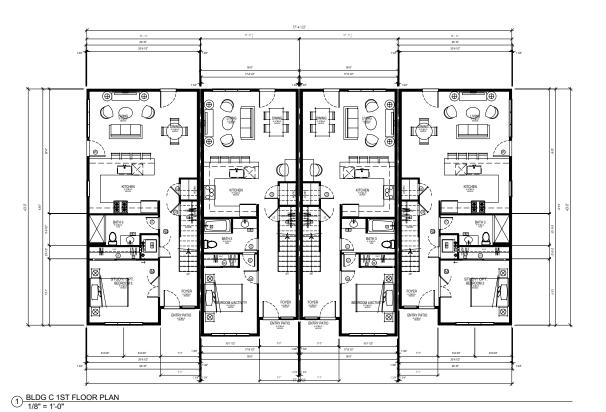

ARCHITECTS

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1998-2024 Montecito Avenue

SHEET TITLE:

BUILDING C FLOOR PLAN

PLANNING RE-SUBMITTAL
10 OCTOBER 2014


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12 FEBRUARY 2015


PLANNING RE-SUBMITTAL 24 MARCH 2015

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DRAWN BY: MG, MK, TC, IJ

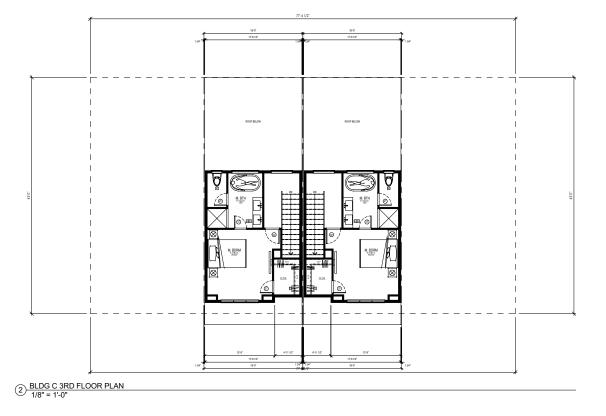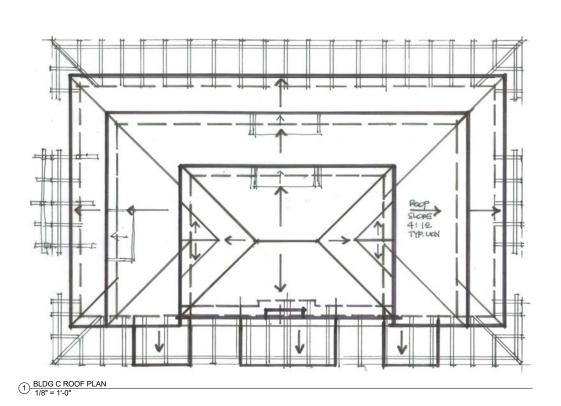A3.7





EDARCHITECTS

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1998-2024 Montecito Avenue

BUILDING C FLOOR PLAN AND ROOF PLAN

PLANNING RE-SUBMITTAL
10 OCTOBER 2014

PLANNING RE-SUBMITTAL
12 FEBRUARY 2015

PLANNING RE-SUBMITTAL 24 MARCH 2015

20 APRIL 2015

MCL

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A3.8



1998-2024 Montecito Avenue , CALIFORNIA

SHEET TITLE:

PROJECT ELEVATION


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PLANNING RE-SUBMITTAL 12 FEBRUARY 2015

PLANNING RE-SUBMITTA 24 MARCH 2015


20 APRIL 2015

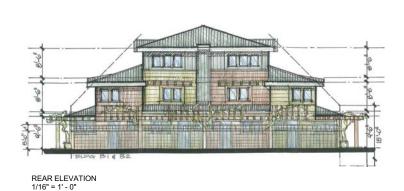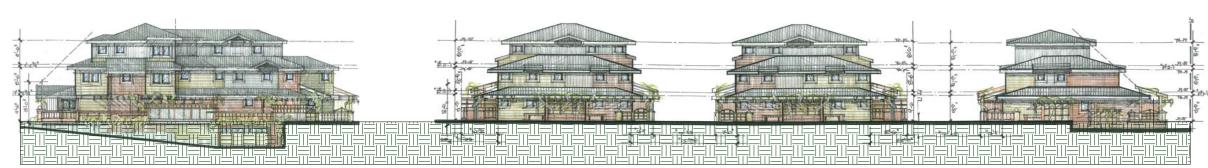PROJ. NO. MCL ISSUED: --DWG. SCALE: AS SHOWN DRAWN BY: MG, MK, TC, IJ











EAST ELEVATION 1/16" = 1' - 0"

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A4.1

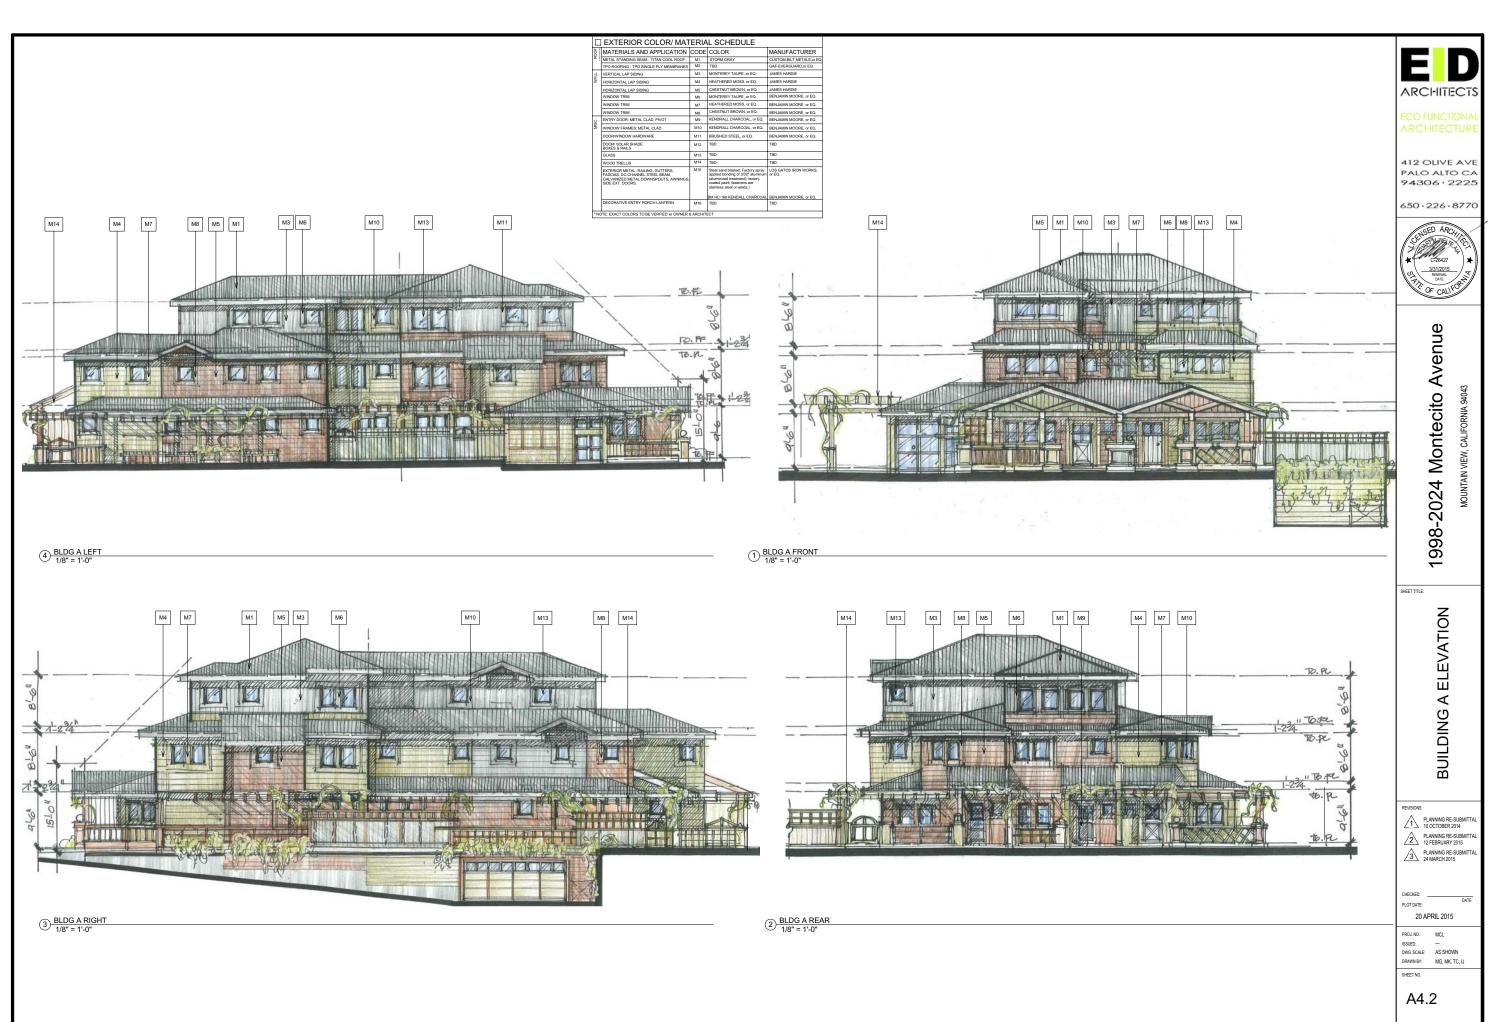

ROOF	MATERIALS AND APPLICATION	CODE	COLOR	MANUFACTURER
2 j	METAL STANDING SEAM - TITAN COOL ROOF	M1	STORM GRAY	CUSTOM-BILT METALS or EC
	TPO ROOFING - TPO SINGLE PLY MEMBRANES	M2	TBD	GAF-EVERGUARD,or EQ.
3	VERTICAL LAP SIDING	M3	MONTEREY TAUPE, or EQ.	JAMES HARDIE
WALL	HORIZONTAL LAP SIDING	M4	HEATHERED MOSS, or EQ.	JAMES HARDIE
	HORIZONTAL LAP SIDING	M5	CHESTNUT BROWN, or EQ.	JAMES HARDIE
	WINDOW TRIM	M6	MONTEREY TAUPE, or EQ.	BENJAMIN MOORE, or EQ.
	WINDOW TRIM	M7	HEATHERED MOSS, or EQ.	BENJAMIN MOORE, or EQ.
	WINDOW TRIM	M8	CHESTNUT BROWN, or EQ.	BENJAMIN MOORE, or EQ.
MISC.	ENTRY DOOR: METAL CLAD, PIVOT	M9	KENDRALL CHARCOAL, or EQ.	BENJAMIN MOORE, or EQ.
N	WINDOW FRAMES: METAL CLAD	M10	KENDRALL CHARCOAL, or EQ.	BENJAMIN MOORE, or EQ.
	DOOR/WINDOW HARDWARE	M11	BRUSHED STEEL, or EQ.	BENJAMIN MOORE, or EQ.
	DOOR/ SOLAR SHADE BOXES & RAILS	M12	TBD	TBD
	GLASS	M13	TBD	TBD
	WOOD TRELLIS	M14	TBD	TBD
	EXTERIOR METAL: RAILING, GUTTERS, FASCIAS, DC-CHANNEL STEEL BEAM, GALVANIZED METAL DOWNSPOUTS, AWNINGS, SIDE EXT. DOORS.	M15	Steel sand blasted; Factory spray applied bonding of 3/32" aluminum (aluminized treatment); factory coated paint; fasteners are stainless steel or welds.)	
	DECORATIVE ENTRY PORCH LANTERN	M16	BM HC-166 KENDALL CHARCOAL TRD	BENJAMIN MOORE, or EQ.

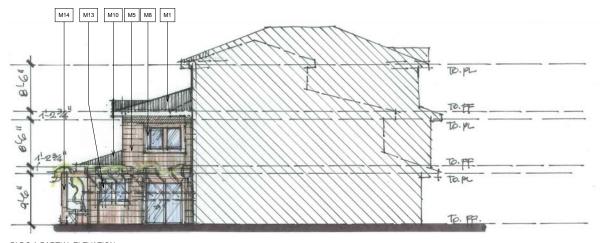

1 BLDG A PARTIAL ELEVATION 1/8" = 1'-0"

EDARCHITECTS

412 OLIVE AVE PALO ALTO CA 94306 · 2225

650 - 226 - 8770



1998-2024 Montecito Avenue

SHEET TITLE:

BUILDING A ELEVATION

PLANNING RE-SUBMITTAL
10 OCTOBER 2014
2 PLANNING RE-SUBMITTAL
12 FEBRUARY 2015
PLANNING RE-SUBMITTAL
24 MARCH 2015

20 APRIL 2015


PROJ. NO. MCL
ISSUED: --DING. SCALE: AS SHOWN
DRAWN BY: MG, MK, TC, IJ

A4.2.1


	EXTERIOR COLOR/ MAT	ERIA	L SCHEDULE	
ROOF	MATERIALS AND APPLICATION	CODE	COLOR	MANUFACTURER
& i	METAL STANDING SEAM - TITAN COOL ROOF	M1	STORM GRAY	CUSTOM-BILT METALS, or EQ.
1	TPO ROOFING - TPO SINGLE PLY MEMBRANES	M2	TBD	GAF-EVERGUARD,or EQ.
WALL	VERTICAL LAP SIDING	M3	MONTEREY TAUPE, or EQ.	JAMES HARDIE
š	HORIZONTAL LAP SIDING	M4	HEATHERED MOSS, or EQ.	JAMES HARDIE
	HORIZONTAL LAP SIDING	M5	CHESTNUT BROWN, or EQ.	JAMES HARDIE
	WINDOW TRIM	M6	MONTEREY TAUPE, or EQ.	BENJAMIN MOORE, or EQ.
	WINDOW TRIM	M7	HEATHERED MOSS, or EQ.	BENJAMIN MOORE, or EQ.
	WINDOW TRIM	M8	CHESTNUT BROWN, or EQ.	BENJAMIN MOORE, or EQ.
MISC.	ENTRY DOOR: METAL CLAD, PIVOT	M9	KENDRALL CHARCOAL, or EQ.	BENJAMIN MOORE, or EQ.
¥	WINDOW FRAMES: METAL CLAD	M10	KENDRALL CHARCOAL, or EQ.	BENJAMIN MOORE, or EQ.
	DOORWINDOW HARDWARE	M11	BRUSHED STEEL, or EQ.	BENJAMIN MOORE, or EQ.
	DOOR/ SOLAR SHADE BOXES & RAILS	M12	TBD	TBD
	GLASS	M13	TBD	TBD
	WOOD TRELLIS	M14	TBD	TBD
	EXTERIOR METAL: RAILING, GUTTERS, FASCIAS, DC-CHANNEL STEEL BEAM, GALVANIZED METAL DOWNSPOUTS, AWNINGS, SIDE EXT. DOORS.	M15	Steel sand blasted; Factory spray applied bonding of 3/32" aluminum (aluminized treatment); factory coated paint; fasteners are stainless steel or welds.)	LOS GATOS IRON WORKS, or EQ.
1			BM HC-166 KENDALL CHARCOAL	
	DECORATIVE ENTRY PORCH LANTERN	M16	TBD	TBD
* NC	TE: EXACT COLORS TO BE VERFIED w/ OWNER.	& ARCHITI	ECT	·



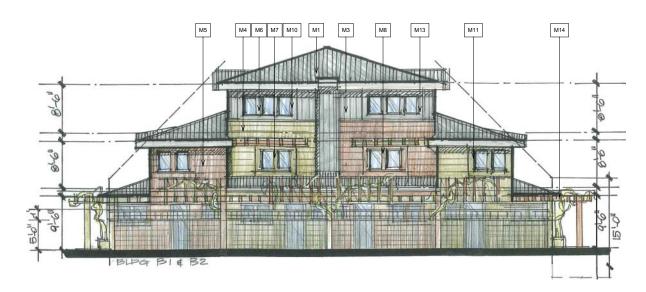1) BLDG B FRONT 1/8" = 1'-0"



2 BLDG B REAR 1/8" = 1'-0"

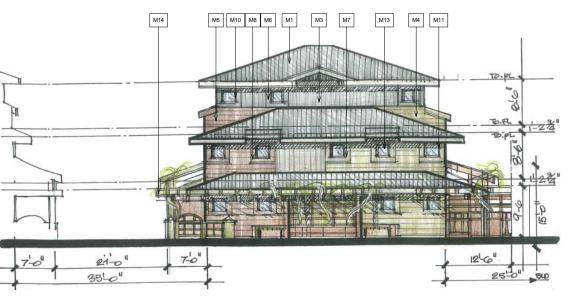

3 BLDG B (OTHER SITE SIM) 1/8" = 1'-0"

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SHEET TITLE:

B ELEVATION BUILDING

PLANNING RE-SUBMITTAL 10 OCTOBER 2014

PLANNING RE-SUBMITTA 12 FEBRUARY 2015

PLANNING RE-SUBMITTAL 24 MARCH 2015

20 APRIL 2015

MCL ISSUED: --DWG. SCALE: AS SHOWN DRAWN BY: MG, MK, TC, IJ

A4.3


	EXTERIOR COLOR/ MAT			
ROOF	MATERIALS AND APPLICATION	CODE	COLOR	MANUFACTURER
@	METAL STANDING SEAM - TITAN COOL ROOF	M1	STORM GRAY	CUSTOM-BILT METALS, or EQ
	TPO ROOFING - TPO SINGLE PLY MEMBRANES	M2	TBD	GAF-EVERGUARD,or EQ.
WALL	VERTICAL LAP SIDING	M3	MONTEREY TAUPE, or EQ.	JAMES HARDIE
š	HORIZONTAL LAP SIDING	M4	HEATHERED MOSS, or EQ.	JAMES HARDIE
	HORIZONTAL LAP SIDING	M5	CHESTNUT BROWN, or EQ.	JAMES HARDIE
	WINDOW TRIM	M6	MONTEREY TAUPE, or EQ.	BENJAMIN MOORE, or EQ.
	WINDOW TRIM	M7	HEATHERED MOSS, or EQ.	BENJAMIN MOORE, or EQ.
	WINDOW TRIM	M8	CHESTNUT BROWN, or EQ.	BENJAMIN MOORE, or EQ.
g	ENTRY DOOR: METAL CLAD, PIVOT	M9	KENDRALL CHARCOAL, or EQ.	BENJAMIN MOORE, or EQ.
MISC.	WINDOW FRAMES: METAL CLAD	M10	KENDRALL CHARCOAL, or EQ.	BENJAMIN MOORE, or EQ.
	DOOR/WINDOW HARDWARE	M11	BRUSHED STEEL, or EQ.	BENJAMIN MOORE, or EQ.
	DOOR/ SOLAR SHADE BOXES & RAILS	M12	TBD	TBD
	GLASS	M13	TBD	TBD
	WOOD TRELLIS	M14	TBD	TBD
	EXTERIOR METAL: RAILING, GUTTERS, FASCIAS, DC-CHANNEL STEEL BEAM, GALVANIZED METAL DOWNSPOUTS, AWNINGS, SIDE EXT. DOORS.		Steel sand blasted; Factory spray applied bonding of 3/32* aluminum (aluminized treatment); factory coated paint; fasteners are stainless steel or welds.) BM HC-166 KENDALL CHARCOAL	
	DECORATIVE ENTRY PORCH LANTERN	M16	TRD	TRD



1) BLDG C FRONT 1/8" = 1'-0"



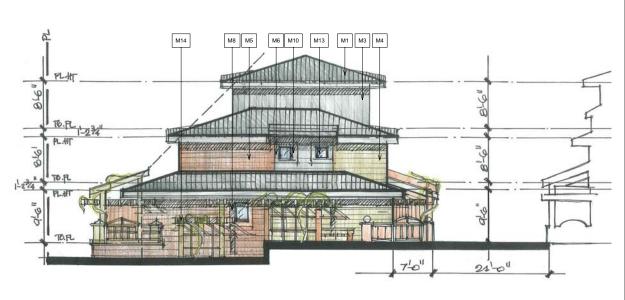2 BLDG C REAR 1/8" = 1'-0"



3 BLDG C (OTHER SITE SIM) 1/8" = 1'-0"

ARCHITECTS

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MOUNTAIN VIEW, CALIFORNIA

1998-2024 Montecito Avenue

SHEET TITLE:

C ELEVATION

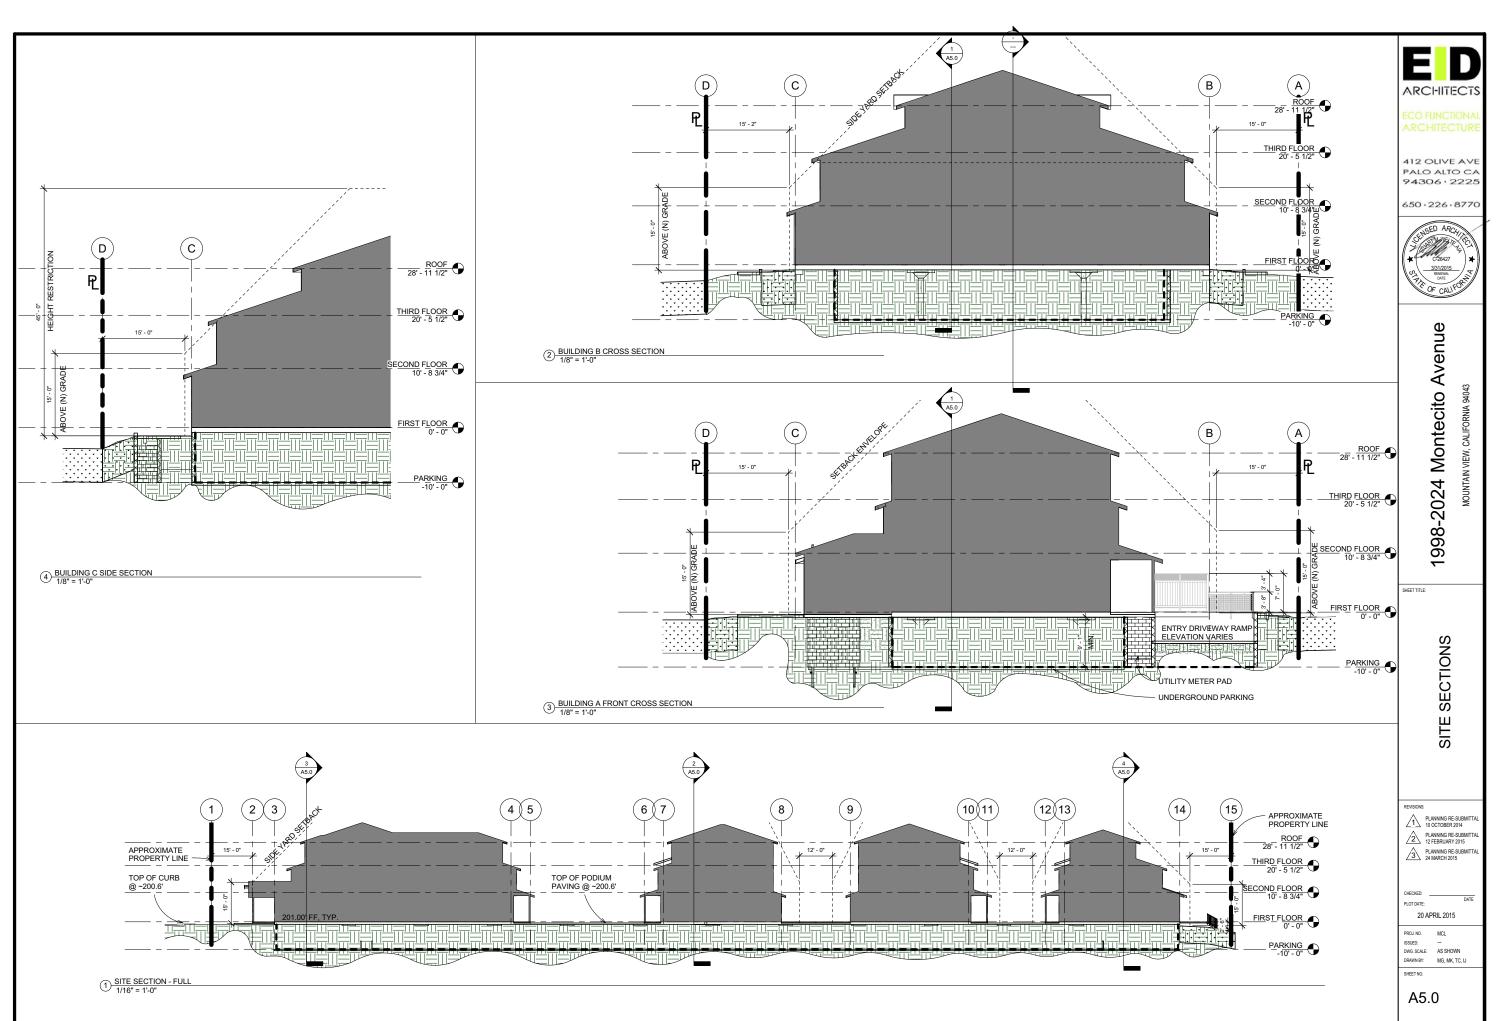
BUILDING (

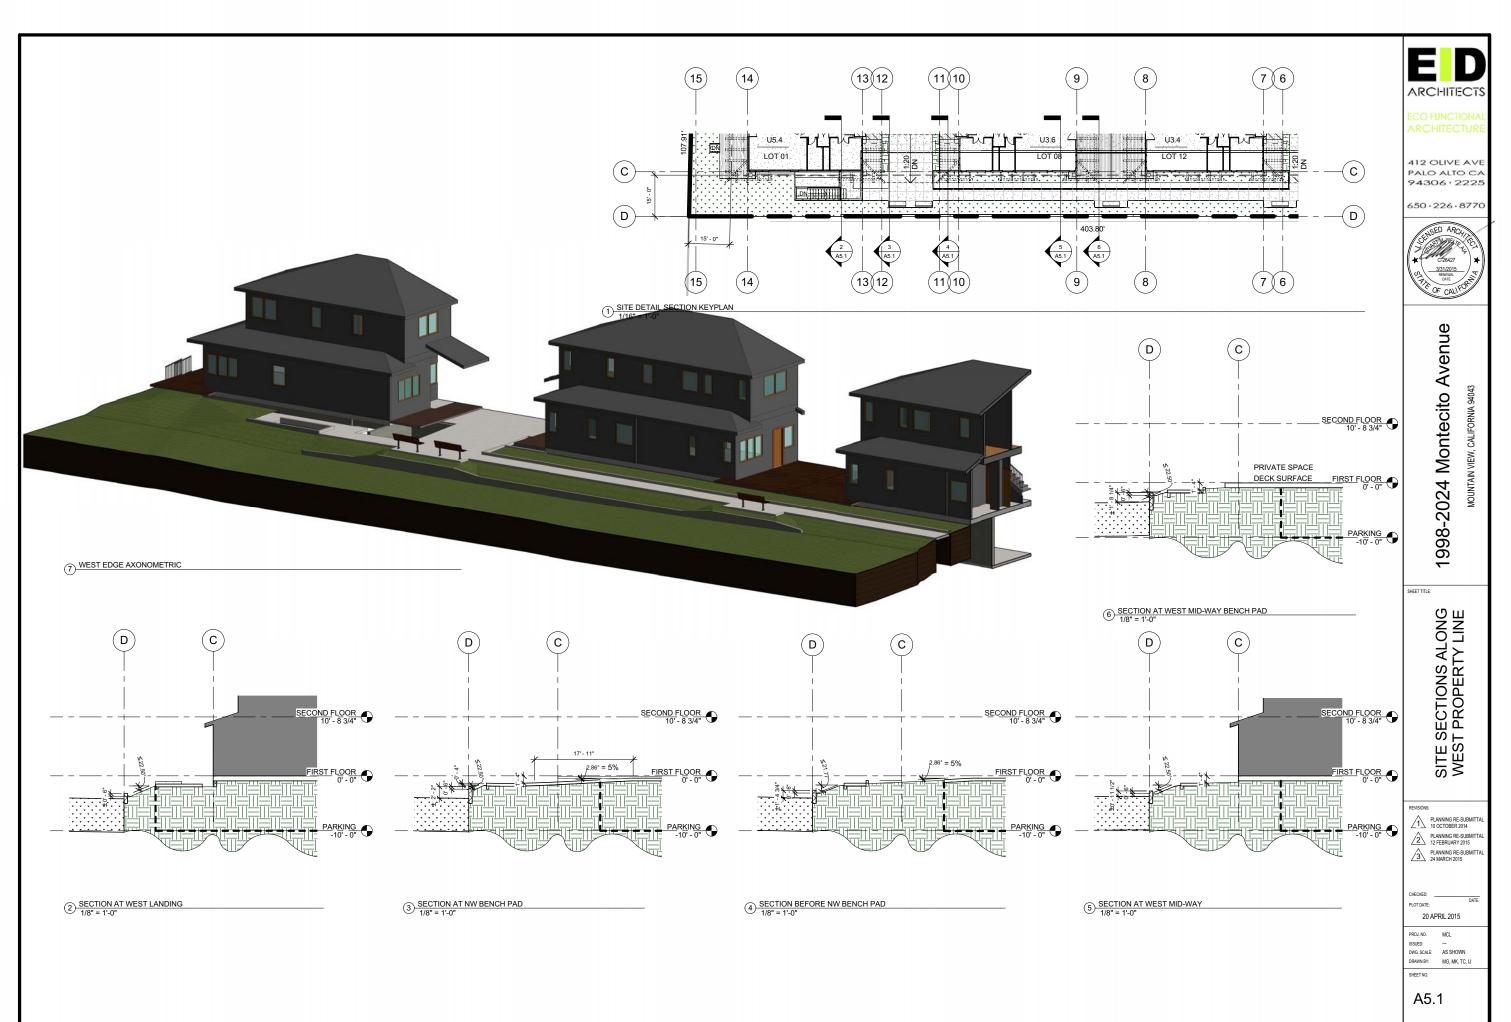
PLANNING RE-SUBMITTAL 10 OCTOBER 2014
PLANNING RE-SUBMITTAL 12 FEBRUARY 2015 PLANNING RE-SUBMITTAL 24 MARCH 2015

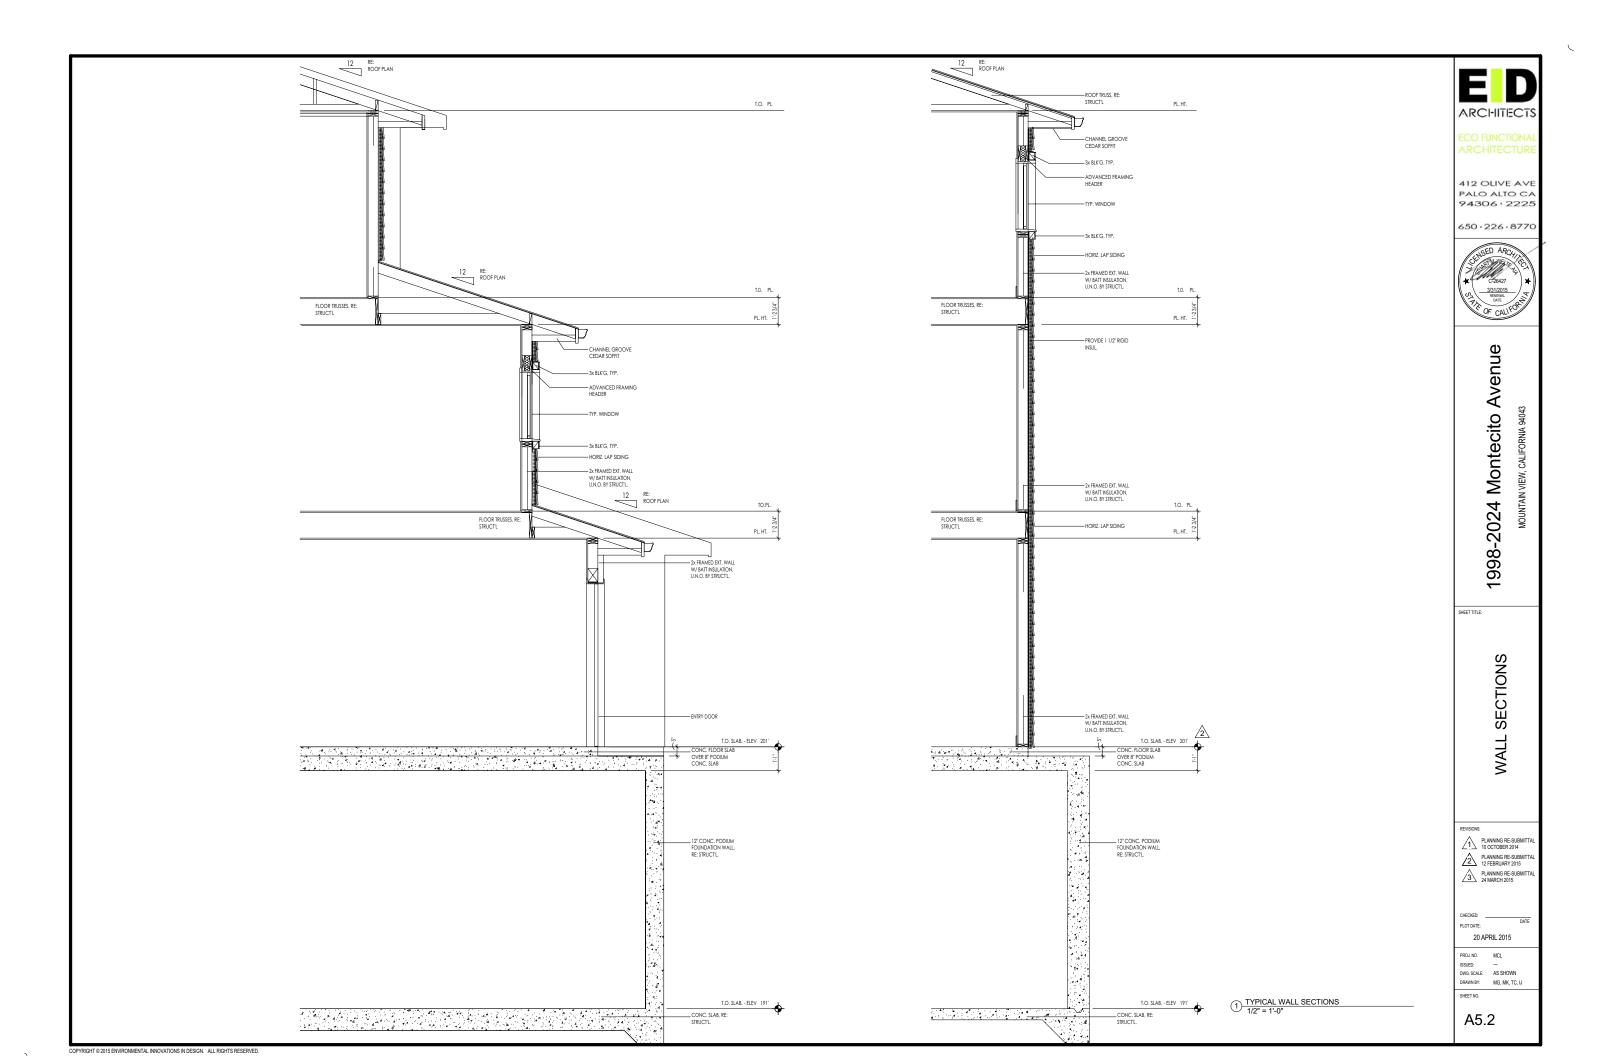
20 APRIL 2015

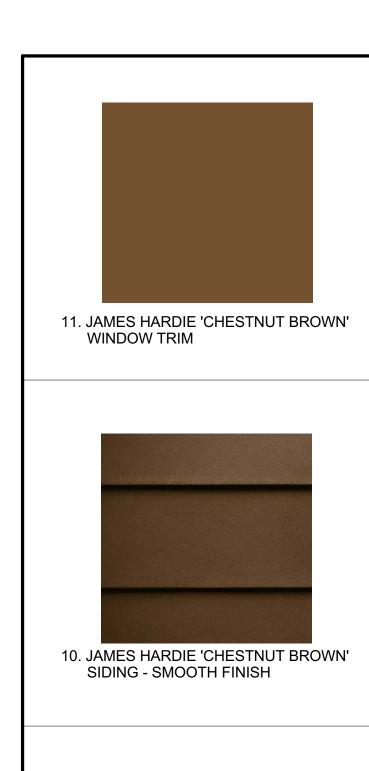
PROJ. NO. MCL ISSUED: --DWG. SCALE: AS SHOWN DRAWN BY: MG, MK, TC, IJ

A4.4












8. JAMES HARDIE 'HEATHERED MOSS'

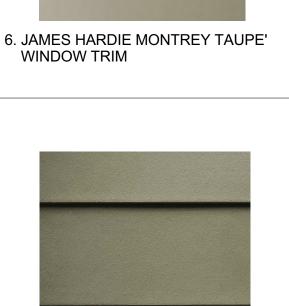WINDOW TRIM





5. JAMES HARDIE 'MONTEREY TAUPE' SIDING - SMOOTH FINISH



2. HARDIE TRIM TYP.



9. DAVIS 'ADOBE' CONCRETE TYP.



7. EXTERIOR PATIO TILE TYP.



4. B.M 'KENDALL CHARCOAL' ENTRY DOOR AND WINDOW FRAME



1. PRIVATE SPACE, SIM



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1998-2024 Montecito Avenue

COLOR AND MATERIALS

PLANNING RE-SUBMITTA 10 OCTOBER 2014

PLANNING RE-SUBMITTA 12 FEBRUARY 2015

20 APRIL 2015

ISSUED: --DWG. SCALE: AS SHOWN



650 - 226 - 8770

ARCHITECTS

PALO ALTO CA 94306 • 2225



1998-2024 Montecito Avenue



3. FENCE, COLUMNS, OPTIONS



9. ENTRY DOUBLE COLUMNS, SIM



8. FENCE OPTION, SIM



6. PRIVATE SPACE, SIM

5. ENTRY DOUBLE COLUMNS, SIM





2. FENCE WOOD OPTION, SIM



11. GATE OPTION, SIM

12. GATE WOOD OPTION, SIM



12. BENCH AND TRASH CAN





7. PLANTERS AND OUTDOOR TABLE



4. PORCH



1. TRELLIS, SIM

PLANNING RE-SUBMITTA 10 OCTOBER 2014

PLANNING RE-SUBMITTA 12 FEBRUARY 2015

ARCHITECTUAL ELEMENTS

20 APRIL 2015

DWG. SCALE: AS SHOWN
DRAWN BY: MG, MK, TC, IJ

12. EXTERIOR LIGHT POST, OPTION 1



9. MOUNTED LIGHT FIXTURE, OPTION 1



6. EXTERIOR LIGHT POST, OPTION 2





3. MOUNTED LIGHT FIXTURE, OPTION 2



11. EXTERIOR DOOR HARDWARE



8. BACKLIT ADDRESS NUMBER



5. ADDRESS NUMBER DARK



2. DOUBLE HUNG WINDOW



10. ENTRY DOOR WOOD OPTION, SIM



7. ENTRY DOOR WOOD OPTION, SIM



4. ENTRY DOOR WOOD OPTION, SIM





1. DOUBLE HUNG WINDOW



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1998-2024 Montecito Avenue

ARCHITECTUAL ELEMENTS

PLANNING RE-SUBMITTA 10 OCTOBER 2014
PLANNING RE-SUBMITTA 12 FEBRUARY 2015

20 APRIL 2015

DWG. SCALE: AS SHOWN DRAWN BY: MG, MK, TC, IJ





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1998-2024 Montecito Avenue

SHEET TITLE:

COLOR BOARD

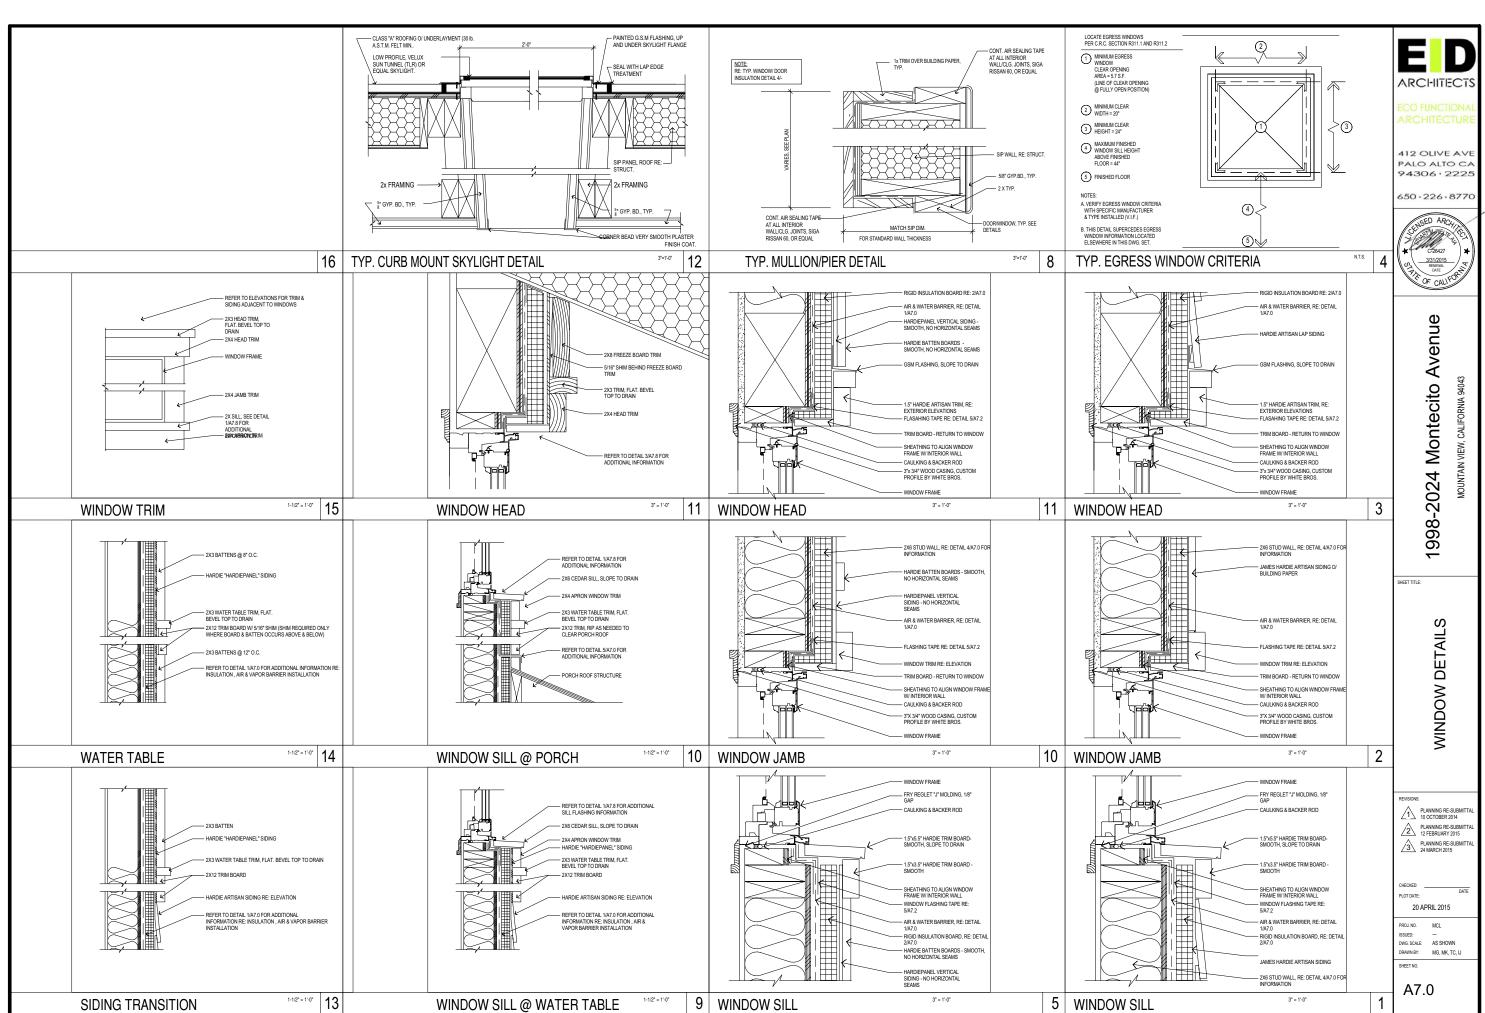
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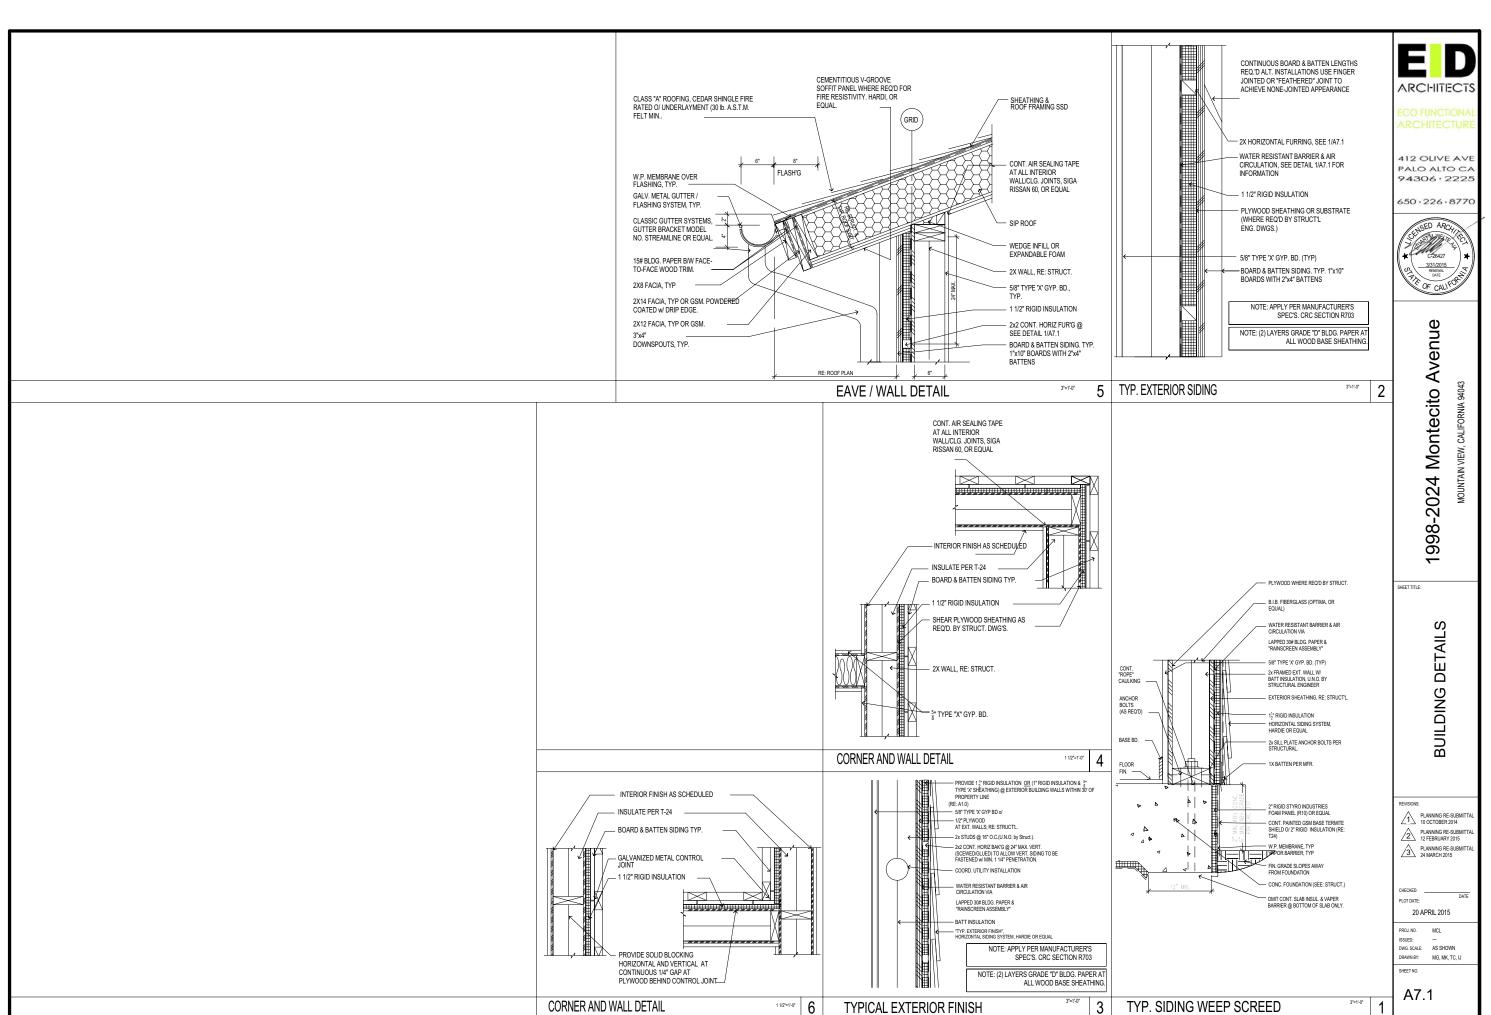
PLANNING RE-SUBMITTAL 12 FEBRUARY 2015

PLANNING RE-SUBMITTA 24 MARCH 2015

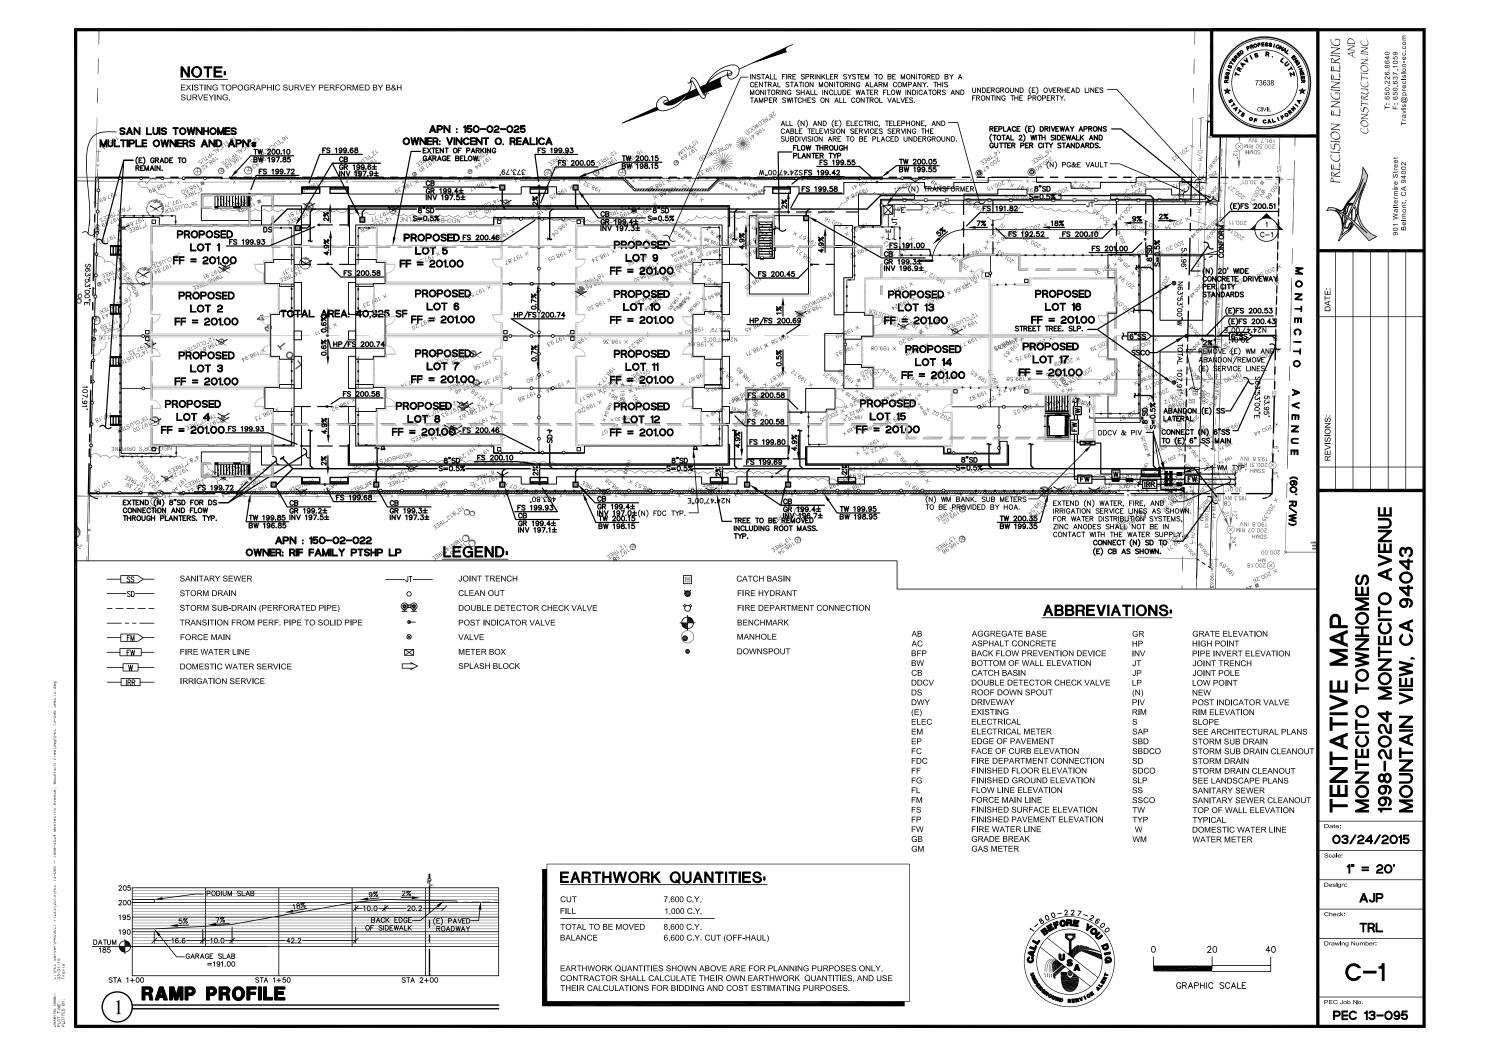
20 APRIL 2015

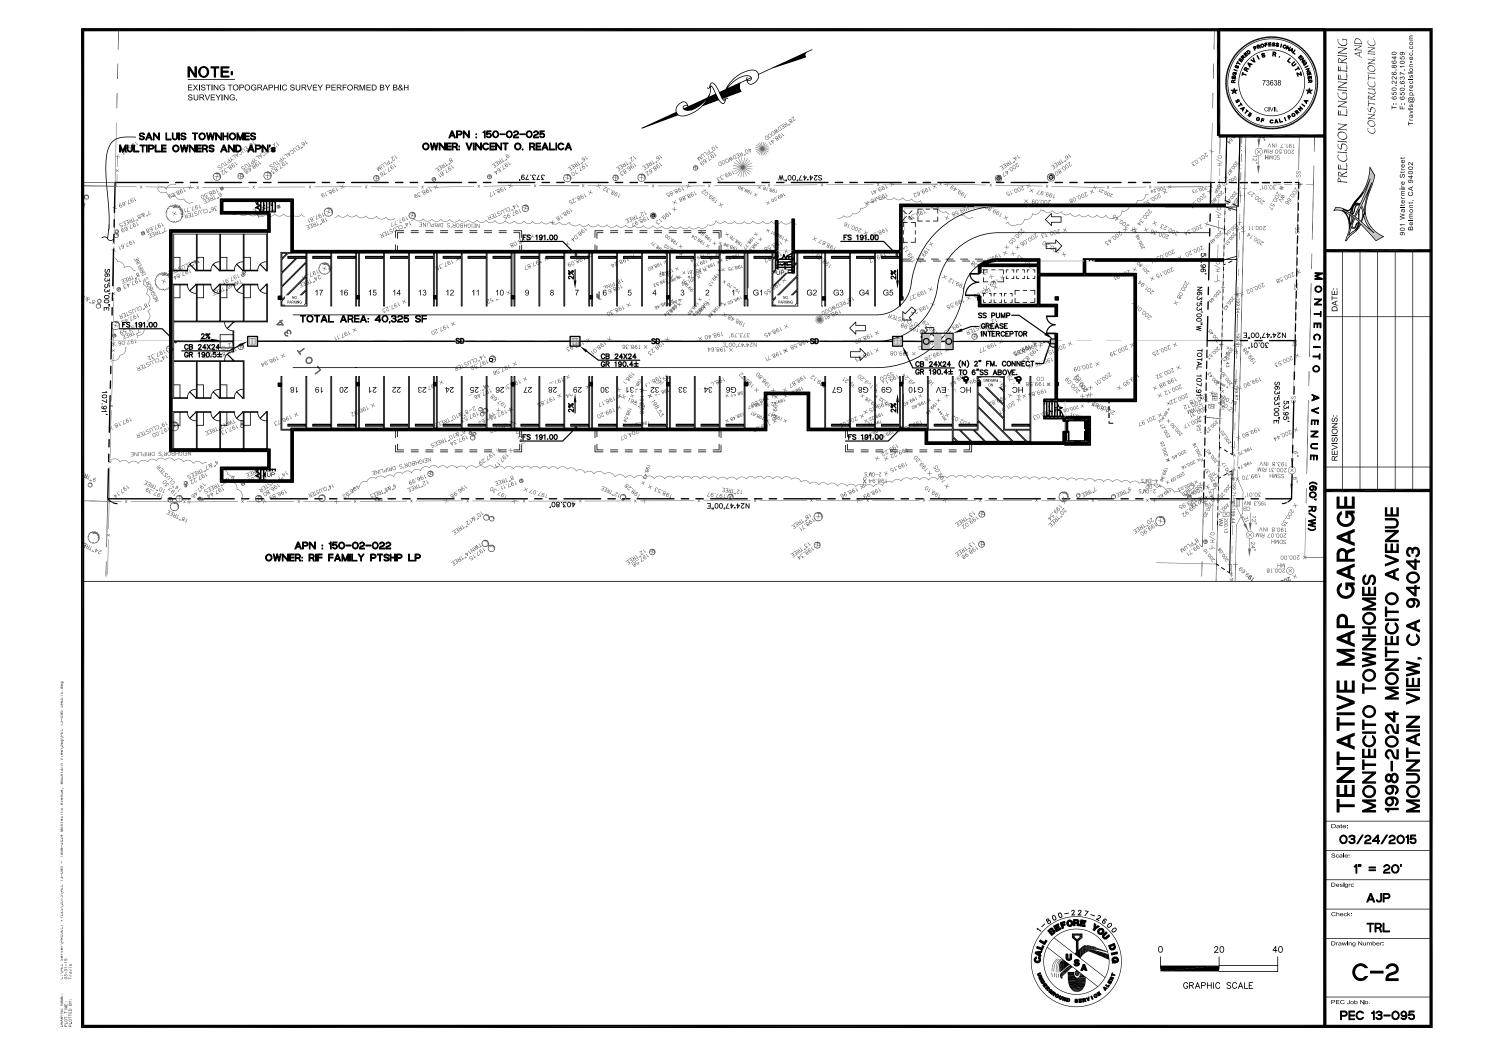
ISSUED: --DIWG. SCALE: AS SHOWN
DRAWN BY: MG, MK, TC, IJ

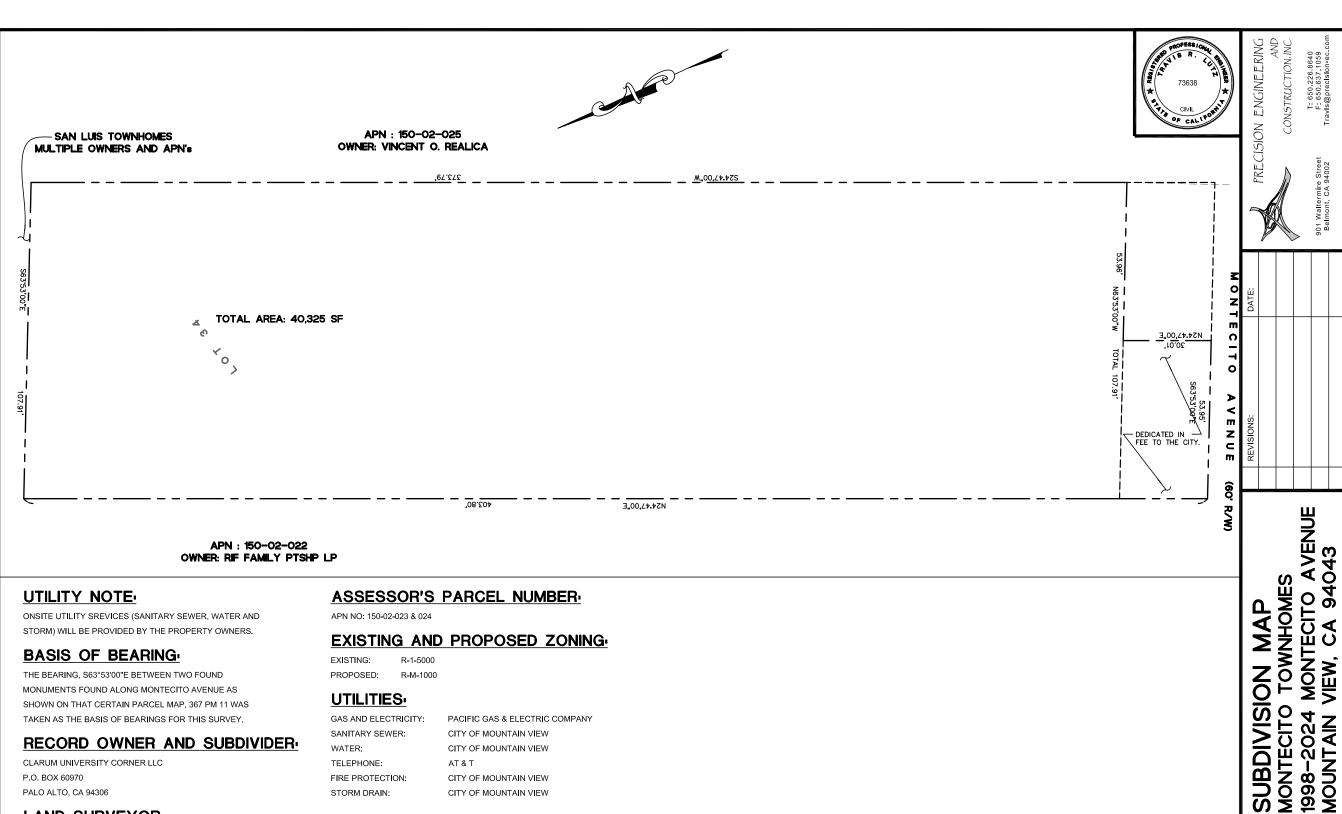




'







MONUMENTS FOUND ALONG MONTECITO AVENUE AS SHOWN ON THAT CERTAIN PARCEL MAP, 367 PM 11 WAS TAKEN AS THE BASIS OF BEARINGS FOR THIS SURVEY.

RECORD OWNER AND SUBDIVIDER-

CLARUM UNIVERSITY CORNER LLC P.O. BOX 60970

PALO ALTO, CA 94306

LAND SURVEYOR

B & H LAND SURVEYING 901 WALTERMIRE STREET BELMONT, CA 94002 (650) 637-1590

CIVIL ENGINEER:

PRECISION ENGINEERING AND CONSTRUCTION, INC. 901 WALTERMIRE STREET BELMONT, CA 94002 (650) 226-8640

UTILITIES:

GAS AND ELECTRICITY: PACIFIC GAS & ELECTRIC COMPANY SANITARY SEWER: CITY OF MOUNTAIN VIEW

WATER: CITY OF MOUNTAIN VIEW

TELEPHONE: AT & T

FIRE PROTECTION: CITY OF MOUNTAIN VIEW STORM DRAIN: CITY OF MOUNTAIN VIEW

GRAPHIC SCALE

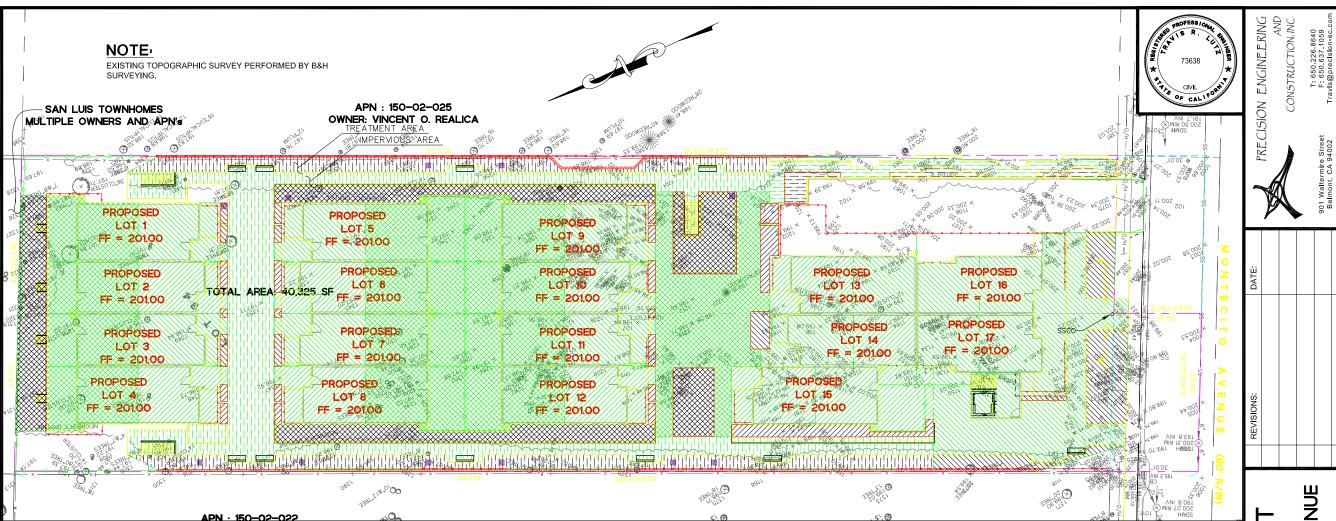
03/24/2015

1" = 20'

AJP

TRL

PEC Job No. PEC 13-095




STORMWATER TREATMENT

TOTAL AREA	TOTAL IMPERVIOUS AREA	INTERCEPTOR TREE CREDIT	IMPERVIOUS AREA REQUIRED TO BE TREATED	C.3 REQUIRED TREATMENT AREA	TREATMENT AREA PROVIDED
40,325 S.F.	31,048 S.F.	*7,700 S.F.	23,748 S.F.	950 S.F.	**1,400 S.F.

TREATMENT AREA SIZING CRITERIA: SANTA CLARA COUNTYWIDE WATER POLLUTION PREVENTION PROGRAM: C.3 STORMWATER TECHNICAL GUIDANCE.

- INTERCEPTOR TREE CREDIT: BASED ON PROPOSED TREE COUNT: (3 DECIDUOUS TREES) x (100 SF) + (35 EVERGREEN TREES) x (200 SF) = 7,300 SF
- PROVIDED BY FLOW THROUGH PLANTERS/LANDSCAPED AREAS

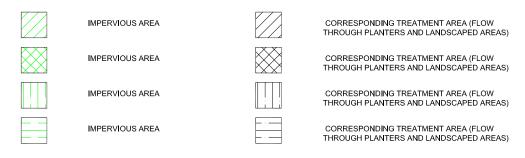LEGEND





GRAPHIC SCALE

ATMENT SHEET
O TOWNHOMES
1 MONTECITO AVENUE
VIEW, CA 94043 C.3 TREAT MONTECITO 1998-2024 MOUNTAIN VI 03/24/2015 1" = 20' AJP TRL C-4

PEC Job No.

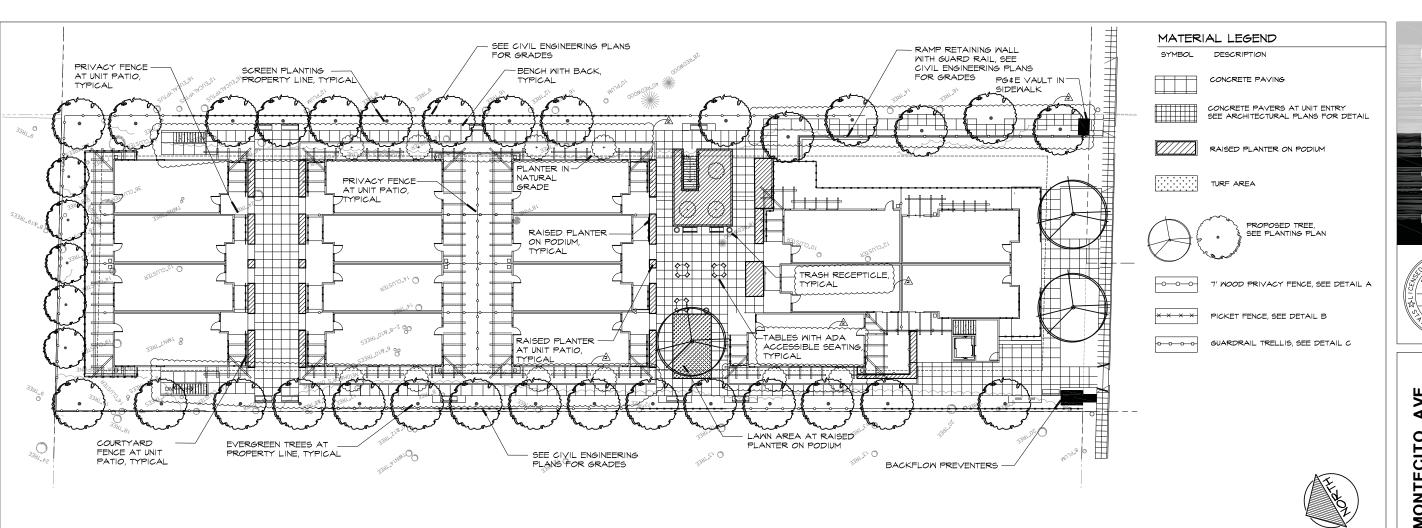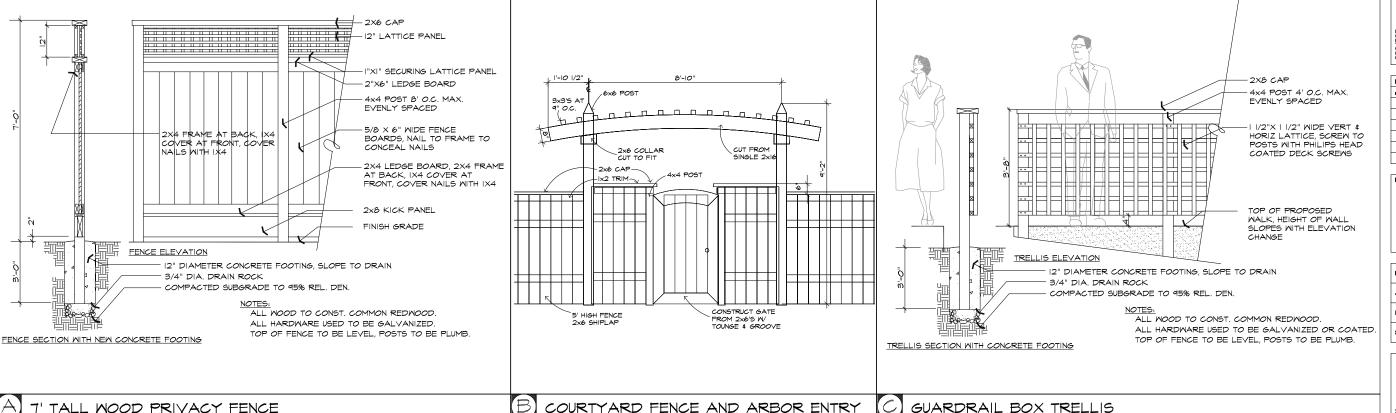PEC 13-095







Synther 17 3/2 F CALL YORK TO THE TOTAL YORK TO

1998-2024 MONTECITO AV
MOUNTAIN VIEW, CALIFORNIA

OWNER. HANFORD CAPITAL INC.
1131 DE ANZA BLVD.
SAN JOSE, CA 95129

REVISIONS				
MARK	DATE	DESCRIPTION		
- 1	10.17.14	CITY COMMENTS		
-	2.12.15	CITY COMMENTS		
2	3.24.15	CITY COMMENTS		

DRAWING TITLE

LANDSCAPE LAYOUT PLAN

DATE:9/3/14

JOB NUMBER: 1306

DRAWN: SF CHECKED: SF


SCALE: 1/16"= 1'-0"

SHEET NUMBER

L1.1

SHEET OF

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SYMBOL LEGEND

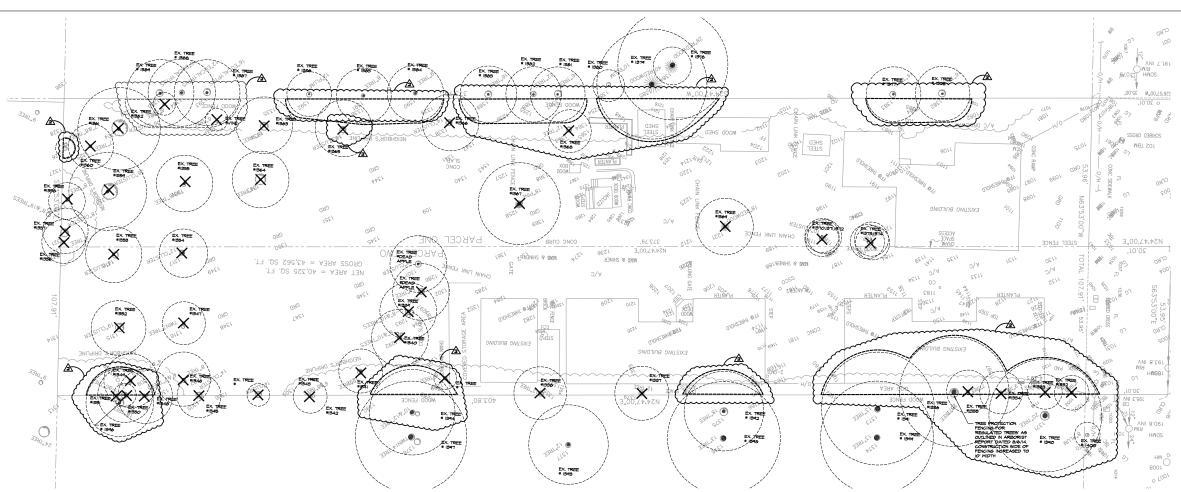

EXISTING TREES INTENDED FOR REMOVAL

EXISTING TREES TO REMAIN WITH TREE PROTECTION FENCING MEASURES AS NOTED IN ARBORIST REPORT DATED 8/6/14



AVE. I MONTECITO AIN VIEW, CALIFORNIA S C HANFORD CAPITAL I 1131 DE ANZA BLVD. SAN JOSE, CA 95129

1998-2024 N

REVISIONS

MARK	DATE	DESCRIPTION
- 1	10.17.14	CITY COMMENTS
-	2.12.15	CITY COMMENTS
2	3.24.15	CITY COMMENTS

DRAWING TITLE

TREE INVENTORY

DATE:9/3/14 JOB NUMBER: 1306

DRAWN: SF CHECKED: SF

SCALE: 1/16"= 1'-0"

SHEET NUMBER

SHEET OF

TREE INVENTORY LEGEND

TREE #	TREE SPECIES - BOTANICAL NAME	TREE SPECIES - COMMON NAME	SIZE (INCH) DBH @ 48"	STD. OR MULTI. TRUNK	TO BE	HERITAGE TREE
1332	PRUNUS DULCIS	ALMOND	6"	STD	YES	
1333	CALLISTEMON CITRINUS	BOTTLEBRUSH	6	MULTI	YES	
1334	JUGLANS NIGRA	BLACK WALNUT	9"	STD	YES	
1335	JUGLANS REGIA	ENGLISH WALNUT	7" /2	STD	YES	
1335	JUGLANS REGIA	ENGLISH MALNUT	7"	STD	XES.	YES
1336	JUGLANS NIGRA	BLACK WALNUT	20"	STD	(NO)	
1337	JUGLANS NIGRA	BLACK WALNUT	10"	STD	YES	
1338	JUGLANS NIGRA	BLACK WALNUT	12"	STD	YES	
1339	FICUS CARICA	FIG	10",9",9"	MULTI	YES	
1340	FICUS CARICA	FIG	10",9",9"	MULTI	YES	
1341	MALUS DOMESTICA	APPLE	12"	STD	YES	
1342	LIGUSTRUM LUCIDUM	PRIVET	6",4",4"	MULTI	YES	
1343	MALUS DOMESTICA	APPLE	4",4"	MULTI	YES	
1344	LIGUSTRUM LUCIDUM	PRIVET	3",3",3"	MULTI	YES	
1345	LIGUSTRUM LUCIDUM	PRIVET	3",3",4"	MULTI	YES	
1346	JUGLANS REGIA	ENGLISH WALNUT	10"	STD	YES	
1347	MALUS DOMESTICA	APPLE	[]"	STD	YES	
1348	LIGUSTRUM LUCIDUM	PRIVET	7",5"	MULTI	YES	
1349	LIGUSTRUM LUCIDUM	PRIVET	7",6"	MULTI	YES	
1350	LIGUSTRUM LUCIDUM	PRIVET	13"	STD	YES	
1351	JUGLANS REGIA	ENGLISH WALNUT	12"	STD	YES	
1352	JUGLANS REGIA	ENGLISH MALNUT	16"	STD	YES	YES
1353	JUGLANS REGIA	ENGLISH MALNUT	13"	STD	YES	
1354	JUGLANS REGIA	ENGLISH WALNUT	18"	STD	YES	YES
1355	JUGLANS REGIA	ENGLISH MALNUT	18"	STD	YES	YES
1356	LIGUSTRUM LUCIDUM	PRIVET	8"	STD	YES	
1357	PITTOSPORUM TOBIRA	PITTOSPORUM	6".6".4".5"	MULTI	YES	
1358	JUGLANS NIGRA	BLACK WALNUT	9"	STD	YES	
1359	JUGLANS NIGRA	BLACK WALNUT	13",13"13"8"8"	MULTI	YES	YES
1360	LIGUSTRUM LUCIDUM	PRIVET	8"	STD	YES	
1361	JUGLANS NIGRA	BLACK WALNUT	4" 2" 2"	MULTI	YES	YES
1362	MORUS ALBA	MULBERRY	8"	STD	YES	
1363	JUGLANS REGIA	ENGLISH WALNUT	24"	STD	YES	YES
1364	JUGLANS REGIA	ENGLISH WALNUT	27"	STD	YES	YES

TREE #	TREE SPECIES - BOTANICAL NAME	TREE SPECIES - COMMON NAME	SIZE (INCH) DBH @ 48"	STD. OR MULTI. TRUNK	TREE TO BE REM- OVED	HERITAGE TREE
1365	JUGLANS REGIA	ENGLISH WALNUT	24"	STD	YES	YES
1366	PRUNUS DULCIS	ALMOND	24"	MULTI	YES	YES
1367	PINUS PINEA	STONE PINE	19"	STD	YES	YES
1368	PRUNUS DULCIS	ALMOND	13"	STD	YES	
1369	SEQUOIA SEMPERVIRENS	COAST REDWOOD	20"	STD	YES	YES
1370	CITRUS LIMON	LEMON	6"6"	MULTI	YES	
1371	CITRUS LIMON	LEMON	6"7"	MULTI	YES	
1372	CITRUS LIMON	LEMON	6"8"	MULTI	YES	
1373	LIGUSTRUM LUCIDUM	PRIVET	6"6"4"	MULTI	YES	
1374	LIGUSTRUM LUCIDUM	PRIVET	8"	STD	YES	
1375	PERSEA AMERICANA	AVOCADO	6"	STD	YES	
1376	LIQUIDAMBAR STYRACIFLUA	SMEETGUM	17"	STD	NO	YES
1377	LIQUIDAMBAR STYRACIFLUA	SMEETGUM	16"	STD	NO	YES
1378	SEQUOIA SEMPERVIRENS	COAST REDWOOD	44"	STD	NO	YES
1379	SEQUOIA SEMPERVIRENS	COAST REDWOOD	40"	STD	NO	YES
1380	PRUNUS CERASIFERA	PLUM	13"	STD	NO	
1381	EUCALYPTUS POLYANTHEMOS	SILVER DOLLAR EUC.	20"	STD	NO	YES
1382	EUCALYPTUS POLYANTHEMOS	SILVER DOLLAR EUC.	15"	STD	NO	YES
1383	EUCALYPTUS POLYANTHEMOS	SILVER DOLLAR EUC.	17"	STD	NO	YES
1384	LIQUIDAMBAR STYRACIFLUA	SMEETGUM	10"	STD	NO	
1385	LIQUIDAMBAR STYRACIFLUA	SMEETGUM	9"	STD	NO	
1386	PRUNUS CERASIFERA	PLUM	16"	STD	NO	
1387	EUCALYPTUS POLYANTHEMOS	SILVER DOLLAR EUC.	13"	STD	NO	
1388	EUCALYPTUS POLYANTHEMOS	SILVER DOLLAR EUC.	18"	STD	NO	
1389	EUCALYPTUS POLYANTHEMOS	SILVER DOLLAR EUC.	18"	STD	NO	
1390	ZELKOVA SERRATA	ZELKOVA	28"	STD	NO	
1391	CINNOMOMUM CAMPHORA	CAMPHOR	14"	STD	NO	
1392	CINNOMOMUM CAMPHORA	CAMPHOR	17"	STD	NO	
1393	CINNOMOMUM CAMPHORA	CAMPHOR	16"	STD	NO	
1394	CINNOMOMUM CAMPHORA	CAMPHOR	12"11"	MULTI	NO	
1395	JUGLANS REGIA	ENGLISH MALNUT	12"	STD	YES	
1396	JUGLANS NIGRA	BLACK WALNUT	19"	STD	NO	
1397	CINNOMOMUM CAMPHORA	CAMPHOR	15"15"	STD	NO	
1398	CINNOMOMUM CAMPHORA	CAMPHOR	15"	STD	NO	
1399	CINNOMOMUM CAMPHORA	CAMPHOR	15"	STD	NO	
1400	PRUNUS CERASIFERA	PLUM	8"	STD	NO	

TREE PROTECTION MEASURES

EXTRACTION FROM ARBORIST REPORT PG. 10 1998 - 2024 Mortecito Avenue - Tree Inventory, Assessment, and Protection Plan

August 6, 2014

Tree Protection

Tree protection focuses on protecting trees from damage to the roots, trunk, or scaffold branches from heavy equipment (Appendix D).

The tree protection zone (TPZ) is the defined area in which certain activities are prohibited to minimize potential injury to the tree. The TPZ can be determined by a formula based on species tolerance, tree age, and diameter at breast height (DBH) (Matheny, N. and Clark, J. 1998) or as the drip line in some instances. The tree protection zones for this project should simply be located at the tree **drip lines**. Trees that are to be retained should be protected as groups where possible and protection fence should be established at their drip line where possible.

Preventing mechanical damage to the trunks from equipment or hand tools can be accomplished by wrapping them with straw wattle (Figure 2). The wattle will create a porous barrier around the trunks and prevent damage to the bark and vascular tissues underneath. Trees moderately affected and to be retained without root zone exclusion should be wrapped in wattle as an extra

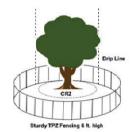


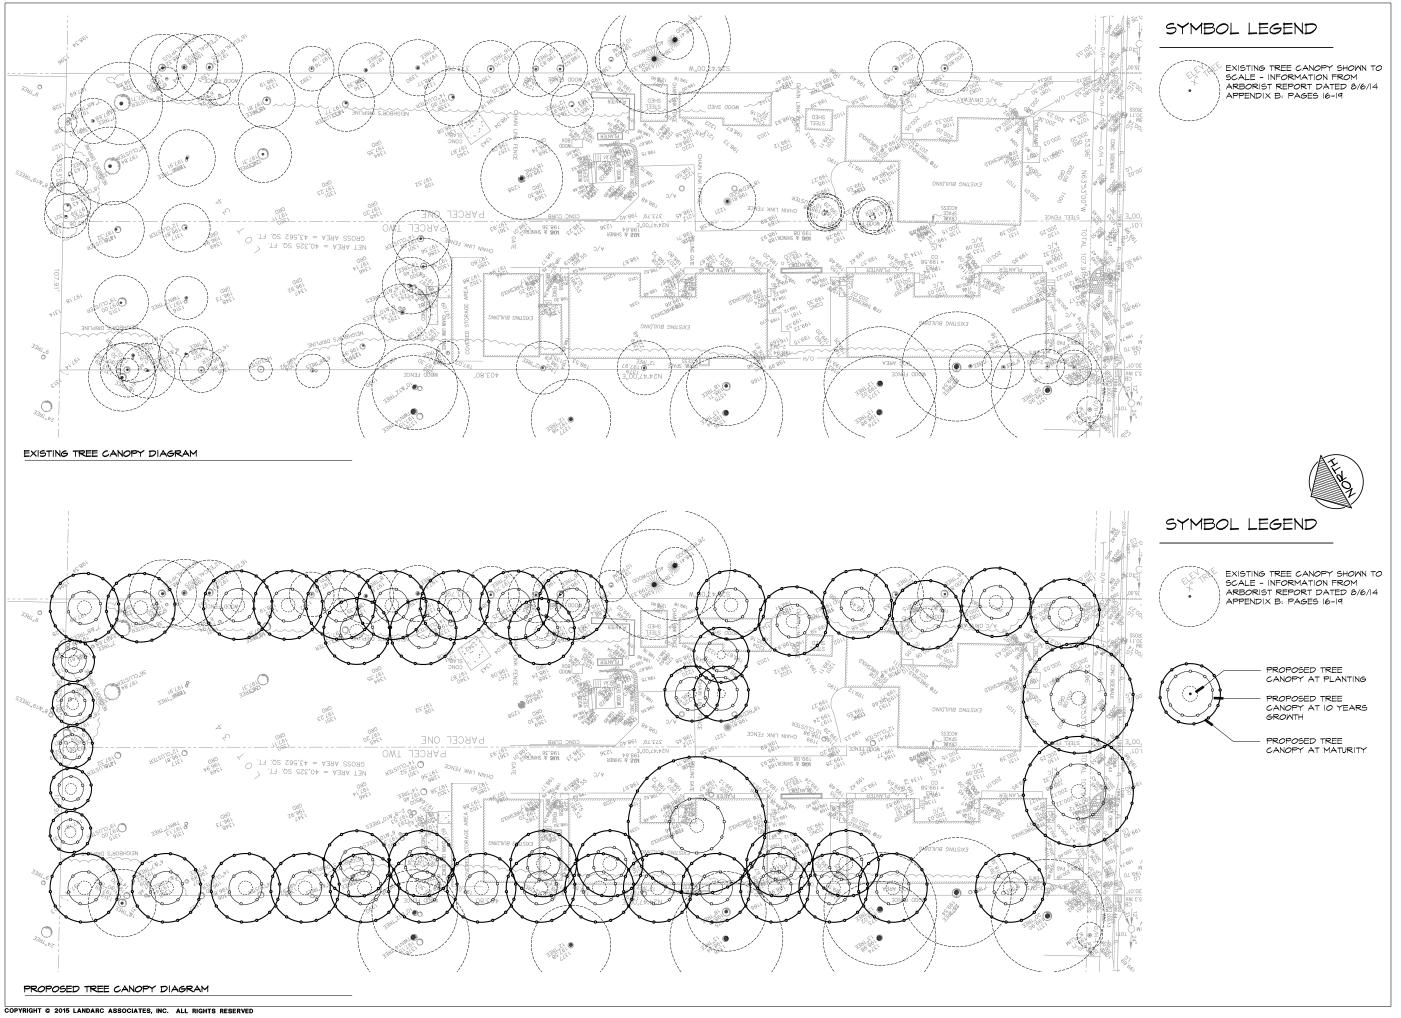


Figure 1: The image above depicts the drip line, CRZ and TPZ.

Figure 2: The image above depicts wrapping the trunk with straw wattle.

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Richard Gessner - Monarch Consulting Arborists LLC - (831) 331-8982 - rick@mionarcharborist.com P.O. Box 1010 Felton, CA 95018





AVE.

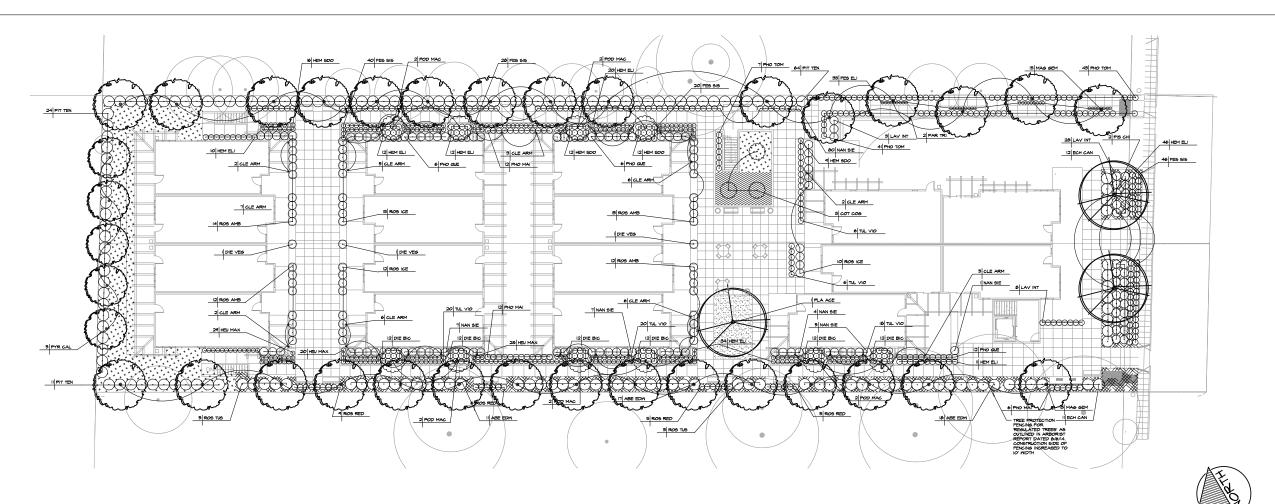
8-2024 MONTECITO A MOUNTAIN VIEW, CALIFORNIA HANFORD CAPITAL INC. 1131 DE ANZA BLVD. SAN JOSE, CA 95129 S C 1998-2024 N

REVISIONS MARK DATE DESCRIPTION - 3.24.15 CITY COMMENTS

DRAWING TITLE TREE CANOPY PLAN

DATE:9/3/14 JOB NUMBER: 1306 DRAWN: SF CHECKED: SF SCALE: 1/16"= 1'-0"

SHEET NUMBER SHEET OF




PLANT LEGEND SUNSET ZONE 15 WULCOLS VALUE REGION I COMMENTS SYMBOL SIZE BOTANICAL NAME COMMON NAME TREES COT COG 15 GAL COTINUS COGGYRIA MAG GEM 24" BOX MAGNOLIA G. 'LITTLE GEM' SMOKE TREE LITTLE GEM MAGNOLIA PLA ACE 24" BOX PLATANUS ACERIFOLIA 'COLUMBIA'
PIS CHI 24" BOX PISTACIA CHINENSIS LONDON PLANE TREE CHINESE PISTACHE POD MAC 24" BOX PODOCARPUS MACROPHYLLUS PYR CAL 24" BOX PYRUS CALLERYANA 'CHANTICLEER' YEM PINE ORNAMENTAL PEAR SHRUBS ABE EDW 5 GAL DIE BIC 5 GAL DIE VEG 5 GAL ECH CAN 5 GAL ABELIA G. 'EDWARD GOUCHER' DIETES BICOLOR DIETES VEGATA GLOSSY ABELIA DWARF CREAM FORTNIGHT LILY
WHITE FORTNIGHT LILY
PRIDE OF MADERA
DAYLILY - PURPLE ECHIUM CANDICANS HEMEROCALLIS 'ELIZABETH PURPLE' HEM ELI 5 GAL HEMEROCALLIS 'STELLA DE ORO' HEUCHERA MAXIMA LAVANDULA X. 'PROVENCE' DAYLILY - ORANGE ISLAND ALUM ROOT PROVENCE LAVENDER HEAVENLY BAMBOO NANDINA D. MONFAR 'SIENNA SUNRISE' NAN SIE 5 GAL PHORMIUM C. 'MAORI MAIDEN' PHORMIUM C. 'MAORI QUEEN' PHO MAI DWARF NEW ZEALAND FLAX DWARF NEW ZEALAND FLAX PHO QUE PHO RUB PHO TOM PITTOSPORUM TENUIFOLIUM 'SILVER SHEEN' NON PITT TEN 5 GAL ROSA FLORIBUNDA 'ICEBERG' ROSA FLOWER CARPET -'AMBER' ROSA X. NOARE -'RED' ROSMARINUS O. 'TUSCAN BLUE' ICEBERG ROSE AMBER GROUNDCOVER ROSE (MONROVIA) ROS RED 5 GAL ROS TUS 5 GAL TUL VIO 5 GAL RED GROUNDCOVER ROSE (MONROVIA)
ROSEMARY SOCIETY GARLIC TULBAGHIA VIOLACEA GRASSES FES ELI 5 GAL FESTUCA GLAUCA 'ELIJAH BLUE' FES SIS 5 GAL FESTUCA GLAUCA 'SISKIYOU BLUE' ELIJAH BLUE FESCUE SISKIYOU BLUE FESCUE VINES CLEMATIS ARMANDI EVERGREEN CLEMATIS CLE ARM 5 GAL PARTHENOCISSUS TRICUSPIDATA BOSTON IVY GROUNDCOVERS 50D MEDALLION VARIETY AVAILABLE FROM PACIFIC SOD 800-692-8690 HYPERICUM CALYCINUM CAMPANULA POSCHARSKYANA SERBIAN BELLFLOWER

PLANT NOTES

- THESE NOTES ARE FOR GENERAL REFERENCE IN CONJUNCTION WITH, AND AS A SUPPLEMENT TO, THE WRITTEN SPECIFICATIONS, DETAILS, ADDENDA AND CHANGE ORDERS ASSOCIATED WITH THE CONTRACT DOCUMENTS.
- 2. CONTRACTOR SHALL COORDINATE ALL WORK WITH OTHER TRADES PRIOR TO INSTALLATION.
- CONTRACTOR SHALL BECOME FAMILIAR WITH THE LOCATION OF ALL EXISTING AND FUTURE UNDERGROUND SERVICES AND IMPROVEMENTS WHICH MAY CONFLICT WITH WORK TO BE DONE. CONTACT UNDERGROUND SERVICE ALERT (DSA) AT (BOO) 227-2600 PRIOR TO DIGGING. NOTIFY OWNER'S REPRESENTATIVE IMMEDIATELY SHOULD CONFLICTS ARISE.
- 4. FINE GRADING, HEADERS AND IRRIGATION COVERAGE SHALL BE APPROVED BY OWNER'S REPRESENTATIVE PRIOR TO PLANTING OPERATIONS.
- 5. CONTRACTOR SHALL LAY OUT PLANT MATERIAL PER PLAN AND FACE TO GIVE BEST APPEARANCE OR RELATION TO ADJACENT PLANTS, STRUCTURES OR VIEWS. CONTRACTOR TO OBTAIN APPROVAL FROM OWNER'S REPRESENTATIVE PRIOR TO INSTALLATION.
- 6. PLANT MATERIAL SHALL NOT BE INSTALLED IN AN AREA WHICH WILL CAUSE HARM TO ADJACENT STRUCTURES OR OBSTRUCT IRRIGATION SPRAY PATTERN. NOTIFY THE OWNER'S REPRESENTATIVE SHOULD CONFLICTS ARISE.
- PRIOR TO PLANTING INSTALLATION, CONTRACTOR SHALL OBTAIN APPROVAL OF PLANT LAYOUT FROM OWNER'S REPRESENTATIVE. PLANT LOCATIONS ARE DIAGRAMMATIC AND MAY BE ADJUSTED IN THE FIELD AT THE OWNER'S REPRESENTATIVE'S REQUEST.
- δ . Contractor shall coordinate plant location to drip tubing location and adjust planting as NECESSARY to achieve Best Result.
- . ALL NON-TURF AREAS SHALL BE MILCHED WITH A MINIMUM 3" LAYER OF BARK MULCH, UNLESS OTHERWISE NOTED, FINISH GRADE OF PLANTING AREAS SHALL BE 3" BELOW ADJACENT PAVING. TAPER 3" DEPTH BARK MULCH TOP DRESSING TO 1/2" BELOW ADJACENT PAVING (I-1/2" DEPTH) MITHIN 2" OF PAVING, CONTRACTOR SHALL SUBMIT A SAMPLE TO THE CITY FOR REVIEW AND APPROVAL PRIOR TO MULCH DELIVERY TO THE SITE. FOR FURTHER INFORMATION, SEE SPECIFICATIONS.
- IO. GROUND COVERS SHALL BE PLANTED EVENLY AND CONTINUOUSLY UNDER TREE AND SHRUB MASSES.
- I. CONTRACTOR SHALL USE A NATURAL PRE-EMERGENT, SUCH AS CORN MEED BLOCKER OR COMPARABLE, AND SHALL APPLY ACCORDING TO THE MANUFACTURER'S DIRECTIONS PRIOR TO APPLYING MULCH.
- 12. ALL NEWLY PLANTED MATERIAL SHALL BE THOROUGHLY SOAKED WITH WATER WITHIN 3 HOURS OF PLANTING.
- 13. THIRTY DAYS AFTER PLANTING, CONTRACTOR SHALL RE-STAKE AND STRAIGHTEN TREES AS NEEDED.
- 14. BENEATH PROPOSED SOD, EXCAVATE EXISTING SOIL TO A DEPTH OF 12" BELOW PROPOSED FINISHED GRADE. REPLACE WITH IMPORTED LOAM SOIL AND BRING TO FINISHED GRADE.
- 15. THE CONTRACTOR SHALL PROVIDE FOR IN THEIR BID FOR A BASE AMENDMENT FOR SOIL AMENDMENT. AFTER ROUGH GRADING OF THE SITE A SOIL NUTRIENT TEST WILL BE CONDUCTED OF VARIOUS PLANTED AREAS AND TH PLANTER AREAS SHALL BE AMENDED BASED ON THIS SOILS REPORT.

IRRIGATION MEANS AND METHODS

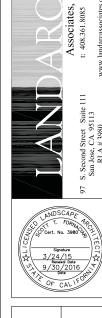ALL MEANS AND METHODS OF IRRIGATION FOR THE LANDSCAPE IMPROVMENTS SHALL FOLLOW THE STATE OF CALIFORNIA MODEL WATER EFFICIENT LANDSCAPE ORDINANCE



98-2024 MONTECITO AVE MOUNTAIN VIEW, CALIFORNIA
HANFORD CAPITAL INC.
1131 DE ANZA BLVD.
SAN JOSE, CA 95129

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REVIS	SIONS	
MARK	DATE	DESCRIPTION
- 1	10.17.14	CITY COMMENTS
-	2.12.15	CITY COMMENTS
-	9.24.15	CITY COMMENTS

DRAWING TITLE
PLANTING PLAN

DATE:9/3/14

JOB NUMBER: 1306

DRAWN: SF CHECKED: SI

SCALE: 1/16"=1'-0"

L2.1

BARK MULCH - 3" COVER IN ALL PLANTERS NOT PLANTED AND FILLED IN AROUND ALL PLANTS, TYPICAL.



ORNAMENTAL PEAR - CHANTICLEER



MAGNOLIA - LITTLE GEM



LONDON PLANE TREE



YEW PINE

☐ ON SITE TREES



CHINESE PISTACHE

☐ STREET TREES



ABELIA - EDWARD GOUCHER



FORTNIGHT LILY



PRIDE OF MADERA



DAYLILY - PURPLE



DAYLILY - ORANGE



ISLAND ALUM ROOT



LAVENDER - PROVENCE



ROSEMARY - TUSCAN BLUE





NANDINA - SIENNA SUNRISE NEW ZEALAND FLAX - MAORI QUEEN NEW ZEALAND FLAX RED





NEW ZEALAND FLAX - TOM THUMB



PITTOSPORUM - SILVER SHEEN

AVE.

HANFORD CAPITAL INC. 1131 DE ANZA BLVD. SAN JOSE, CA 95129 1998-2024 MONTECITO MOUNTAIN VIEW, CALIFORNIA

MARK DATE - 2.12.15 CITY RESUBMITTAL

DRAWING TITLE LANDSCAPE MATERIALS

DATE:9/3/14 DRAWN: SF CHECKED: SF SCALE: NTS

SHEET NUMBER SHEET OF

HYDROZONE LEGEND

ZONE I SOD AREA TOTAL = 315 SF



ZONE 2 PLANTER SPRAY AREA TOTAL = 1,520 SF

ZONE 3 PLANTER DRIP AREA TOTAL = 6,833 SF



1998-2024 MONTECITO MOUNTAIN VIEW, CALIFORNIA

AVE.

OWNER:

HANFORD CAPITAL INC.
1131 DE ANZA BLVD.
SAN JOSE, CA 95129

REVISIONS
MARK DATE DESCRIPTION
1 9.24/15 CITY COMMENTS

DRAWING TITLE

HYDROZONE PLAN

DATE:9/3/14

JOB NUMBER: 1306

DRAWN: SF CHECKED: SF
SCALE: 1":20'-0"

SHEET NUMBER

L3.1

SHEET OF

