City of Mountain View Planning Department 500 Castro Street Mountain View, CA 94041

Re: Gatekeeper Application

Submission Date - October 21, 2016

Applicant & Property Owner:

SWENSON

Cole Strombom – Development Manager – Cole@Swenson.com – 408.938.6398 Cameron Schwab – Development Manager – Cam@Swenson.com – 408.938.6395 777 N First Street, 5th Floor San Jose, CA 95112

Property Address:

1025 Terra Bella Ave, Mountain View

Project Description:

Given the current City of Mt View (and greater Bay Area) demand for housing, SWENSON has designed an efficient higher density residential development in the Terra Bella neighborhood. As seen in the attachments, the design is comprised of a 3-level podium with a 13-story residential mid-rise (234 units) along the Terra Bella Ave side of the property (max height: 164'); then stepping down to 20 two-story townhomes surrounding an amenity deck on the south side of the property.

The zoning and general plan are both industrial. SWENSON realizes that residential does not conform to current zoning and general plan and is open to recommendations from City staff moving forward. Given the immediate surrounding uses and proximity to the 85/101 highway interchange, SWENSON has designed the mid-rise to maximize the density, while still meeting the parking requirements set forth by the City of Mountain View. The purpose of the height step-down from 164' (top of the mid-rise) to 52' (top of the townhomes) is to reduce the visual impact from the single family residential homes at the southern end of the street from this proposed development. With this in mind, SWENSON has an "alternate site plan" attached as well if the community and council would prefer to see a higher density of residential units on the site. The alternate site plan consists of 2 mid-rise towers, but in this plan the southern mid-rise steps down by 7 stories to accomplish the same goal.

In addition, SWENSON understands that local neighborhood beautification efforts, streetscape improvements, traffic mitigation measures, etc. will be important in ensuring the success of higher intensity residential in this location.

Sincerely,


Cole Strombom


Attachments: Site Plan & 3D Model

Alternative Site Plan & 3D Model

CC: Randy Tsuda – Randy.Tsuda@mountainview.gov

Terry Blount - Terry.Blount@mountainview.gov

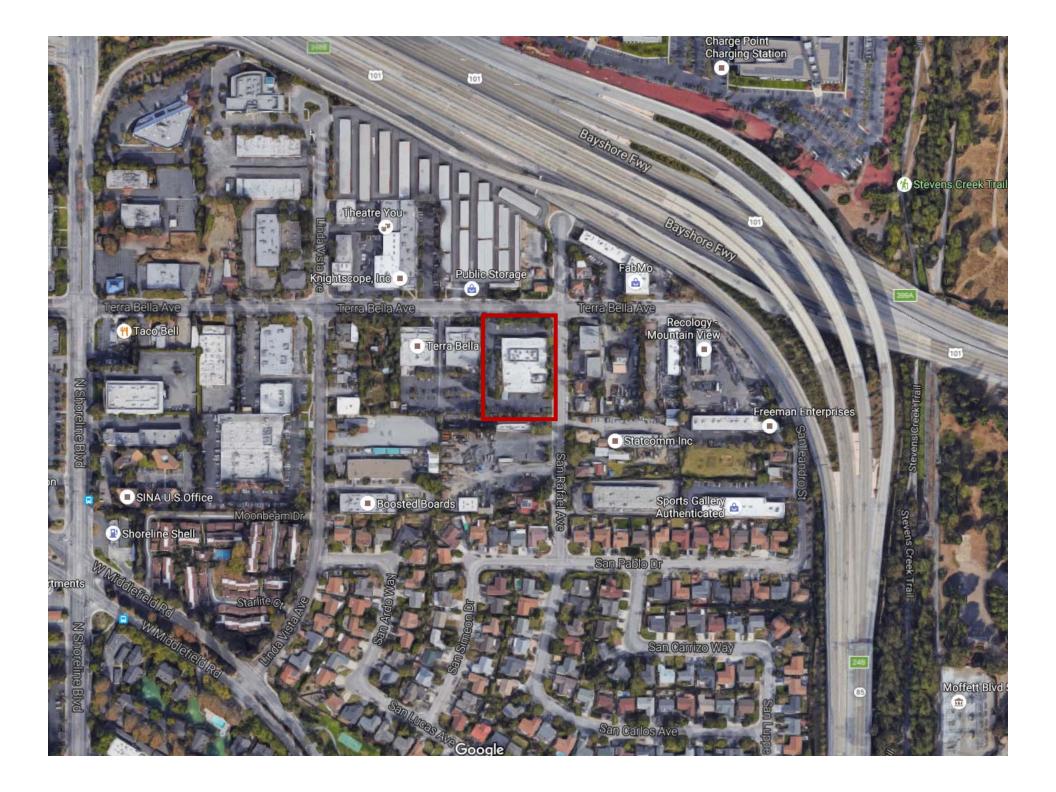

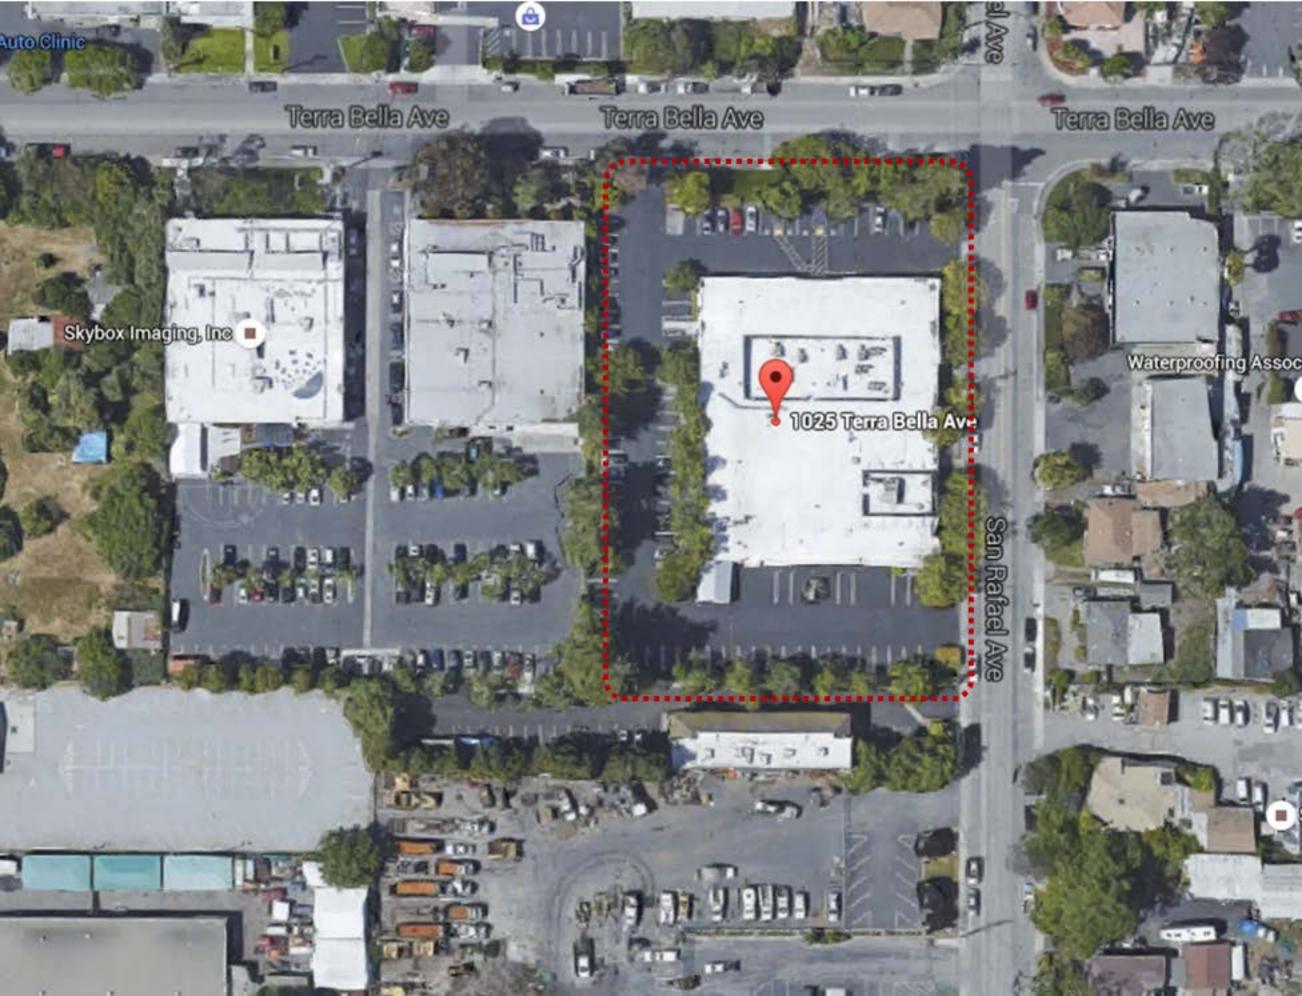

16 STORY TOWER (164'-0" HEIGHT ABOVE GRADE)
-234 RESIDENTIAL UNITS (18 UNITS PER FLOOR X 13 FLOORS)
-252,135 G.S.F.


-903 AVE. UNIT S.F.

19 TWO-STORY TOWNHOMES ON 4TH FLOOR PODIUM (52'-0" HEIGHT ABOVE GRADE)


-28,428 G.S.F.

-1,461 AVE. S.F.


4TH FLOOR AMENITIES DECK (32'-0" HEIGHT ABOVE GRADE) -31,975 TOTAL S.F.

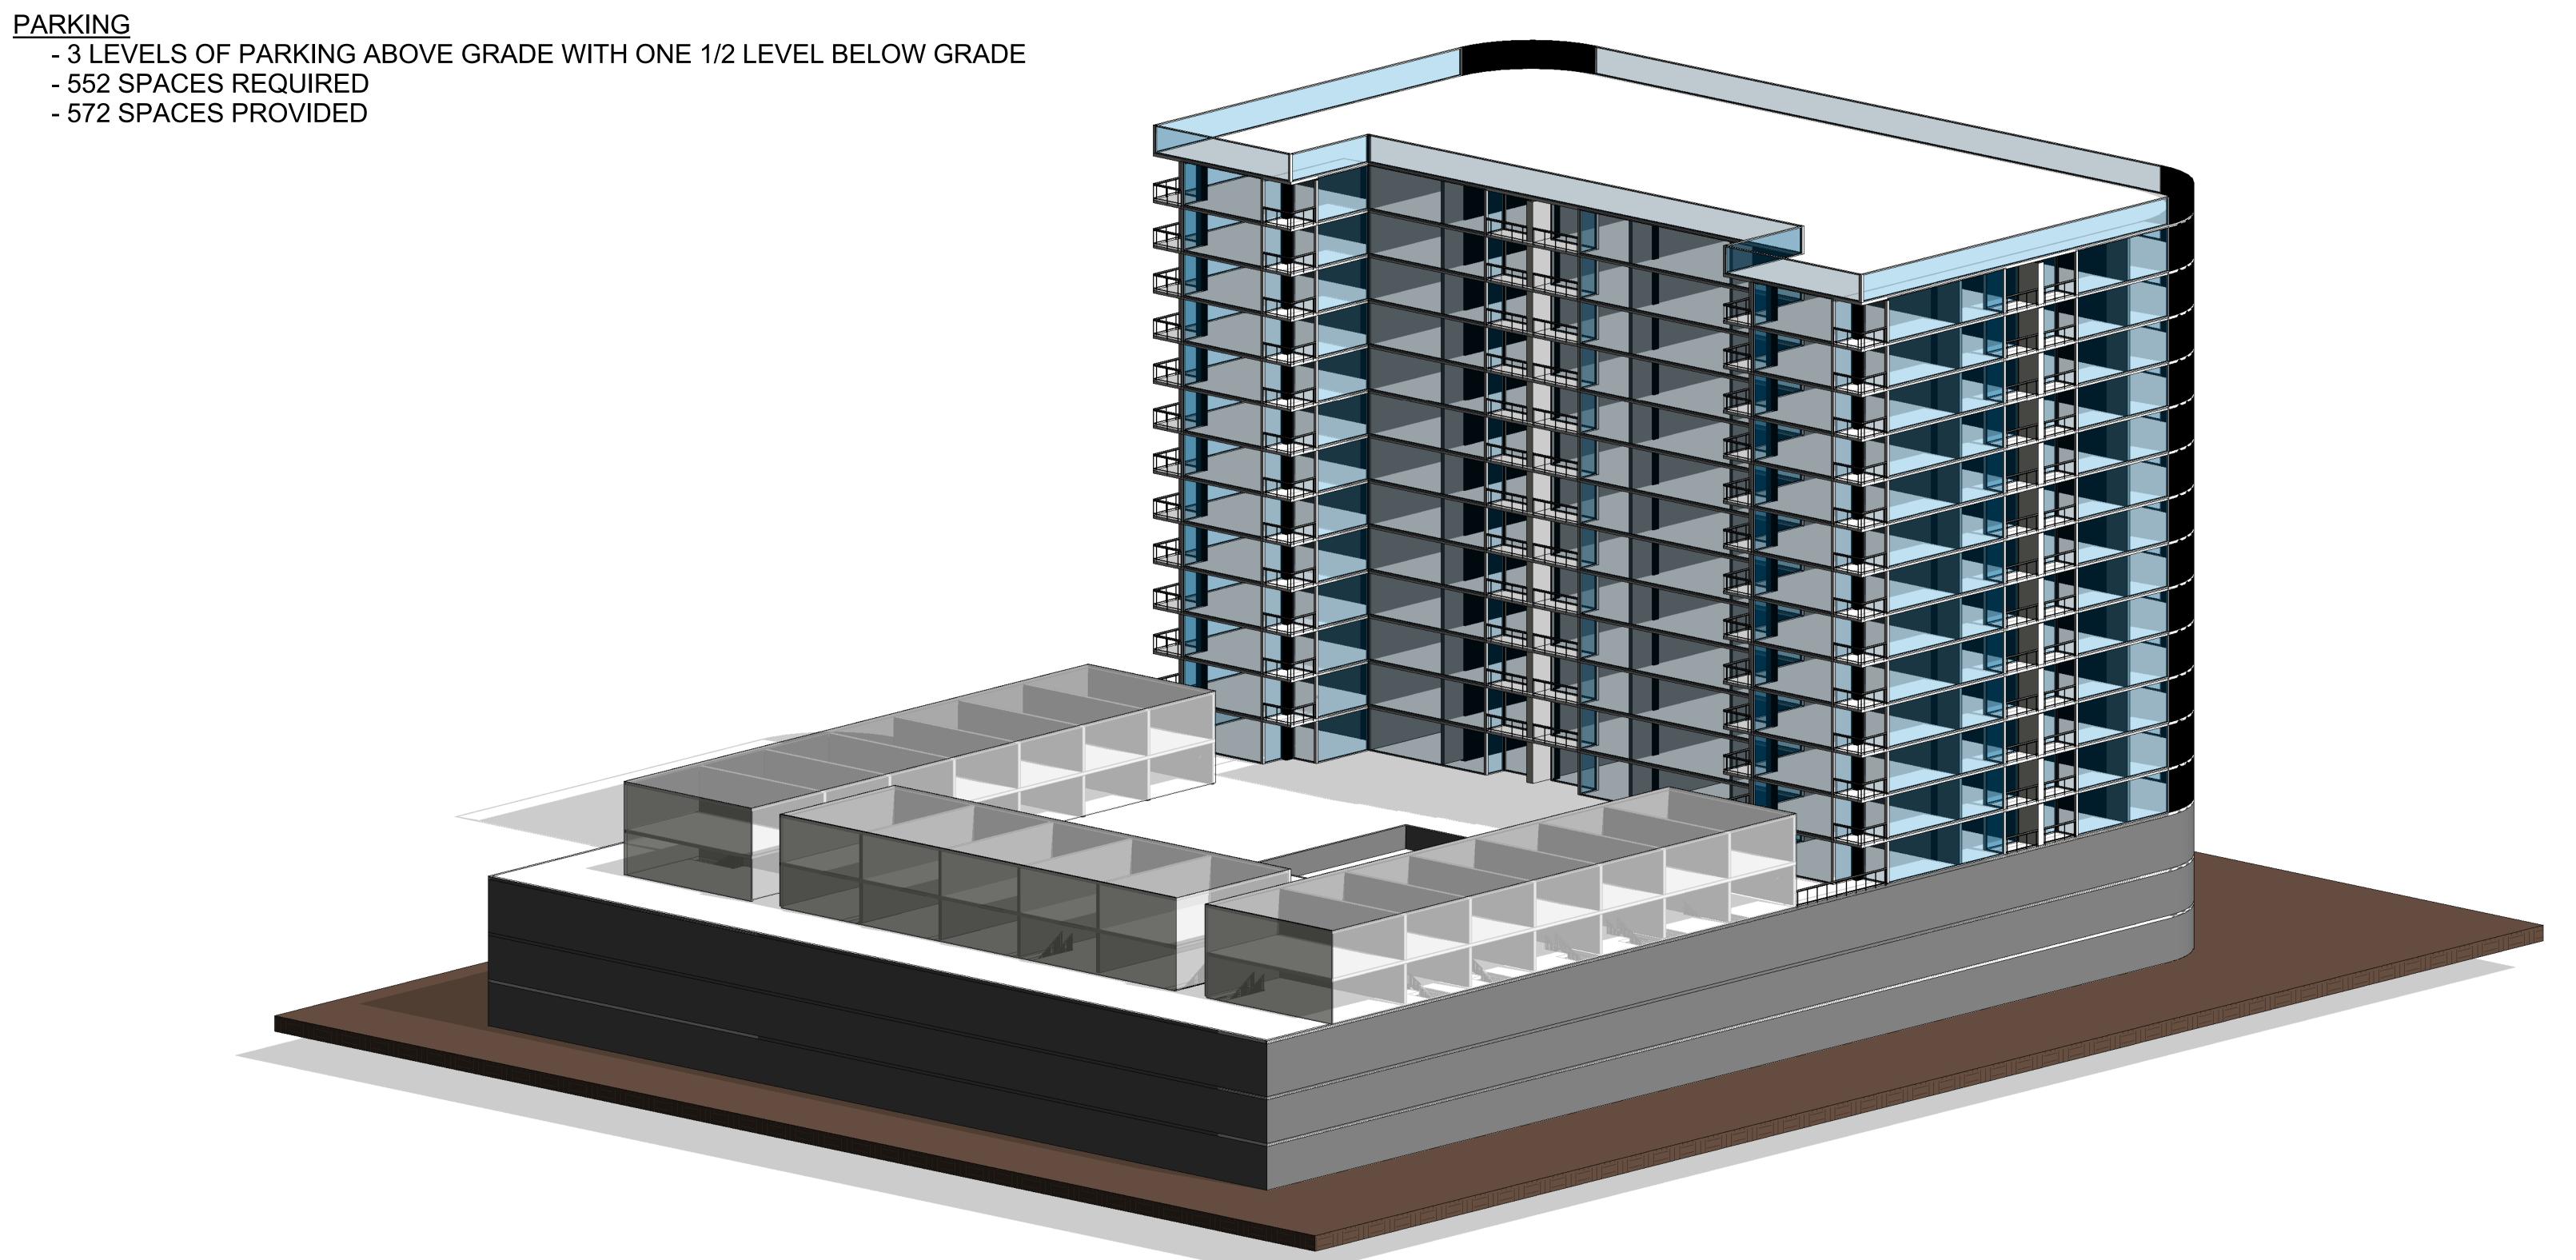


1 PERSPECTIVE VIEW

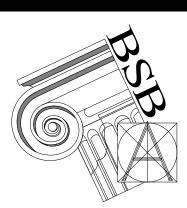

COPYRIGHT © 2014

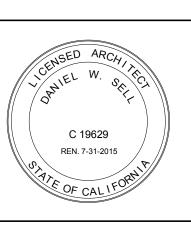

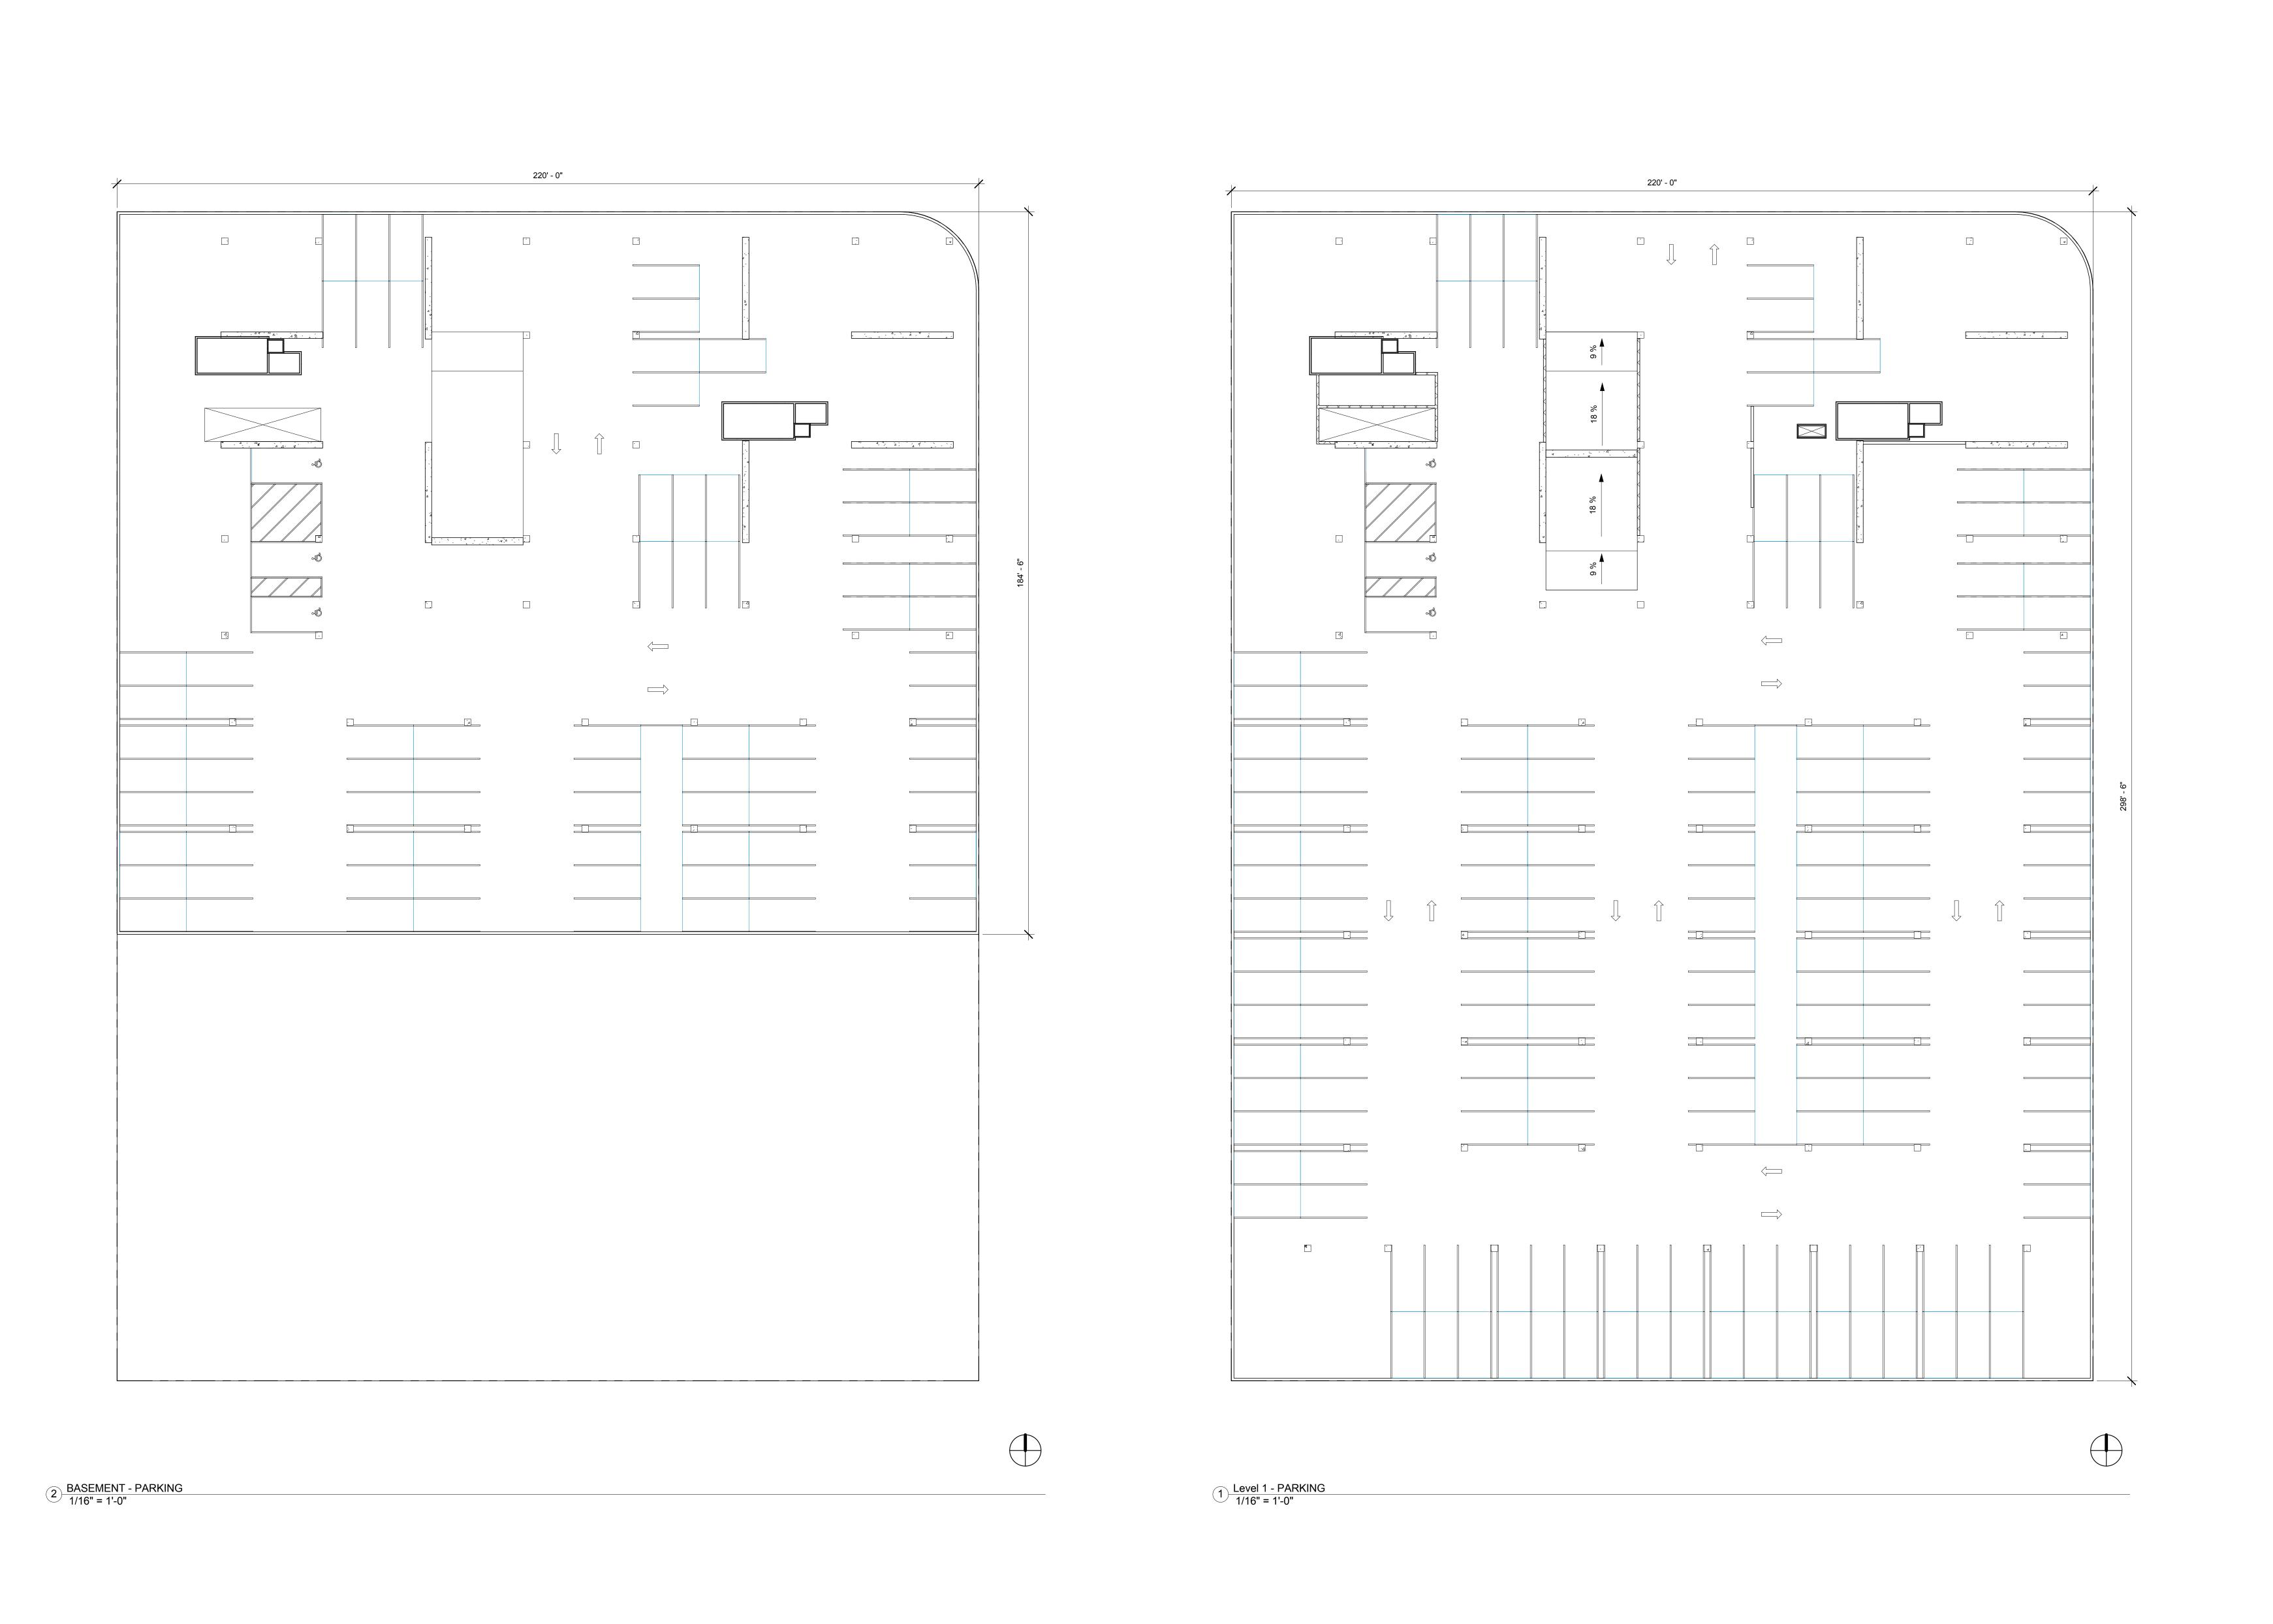


BARRY SWENSON BUILDER A DIVISION OF GREEN VALLEY CORP. 777 North First Street Fifth Floor San Jose, Ca 95112 tel: (408) 287-0246 fax: (408) 998-1737

Consultant:

Revision Schedule

Description Date

COPYRIGHT © 2014 BARRY SWENSON BUILDER

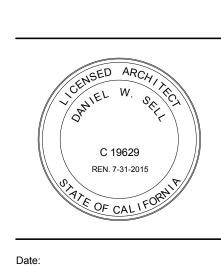


OCTOBER, 2016

Drawn by: Job #:

13-9170

Sheet

A102

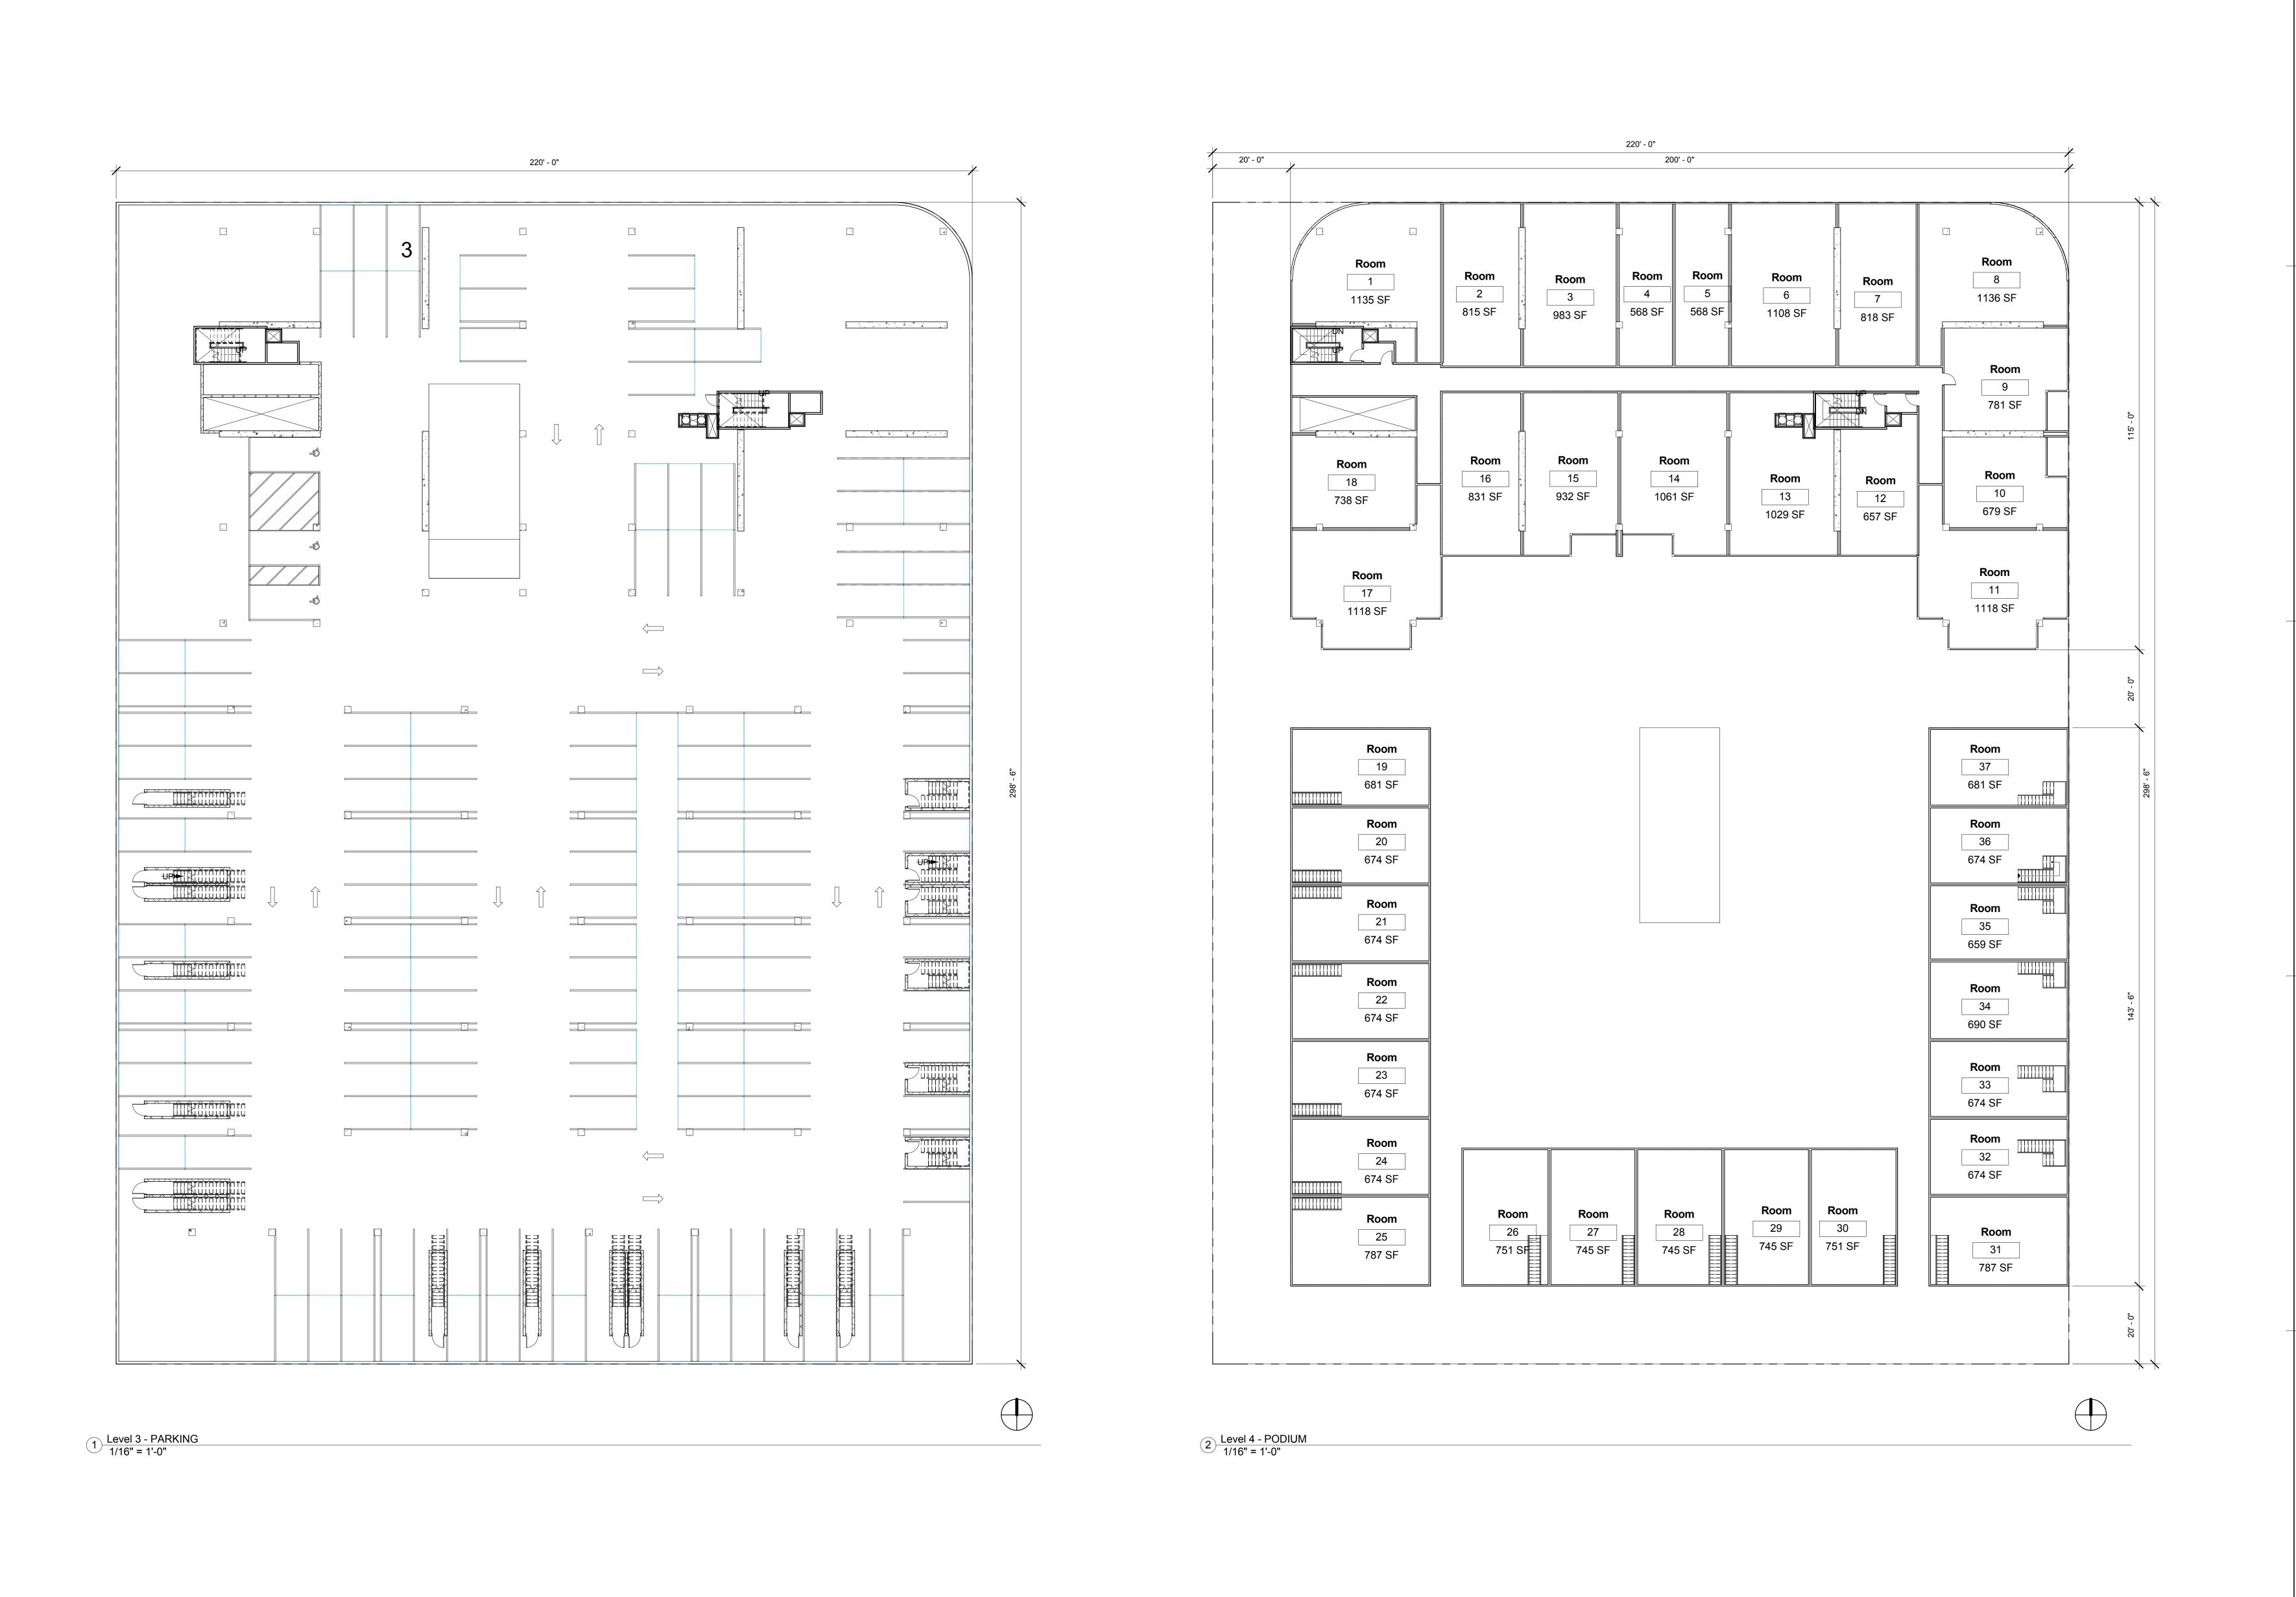

BARRY SWENSON BUILDER A DIVISION OF GREEN VALLEY CORP. 777 North First Street Fifth Floor San Jose, Ca 95112 tel: (408) 287-0246 fax: (408) 998-1737

Consultant:

Revision Schedule

Description

COPYRIGHT © 2014 BARRY SWENSON BUILDER

3RD & TERR



OCTOBER, 2016

Job #: 13-9170

A103

APPN: 1925 TERRIA DELLA AVE MOUNTAIN NEWLOOD STITE AREA (G.S.F.): 1025 TERRIA DELLA AVE MOUNTAIN NEWLOOD STITE AREA (G.S.F.): 1525 TERRIA DELLA AVE MOUNTAIN NEWLOOD STITE AREA (G.S.F.): 1525 TERRIA DELLA AVE MOUNTAIN NEWLOOD STITE AREA (G.S.F.): 1525 TERRIA DELLA AVE MOUNTAIN NEWLOOD STITE AREA (G.S.F.): 1525 TERRIA DELLA AVE MOUNTAIN NEWLOOD STITE AREA (G.S.F.): 1525 TERRIA DELLA AVE MOUNTAIN NEWLOOD STITE AREA (G.S.F.): 1525 TERRIA DELLA AVE MOUNTAIN NEWLOOD STITE AREA (G.S.F.): 1525 TERRIA DELLA AVE MOUNTAIN NEWLOOD STITE AREA (G.S.F.): 1525 TERRIA DELLA MOUNTAIN NEWLOOD STITE ARE	PROJECT DATA					
ADDRESS 1025 TREAR BELLA AVE MOUNTAIN NEV CA	1025 TERRA BELLA					
SITE AREA (G.S.F.): ORGOS STIF AREA (G.S.F.): LOT COVERAGE SORGOS STIF AREA (G.S.F.): LOT COVERAGE SORGOS STIF AREA (G.S.F.): SORGOS STIF AREA (G.S.F.): MM GENERAL INDUSTRIA SORGOS STIF AREA OF IMPROVEMENTS: GROSS DATA 6SF LEVELS LEVELS TOTAL CS RADAM 1 1 4025 GROSS DATA 6SF LEVELS TOTAL CS RADAM 1 1 1 4025 GROPE THAN (LIVEL) TOTAL (LIVEL) THAN (LIVEL) THA						153.17.050
GROSS STITE AREA (ACRES) 1.5 1.5 1				10	25 TERRA BELLA AVE	
IOT COPERAGE IOT CONTINGE IOT	• •					
STREACK REG. FRONT SIDE 0'-25' FROM RL PARKET REGISTRACK R						
SETBACK REQ. FRONT SIDE 0'-25' FROM RL	ZONING:				MM	-GENERAL INDUSTRIAL
SETBACK PROPOSED O' O' O' O' O' O' O' O	GENERAL PLAN:2040				MM	-GENERAL INDUSTRIAL
TOTAL 55, SITE AREA OF IMPROVEMENTS:	SETBACK REQ.					
GROSS DATA		1.	0'	0'		
ASSESSIBENTIAL DATA (TOWNHOUSE) 10		VIEN 15:				65,584
BASEMENT LEVEL	GROSS DATA					
BASEMENT LEVEL 40,251 1 40,050			GSF		LEVELS	TOTAL GSF
TYP. FLOOR PLAN (TOWER) 19.395 14,214 1 1421 TOTAL GSF RESIDENTIAL DATA (TOWER) STUDIO 568 679-983 1.135 THE FLOOR 2 10 6 113 THE FLOOR 3 10 6 1	BASEMENT LEVEL		40,251			40251
STH FLOOR PLAN (TOWNHOUSE)	GRADE-4TH LEVEL				4	262336
TOTAL GSF RESIDENTIAL DATA (TOWER) 1/1+DEN 2/2 UNIT 1108-	TYP. FLOOR PLAN (TOWER)		19,395		12	232740
RESIDENTIAL DATA (TOWER) 1/1+DEN	5TH FLOOR PLAN (TOWNHOUSE)		14,214		1	14214
NUMITOTALSS. STUDIO 568 679-983 1135 1135 11	TOTAL GSF					549,541
NUMITOTALSS. STUDIO 568 679-983 1135 1135 11	RESIDENTIAL DATA (T	OWFR)				TOTAL
UNIT TOTAL SF. STUDIO 568 679-983 1135 4TH FLOOR 2 10 6 11 5TH FLOOR 2 10 6 11 11 110 6 11 11 110 6 11 110 6 11 110		T	1/1+DEN	2/2 LINIT 1100	1	TOTAL
### FLOOR			-	·		
STHELOOR	UNIT TOTAL SF.	STUDIO 568	679-983	1135		
### FILOR ### FI	4TH FLOOR	2	10	6		18
TITH FLOOR	5TH FLOOR	2	10	6		18
## FILOR ##	6TH FLOOR					18
9TH FLOOR 2 10 6 11 10TH FLOOR 2 10 6 11 11TH FLOOR	7TH FLOOR					18
10TH FLOOR 2						18
11TH FLOOR						
12TH FLOOR 2 10 6 11 13TH FLOOR 2 10 6 11 13UBTOTAL 26 130 78 234 13UBTOTAL 26 130 78 234 13UBTOTAL 27 27 27 27 27 27 27 2						
13TH FLOOR 2						18
14TH FLOOR 2		ļ				18
16TH FLOOR 2	14TH FLOOR					18
SUBTOTAL 26	15 TH FLOOR	2	10	6		18
TOTAL	16TH FLOOR	2	10	6		18
TOTAL SUBTOTAL DATA (TOWNHOUSE) TOTAL	SUBTOTAL	26	130	78		234
2/2.5 UNIT 1348-1574	TOTAL					234
2/2.5 UNIT 1348-1574		*		₽	8	l .
2/2.5 UNIT 1348-1574						
UNIT TOTAL 1348-1574	RESIDENTIAL DATA (T	OWNHOUSE)				TOTAL
UNIT TOTAL 1348-1574		2/2.5 UNIT				
19		1				
TOTAL 19 19 19 19 19 19 19 1	UNII IOIAL	1540 1574				
TOTAL PARKING REQUIRED: RESIDENTIAL STUDIO	4TH FLOOR	19				19
TOTAL PARKING REQUIRED: RESIDENTIAL STUDIO	SURTOTAL	19				19
TOTAL PARKING REQUIRED: RESIDENTIAL STUDIO		15				40
STUDIO	IOIAL					19
STUDIO						
STUDIO	TOTAL PARKING REOL	IIRED. BECIDEN	ΙΤΙΔΙ			
PARKING RATIO SQ. 1.5 2 2 2 2 2 3 3 480 480 TOTAL FARRING REQU			- 1-		ı
SUBTOTAL GUEST PARKING TOTAL TOTAL S52 TOTAL PARKING PROVIDED: RESIDENTIAL ADA PARKING BASEMENT SINGLE SINGLE SINGLE SINGLE SINGLE TANDEM BASEMENT 3 29 25 57 111 2ND Floor 3 55 57 111 3RD Floor 3 53 45 100 TOTAL 12 192 184 388 TOTAL PKG PROVIDED: SINGLE SINGLE TANDEM 192 193 TOTAL TOTAL 192 193 TOTAL TOTA			•			
TOTAL TOTAL TOTAL TOTAL TOTAL TOTAL TOTAL TOTAL PARKING PROVIDED: RESIDENTIAL TANDEM	PARKING RATIO SQ.					
TOTAL TOTAL TOTAL PARKING PROVIDED: RESIDENTIAL ADA PARKING SINGLE TANDEM	SUBTOTAL	26	260	156	38	480
TOTAL 552 TOTAL PARKING PROVIDED: RESIDENTIAL ADA PARKING SINGLE TANDEM BASEMENT 3 29 25 55 57 11: 2ND Floor 3 55 57 11: 38D Floor 3 53 45 10: 10: <	GUEST PARKING		1!	5%		72
TOTAL PARKING PROVIDED: RESIDENTIAL ADA PARKING SINGLE TANDEM		 				
ADA PARKING SINGLE TANDEM BASEMENT 3 29 25 55 First Floor 3 55 57 11: 2ND Floor 3 55 57 11: 2ND Floor 3 55 57 11: 3RD Floor 3 53 45 10: TOTAL 12 192 184 388 TOTAL PKG PROVIDED: SINGLE (8'-6"x18") 192 192 194 195 COMPACT (8'x16') 0 0 0 0 0 0 0 0 0 0 0 0 0 0 0 0 0 0 0		ADED: DECIDEN	ITIAI			<u> </u>
BASEMENT 3 29 25 55 First Floor 3 55 57 11! 2ND Floor 3 55 57 11! 3RD Floor 3 57 57 57 11! 3RD	TOTAL PARKING PRO	VIDED: KESIDEN				
First Floor 3 55 57 11! 2ND Floor 3 55 57 11! 3RD Floor 3 55 57 11! 3RD Floor 3 53 45 10: TOTAL 12 192 184 388 TOTAL PKG PROVIDED: SINGLE (8'-6"x18") 192 192 193 COMPACT (8'x16") 0 0 0 TANDOM (8'-6"'x18") 184 366 HC (18'x 9") 12 12 13:		ADA PARKING	SINGLE	TANDEM		
2ND Floor 3 55 57 11: 3RD Floor 3 53 45 10: TOTAL 12 192 184 388 TOTAL PKG PROVIDED: SINGLE (8'-6"x18") 192 COMPACT (8'x16") 0 0 TANDOM (8'-6"x18") 184 366 HC (18'x 9") 12 1:	BASEMENT	3	29	25		57
3RD Floor 3 53 45 100 TOTAL 12 192 184 388 TOTAL PKG PROVIDED: SINGLE (8'-6"x18') 192 192 193 COMPACT (8'x16') 0 0 0 TANDOM (8'-6"x18') 184 366 HC (18'x 9') 12 12 13	First Floor					115
TOTAL 12 192 184 388 TOTAL PKG PROVIDED: SINGLE (8'-6"x18') 192 193 COMPACT (8'x16') 0 0 0 TANDOM (8'-6"x18') 184 366 HC (18'x9') 12 13	2ND Floor					115
TOTAL PKG PROVIDED: SINGLE (8'-6"x18") 192 19: COMPACT (8'x16") 0 (7 TANDOM (8'-6"x18") 184 36: HC (18'x9") 12 1:		3	53	45		101
SINGLE (8'-6"x18") 192 193 COMPACT (8'x16') 0 0 TANDOM (8'-6"x18') 184 366 HC (18'x 9') 12 1.3	TOTAL	12	192	184		388
SINGLE (8'-6"x18") 192 193 COMPACT (8'x16') 0 0 TANDOM (8'-6"x18') 184 366 HC (18'x 9') 12 1.3	TOTAL PKG PROVIDED:			•	-	
COMPACT (8'x16') 0 TANDOM (8'-6"'x18') 184 HC (18'x 9') 12 12 1.3		 	1	92		102
TANDOM (8'-6"'x18') 184 36(HC (18'x 9') 12 13		 				192
HC (18'x 9') 12 13	TANDOM (8'-6"'x18')	<u> </u>				368
		İ				12
	SUBTOTAL					572

OPTION 2
NORTH TOWER


18 UNITS/FLOOR X 13 FLOORS = 234 UNITS
234 X 2 = 468 PARKING

SOUTH TOWER

18 UNITS/FLOOR X 6 FLOORS = 108 UNITS

108 X 2 = 216 PARKING

468 + 216 = 684 PARKING FOR UNITS 684 X 15% = 103 PARKING FOR GUESTS 506 + 76 = <u>787 TOTAL PARKING</u>

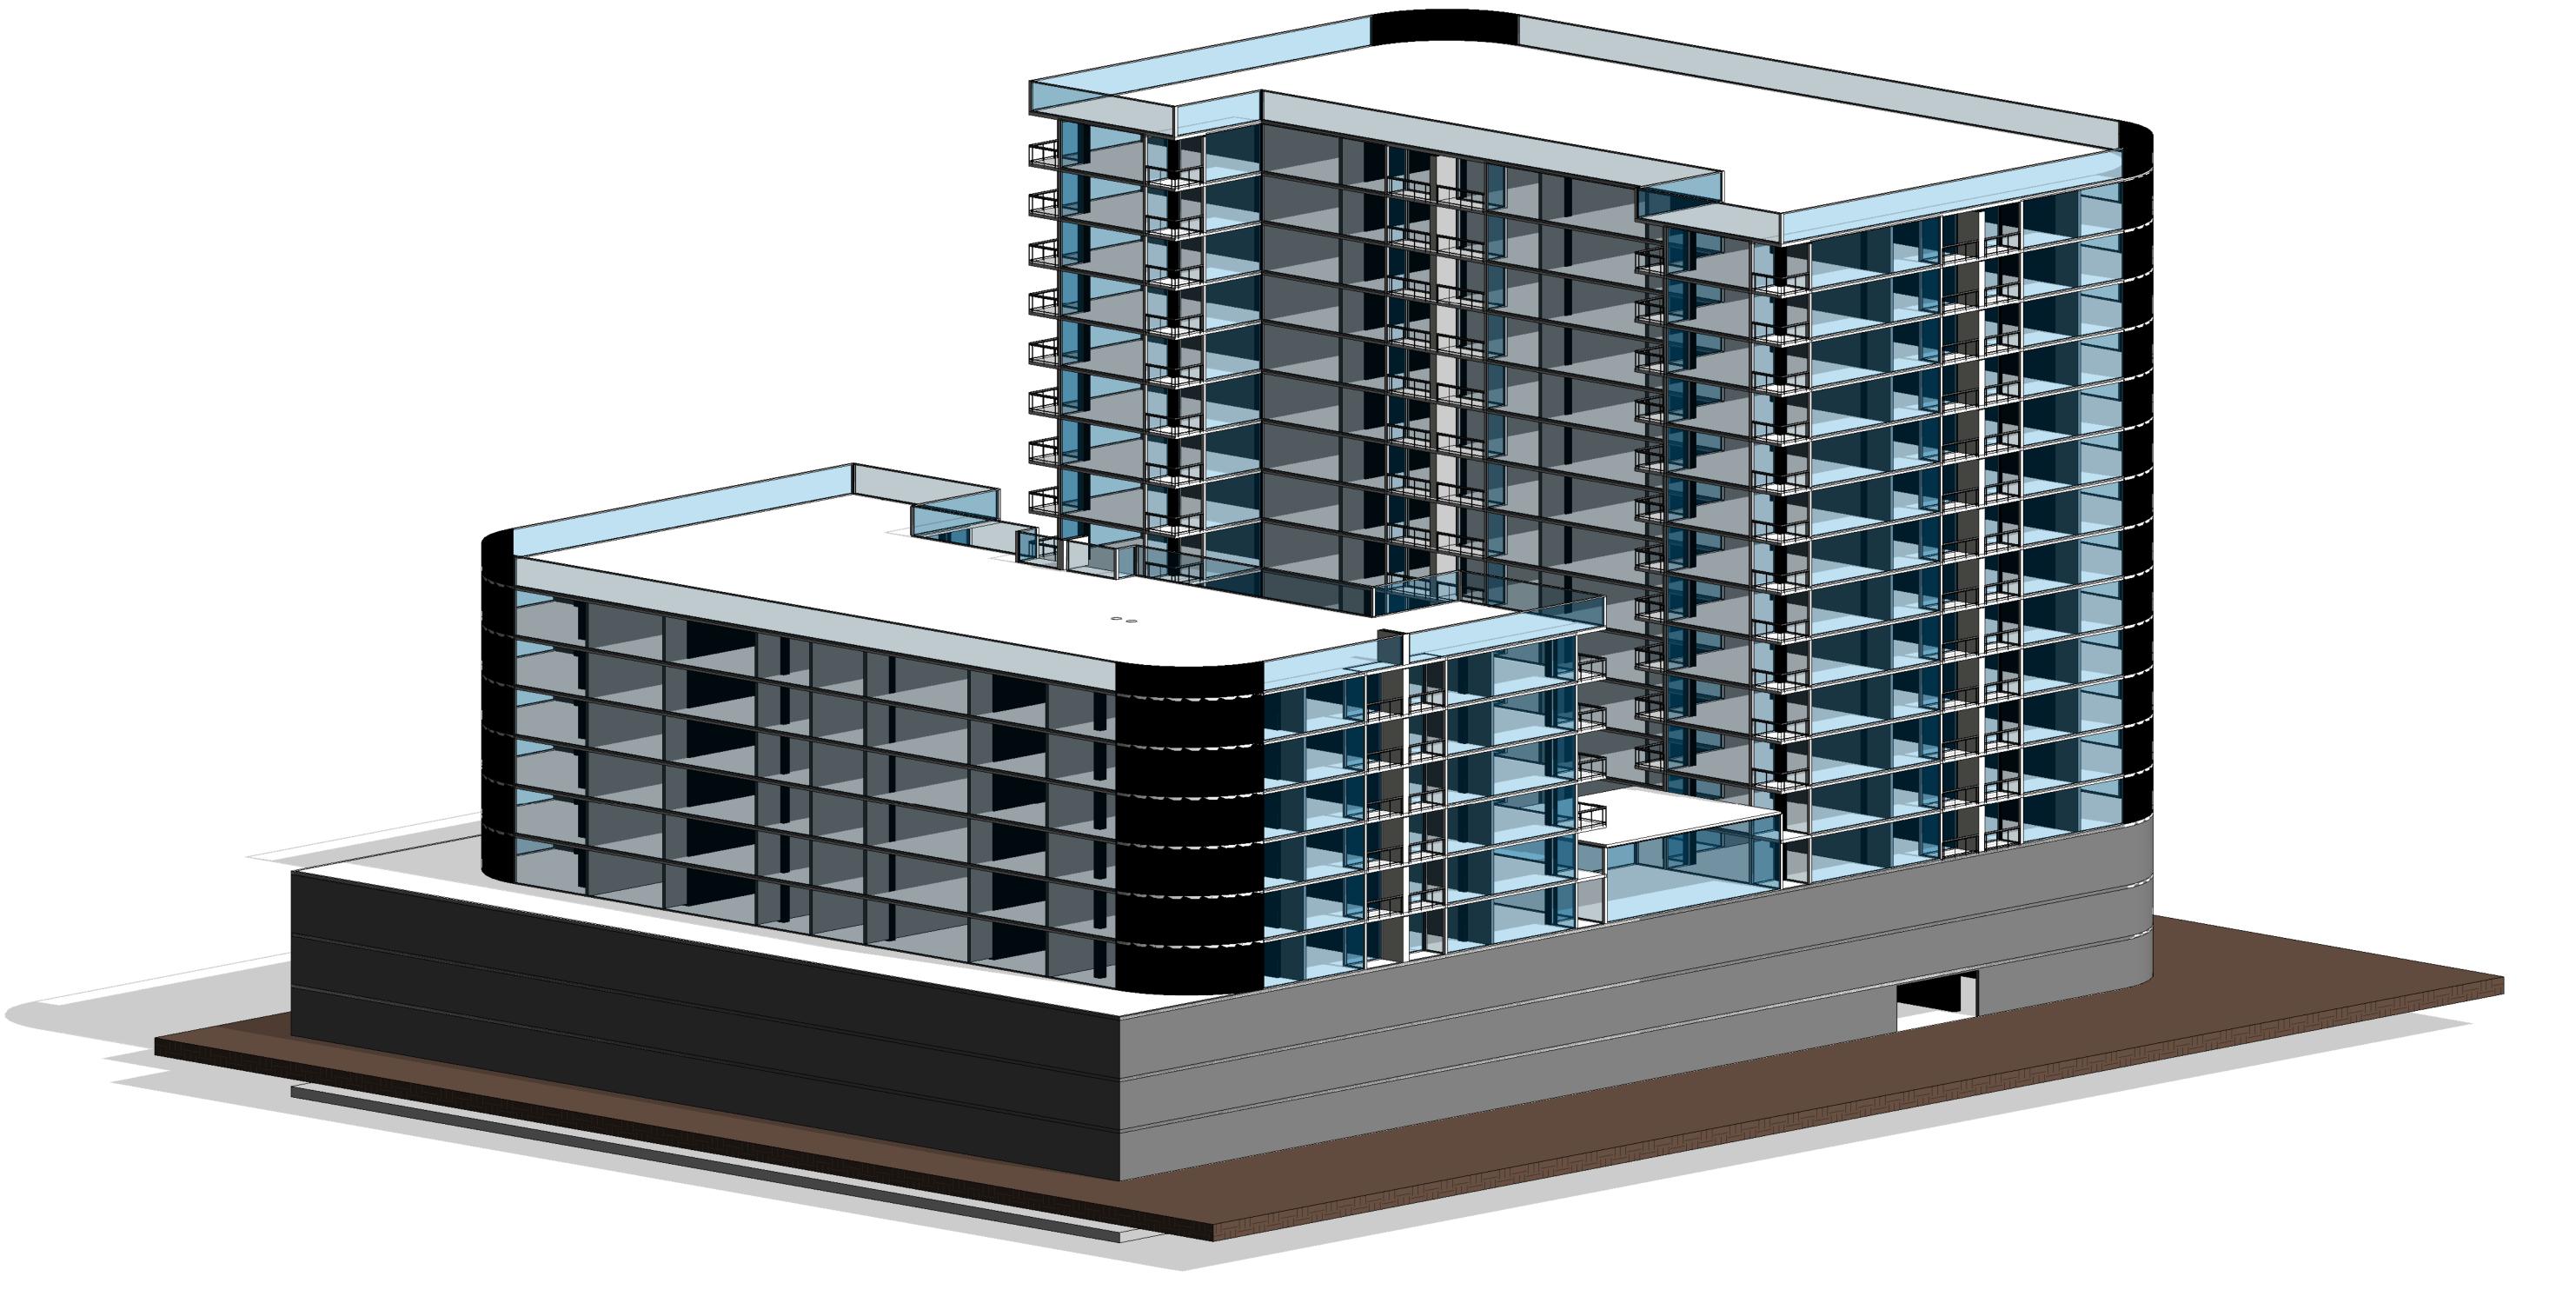

BARRY SWENSON BUILDE A DIVISION OF GREEN VALLEY COR

777 North First Street Fifth Floor San Jose, Ca 95112 tel: (408) 287-0246 fax: (408) 998-1737


Consultant:

Revision Schedule

Description Date

COPYRIGHT © 2014 BARRY SWENSON BUILDER

> APN: 153.17.050 1025 TERRA BELLA AVE. MT. VIEW, CA 94043

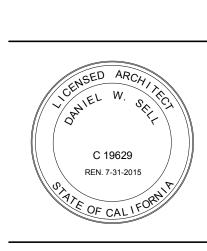


Date:
OCTOBER, 2016
Scale:

Drawn by:

Job #: 13-9170

A104

1 PERSPECTIVE - OPTION 2

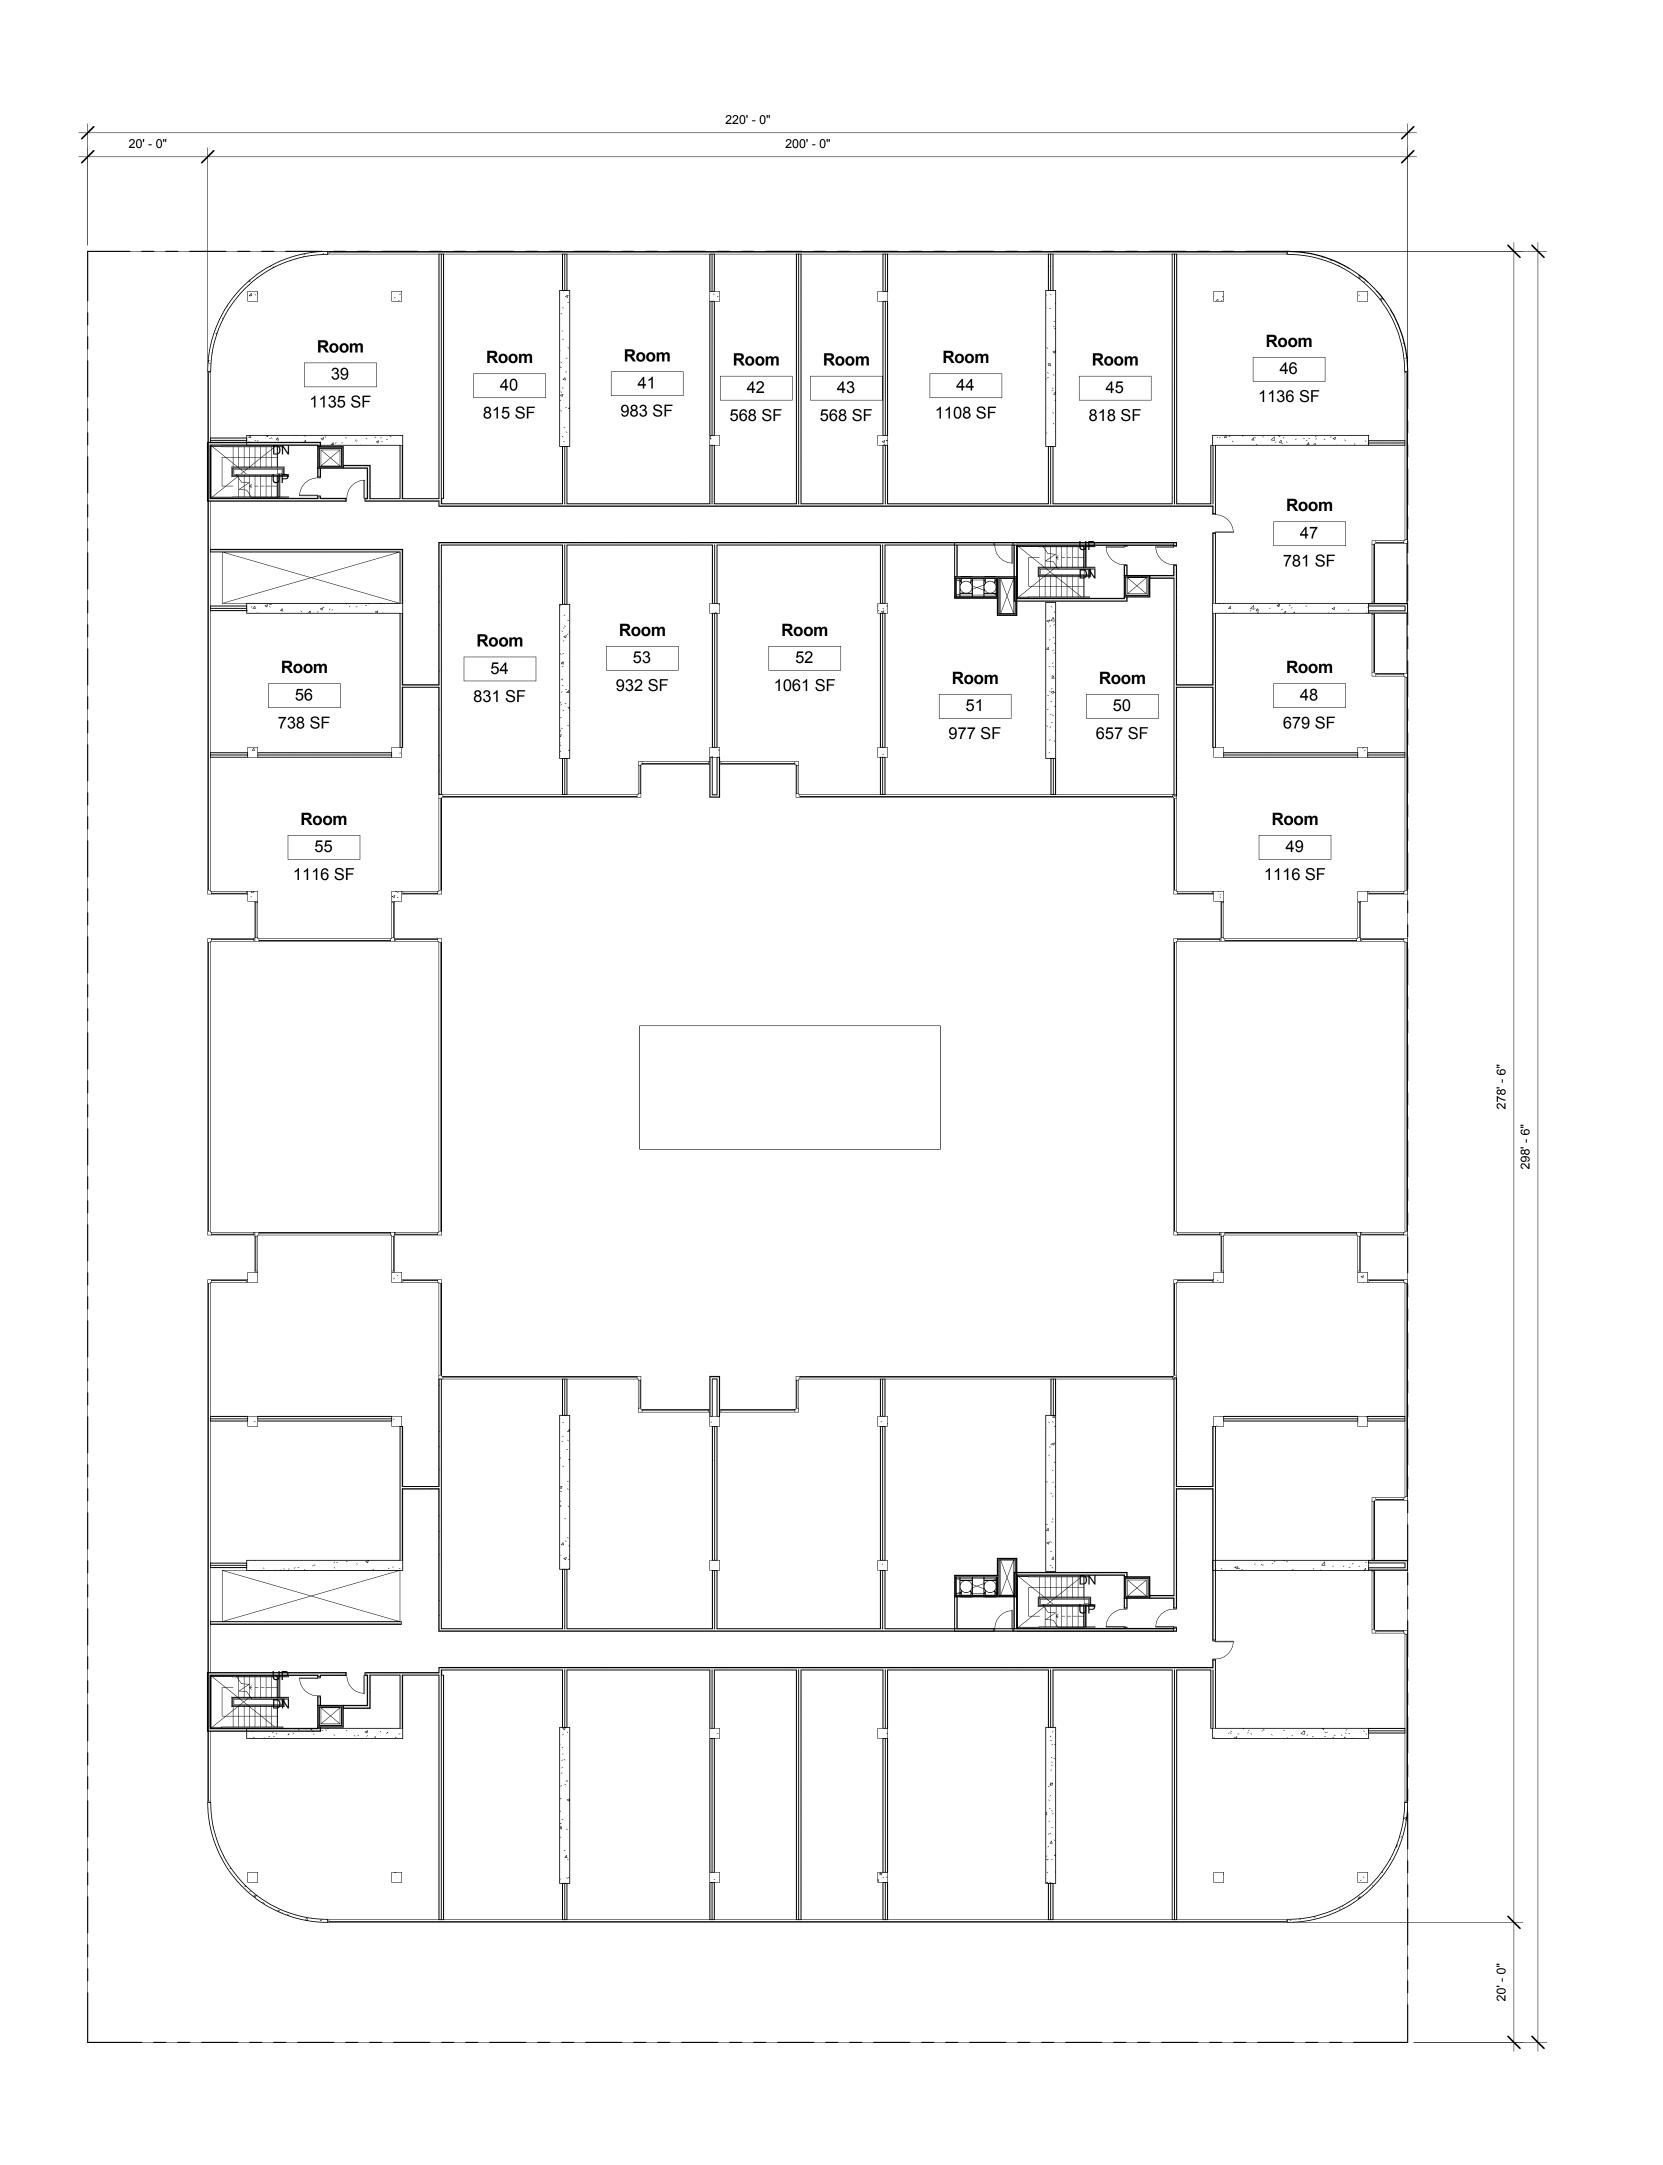

2 Level 4 - OPTION 2 1/16" = 1'-0"

BARRY SWENSON BUILDER
A DIVISION OF GREEN VALLEY CORP.

777 North First Street
Fifth Floor
San Jose, Ca 95112

tel: (408) 287-0246 fax: (408) 998-1737

Consultant:


Revision Schedule

Description Date

COPYRIGHT © 2014 BARRY SWENSON BUILDER

I025 TERRA BELLA AVE.
MT. VIEW, CA 94043

COWERS - 4TH FLOOR PLAN

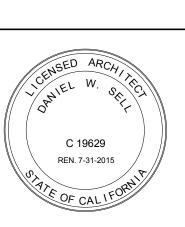

Date:
OCTOBER, 2016

TERR

Drawn by:

Job #: 13-9170

A105