Google Huff

Formal Review 5.1: Volume 2 May 26, 2020



AERIAL PERSPECTIVE



HUFF PARKING STRUCTURE

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KEY PLAN

PROJECT:



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PERSPECTIVE AT GREENWAY



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PERSPECTIVE AT ALTA AVE - GREENWAY



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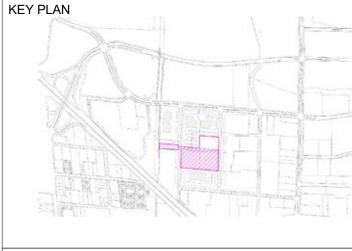
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PERSPECTIVE AT EAST FACADE



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PERSPECTIVE AT SOUTH FACADE



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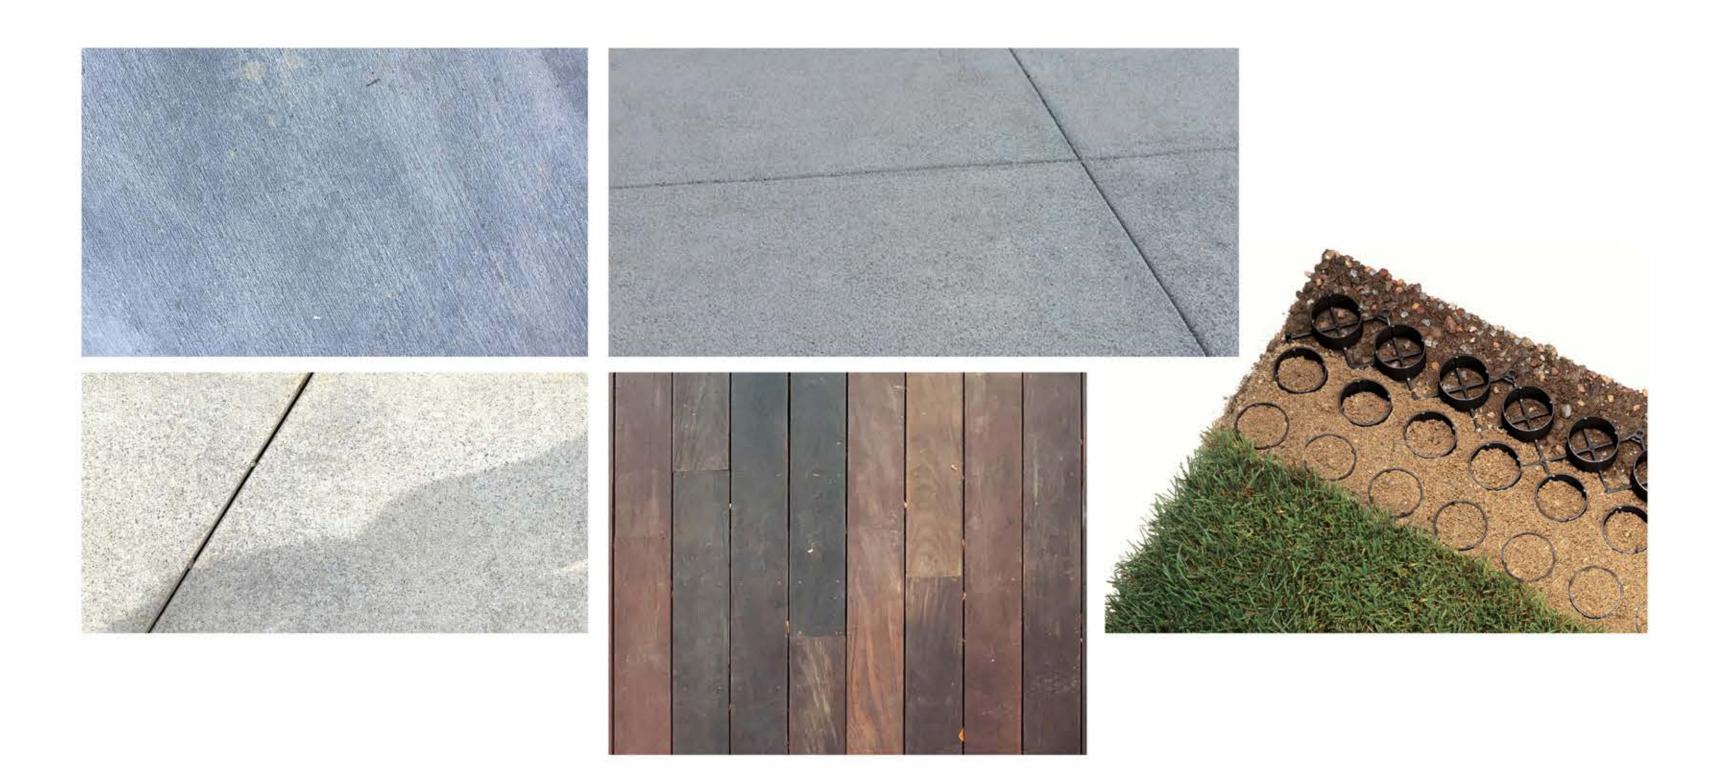
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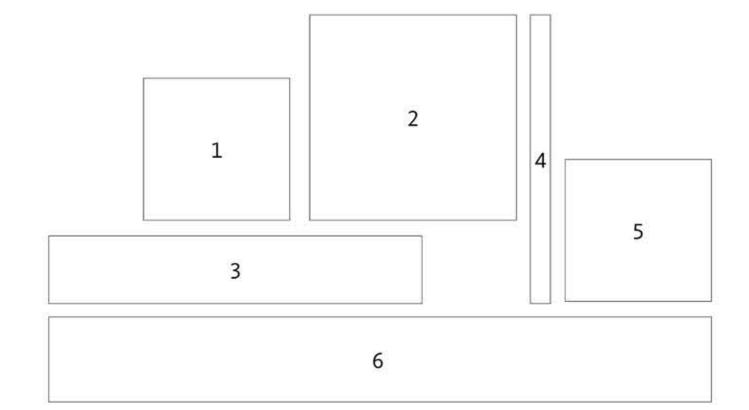
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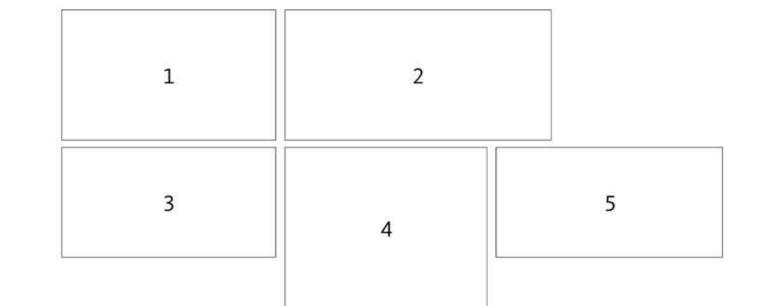
BUILDING MATERIALS

- 1 KINETIC FACADE EDGE WRAPPER
 DARK GREY ALUMINUM WITH KYNAR FINISH
- 2 CAR ENTRANCE PORTAL AND RETAIL ROOF FINISH LIGHT GREY ALUMINUM WITH KYNAR FINISH
- 3 TIMBER FEATURE AT BUILDING RECESS REDWOOD
- 4 PLANTING WALL AT SOUTH FACADE STAINLESS STEEL CABLES
- 5 GLAZING AT ROOF LEVEL NEUTRAL-TONED GLASS
- 6 KINECTIC FACADE FLAPPERS
 COLORED ALUMINUM SHEETS WITH KYNAR FINISH



SITE MATERIALS

- 1 BROOM FINISH CONCRETE
- 2 PERVIOUS CONCRETE
- 3 SEEDED CONCRETE
- 4 REDWOOD DECKING
- 5 TURF CELL PAVER





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KEY PLAN



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EXECUTIVE SUMMARY

PROJECT DESCRIPTION

The Huff Parking Structure is a four level, fully sprinklered, concrete parking structure with retail at ground level. The parking structure will serve Google Landings to the west and, starting in 2026 (unless the Amphitheatre lease is further extended), Charleston East to the north. Parking for persons with disabilities at the retail parking area, electric vehicles, carpool and vanpool spaces, green vehicles, motorcycles, and bicycles will be provided as part of the project. The parking structure will provide for 509 parking spaces when it opens. When the Shoreline Amphitheater lot lease terminates, which is anticipated to occur at the end of 2025 unless extended by agreement with the City, the designated Charleston East spaces will be shifted to this parking structure which will increase the parking count to 1,709 stalls.

The building area is approximately 521,312 sf, built on four levels: a ground level of approximately 140,476 sf, 2 elevated decks of approximately 128,112 sf each, and a roof deck of approximately 124,612 sf. Within the ground level there is a pedestrian/bicycle portal, and two retail areas consisting of one retail to the west of 4,894 sf and one retail to the east of 5,602 sf. The overall building footprint is approximately 560'-0" x 263'-9" and complies with NBPP requirements for setbacks and lot coverage.

The project facade is comprised of a graphic screen system that is variably articulated in order to provide visual interest to pedestrians and vehicles. Pedestrian entrances will be accentuated with significant recesses in the building massing in conjunction with landscape design features. The facade will have sufficient free air on all sides to allow for passive ventilation of the garage.

Fifty-five spaces of ground level parking will be open to the public. The remainder of the ground floor and the upper levels will be designated for Google employees only. The vehicle ramps from the ground level will be controlled by a card reading access control system, tilt down gates and gate arms. The pedestrian vertical circulation stairs and elevators will be secured and controlled by card readers.

In addition to the garage project, additional improvements will be made at the 900 Alta site to facilitate the continuation of the Greenway from Alta Avenue to the Permanente Creek trail. Connections for a future pedestrian and bike bridge from the Alta site to the Landings site over Permanente Creek will also be accommodated.

FLOOR AREA RATIO

The base FAR for the site is 0.45. The proposed project has a FAR of approximately 0.03 as parking garages for office uses do not count towards FAR.

FIRE AND LIFE SAFETY

TThe Huff Parking structure project will be fully sprinklered and will be designed to meet or exceed the City of Mountain View and State of California fire/life safety codes for parking structures. As the highest occupiable level will not exceed 75 feet above the fire department vehicle access.

the building will not be classified as a high-rise with respect to fire safety. The building will have Type IB construction and will be fully fire sprinklered.

MEP OVERVIEW

The Mechanical, Electrical and Plumbing (MEP) systems of the parking structure will be designed to provide healthy air quality and efficient energy usage, while also providing a long-term, expandable and resilient strategy.

- HVAC Systems: The majority of the structure will be passively ventilated in order to achieve "Open-Air" compliance with state code. The retail spaces, parking management offices and utility closets will be provided with split air systems to reduce the need for packaged heating and cooling equipment.
- <u>Plumbing Systems:</u> All building plumbing systems will be low flow and, where
 possible, will exceed Cal Green and code standards. The structure will be
 connected to the municipal reclaimed water system in order to allow the retail
 toilet facilities (under future permit) to be flushed with reclaimed water.
- <u>Electrical Systems:</u> A new PG&E service will service the structure. The project will meet all City and State requirements for electric vehicle charging stations and readiness. The use of LED lighting and lighting controls will utilize motion detectors and daylight photocell sensors to adjust for daylighting and pedestrian and/or vehicle motion.

LANDSCAPE

The Huff Parking Structure landscape is designed to blend both the structure and the landscape into its North Bayshore Greenway and broader North Bayshore surroundings. As a result, the landscape approach varies significantly depending on the façade.

The north side of the structure interfaces with the existing Green Way. The landscape includes paths, plaza spaces, bicycle parking areas, and stormwater treatment areas. There is an emphasis on creating pedestrian/bicycle circulation patterns to help separate these areas and provide pedestrian access from the parking structure to the Greenway pedestrian path. The planting approach focuses on lower-statured native vegetation near the building with native trees lining the southern edge of the Greenway.

The east and west sides respond to the Alta Avenue and Huff Avenue streetscapes. These areas are focused on providing pedestrian access to the parking structure. Along the Huff side, the required EVA takes up most of the plantable area between the structure and the road. Portions of the EVA will be paved with turf cell paving and planted with low growing grasses that will be mowed and maintained in order to keep the EVA highly visible. The remaining portion of the EVA will double as pedestrian access. The planting approach at both streetscapes is to create a dense palette of understory and trees where possible.

The south side includes required EVA access with a similar approach as the Huff Avenue streetscape EVA access.

The plant palette is dominated by native species that will (1) blend in with the Greenway planting areas across Huff Avenue, (2) provide ecological benefits by improving/creating habitat for pollinators and birds, which in turn results in increased biophilic interactions for people, and (3) be consistent with the North Bayshore Precise Plan. In addition, all existing trees in containers along the

Green Way will be assessed by an arborist for suitability for transplant into the Huff landscape, based on current health and likelihood of transplant success.

In addition to the Huff Parking Structure landscape, the proposed parking lot removal at the 900 Alta parcel will accommodate the continuation of the Greenway and additional landscape. The landscape here will be more focused on habitat creation than the Huff Parking Structure landscape because (1) it is adjacent to Permanente Creek and thus within the Precise Plan HOZ for creeks and close to the proposed Permanente Creek riparian habitat restoration area on the Landings site, (2) the area available for planting is larger than at the Huff Parking Structure landscape, and (3) there is no architectural structure that the landscape needs to respond to or highlight. This site's function is primarily to convey people through the space, however there are two small seating/activator areas, one near Alta Avenue and one near the center of the parcel.

RETAIL

The retail spaces are designed to be cold shell spaces for this application. The interior design, signage, and specific retail use type will be determined upon the leasing of the retail space. The type of retailers who lease these spaces will be determined by future market demand. However, Google's intent is to provide a variety of ground floor activations and experiences along the Greenway and therefore have identified fitness centers, light food service (e.g. coffee shop), and outdoor merchandise retailers (e.g. bike shop) as viable, community-serving uses. The retail spaces are arranged so large frontages towards both Huff and Alta Ave as well as towards the Greenway are created. The exterior landscape of the retail areas will feature flexible gathering space with movable furniture and umbrellas, as well as adjacent access to personal bike parking and g-bike parking.

PARKING NARRATIVE

The Huff Parking Structure will provide four levels of structured parking and will provide for between approximately 509 parking spaces and approximately 1,709 parking spaces. Parking will be provided with a combination of self-park and stacker spaces.

When the parking structure opens in 2023 it will provide for approximately 509 standard parking spaces. When parking demand increases in 2025, mechanical vehicle stackers will be installed to increase the parking count to 1709 and a valet service will be employed to operate the stackers. Valet operations will occur next to the primary vertical circulation cores on each level of the garage. Traditional valet for egress shall be implemented where drivers can call ahead for a vehicle and it is staged for them to pick up.

It is assumed that a roll out valet kiosk would be provided on each level. It is intended that some amount of 'self-parking' for a portion of the garage will occur until self-park spaces are no longer available. Stacker platforms will be left in the down position overnight, and upon arrival, a Googler will park their vehicle on the platform. The lift would then be raised by a valet attendant so that the next car which would need to park in that space could pull in without the need to raise the platform or seek the assistance of the valet. Once parked, the lower spot patron would leave their keys in a secured box which would be only accessible by the parking valet or themselves. A valet will be available to retrieve the lower vehicle to allow the upper platform to be lowered and allow the car to leave on their own. As the garage stackers fill, there will be a point in which the garage

will convert to 'full valet' operation. This would require that parkers would drive to a designated valet drop-off zone to then leave their vehicle with a parking attendant.

With some amount of self parking, a comprehensive wayfinding and guidance system for the parkers will be implemented to ensure successful operations. As Googlers arrive at the garage they will be able to obtain real time parking availability data from sensors which will direct the driver to an optimal spot within the Huff garage. Individual stall numbering, bay designation and aisle designation will be utilized for successful patron wayfinding and valet operations. This will minimize search times and congestion within the parking structure.

BIRD SAFETY SUMMARY

Buildings with transparent and reflective surfaces can present a collision risk for birds and artificial light at night can enhance this risk. Consistent with the North Bayshore Precise Plan bird safety requirements, we propose incorporating a set of bird-friendly design strategies including, but not limited to, low reflectivity glass and fine-grained visual obstacles in the first-floor vertical envelope and limited light pollution at night. Glazing on the structure is restricted to the ground floor retail storefronts and the roof core elevator locations and thus is substantially limited overall. In addition, vegetation will be selectively located outside of the facade to further reduce the risk of bird collisions.

SOLID WASTE MANAGEMENT

Trash collection will occur at the curbside, where there are no vertical obstructions impeding trash collection vehicles, no turning movements are required for the trash collection vehicles to access trash receptacles, and where trash collection vehicles would not block pedestrian walkways during trash collection. Waste for each of the retail spaces on the east and west side of the structure will be stored within secured waste rooms adjacent to each retail space. The trash rooms are sized to accommodate the trash bin sizes required by the City. Each retail space will have a trash room of approximately 10'x18'. An additional trash room of equal size will be located on the structure's east side to accommodate the garage trash. The garage trash includes a 3-stream bins located at each stair and elevator landing on each level, in the parking management office. Upon commencement of valet operations, valet offices will have a 3-stream trash bin as well. Within the retail and garage trash rooms the relevant waste streams will be stored until they are ready for collection.

The trash bins stored in the trash rooms will be moved out to an external collection staging area by building management. A trash hauler will retrieve the bins from the exterior staging area for loading into the waste collection vehicle for disposal.



HUFF PARKING STRUCTURE

GOOGLE LLC.

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TEL: +1 650-253-0000

ARCHITECT OF RECORD:

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FACADE DESIGNER: GENSLER

TEL: (408) 885 8100
STRUCTURAL ENGINEER:

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ELECTRICAL DESIGN BUILDER:
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FIRE PROTECTION DESIGN BUILDER:

COSCO FIRE PROTECTION

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SERA DESIGN 304 12th St., Suite 3A, Oakland, CA 94607, TEL: (510) 480-4988

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CIVIL: WMH

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SAN JOSE, CA 95113
TEL: (408) 971-7300

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INTERNATIONAL PARKING DESIGN, INC.

PROJECT:

HUFF PARKING STRUCTURE CITY OF MOUNTAIN VIEW, CA

KEY PLAN

DRAWING TITLE:

EXECUTIVE SUMMARY & DESIGN INTENT NARRATIVE

 SEAL & SIGNATURE:
 DATE
 05/26/2

 PROJECT No:
 1824

 SCALE:
 FORMAT: ARCH D
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 DRAWN: Author
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 CHK:
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 DWG No:
 O6

G002

PRECISE PLAN VISION AND GUIDING PRINCIPLES

PARKING GARAGE DESIGN GUIDELINES

The Huff parking garage is built to meet the parking demand of both the Landings and Charleston East projects.

The project is consistent with the following North Bayshore Precise Plan parking garage design guidelines:

Section 6.11, Garage Adaptability: "Parking garages built to accommodate today's parking demand should be adaptable to other uses over time to accommodate reductions in parking demand."

Section 6.11, Guidelines, Parking Garage Design: "Garages should be designed to include the following elements to allow their future conversion to other uses:

- Level floors.
- Ramps at the center of the garage or external to the garage.
- Floor-to-ceiling heights sufficient to accommodate future residential or commercial conversion."

GROUND FLOOR RETAIL

In order to better situate a parking garage in the context of North Bayshore, the ground floor along the E-W Greenway features two retail spaces that are located at the intersections of Huff Ave and Alta Ave. These retail spaces will activate the Greenway and provide a more community-focused parking garage. The retail spaces will be publicly accessible.

OPEN SPACE

The Huff Garage aims to create an environment that fits into the greater context of the North Bayshore area. A diverse palette of trees and plants create settings for different experiences and in natural areas including both passive and active activities. The project fronts the E-W Greenway and thus ties into the greater North Bayshore area.

ECOLOGY

The Huff site offers a unique opportunity to enhance the ecology and habitat along Huff Ave, Alta Ave, and the Greenway. This enhancement is an important piece of the overall ecological vision of the North Bayshore Precise Plan; strengthening the green connections between larger ecological assets in the area.

SUSTAINABILITY

The project will seek opportunities to reduce the environmental impact of the building during construction and operation, and responsibly manage water across the site by complying with State of California C3 stormwater diversion requirements and by utilizing the City of Mountain View's reclaimed water system for landscape irrigation water (assuming reclaimed water infrastructure exists in the public street or streets fronting the property). Additionally, the roof level will feature a PV installation.

FLOOR AND SEA LEVEL RISE

Based on the City of Mountain View's study of 50-year Sea-Level Rise, areas below 13.2' (above sea-level) will be susceptible to flooding by 2052. Although a small portion of the huff parcel(s) are below this 13.2' mark, the project footprint is outside of this zone and not subject to Sea-Level Rise

VEHICULAR TRANSIT

The external vehicle circulation is provided by four entry/exit points, two from Huff Avenue and two from Alta Avenue. The interior vehicle circulation is provided by two-way traffic and 90-degree parking stalls. Vertical vehicular circulation is provided by two express ramps, one from the east and one oriented towards the west.

As requested by City Department of Public Works (DPW), the Huff project will install "No Parking Anytime" signs along the Huff project frontage (Alta Ave and Huff Ave) as shown on sheet C160.

PEDESTRIAN CIRCULATION

The location of this parking garage enhances the vision of the North Bayshore Precise Plan by connecting the Greenway, a key pedestrian amenity, to this parking structure, which will become one of the North Bayshore's district parking facilities. The pedestrian circulation is facilitated by strategically located elevators and stairs. The retail spaces and bike lobby strategically front the Greenway to the north as this is the most active pedestrian frontage

GREEN WAY CONNECTIVITY

The Huff project will extend the existing E-W Greenway to cross Alta Avenue at a new pedestrian street crossing. A new Greenway segment is proposed on 900 Alta which will connect to the Permanente Creek trail thus completing this important section of the Greenway in direct support of the North Bayshore Precise Plan goals.

The Huff project also provides a 20' clear width along the southern property line (See Sheet C150). This 20' width provides for 50% of the overall required future Greenway width of 40' (Greenway & Setbacks) per The North Bayshore Precise Plan requirements.

The existing Greenway, illustrated on sheet C101, north of the garage will be reconstructed in accordance with The North Bayshore Precise Plan Greenway standards. Additionally, this pathway will be enhanced with new retail connections, bike parking, furnishings, and native landscaping.

The garage is designed to allow for a future N-S bike and pedestrian movement through the ground floor.

BUILDING FACADE LENGTH

The east-west garage structure facade length exceeds Precise Plan guidance for a maximum 300' length. In order to meet Precise Plan intent for attractive, varied facades the building massing includes 18' deep and 30' wide recesses on East and West building sides, and 18' deep and 54' wide recesses on North and South building sides.

PRECISE PLAN REQUIREMENTS

BUILD-TO-AREA

The Precise Plan establishes a minimum build-to frontage of 50% within the 15'-40' build-to-area along the east side of the site along the Huff Avenue Neighborhood Street. There is also a minimum build-to frontage of 50% within the 15'-50' build-to-area along the west side of the site along the Alta Avenue Access Street. Huff Avenue frontage build-to frontage is 50%, and the Alta Avenue build-to frontage is 50%.

The north side of the site achieves activation and quality design through the inclusion of retail uses, sidewalks, bikeways, the Greenway connection, and landscape along the ground level. This treatment of the site and the access connections, along with the concealment of parking behind the retail spaces, allow for an attractive, welcoming face of the building along the Greenway.

The southern orientation of the Huff project site is not subject to the build-to frontage requirements. It borders the adjacent property and faces the back of the adjacent building at 1600 Plymouth.

GREEN WAY FRONTAGES AND DESIGN STANDARDS

The existing Greenway extends the entire span across the east to west portion of the site. The Precise Plan allows for exemptions from the build-to standard in the setback zone if "the area exceeding the maximum setback contains pedestrian-oriented uses, building entries, seating areas, active spaces, and/or similar elements" (NBPP, February 22, 2018 p. 75 footnote 15). The Greenway through the Huff site meets these goals and is flanked by such active uses, gathering spaces, and landscape areas.

BUILDING HEIGHT

The Precise Plan maximum building height for the Huff site is 95 feet.

Per the Mountain View City Code, building height is measured as the vertical distance from the elevation of the top of the existing or planned curb along the front property line to the highest point of the coping or flat roof or to the top of the slope of a mansard roof or the mean height level between the eaves and ridge for gable, hip or gambrel roof.

The proposed roof level is at 51 feet 10 inches. Per California Building Code, parapets with guardrails must extend 3 feet 6 inches above the finish floor. Top of guardrail will be 55 feet 4 inches. Elevator shafts show at 18 feet above the roof level. Per the City of Mountain View Code of Ordinances Sec. 36.08.30.A, height limit shall not apply to elevator penthouses, and the height limit shall not apply to parapet walls extending not more than four (4) feet above the limiting height of the building.



HUFF PARKING STRUCTURE

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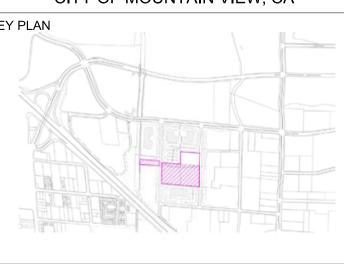
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CITY OF MOUNTAIN VIEW, CA **KEY PLAN**




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G003





| | General Character Area Lot Coverages | Huff Project Coverage |
|--------------------------------|---|--------------------------|
| Landscape / Open Space Area | Minimun 25% | 55% |
| Paving Area | Maximum 40% | 2% |
| Building Area | Maximum 55% | 43% |

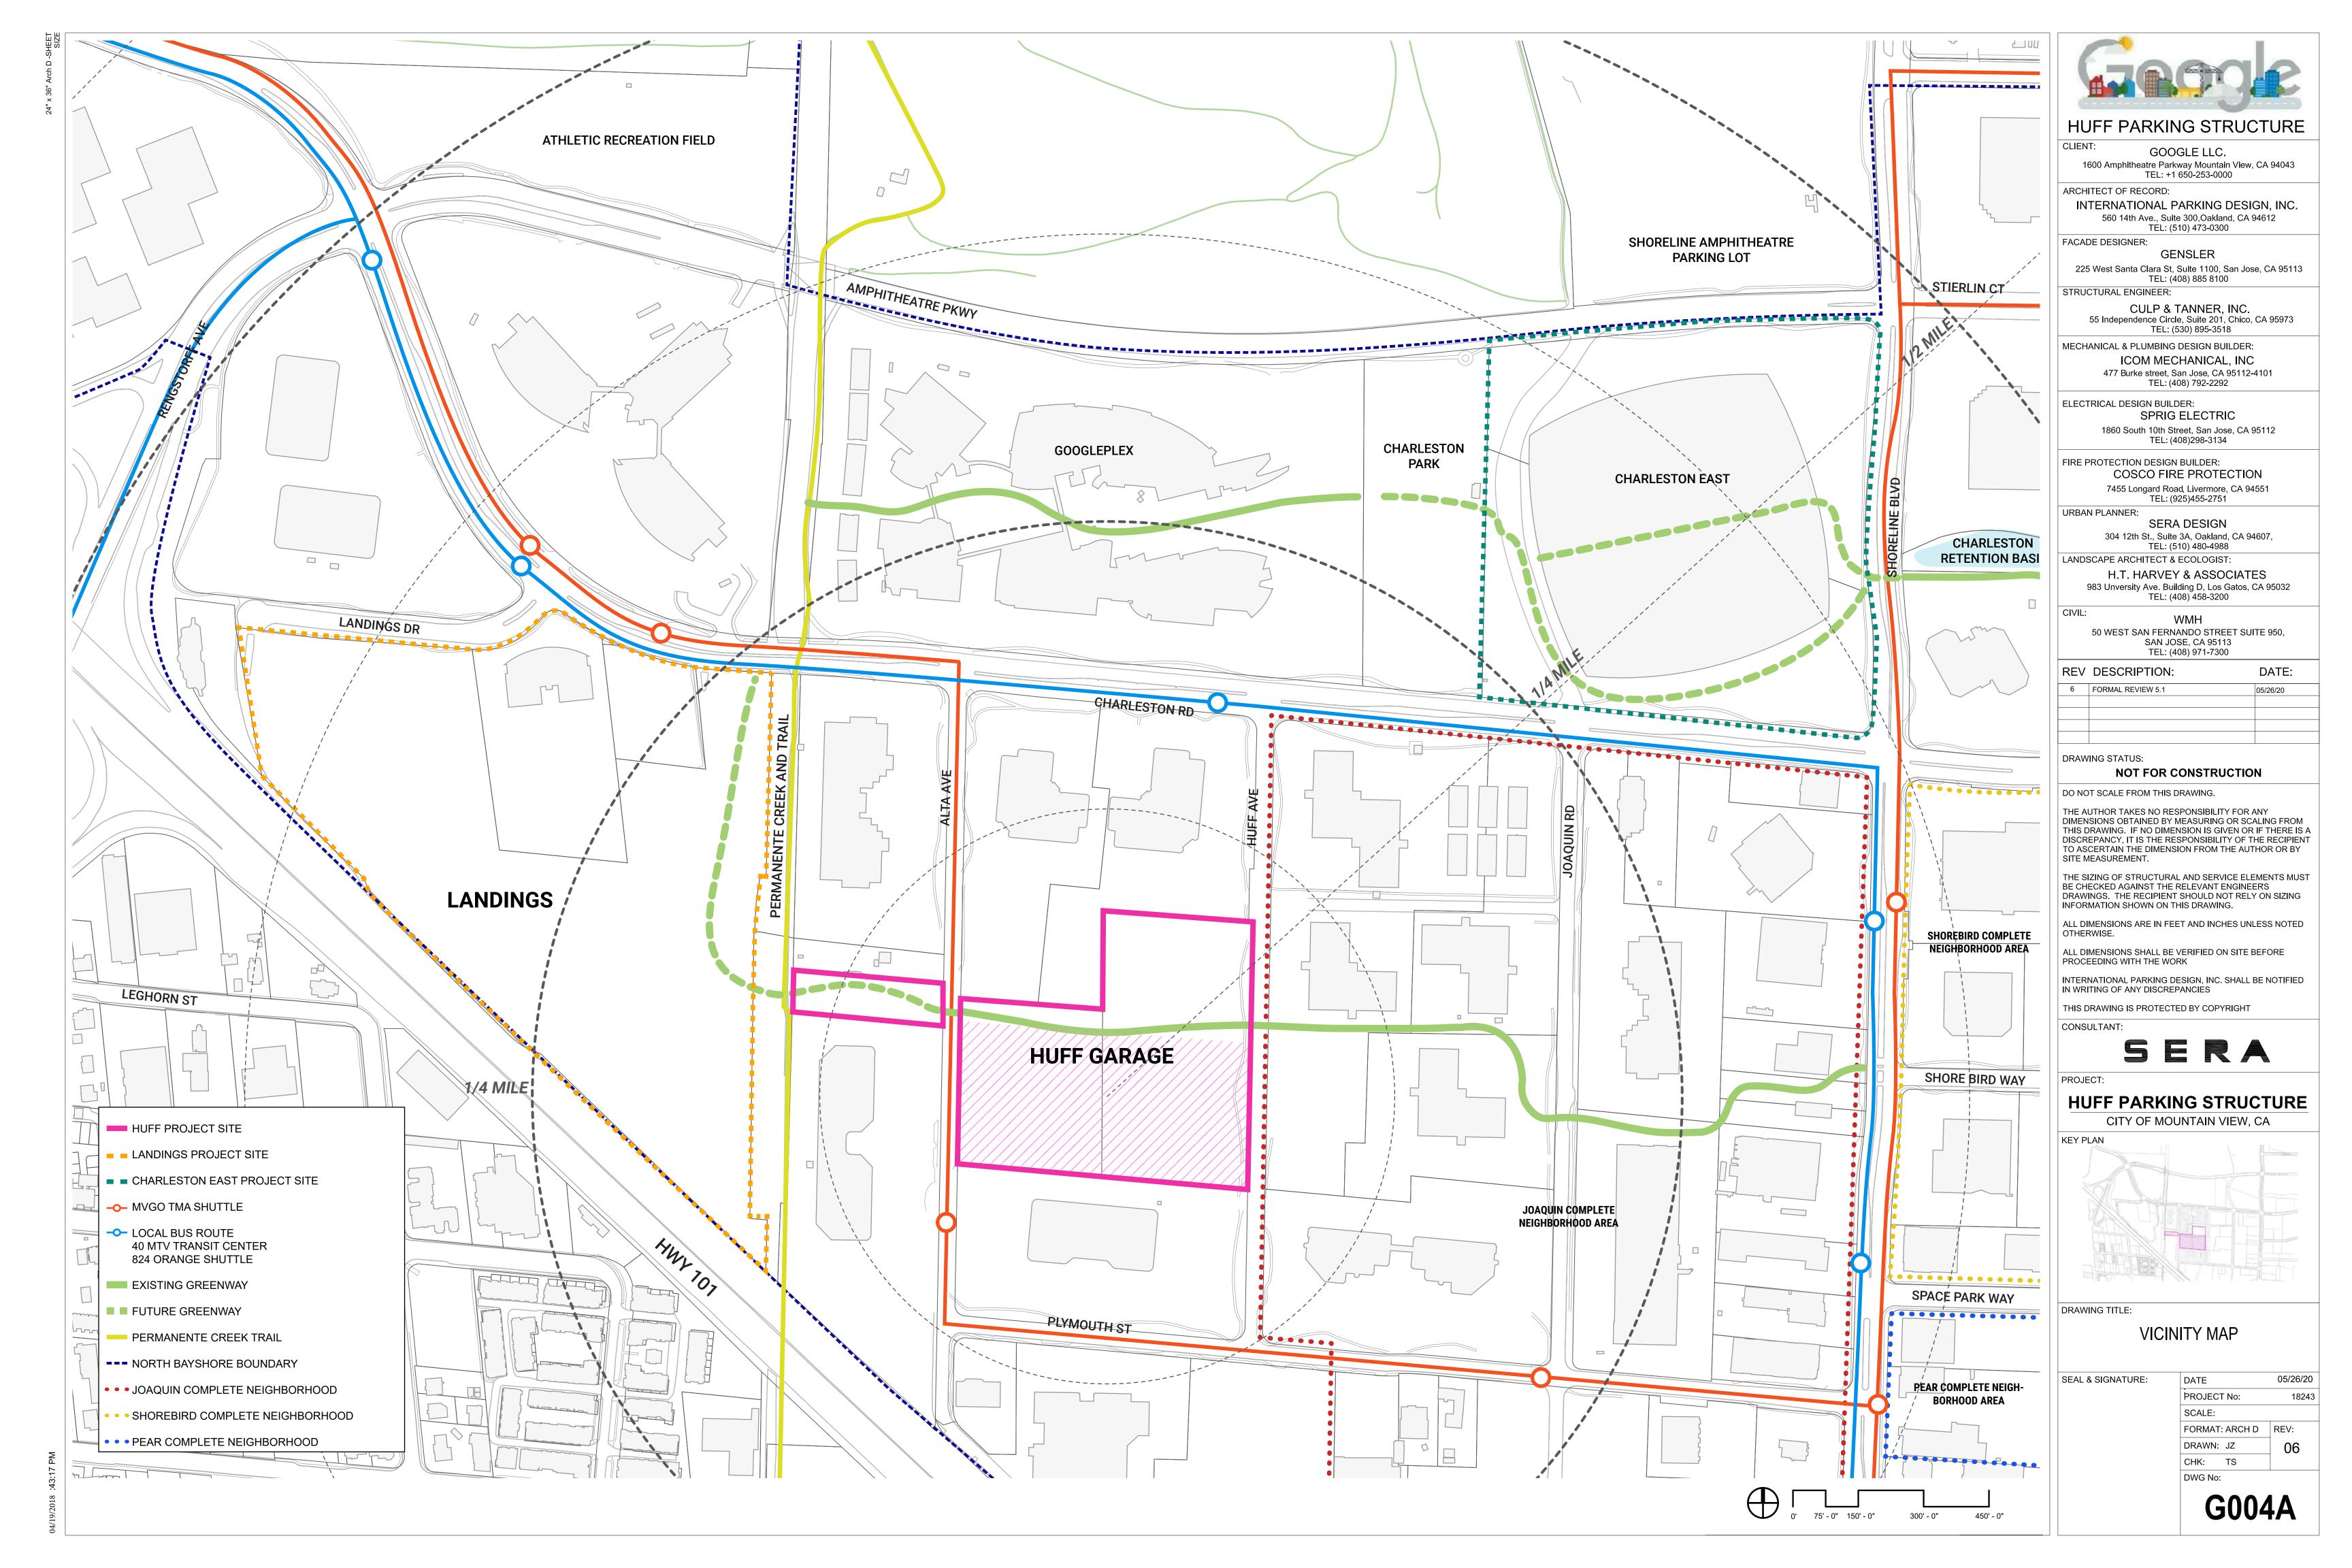

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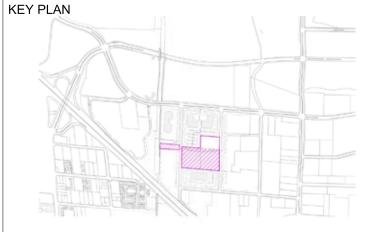
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CITY OF MOUNTAIN VIEW, CA



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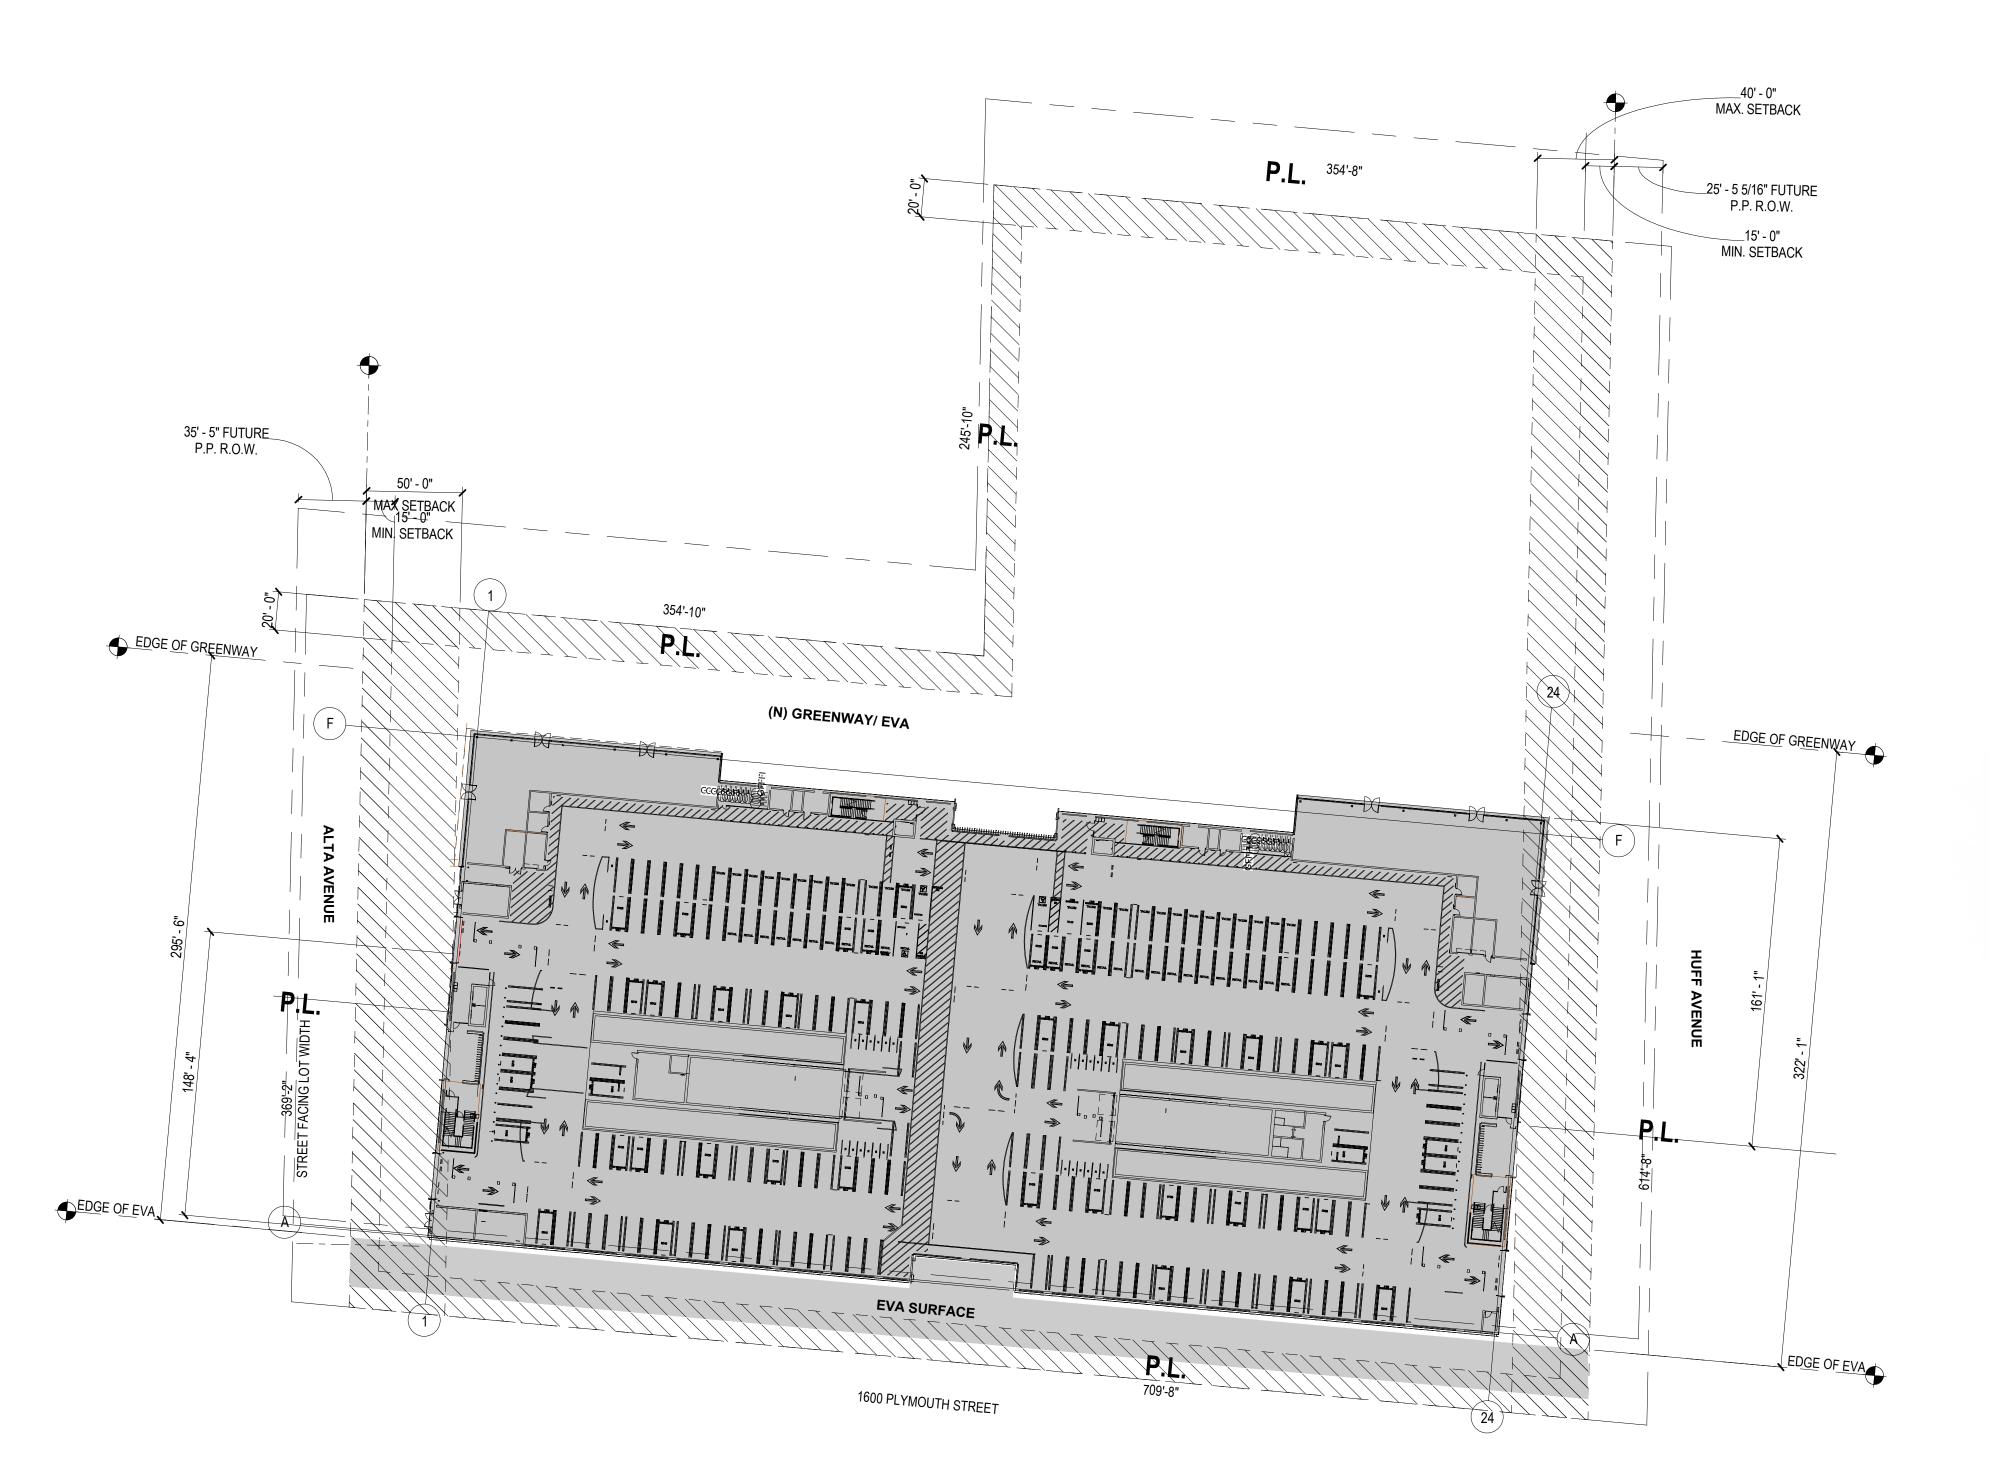
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BUILD-TO-AREA


The Precise Plan establishes a minimum build-to frontage of 50% within the 15'-40' build-to-area along the east side of the site along the Huff Avenue Neighborhood Street. There is also a minimum build-to frontage of 50% within the 15'-50' build-to-area along the west side of the site along the Atla Avenue Access Street. Huff Avenue frontage is currently at 50%. Alta Avenue frontage is at 50%.

The north side of the site achieves activation and quality design through the inclusion of sidewalks, bikeways, the Greenway connection, and landscape along the ground level. This treatment of the site and the access connections, along with the concealment of parking behind the retail spaces, allow for an attractive, welcoming face of the building along the Greenway.

The southern orientation of the Huff project site is not subject to the build-to frontage requirements. It borders the adjacent propertyand faces the back of the adjacent building at 1600 Plymouth.

GREENWAY FRONTAGES AND DESIGN STANDARDS

The Greenway includes an easement through the entire span across the east to west portion of the site. The Precise Plan allows for exemptions from the build-to standard in the setback zone if "the area exceeding the maximum setback contains pedestrian-oriented uses, building entries, seating areas, active spaces, and/or similar elements". (NBPP, February 22, 2018 p. 75 footnote) The Green Loop through the Huff site broadly meets these goals and is typically flanked by such active uses, gathering spaces, landscape areas, or a property boundary.

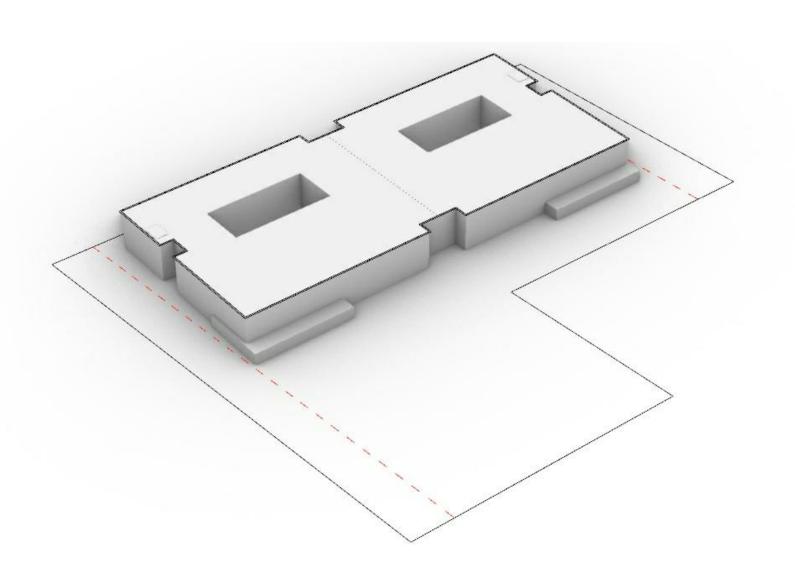

MASSING STUDY

116-09-110 AND 116-09-141 LOT AREA: 7.992 + ACRES (GROSS) 7.541 + ACRES (NET) **BUILDING COVERAGE:** F.A.R.:





CLIENT: GOOGLE LLC. 1600 Amphitheatre Parkway Mountain View, CA 94043

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HUFF PARKING STRUCTURE

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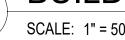


BUILDING MASSING & PLACEMENT

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G006

BUILDING PLACEMENT




BUILDING HEIGHT

The Precise Plan provides that the maximum building height for the Huff site is 5 stories and 95 feet. The Precise Plan height guideline for a parking garage is 45 feet.


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The proposed roof level is at 55 feet 4 inches. Elevator shafts are shown at 18 feet above the roof level.

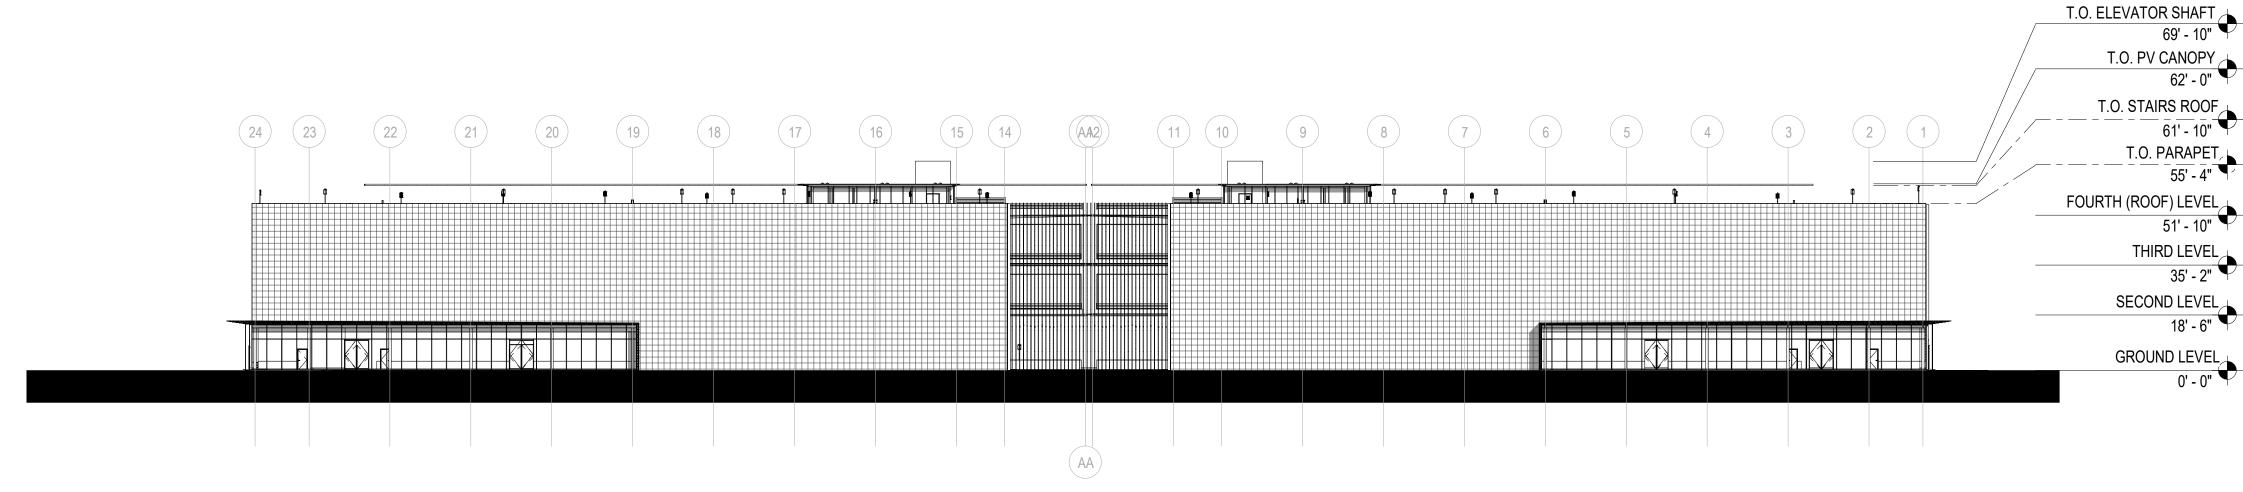



NORTH - HEIGHT SUMMARY

SCALE: 1/32" = 1'-0"

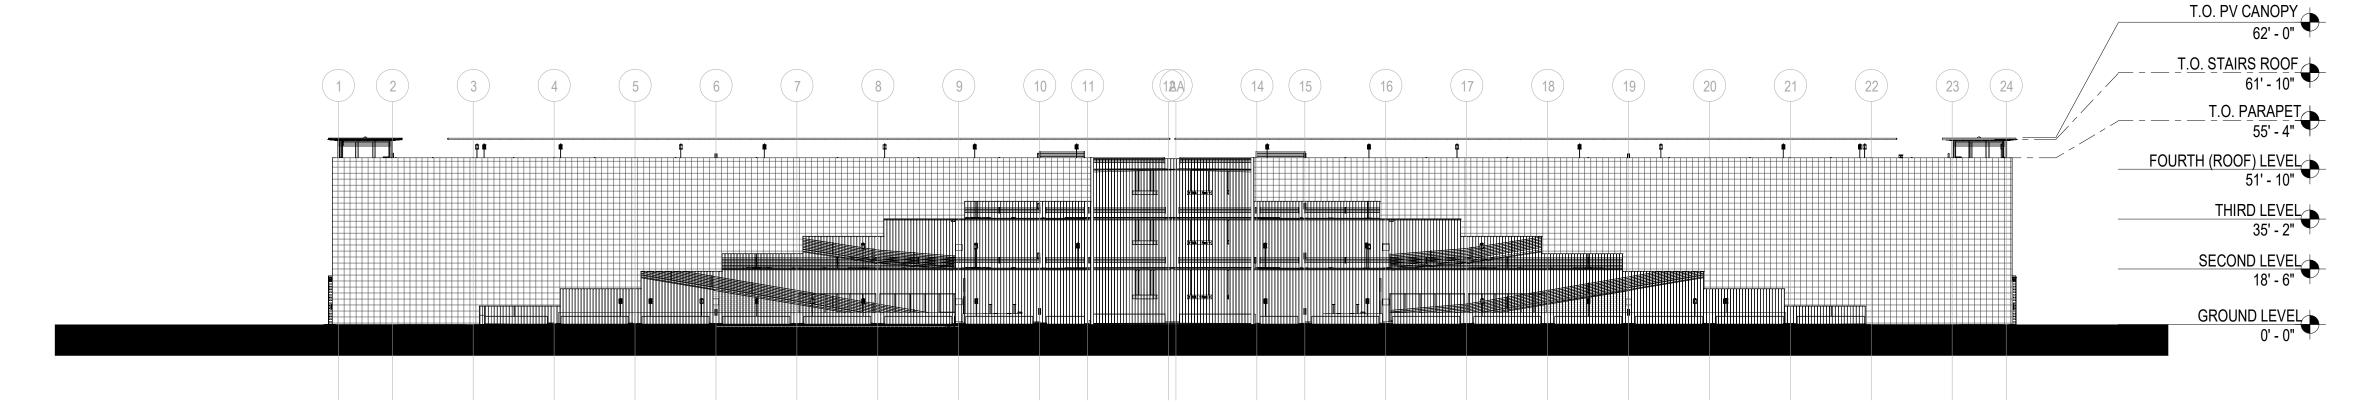

SOUTH - HEIGHT SUMMARY

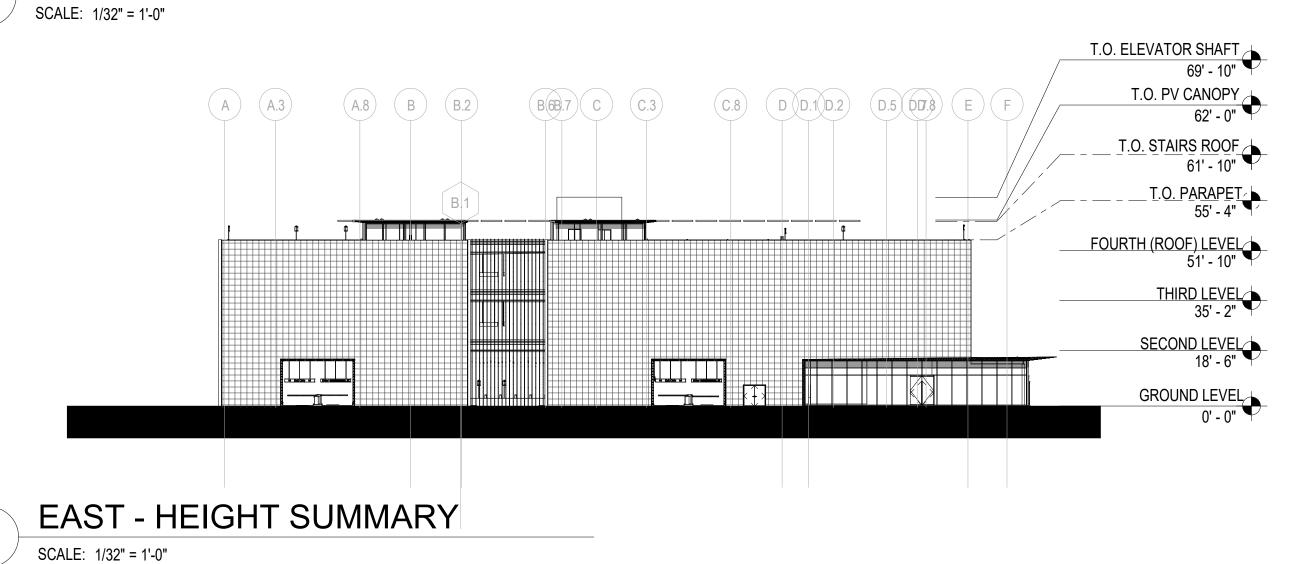

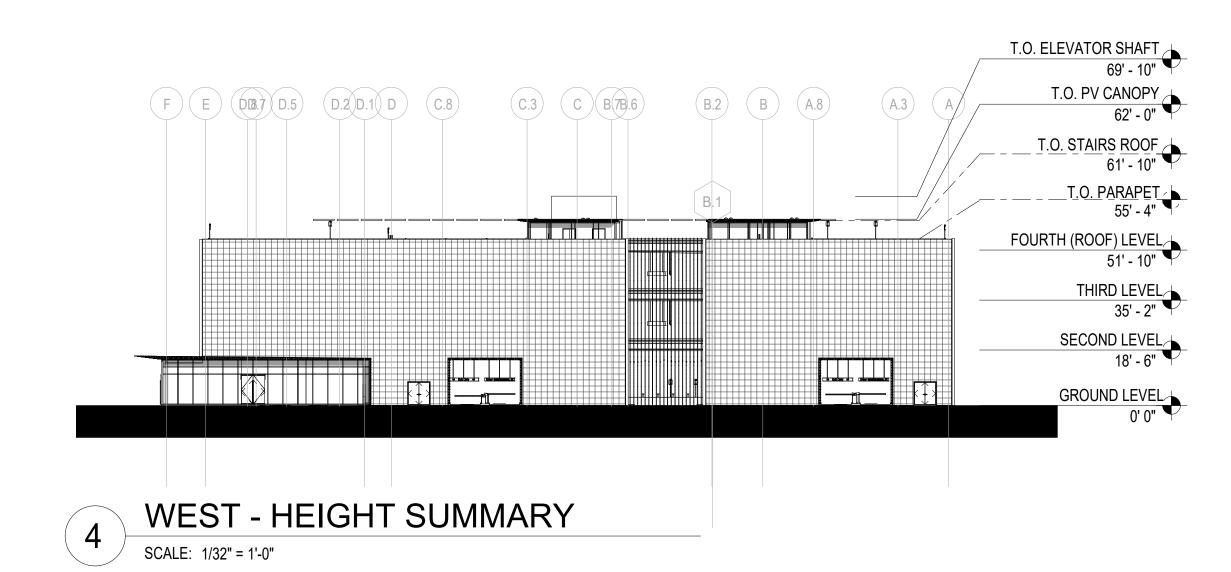

HUFF PARKING STRUCTURE

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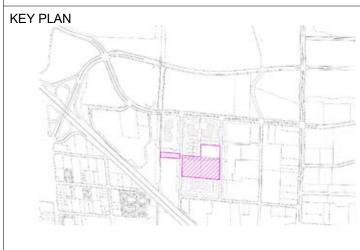
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CONSULTANT:

GENSLER

HUFF PARKING STRUCTURE

CITY OF MOUNTAIN VIEW, CA



DRAWING TITLE:

BUILDING HEIGHT SUMMARY

| | G0 | U, | 7 |
|------------------|-----------------|-----|-------------|
| | DWG No: | | |
| | CHK: Checke | r | |
| | DRAWN: Author | | 06 |
| | FORMAT: ARCH | D | REV: |
| | SCALE:As indica | ted | |
| | PROJECT No: | 03 | 35.3549.000 |
| EAL & SIGNATURE: | DATE | | 05/26/20 |

PARKING SPACE SUMMARY PRE 2025

| DADKING ADEA. | DE | DESIGNATED PARKING EV | | | STANDARD STALL TYPE | | | | |
|---------------------|-------|--------------------------|------|---|---------------------|-----|-------|-------|--|
| PARKING AREA: | | | | | VS | FS | STACK | TOTAL | |
| | EV-VA | EV-VA | EVCS | | | | | | |
| LEVEL 1 | 1 | 1 | 24 | 2 | 1 | 105 | | 13 | |
| LL VLL 1 | 1 | - ' | 27 | | • | 100 | | | |
| LEVEL 2 | | | 17 | | | 108 | | 12 | |
| LEVEL 3 | | | 17 | | | 108 | 0 | 12 | |
| LEVEL 4 | | | 17 | | | 108 | | 12 | |
| STANDARD STACKER | | 1 | 75 | 2 | 1 | 429 | 0 | 50 | |
| TOTAL: | 1 | 1 | 75 | 2 | 1 | 429 | 0 | 50 | |

LEGEND:

EV-VA - VAN ACCESSIBLE ELECTRIC VEHICLE CHARGING STATION

STACK-EV - STACKER ELECTRIC VEHICLE CHARGING STATION

EVCS - ELECTRIC VEHICLE CHARGING STATION (ON SLAB)

AS - REGULAR ACCESSIBLE STALL VS - VAN ACCESSIBLE STALL

FS - FULL SIZE STALL

STACK - STACKER

PARKING SPACE SUMMARY POST 2025

| PARKING AREA: | | DESIGN | ATED PARKING | | ST | ANDAR | D STAL | L TYPE | TOTAL |
|---------------|-------|--------|--------------|------|----|-------|--------|---|-------|
| PARKING AREA. | | | EV AS VS FS | | | | FS | STACK | IOTAL |
| | EV-VA | EVA | EV - STACKER | EVCS | | | | | |
| | | | | | | | | | |
| LEVEL 1 | 1 | 1 | 20 | 25 | 2 | 1 | 130 | 120 | 300 |
| | | | | | | | | | |
| LEVEL 2 | | | | 78 | | | 104 | 364 | 546 |
| LEVEL 3 | | | | 77 | | | 129 | 314 | 520 |
| | | | | | | | | • | |
| LEVEL 4 | | | | 58 | | | 285 | 0 | 343 |
| STANDARD | 1 | | | 238 | 2 | 1 | 648 | | 890 |
| STACKER | | | | | | | | 798 | 798 |
| OTAL: | 1 | | | 238 | 2 | 1 | 648 | 798 | 1,709 |

MOTORCYCLE SPACES:

LEGEND:

EV-AMB - AMBULATORY ELECTRIC VEHICLE CHARGING STATION

EV-A - REGULAR ACCESSIBLE ELECTRIC VEHICLE CHARGING STATION STACK-EV - STACKER ELECTRIC VEHICLE CHARGING STATION

EVCS - ELECTRIC VEHICLE CHARGING STATION (ON SLAB)

AS - REGULAR ACCESSIBLE STALL

VS - VAN ACCESSIBLE STALL

GV- GREEN VEHICLE STACK - STACKER



PLEASE NOTE: THE LOWER CAR MUST BE MOVED BY A PERSON TO LOWER

| | AREA SUMM | |
|---------------------|---------------------|------------------------|
| LEVEL | AREA NAME | PROPOSED BUILDING AREA |
| GROUND LEVEL | | |
| GROUND LEVEL | PARKING | 129980 SF |
| GROUND LEVEL | RETAIL AREA 01 | 4894 SF |
| GROUND LEVEL | RETAIL AREA 02 | 5602 SF |
| GROUND LEVEL | 1127112711127111271 | 140476 SF |
| | | |
| SECOND LEVEL | | |
| SECOND LEVEL | PARKING | 128112 SF |
| SECOND LEVEL | | 128112 SF |
| | | |
| THIRD LEVEL | | 1,00,400,00 |
| THIRD LEVEL | PARKING | 128112 SF |
| THIRD LEVEL | | 128112 SF |
| FOURTH (ROOF) LEVEL | | |
| FOURTH (ROOF) LEVEL | PARKING | 124612 SF |
| FOURTH (ROOF) LEVEL | 1 | 124612 SF |
| TOTAL BUILDING AREA | | 521312 SF |
| OTAL DOILDING AIRLA | | 02 10 12 OI |

SMIC BRACING IS DONE AT THE TOP OF THE 7'-2" OR GREATER BRACING POINT REAR WALL 10'-2" CEILING HEIGHT CL CF TOWER

MECHANICAL VEHICLE STACKER OPERATION

The Huff Parking Structure utilizes parking stackers to efficiently use space within the structure. The stackers are electrically-powered mechanical lifts that allow a vehicle to be raised approximately 7' above the parking structure floor surface so that another vehicle may be parked underneath.

On a typical day, the stacker platform is in the "down" position when the day begins. A parker will drive their car onto the platform and leave for the day. As the parking structure fills up, a parking attendant will raise the platform to allow room for another parker to park their car underneath the platform. The person parking their car in the lower space will leave their car key with the attendant.

If a parker would like to retrieve their car from a raised platform, a valet attendant will relocate the car, if any, at the bottom parking space to allow the platform to be lowered.


In case of power loss, platforms can be lowered without power to allow cars to be retrieved. The stacker operating system is designed for safety so that the attendant can not be under or in conflict with the platform as it is moving.



VEHICLE STACKER REFRENCE PHOTO

SECTION - SYSTEM RAISED Free space Free space Pass through 1

SECTION - SYSTEM LOWERED

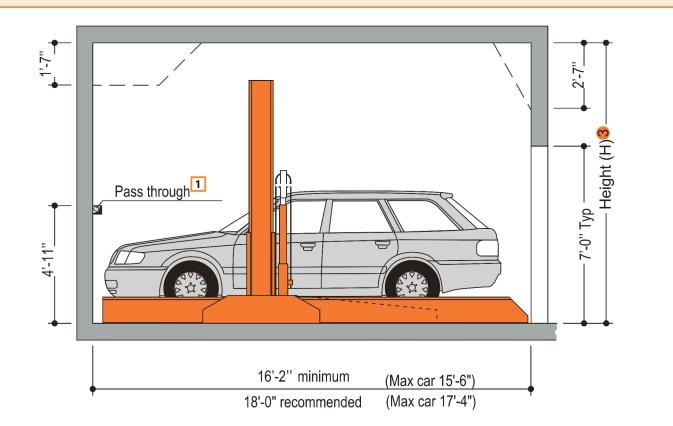



HUFF PARKING STRUCTURE

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URBAN PLANNER

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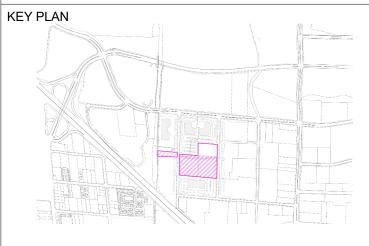
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PROJECT:

HUFF PARKING STRUCTURE

CITY OF MOUNTAIN VIEW, CA



DRAWING TITLE:

PARKING SUMMARY AND VEHICLE STACKER INFORMATION

| OTACILLA | | • |
|----------------|----------------|----------|
| L & SIGNATURE: | DATE | 05/26/20 |
| | PROJECT No: | 18243 |
| | SCALE: | |
| | FORMAT: ARCH D | REV: |
| | DRAWN: LD, PP | 06 |
| | CHK: DT, RNN | |
| | DWG No: | |
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GUUO

GREENWAY

DETAIL PLAN AT HUFF (1)

DETAIL PLAN AT CENTER ENTRY PLAZA

1 001C DETAIL PLAN AT ALTA



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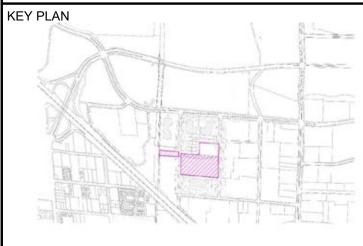
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Ecological Consultants

HUFF PARKING STRUCTURE

CITY OF MOUNTAIN VIEW, CA



SITE LANDSCAPE PLAN

| | DWG No: | |
|-------------------|-----------------|----------|
| | CHK: JMH, KV | |
| | DRAWN: LD, CG | 00 |
| | FORMAT: ARCH D | REV: |
| | SCALE: AS SHOWN | |
| | PROJECT No: | 3475-65 |
| SEAL & SIGNATURE: | DATE | 05/26/20 |

120' - 0"

15' PSE



NOTES

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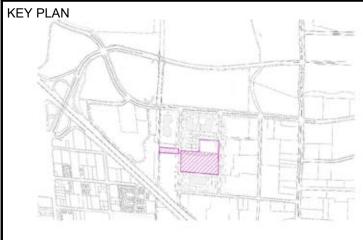
PROJECT:

120' - 0"



HUFF PARKING STRUCTURE

CITY OF MOUNTAIN VIEW, CA



SITE LANDSCAPE PLAN
900 ALTA

| L & SIGNATURE: | DATE | 05/26/20 |
|----------------|-----------------|----------|
| | PROJECT No: | 3475-6 |
| | SCALE: AS SHOWN | |
| | FORMAT: ARCH D | REV: |
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| | DWG No: | |
| | | |

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0' 15'-0" 30' - 0" 60' - 0"

18 :43:17 PM





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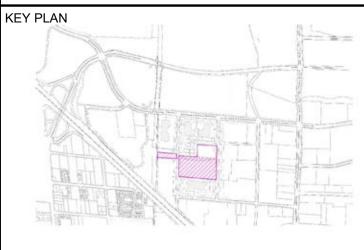
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HUFF PARKING STRUCTURE

CITY OF MOUNTAIN VIEW, CA




SITE LANDSCAPE DETAIL PLAN (1)

| AL & SIGNATURE: | DATE | 05/26 |
|-----------------|-----------------|-------|
| | PROJECT No: | 347 |
| | SCALE: AS SHOWN | |
| | FORMAT: ARCH D | REV: |
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| | CHK: JMH, KV | |
| | DWG No: | |

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DETAIL PLAN AT CENTER ENTRY PLAZA



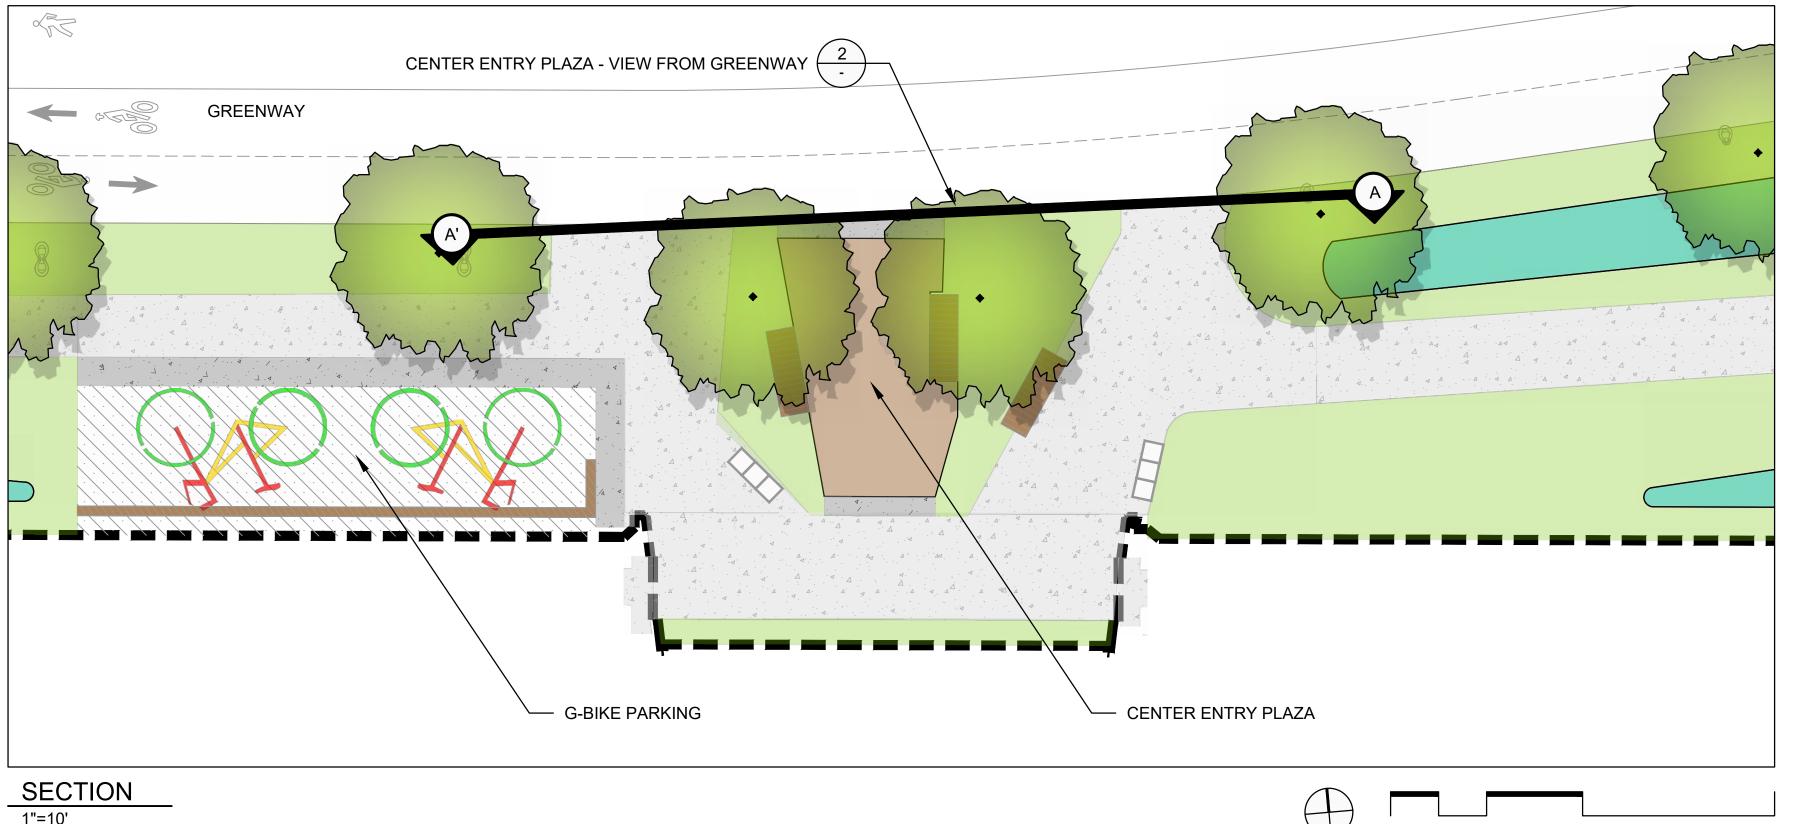

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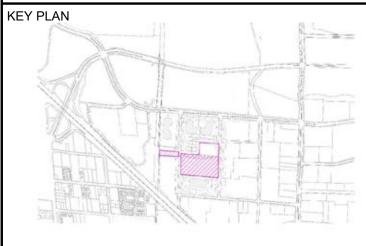
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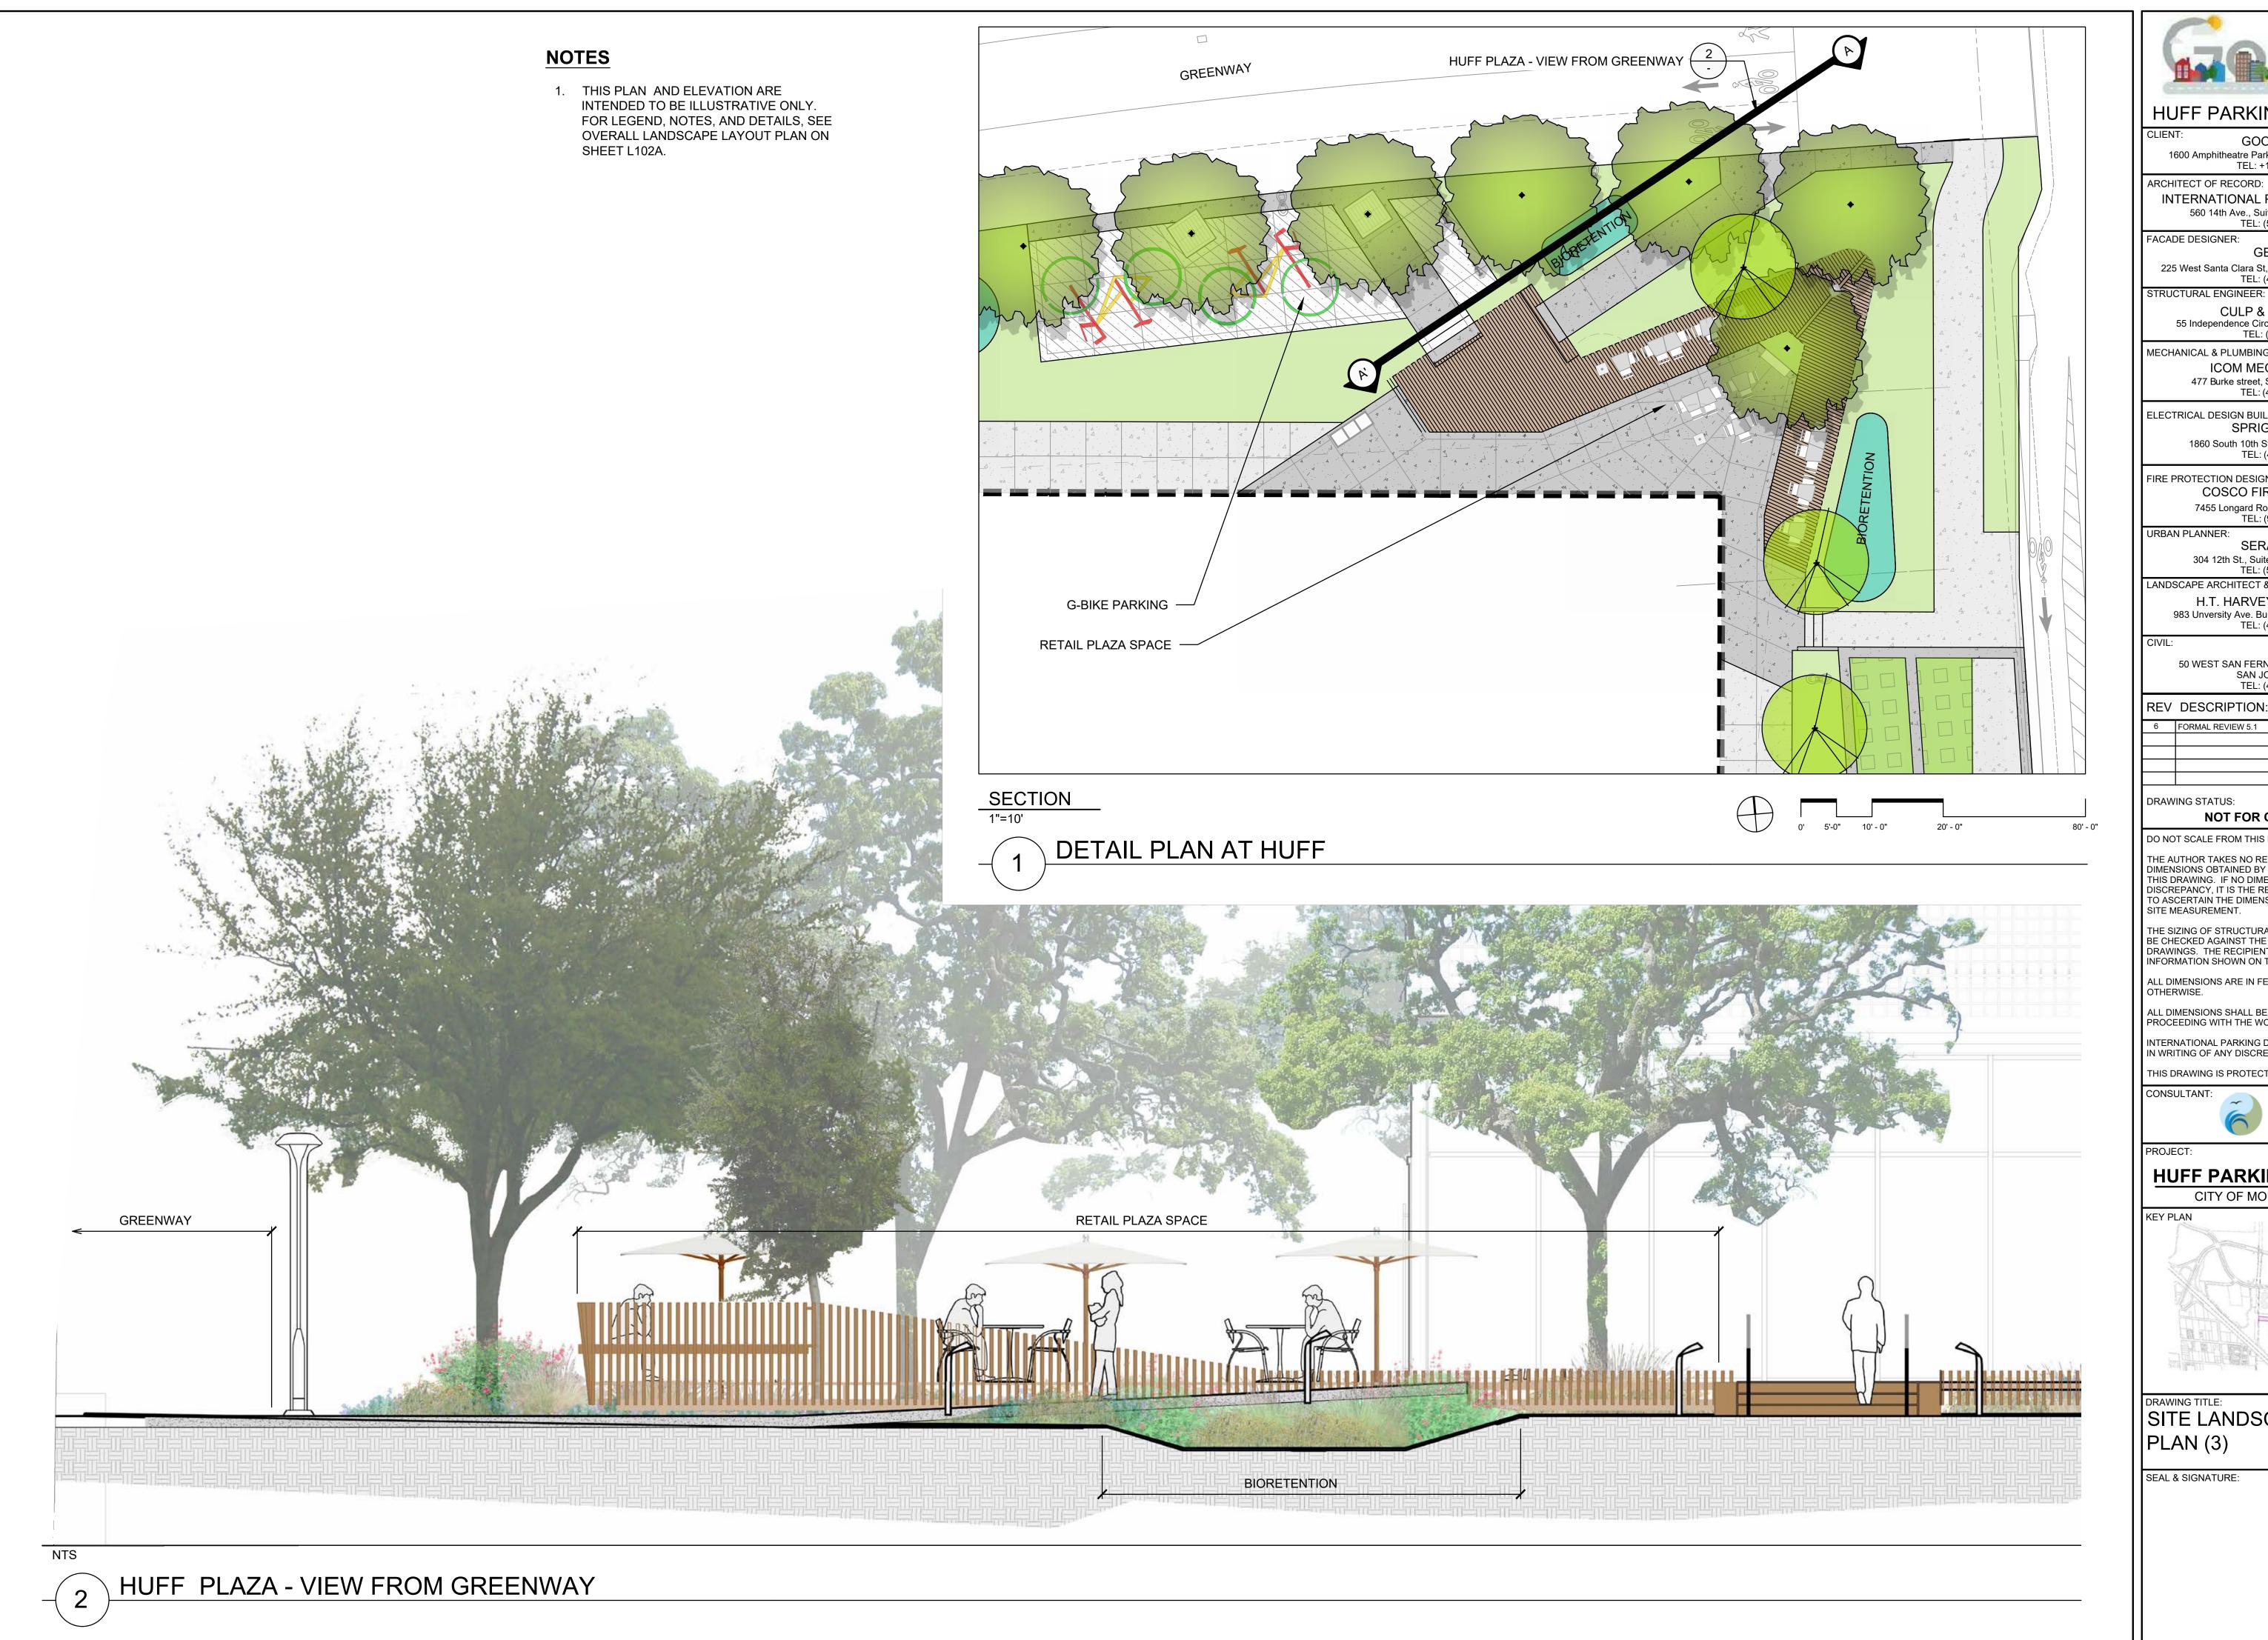
CITY OF MOUNTAIN VIEW, CA



SITE LANDSCAPE DETAIL PLAN (2)

| SEAL & SIGNATURE: | DATE | 05 |
|-------------------|-----------------|-----|
| | PROJECT No: | 3 |
| | SCALE: AS SHOWN | |
| | FORMAT: ARCH D | RE' |
| | DRAWN: LD, CG | (|
| | 01114 | |

CENTER ENTRY PLAZA - VIEW FROM GREENWAY



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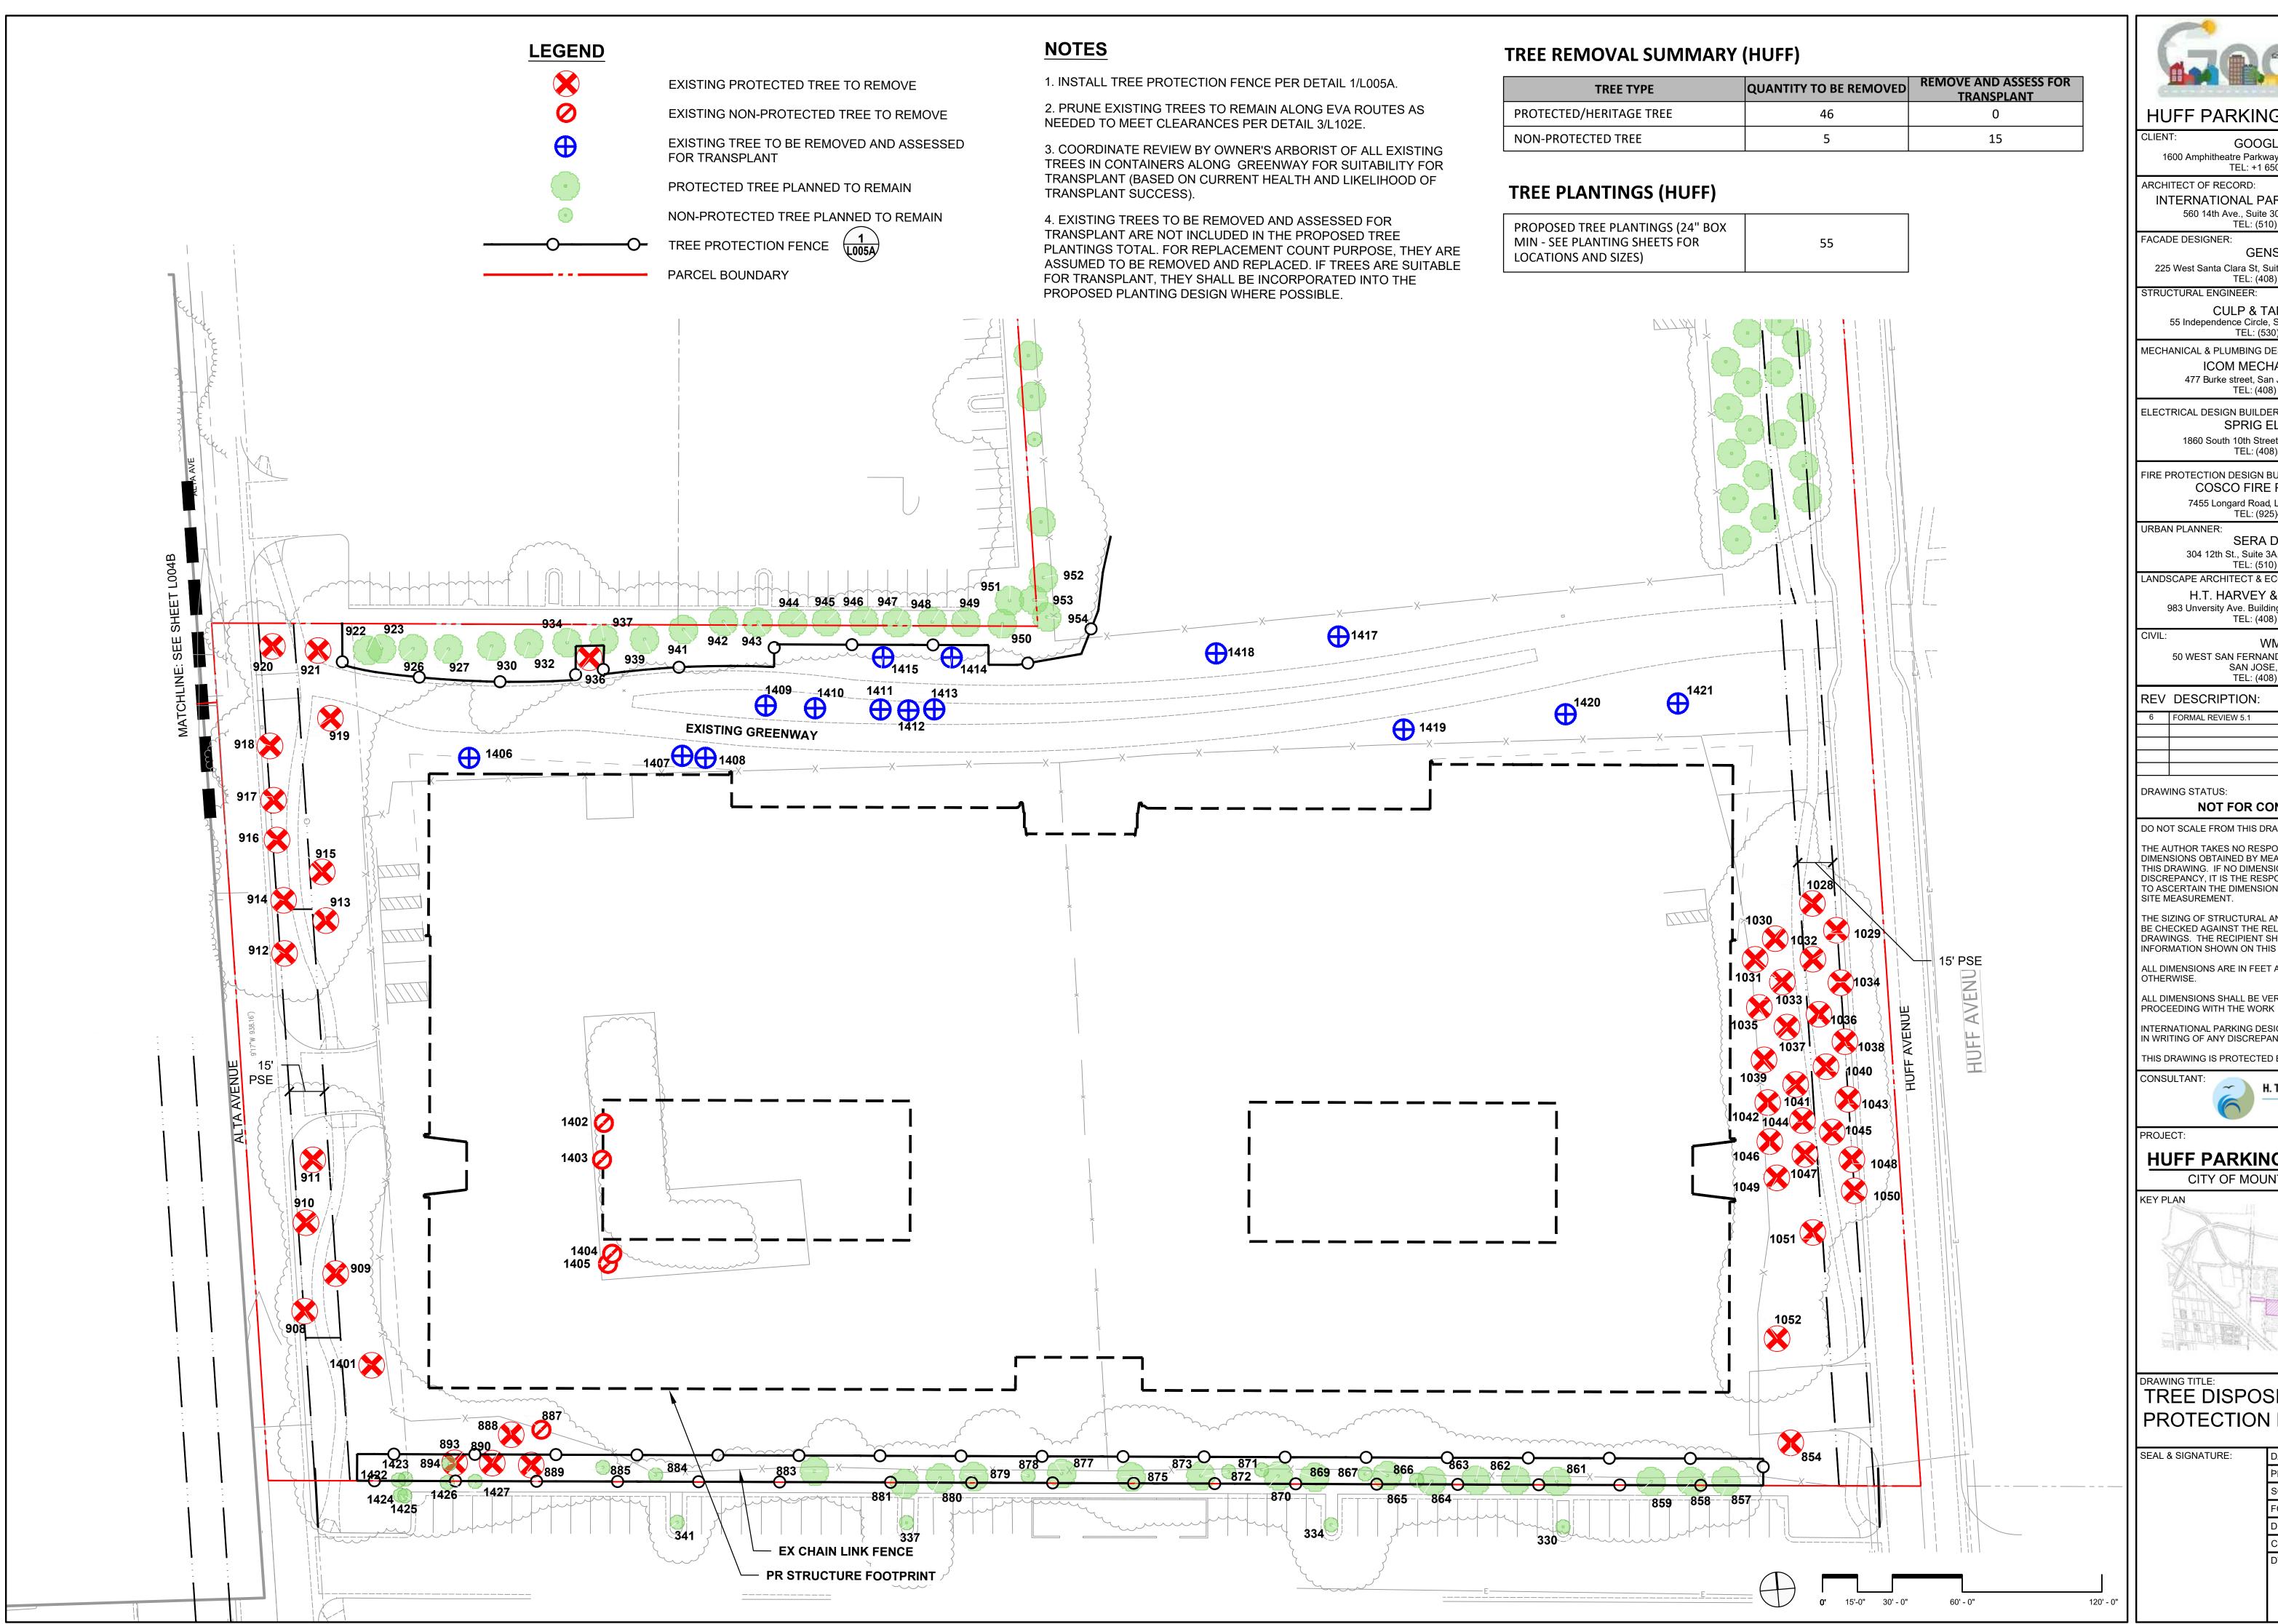
CITY OF MOUNTAIN VIEW, CA **KEY PLAN**



SITE LANDSCAPE DETAIL PLAN (3)

| & SIGNATURE: | DATE | 05/26/ |
|--------------|-----------------|--------|
| | PROJECT No: | 3475 |
| | SCALE: AS SHOWN | |
| | FORMAT: ARCH D | REV: |
| | DRAWN: LD, CG | 06 |
| | CHK: JMH, KV | |
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GOOGLE LLC. 1600 Amphitheatre Parkway Mountain View, CA 94043 TEL: +1 650-253-0000

INTERNATIONAL PARKING DESIGN, INC.

560 14th Ave., Suite 300,Oakland, CA 94612 TEL: (510) 473-0300

GENSLER

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1860 South 10th Street, San Jose, CA 95112 TEL: (408)298-3134

FIRE PROTECTION DESIGN BUILDER: COSCO FIRE PROTECTION 7455 Longard Road, Livermore, CA 94551

SERA DESIGN 304 12th St., Suite 3A, Oakland, CA 94607, TEL: (510) 480-4988

LANDSCAPE ARCHITECT & ECOLOGIST: H.T. HARVEY & ASSOCIATES

TEL: (925)455-2751

983 Unversity Ave. Building D, Los Gatos, CA 95032 TEL: (408) 458-3200

WMH

50 WEST SAN FERNANDO STREET SUITE 950, SAN JOSE, CA 95113 TEL: (408) 971-7300

| REV | DESCRIPTION: | DATE: |
|-----|-------------------|----------|
| 6 | FORMAL REVIEW 5.1 | 05/26/20 |
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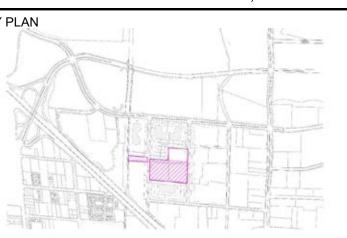
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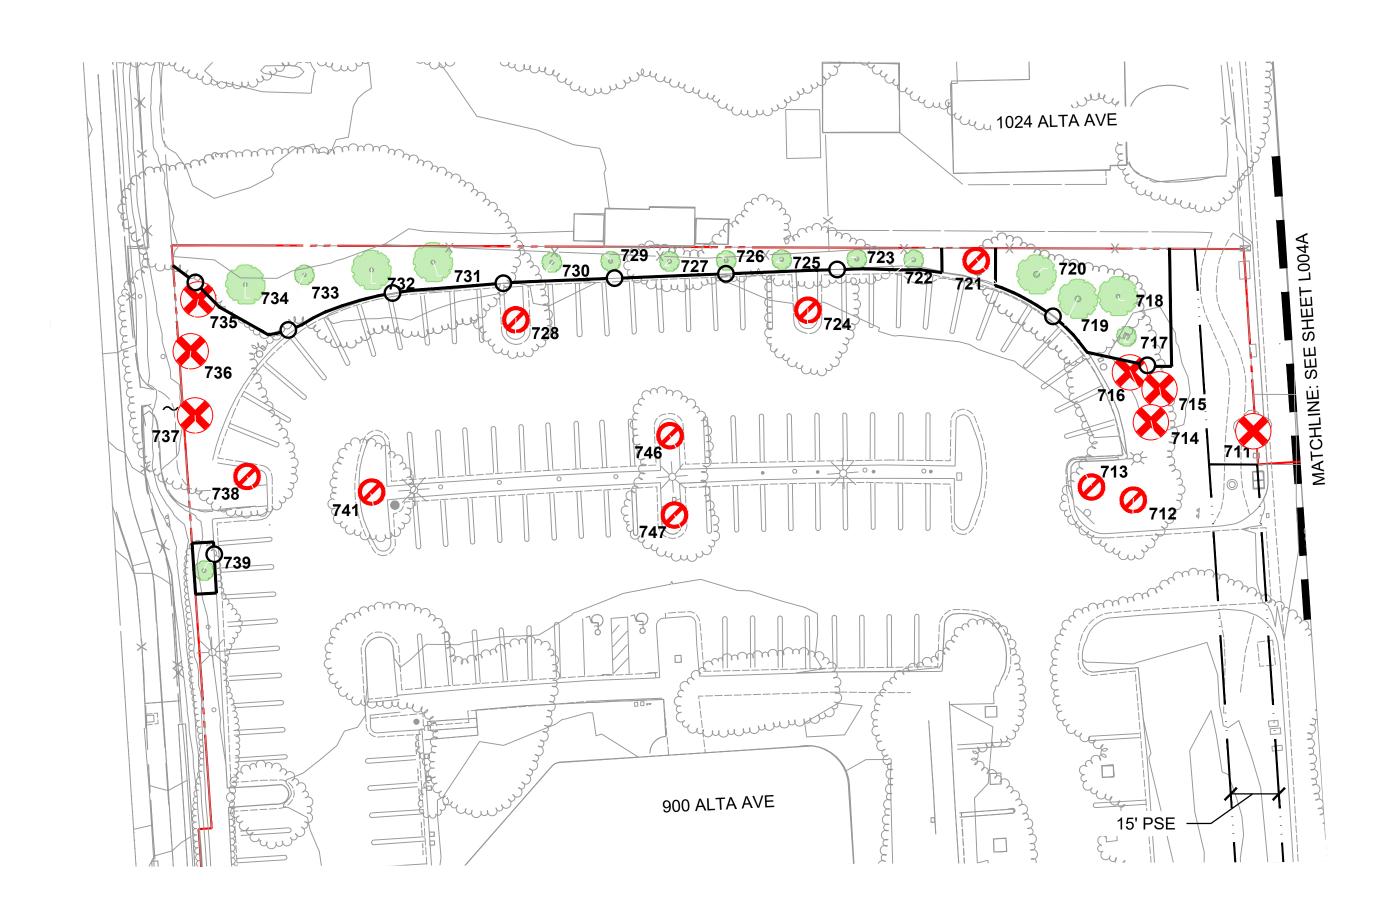
HUFF PARKING STRUCTURE


CITY OF MOUNTAIN VIEW, CA



TREE DISPOSITION & PROTECTION PLAN

| | L004 | 4A |
|-------------------|-----------------|-----------|
| | DWG No: | |
| | CHK: JMH, KV | |
| | DRAWN: LD, CG | 00 |
| | FORMAT: ARCH D | REV: |
| | SCALE: AS SHOWN | |
| | PROJECT No: | 3475-65 |
| SEAL & SIGNATURE: | DATE | 05/26/20 |
| | | |



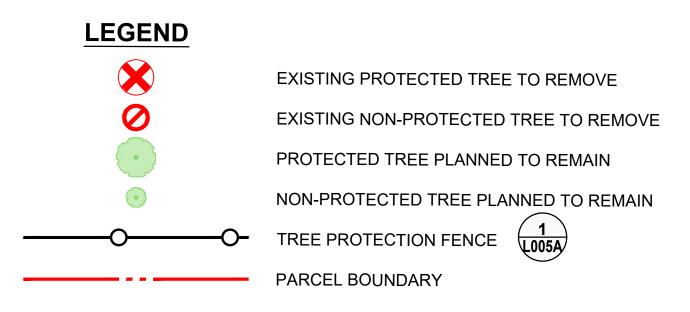

NOTES

1. SEE NOTES ON SHEET L004A.

2. CONTRACTOR SHALL SUBMIT TREE PROTECTION PLAN FOR ALL TREES NOT SHOWN ON THE PLANS, OUTSIDE OF THE DIRECT WORK AREA, TO BE CONSISTENT WITH RECOMMENDATIONS OF THE ARBORIST'S REPORT AND APPROVED BY OWNER'S REPRESENTATIVE.

TREE REMOVAL SUMMARY (900 ALTA)

| TREE TYPE | QUANTITY TO BE REMOVED |
|-------------------------|------------------------|
| PROTECTED/HERITAGE TREE | 7 |
| NON-PROTECTED TREE | 9 |

TREE PLANTINGS (900 ALTA)

| PROPOSED TREE PLANTINGS (24" BOX | |
|----------------------------------|----|
| MIN - SEE PLANTING SHEETS FOR | 72 |
| LOCATIONS AND SIZES) | |
| | |

HUFF PARKING STRUCTURE

GOOGLE LLC. 1600 Amphitheatre Parkway Mountain View, CA 94043 TEL: +1 650-253-0000

ARCHITECT OF RECORD:

STRUCTURAL ENGINEER:

INTERNATIONAL PARKING DESIGN, INC. 560 14th Ave., Suite 300, Oakland, CA 94612 TEL: (510) 473-0300

FACADE DESIGNER: **GENSLER**

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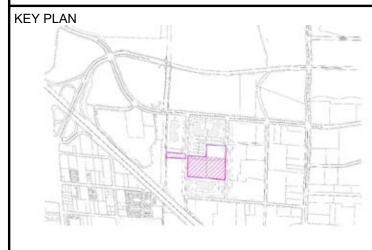
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HUFF PARKING STRUCTURE

CITY OF MOUNTAIN VIEW, CA



TREET DISPOSITION & PROTECTION PLAN 900 ALTA

SEAL & SIGNATURE:

120' - 0"

| DATE | 05/26/2 |
|-----------------|---------|
| PROJECT No: | 3475- |
| SCALE: AS SHOWN | |
| FORMAT: ARCH D | REV: |
| DRAWN: LD, CG | 06 |
| CHK: JMH, KV | |
| DWG No: | |

L004B

TREE DISPOSITION SCHEDULE - HUFF

| TREE TAG NUMBER | SPECIES | DBH (IN.)* | PROTECTED TREE? | REMOVED BY THIS PROJECT?** |
|---|---|--|---|--------------------------------------|
| 330 334 | LONDON PLANE | 11 11 | NO NO | - |
| 336 | GLOSSY PRIVET | 8 | NO | _ |
| 337 | LONDON PLANE | 13 | NO | - |
| 341 | LONDON PLANE | 8 | NO | - |
| 854 | RAYWOOD ASH | 7 | YES | YES |
| 857 | CANARY ISLAND PINE | 22 | YES | - |
| 858 | CANARY ISLAND PINE | 15 | YES | - |
| 859 | CANARY ISLAND PINE | 24 | YES | - |
| 861 | CANARY ISLAND PINE | 20 | YES | - |
| 862 | CANARY ISLAND PINE | 17 | YES | - |
| 863 | CANARY ISLAND PINE | 23 | YES | - |
| 864 | CANARY ISLAND PINE | 17 | YES | - |
| 865 866 | CANARY ISLAND PINE CANARY ISLAND PINE | 5 19 | NO YES | - |
| 867 | CANARY ISLAND PINE | 5 | NO NO | - |
| 869 | CANARY ISLAND PINE | 19 | YES | _ |
| 870 | CANARY ISLAND PINE | 20 | YES | _ |
| 871 | CANARY ISLAND PINE | 5 | NO | - |
| 872 | CANARY ISLAND PINE | 6 | NO | _ |
| 873 | CANARY ISLAND PINE | 17 | YES | - |
| 875 | CANARY ISLAND PINE | 20 | YES | - |
| 877 | CANARY ISLAND PINE | 17 | YES | - |
| 878 | CANARY ISLAND PINE | 5 | NO | - |
| 879 | CANARY ISLAND PINE | 16 | YES | - |
| 880 | CANARY ISLAND PINE | 16 | YES | - |
| 881 | CANARY ISLAND PINE | 17 | YES | - |
| 883 | CANARY ISLAND PINE | 15 | YES | - |
| 884 | NORWAY MAPLE | 5 | NO | - |
| 885 | NORWAY MAPLE | 4 | NO | - |
| 887 | NORWAY MAPLE | 7 | NO | YES |
| 888 | COAST REDWOOD | 15 | YES | YES |
| 889 | COAST REDWOOD | 30 | YES | YES |
| 890 | COAST REDWOOD | 25 | YES | YES |
| 893 | COAST REDWOOD | 25 | YES | YES |
| 894 | CALIFORNIA PEPPER | 9 | NO | - |
| 908 | CALIFORNIA PEPPER | 14 | YES | YES |
| 909 | CALIFORNIA PEPPER | 15 | YES | YES |
| 910 | CALIFORNIA PEPPER | 11 | YES | YES |
| 911 912 | DEODAR CEDAR CALIFORNIA PEPPER | 33 | YES YES | YES YES |
| 912 | CALIFORNIA PEPPER | 17 | YES | YES |
| 913 | CALIFORNIA PEPPER | 8 | YES | YES |
| 915 | CALIFORNIA PEPPER | 15 | YES | YES |
| 916 | CALIFORNIA PEPPER | 24 | YES | YES |
| 917 | CALIFORNIA PEPPER | 8 | YES | YES |
| 918 | CALIFORNIA PEPPER | 33 | YES | YES |
| 919 | COAST REDWOOD | 32 | YES | YES |
| 920 | CALIFORNIA PEPPER | 19 | YES | YES |
| 921 | COAST REDWOOD | 13 | YES | YES |
| 922 | COAST REDWOOD | 10 | YES | - |
| 923 | BLACKWOOD ACACIA | 15 | YES | - |
| 926 | COAST REDWOOD | 17 | YES | - |
| 927 | COAST REDWOOD | 21 | YES | - |
| 930 | COAST REDWOOD | 14 | YES | - |
| 932 | COAST REDWOOD | 13 | YES | - |
| 934 | COAST REDWOOD | 16 | YES | - |
| 936 | COAST REDWOOD | 17 | YES | YES |
| 937 | COAST REDWOOD | 4 | YES | - |
| 939 | COAST REDWOOD | 10 | YES | - |
| 941 | COAST REDWOOD | 33 | YES | - |
| | COAST REDWOOD | 29 | YES | - |
| 942 | OO A OT DEDWOOD | 28 | YES | - |
| 943 | COAST REDWOOD | | VEC | |
| 943 944 | COAST REDWOOD | 17 | YES | - |
| 943 944 945 | COAST REDWOOD COAST REDWOOD | 17 25 | YES | - |
| 943 944 945 946 | COAST REDWOOD COAST REDWOOD COAST REDWOOD | 17 25 21 | YES YES | - - - |
| 943 944 945 946 947 | COAST REDWOOD COAST REDWOOD COAST REDWOOD COAST REDWOOD | 17 25 21 23 | YES YES YES | - - - - |
| 943 944 945 946 947 948 | COAST REDWOOD COAST REDWOOD COAST REDWOOD COAST REDWOOD COAST REDWOOD | 17 25 21 23 25 | YES YES YES YES | - - - - |
| 943 944 945 946 947 948 949 | COAST REDWOOD COAST REDWOOD COAST REDWOOD COAST REDWOOD COAST REDWOOD COAST REDWOOD | 17 25 21 23 25 25 | YES YES YES YES YES | - - - - - |
| 943 944 945 946 947 948 949 | COAST REDWOOD | 17 25 21 23 25 25 25 | YES YES YES YES YES YES | - - - - - - |
| 943 944 945 946 947 948 949 950 | COAST REDWOOD | 17 25 21 23 25 25 25 15 | YES YES YES YES YES YES YES YES | - - - - - - - |
| 943 944 945 946 947 948 949 950 951 | COAST REDWOOD | 17 25 21 23 25 25 25 15 24 | YES | - - - - - - - - |
| 943 944 945 946 947 948 949 950 | COAST REDWOOD | 17 25 21 23 25 25 25 15 | YES YES YES YES YES YES YES YES | - - - - - - - - |

| TREE TAG | | | PROTECTED | REMOVED BY |
|--------------|--|------------|------------|-----------------|
| NUMBER | SPECIES | DBH (IN.)* | TREE? | THIS PROJECT?** |
| 959 961 | CANARY ISLAND PINE CANARY ISLAND PINE | 20 | NO YES | - |
| 963 | CANARY ISLAND PINE | 17 | YES | - |
| 965 | CANARY ISLAND PINE | 18 | YES | - |
| 967 | CANARY ISLAND PINE | 18 | YES | - |
| 969 970 | CANARY ISLAND PINE CANARY ISLAND PINE | 16 | YES YES | - |
| 971 | CANARY ISLAND PINE | 22 | YES | - |
| 972 | CANARY ISLAND PINE | 21 | YES | - |
| 973 976 | CANARY ISLAND PINE CANARY ISLAND PINE | 5 20 | NO YES | - |
| 978 | CANARY ISLAND PINE | 18 | YES | - |
| 979 | CANARY ISLAND PINE | 21 | YES | - |
| 980 | CANARY ISLAND PINE CANARY ISLAND PINE | 19 | YES YES | - |
| 984 | CANARY ISLAND PINE CANARY ISLAND PINE | 20 | YES | - |
| 986 | CANARY ISLAND PINE | 21 | YES | - |
| 988 | CANARY ISLAND PINE | 16 | YES | - |
| 989 991 | CANARY ISLAND PINE CANARY ISLAND PINE | 17 25 | YES YES | - |
| 991 | CANARY ISLAND PINE CANARY ISLAND PINE | 16 | YES | - |
| 995 | CANARY ISLAND PINE | 15 | YES | - |
| 997 | CANARY ISLAND PINE | 22 | YES | - |
| 998 | CANARY ISLAND PINE | 17 | YES | - |
| 1000 | CANARY ISLAND PINE CANARY ISLAND PINE | 17 | YES YES | - |
| 1002 | COAST REDWOOD | 30 | YES | - |
| 1004 | CANARY ISLAND PINE | 19 | YES | - |
| 1005 | COAST REDWOOD | 29 | YES | - |
| 1006 | SWEETGUM SWEETGUM | 11 | YES YES | - |
| 1008 | LONDON PLANE | 14 | NO | - |
| 1009 | CALIFORNIA PEPPER | 26 | YES | - |
| 1010 | COAST REDWOOD | 28 | YES | - |
| 1011 | COAST REDWOOD COAST REDWOOD | 24 | YES YES | - |
| 1012 | COAST REDWOOD | 22 | YES | - |
| 1014 | COAST REDWOOD | 24 | YES | - |
| 1015 | COAST REDWOOD | 16 | YES | - |
| 1016 1017 | COAST REDWOOD COAST REDWOOD | 23 | YES YES | - |
| 1017 | COAST REDWOOD | 19 | YES | - |
| 1019 | COAST REDWOOD | 18 | YES | - |
| 1020 | COAST REDWOOD | 22 | YES | - |
| 1021 | COAST REDWOOD COAST REDWOOD | 24 | YES YES | - |
| 1022 | COAST REDWOOD COAST REDWOOD | 19 | YES | - |
| 1024 | COAST REDWOOD | 24 | YES | - |
| 1025 | COAST REDWOOD | 24 | YES | - |
| 1026 | COAST REDWOOD | 22 | YES YES | - |
| 1027 1028 | COAST REDWOOD COAST REDWOOD | 27 | YES | YES |
| 1029 | COAST REDWOOD | 25 | YES | YES |
| 1030 | COAST REDWOOD | 19 | YES | YES |
| 1031 | COAST REDWOOD | 19 | YES | YES |
| 1032 | COAST REDWOOD COAST REDWOOD | 23 15 | YES YES | YES YES |
| 1034 | COAST REDWOOD | 26 | YES | YES |
| 1035 | COAST REDWOOD | 20 | YES | YES |
| 1036 | COAST REDWOOD | 21 | YES | YES |
| 1037 | COAST REDWOOD COAST REDWOOD | 18 | YES YES | YES YES |
| 1039 | COAST REDWOOD | 24 | YES | YES |
| 1040 | COAST REDWOOD | 22 | YES | YES |
| 1041 | COAST REDWOOD | 21 | YES | YES |
| 1042 | COAST REDWOOD COAST REDWOOD | 21 | YES YES | YES YES |
| 1043 | COAST REDWOOD COAST REDWOOD | 11 | YES | YES |
| 1045 | COAST REDWOOD | 23 | YES | YES |
| 1046 | COAST REDWOOD | 18 | YES | YES |
| 1047 | COAST REDWOOD COAST REDWOOD | 20 | YES YES | YES YES |
| 1046 | COAST REDWOOD COAST REDWOOD | 20 | YES | YES |
| 1050 | COAST REDWOOD | 27 | YES | YES |
| 1051 | CALIEODNIA DEDDED | 23 | VEQ | VEC |

CALIFORNIA PEPPER

23

YES

| TREE TAG NUMBER | SPECIES | DBH (IN.)* | PROTECTED TREE? | REMOVED BY THIS PROJECT?** |
|--------------------|--------------------|------------|-----------------|----------------------------------|
| 1052 | RAYWOOD ASH | 19 | YES | YES |
| 1401 | GLOSSY PRIVET | 4 | YES | YES |
| 1402 | LOMBARDY POPLAR | 4 | NO | YES |
| 1403 | LOMBARDY POPLAR | 4 | NO | YES |
| 1404 | LOMBARDY POPLAR | 4 | NO | YES |
| 1405 | LOMBARDY POPLAR | 5 | NO | YES |
| 1406 | MARINA MADRONE | 5 | NO | TRANSPLANT |
| 1407 | LOMBARDY POPLAR | 7,5 | NO | TRANSPLANT |
| 1408 | LOMBARDY POPLAR | 11 | NO | TRANSPLANT |
| 1409 | FREMONT COTTONWOOD | 10 | NO | TRANSPLANT |
| 1410 | FREMONT COTTONWOOD | 9 | NO | TRANSPLANT |
| 1411 | FREMONT COTTONWOOD | 9 | NO | TRANSPLANT |
| 1412 | FREMONT COTTONWOOD | 10 | NO | TRANSPLANT |
| 1413 | FREMONT COTTONWOOD | 9 | NO | TRANSPLANT |
| 1414 | TULIP TREE | 4 | NO | TRANSPLANT |
| 1415 | FREMONT COTTONWOOD | 5 | NO | TRANSPLANT |
| 1416 | LONDON PLANE | 8 | NO | - |
| 1417 | AUSTRALIAN WILLOW | 4 | NO | TRANSPLANT |
| 1418 | FREMONT COTTONWOOD | 5 | NO | TRANSPLANT |
| 1419 | TRIDENT MAPLE | 4 | NO | TRANSPLANT |
| 1420 | HACKBERRY | 4 | NO | TRANSPLANT |
| 1421 | MARINA MADRONE | 4 | NO | TRANSPLANT |
| 1422 | GLOSSY PRIVET | 5,4 | NO | - |
| 1423 | GLOSSY PRIVET | 7,6 | NO | - |
| 1424 | GLOSSY PRIVET | 7,2,2,2 | NO | - |
| 1425 | GLOSSY PRIVET | 5,3 | NO | - |
| 1426 | GLOSSY PRIVET | 4,4 | NO | - |
| 1427 | GLOSSY PRIVET | 5,3 | NO | - |


*DIAMETER OF THE TREE MEASURED 54 INCHES ABOVE NATURAL GRADE, OR JUST BELOW THE FIRST MAJOR TRUNK FORK FOR MULTI-BRANCHED TREES WHICH HAVE MAJOR BRANCHES BELOW 54 INCHES ABOVE NATURAL GRADE.

**COORDINATE REVIEW BY OWNER'S ARBORIST OF ALL EXISTING TREES IN CONTAINERS ALONG GREENWAY FOR SUITABILITY FOR TRANSPLANT (BASED ON CURRENT HEALTH AND LIKELIHOOD OF TRANSPLANT SUCCESS).

NOTES:

1. ALL REDWOODS TO REMAIN NORTH OF GREENWAY SHALL HAVE THE CURRENT METHOD OF IRRIGATION MAINTAINED AS SHOWN ON SHEET LIR-101A. BIORETENTION AREAS RECEIVING RECYCLED WATER SHALL BE DELINEATED WITH CONCRETE HEADER AS SHOWN ON SHEET L102A.

TREE PROTECTION ZONE FENCE

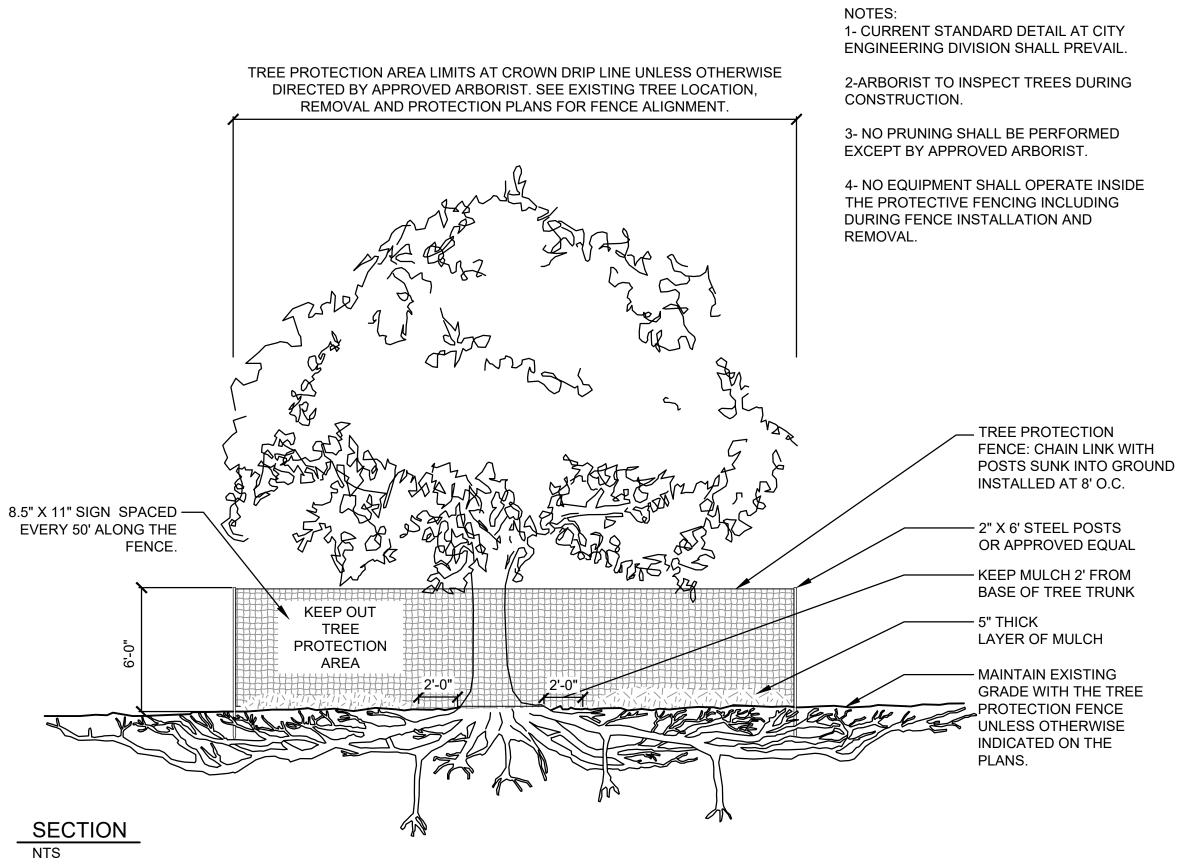



HUFF PARKING STRUCTURE

FACADE DESIGNER:

STRUCTURAL ENGINEER:

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TEL: (925)455-2751 URBAN PLANNER:

> SERA DESIGN 304 12th St., Suite 3A, Oakland, CA 94607, TEL: (510) 480-4988

LANDSCAPE ARCHITECT & ECOLOGIST: H.T. HARVEY & ASSOCIATES

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50 WEST SAN FERNANDO STREET SUITE 950, SAN JOSE, CA 95113

TEL: (408) 971-7300 REV DESCRIPTION: DATE:

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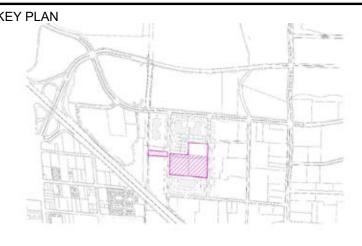
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CITY OF MOUNTAIN VIEW, CA KEY PLAN



TREE DISPOSITION SCHEDULE AND TREE PROTECTION DETAILS

SEAL & SIGNATURE:

L_TREE PROTECTION_SAFETY NETTING_32

05/26/20 PROJECT No: 3475-65 SCALE: AS SHOWN FORMAT: ARCH D REV: DRAWN: LD, CG CHK: JMH, KV

TREE DISPOSITION SCHEDULE - 900 ALTA

| TREE TAG NUMBER | SPECIES | DBH (IN.)* | PROTECTED TREE? | REMOVED BY THIS PROJECT? |
|--------------------|----------------------|------------|-----------------|--------------------------------|
| 711 | CALIFORNIA PEPPER | 10 | YES | YES |
| 712 | CHINESE PISTACHE | 11 | NO | YES |
| 713 | CHINESE PISTACHE | 8 | NO | YES |
| 714 | COAST REDWOOD | 17 | YES | YES |
| 715 | COAST REDWOOD | 13 | YES | YES |
| 716 | COAST REDWOOD | 16 | YES | YES |
| 717 | COAST REDWOOD | 12 | NO | - |
| 718 | COAST REDWOOD | 14 | YES | - |
| 719 | COAST REDWOOD | 17 | YES | - |
| 720 | COAST REDWOOD | 17 | YES | - |
| 721 | WASHINGTON HAWTHORNE | 3 | NO | YES |
| 722 | WASHINGTON HAWTHORNE | 5 | NO | - |
| 723 | WASHINGTON HAWTHORNE | 5 | NO | - |
| 724 | CHINESE PISTACHE | 10 | NO | YES |
| 725 | WASHINGTON HAWTHORNE | 4 | NO | - |
| 726 | WASHINGTON HAWTHORNE | 4 | NO | - |
| 727 | WASHINGTON HAWTHORNE | 5 | NO | - |
| 728 | CHINESE PISTACHE | 7 | NO | YES |
| 729 | WASHINGTON HAWTHORNE | 4 | NO | - |
| 730 | WASHINGTON HAWTHORNE | 3 | NO | - |
| 731 | CALIFORNIA PEPPER | 26 | YES | - |
| 732 | CALIFORNIA PEPPER | 15 | YES | - |
| 733 | CALIFORNIA PEPPER | 12 | NO | - |
| 734 | CALIFORNIA PEPPER | 15 | YES | - |
| 735 | CALIFORNIA PEPPER | 16 | YES | YES |
| 736 | CALIFORNIA PEPPER | 18 | YES | YES |
| 737 | CALIFORNIA PEPPER | 15 | YES | YES |
| 738 | CALIFORNIA PEPPER | 12 | NO | YES |
| 739 | WASHINGTON HAWTHORNE | 5 | NO | - |
| 741 | CHINESE PISTACHE | 12 | NO | YES |
| 746 | CHINESE PISTACHE | 9 | NO | YES |
| 747 | CHINESE PISTACHE | 13 | NO | YES |

*DIAMETER OF THE TREE MEASURED 54 INCHES ABOVE NATURAL GRADE, OR JUST BELOW THE FIRST MAJOR TRUNK FORK FOR MULTI-BRANCHED TREES WHICH HAVE MAJOR BRANCHES BELOW 54 INCHES ABOVE NATURAL GRADE.

NOTES:

 ALL REDWOODS PLANNED TO REMAIN SHALL BE IRRIGATED WITH POTABLE WATER AS SHOWN ON SHEET LIR-101B. AREAS RECEIVING POTABLE WATER SHALL BE DELINEATED WITH CONCRETE HEADER AS SHOWN ON SHEET L102B.



HUFF PARKING STRUCTURE

CLIENT:

GOOGLE LLC.

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TEL: (408)298-3134

TEL: (925)455-2751

URBAN PLANNER:

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TEL: (408) 458-3200

WMH

50 WEST SAN FERNANDO STREET SUITE 950,
SAN JOSE, CA 95113
TEL: (408) 971-7300

REV DESCRIPTION: DATE:

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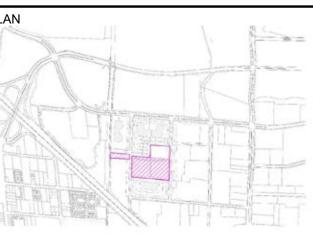
CONSULTANT



PROJECT:

HUFF PARKING STRUCTURE CITY OF MOUNTAIN VIEW, CA

KEY PLAN



TREE DISPOSITION SCHEDULE 900 ALTA


SEAL & SIGNATURE:

DRAWING TITLE:

DATE 05/26/20
PROJECT No: 3475-65
SCALE: AS SHOWN
FORMAT: ARCH D
DRAWN: LD, CG
CHK: JMH, KV
DWG No:

L005B

SAMPLE PLANT PALETTE

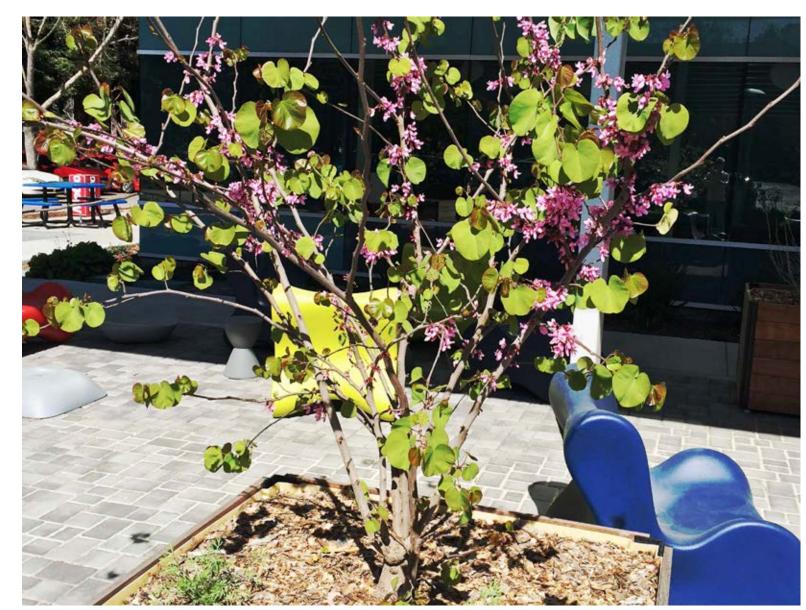

CERCIS OCCIDENTALIS (WESTERN REDBUD)



ACHILLEA X 'MOONSHINE' (MOONSHINE YARROW)



ARCTOSTAPHYLOS SPP. (MANZANITA)



QUERCUS LOBATA (VALLEY OAK)



EPILOBIUM CANUM (CALIFORNIA FUCHSIA)



SALVIA SPATHACEA (HUMMINGBIRD SAGE)
SOURCE: FLICKR (briweldon_CCby2.0_20200330)



IRIS DOUGLASIANA 'PURPLE' (DOUGLAS IRIS)



RIBES SANGUINEUM (FLOWERING CURRANT)



CEANOTHUS THYRSIFLORUS (BLUEBLOSSOM CEANOTHUS)

304 12th St., Suite 3A, Oakland, CA 94607, TEL: (510) 480-4988

LANDSCAPE ARCHITECT & ECOLOGIST:

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983 Unversity Ave. Building D, Los Gatos, CA 95032 TEL: (408) 458-3200

VIL:

WMH

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ARCHITECT OF RECORD:

STRUCTURAL ENGINEER:

ELECTRICAL DESIGN BUILDER:

FIRE PROTECTION DESIGN BUILDER:

FACADE DESIGNER:

| | REV | REV DESCRIPTION: | | | | |
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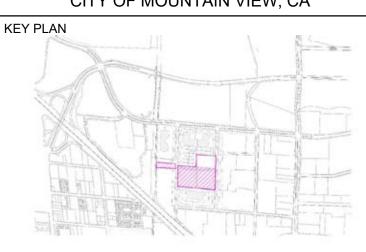
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CITY OF MOUNTAIN VIEW, CA




MATERIALS SCHEDULE (1)

| SEAL & SIGNATURE: | DATE | 05/26/ |
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| | PROJECT No: | 3475 |
| | SCALE: AS SHOWN | |
| | FORMAT: ARCH D | REV: |
| | DRAWN: LD, CG | 00 |
| | CHK: JMH, KV | |
| | DWG No: | |
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L100


SAMPLE HARDSCAPE & SITE FURNISHINGS

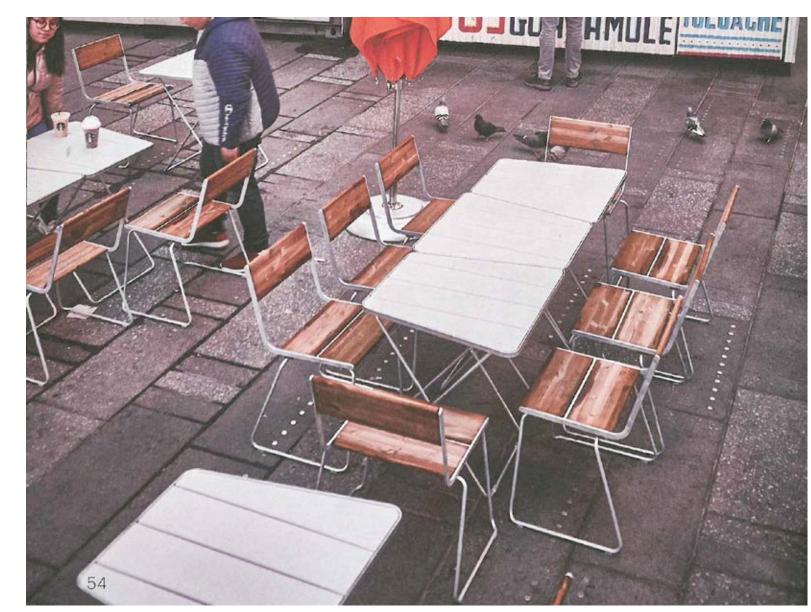

SAMPLE CAFE TABLES & CHAIRS SOURCE: VESTRE (https://vestre.com/us/)




SAMPLE PAVING - CONCRETE - SEEDED

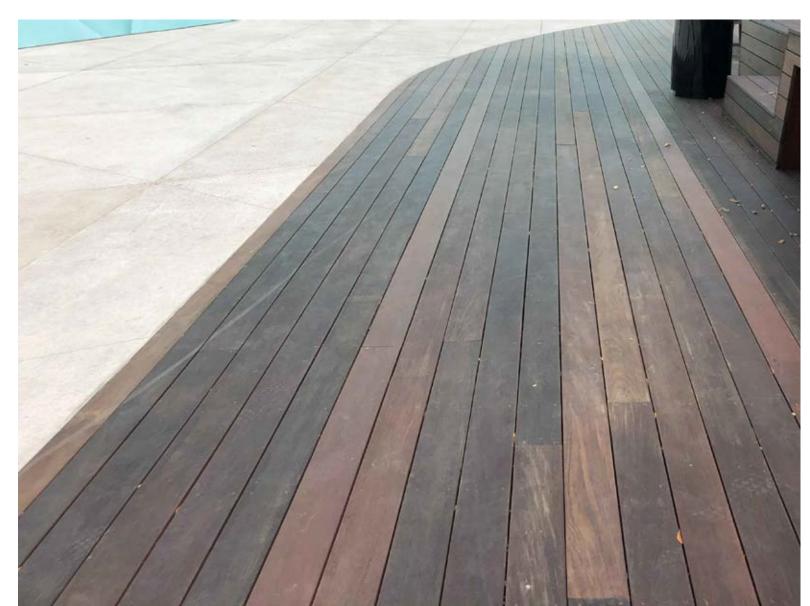

SAMPLE DECKING



SAMPLE COMPOST, LANDFILL & RECYCLE BINS

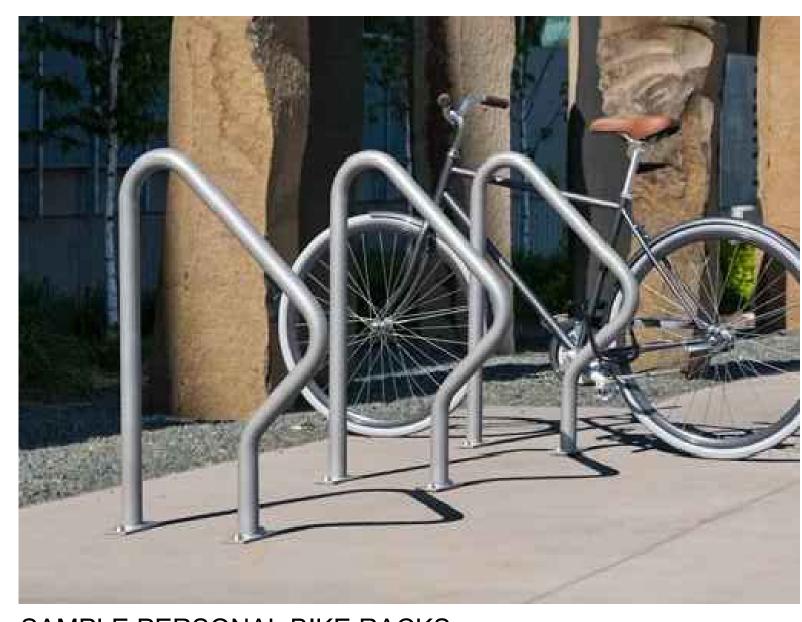


SAMPLE PERSONAL BIKE RACKS SOURCE: DERO (https://www.dero.com/product/swerve-rack/)




SAMPLE LIGHTING ALONG GREENWAY



SAMPLE MOVABLE UMBRELLAS SOURCE: LANDSCAPEFORMS (https://www.landscapeforms.com)

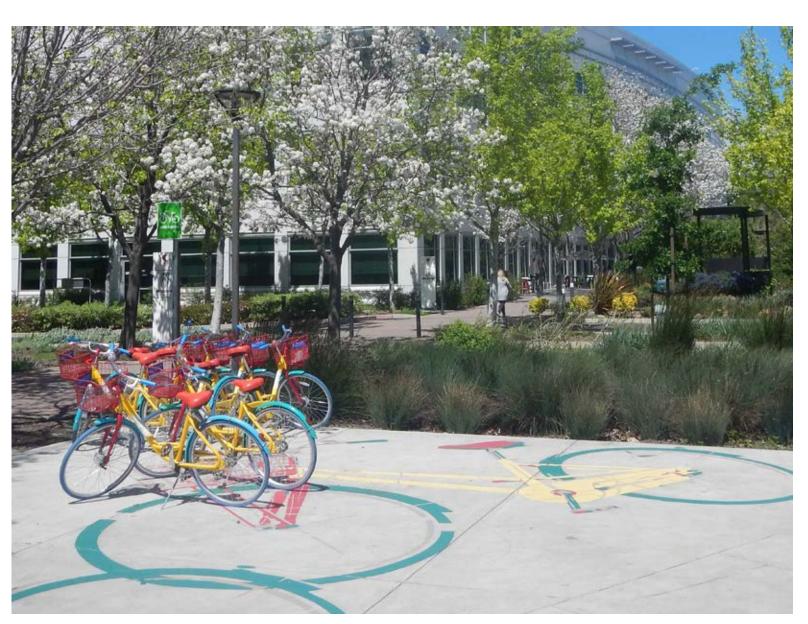

SAMPLE G-BIKE PARKING

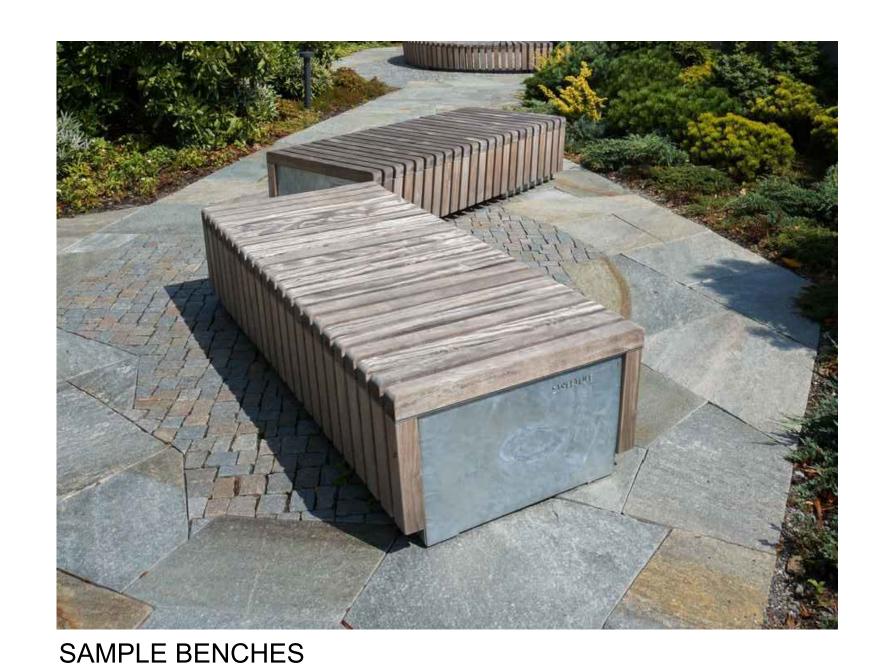

SOURCE: STREETLIFE (https://www.streetlife.nl/en/products/solid-skirt-benches) ALL PHOTOS BY H. T. HARVEY & ASSOCIATES UNLESS OTHERWISE NOTED



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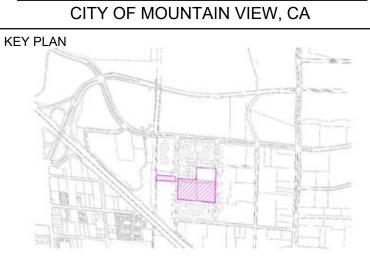
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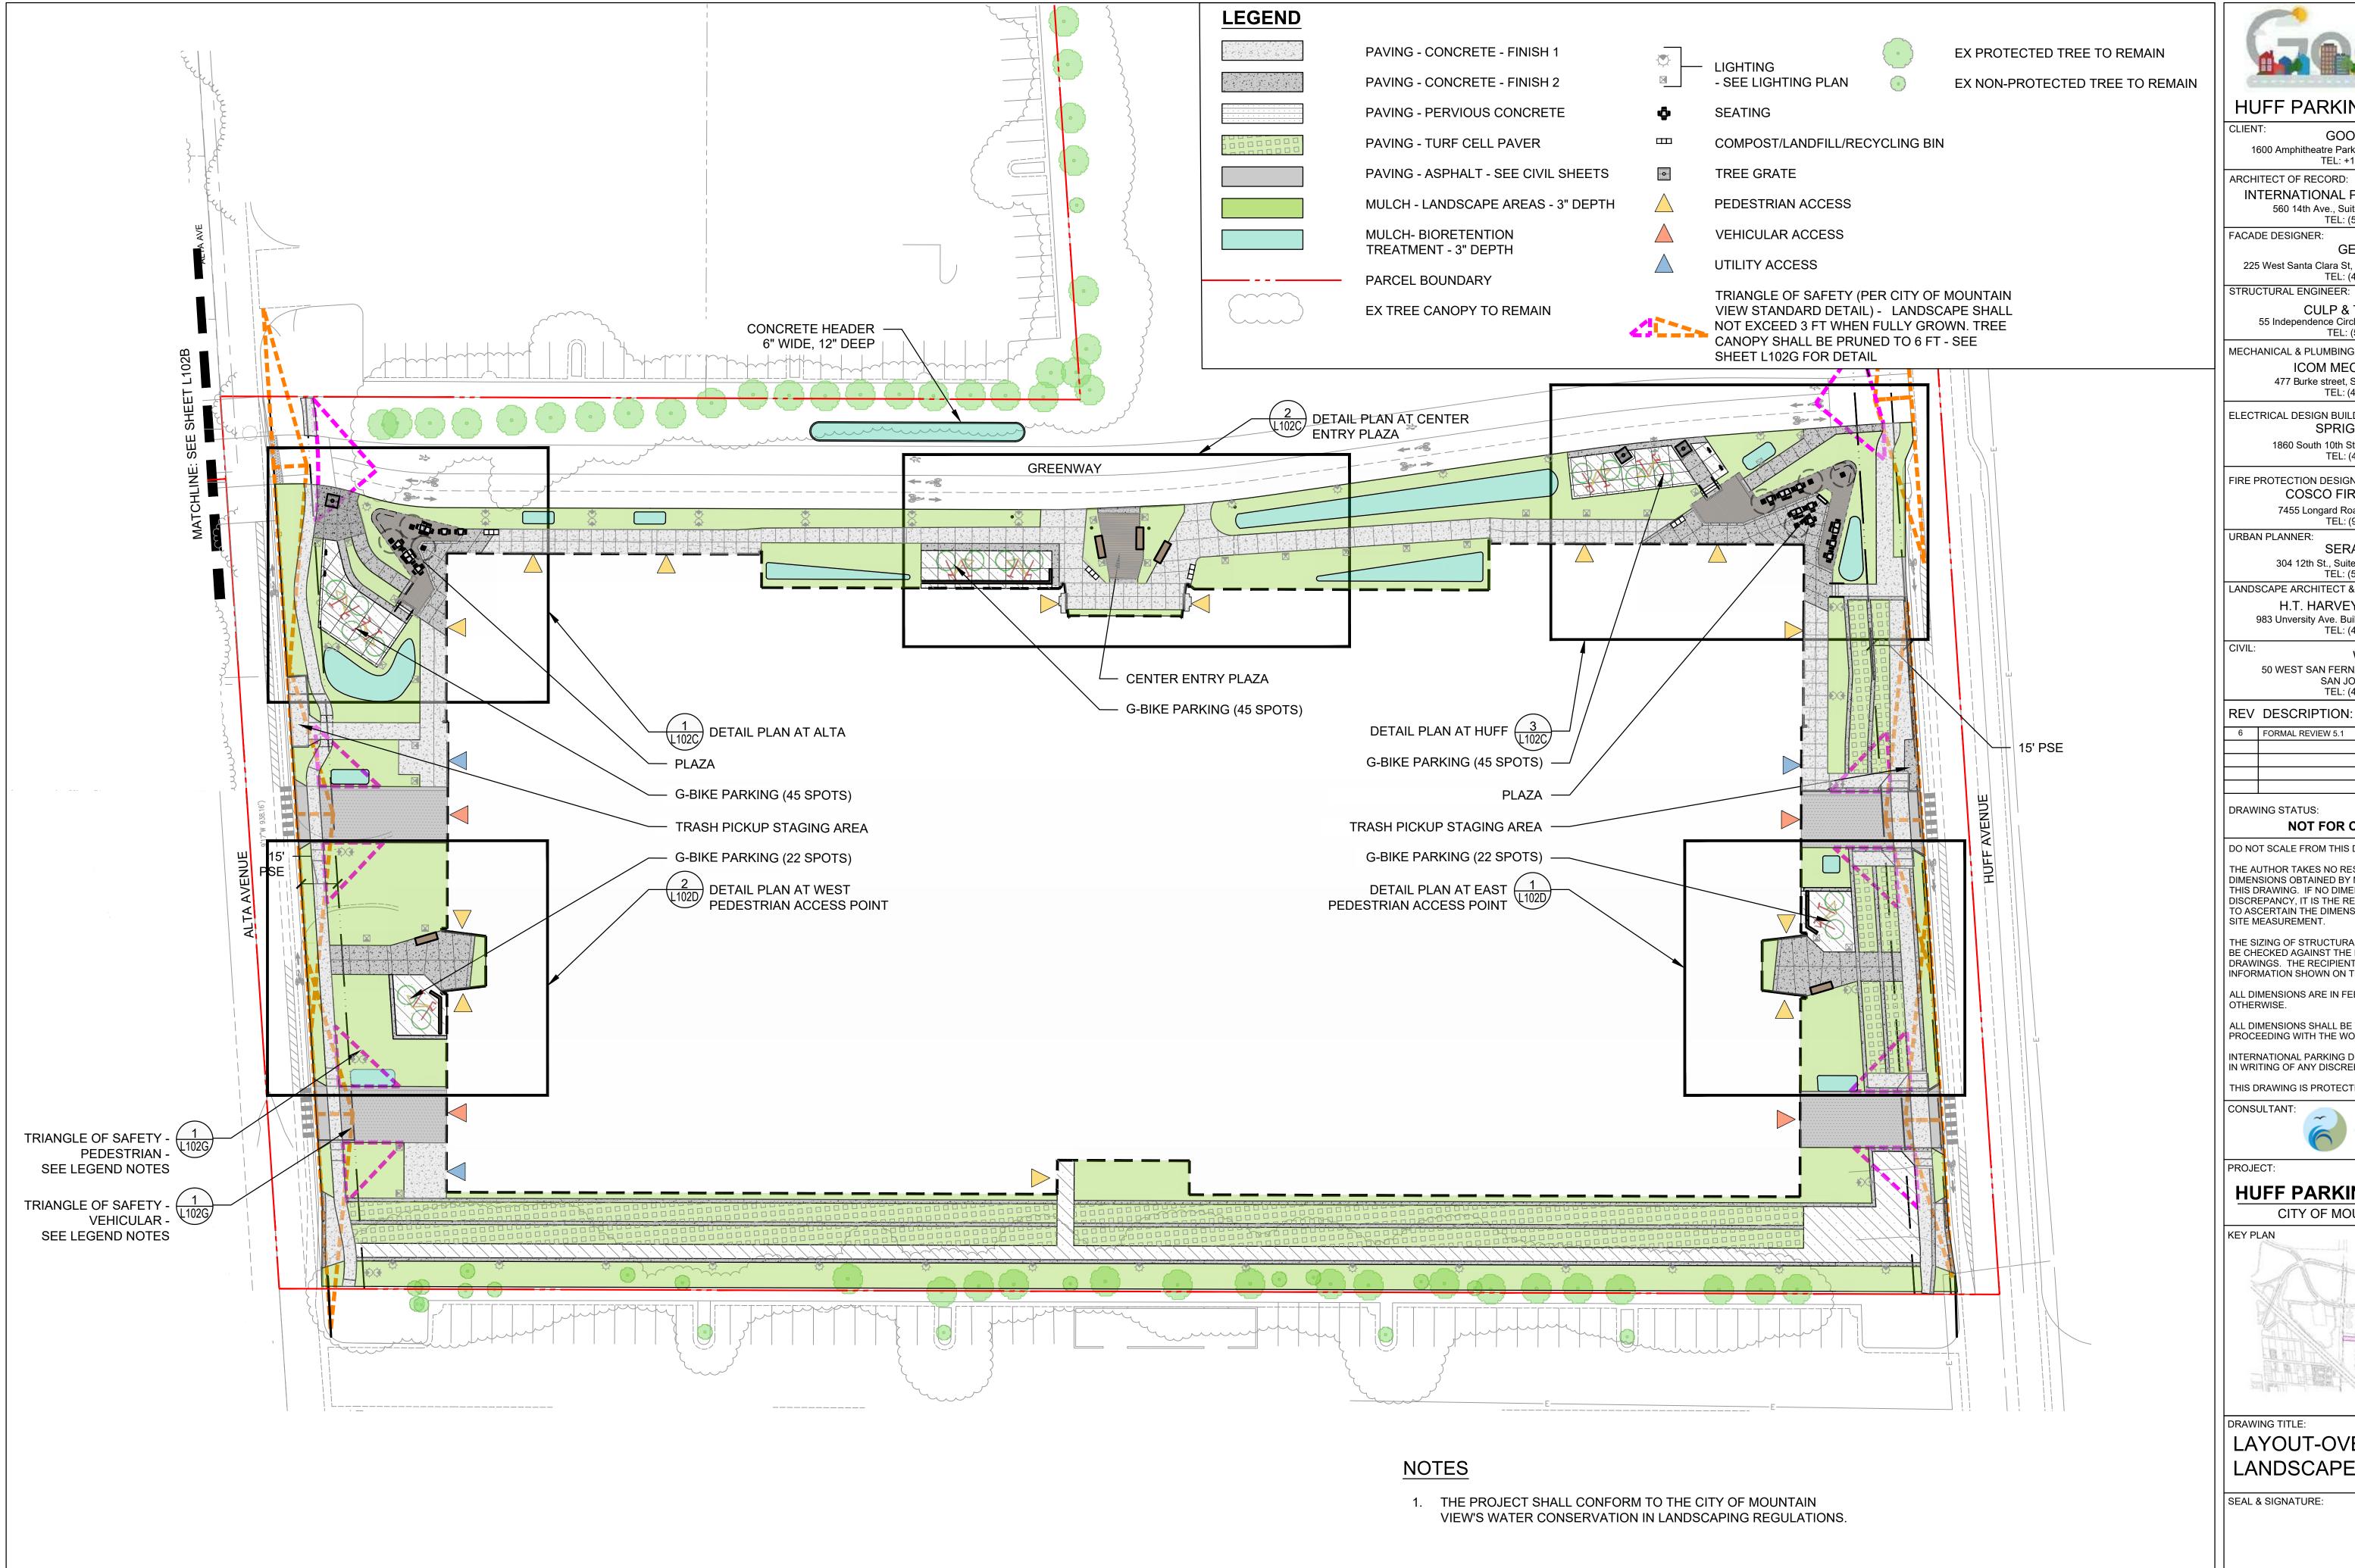
HUFF PARKING STRUCTURE



MATERIALS SCHEDULE(2)

SEAL & SIGNATURE: PROJECT No: SCALE: AS SHOWN FORMAT: ARCH D REV: DRAWN: LD, CG CHK: JMH, KV

L101





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DATE:

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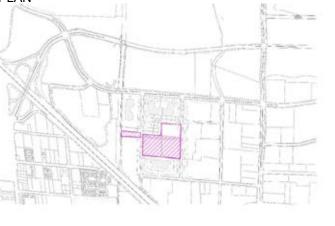
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120' - 0"


HUFF PARKING STRUCTURE CITY OF MOUNTAIN VIEW, CA


KEY PLAN



LAYOUT-OVERALL LANDSCAPE LAYOUT PLAN

| | L102 | 2A |
|-------------------|-----------------|-----------|
| | DWG No: | |
| | CHK: JMH, KV | |
| | DRAWN: LD, CG | 00 |
| | FORMAT: ARCH D | REV: |
| | SCALE: AS SHOWN | |
| | PROJECT No: | 3475-65 |
| SEAL & SIGNATURE: | DATE | 05/26/20 |
| | | |

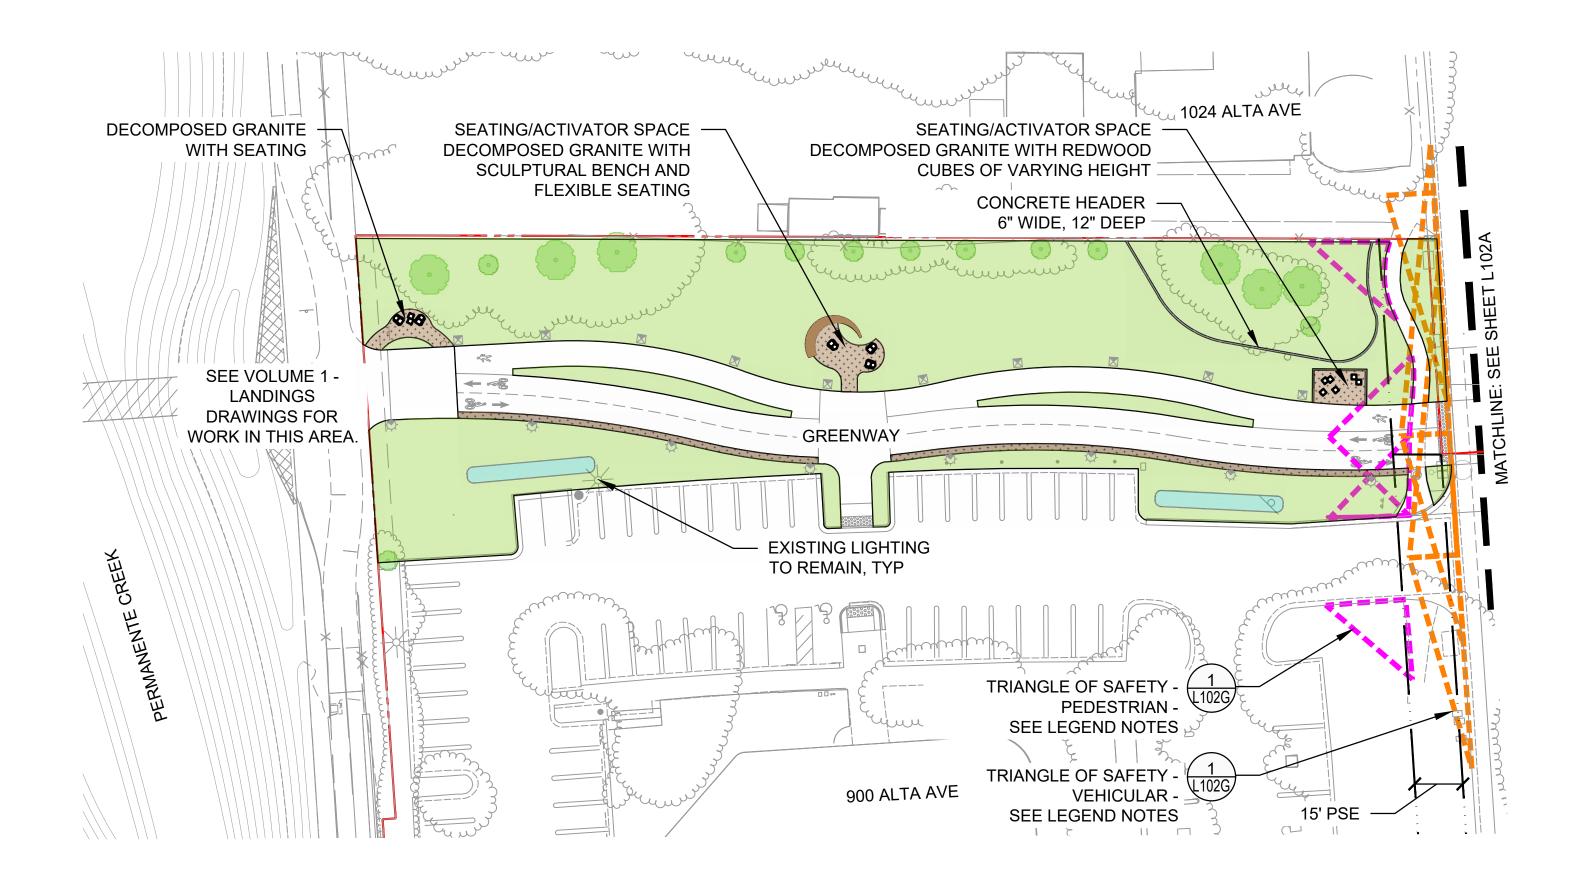

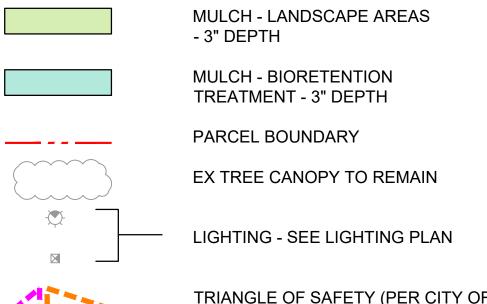

LEGEND

NOTES

EX PROTECTED TREE TO REMAIN

EX NON-PROTECTED TREE TO REMAIN

1. THE PROJECT SHALL CONFORM TO TO CITY OF MOUNTAIN

VIEW'S WATER CONSERVATION IN LANDSCAPING REGULATIONS.

TRIANGLE OF SAFETY (PER CITY OF MOUNTAIN VIEW STANDARD DETAIL) - LANDSCAPE SHALL NOT EXCEED 3 FT WHEN FULLY GROWN. TREE CANOPY SHALL BE PRUNED TO 6 FT - SEE SHEET L102G FOR DETAIL



HUFF PARKING STRUCTURE

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URBAN PLANNER:

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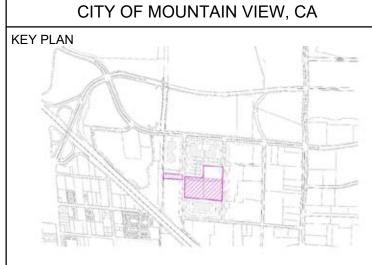
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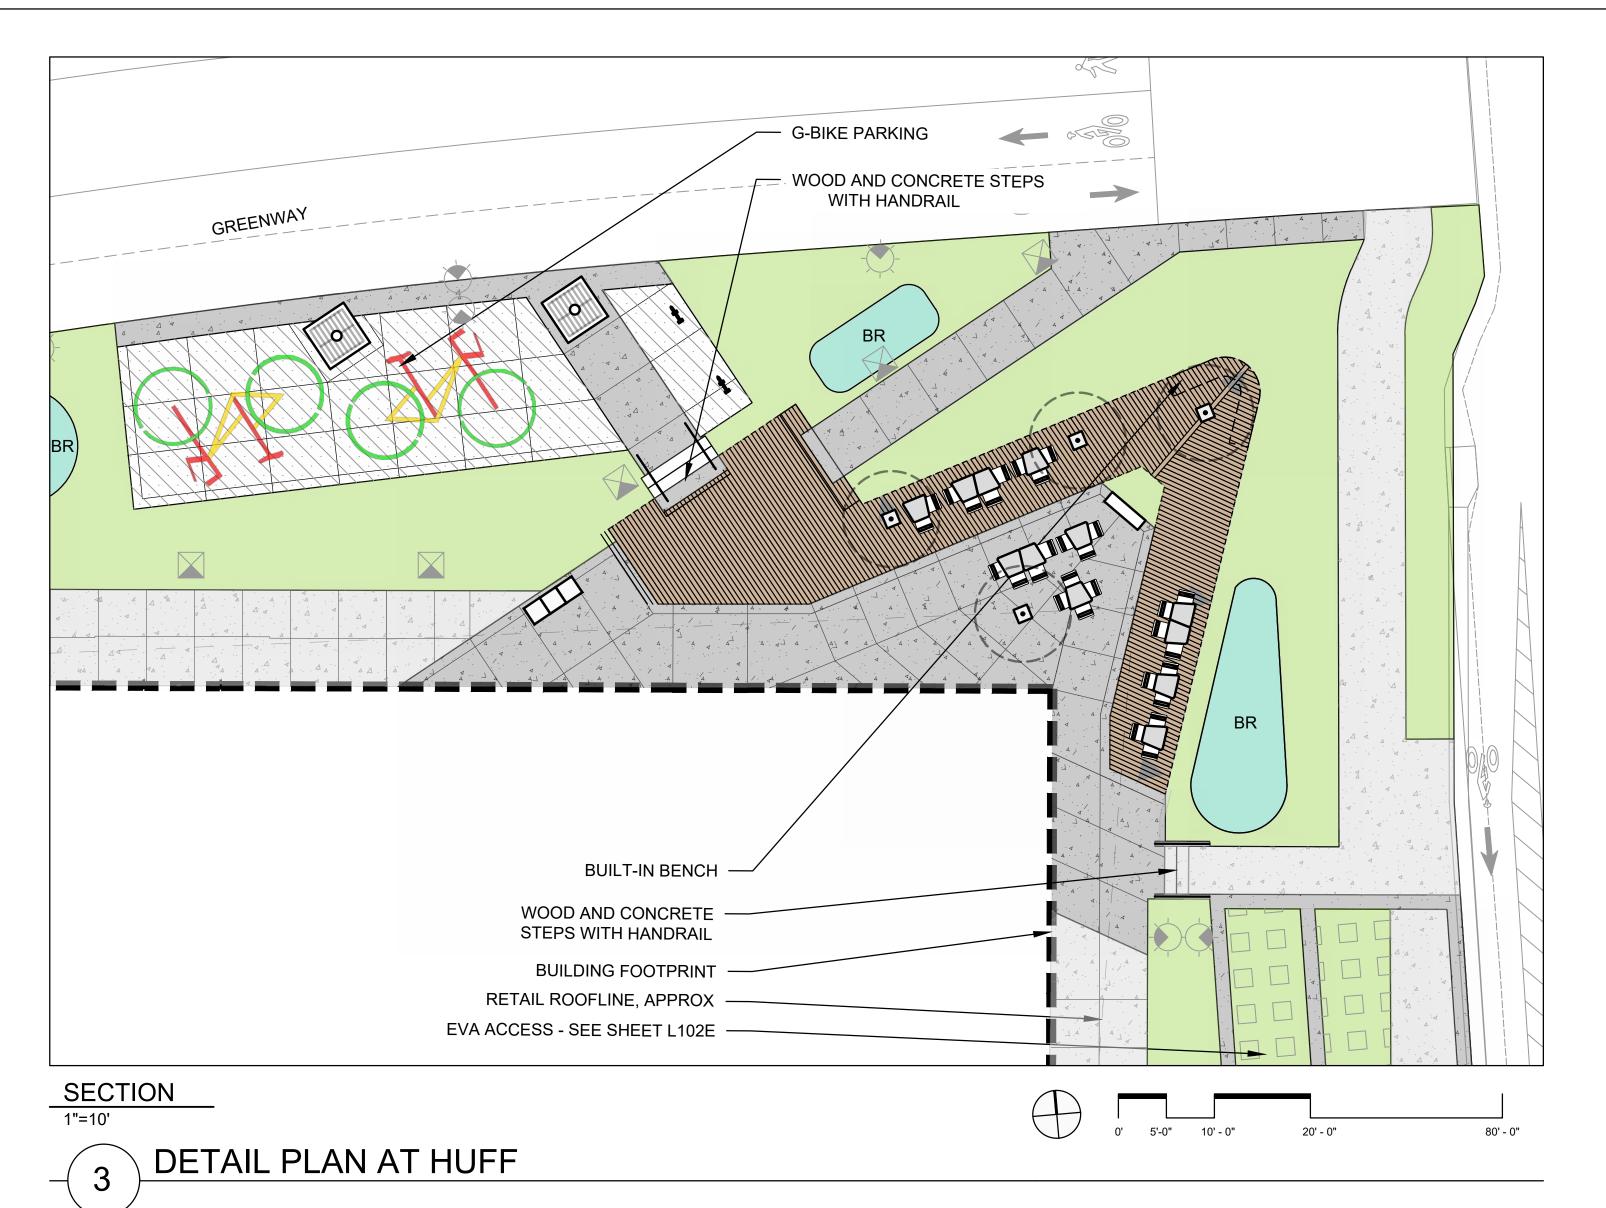
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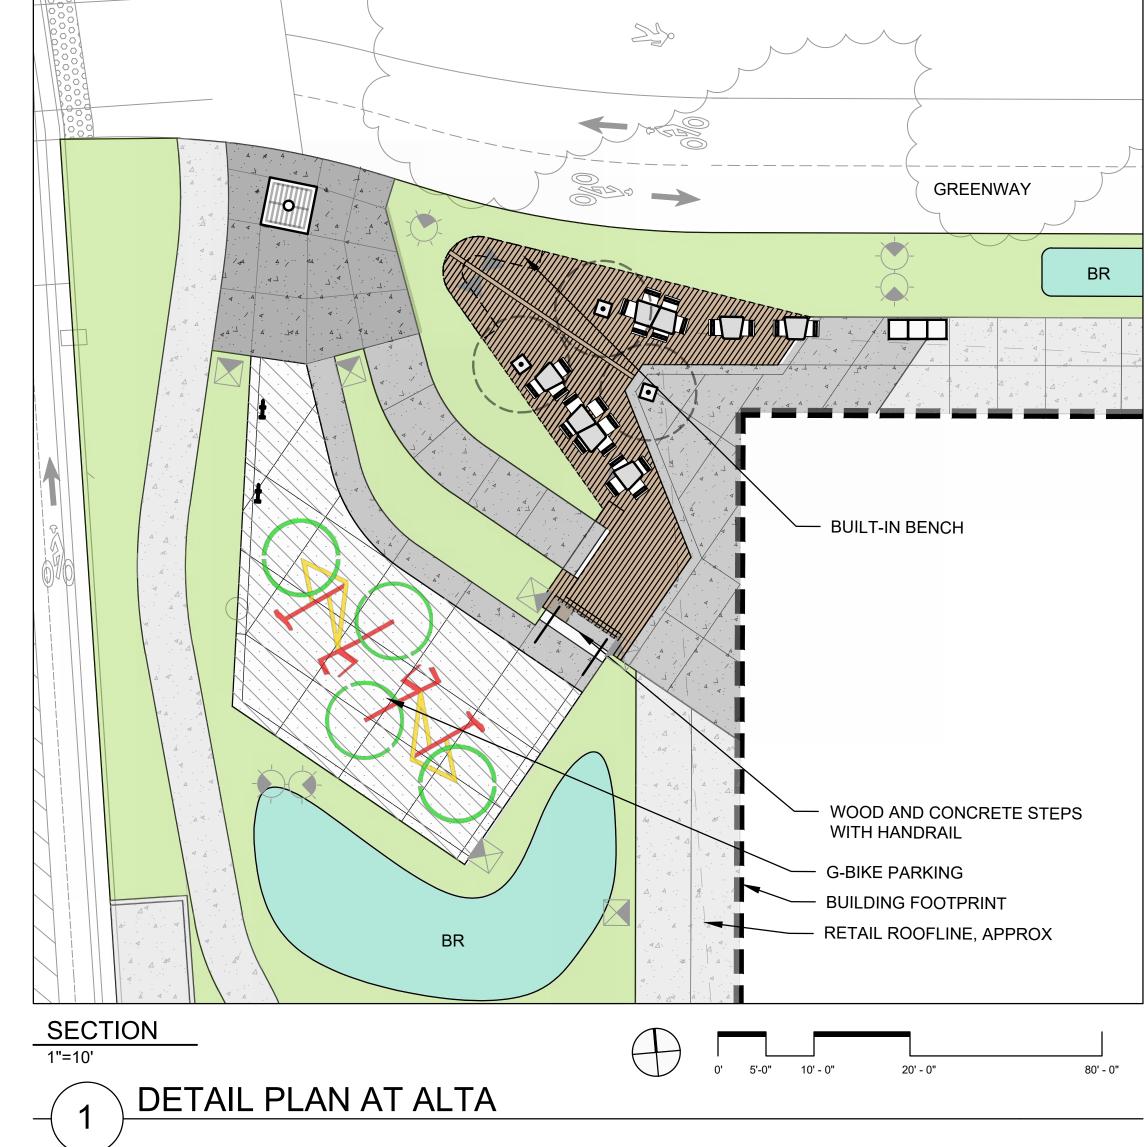


LANDSCAPE SITE LAYOUT PLAN 900 ALTA

| EAL & SIGNATURE: | DATE | 05/26/20 |
|------------------|-----------------|----------|
| | PROJECT No: | 3475-65 |
| | SCALE: AS SHOWN | |
| | FORMAT: ARCH D | REV: |
| | DRAWN: LD, CG | 06 |
| | CHK: JMH, KV | |
| | DWG No: | |
| | 1 | |

L102B 120' - 0"





LEGEND

PAVING - CONCRETE - FINISH 1 PAVING - CONCRETE - FINISH 2

PAVING - PERVIOUS CONCRETE PAVING - TURF CELL PAVER

PAVING - ASPHALT - SEE CIVIL SHEETS

MULCH - LANDSCAPE AREAS - 3" DEPTH MULCH - BIORETENTION AREAS - 3" DEPTH

PARCEL BOUNDARY

EX TREE CANOPY TO REMAIN

BIKE STENCIL - PER GOOGLE STANDARDS

NOTES

1. FOR CIRCULATION AND USE DIAGRAMS, SEE SHEET L102E.

SITE FURNISHING LEGEND

MOVABLE BISTRO TABLES &

COMPOST/LANDFILL/RECYCLING

LIGHTING - SEE LIGHTING PLAN

PERSONAL BIKE RACK

LARGE BENCH

MOVABLE UMBRELLA

TREE GRATE

MOVABLE BENCH

DETAIL PLAN AT CENTER ENTRY PLAZA





HUFF PARKING STRUCTURE

CLIENT: GOOGLE LLC.

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CITY OF MOUNTAIN VIEW, CA





DRAWING TITLE: LAYOUT-HUFF RETAIL AREA DETAIL

SEAL & SIGNATURE: DATE PROJECT No: 3475-65 SCALE: AS SHOWN FORMAT: ARCH D | REV: DRAWN: LD, CG CHK: JMH, KV

L102C



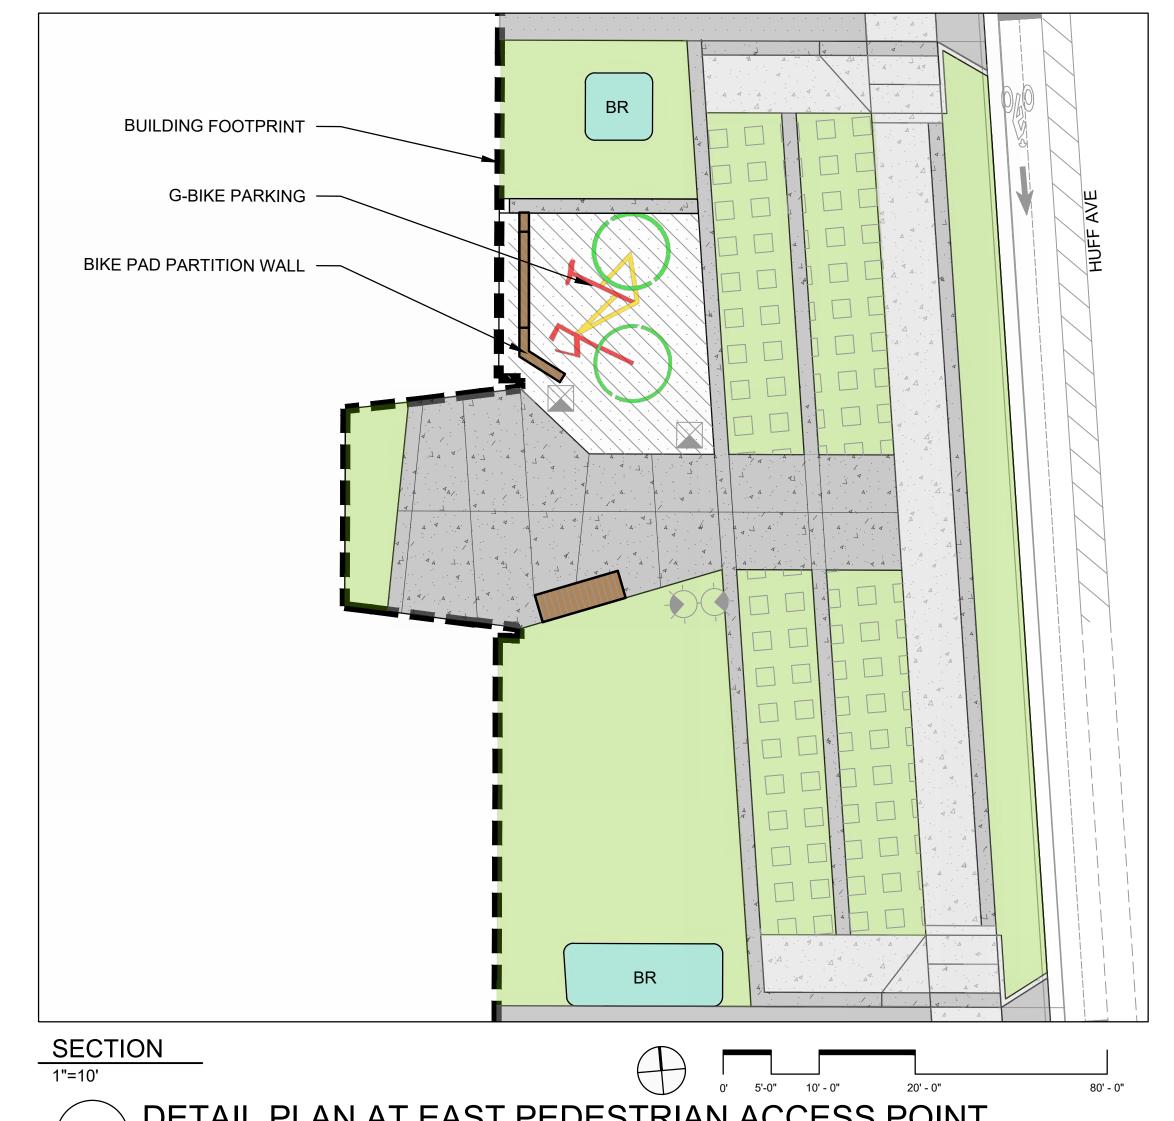

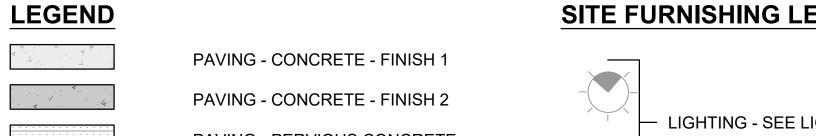

PAVING - PERVIOUS CONCRETE PAVING - TURF CELL PAVER PAVING - ASPHALT - SEE CIVIL SHEETS


PARCEL BOUNDARY

BIKE STENCIL

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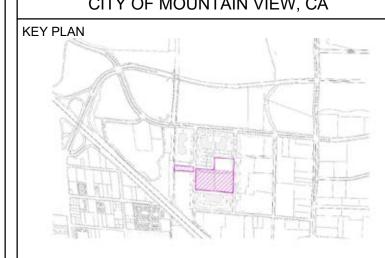
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SITE MEASUREMENT.

FACADE DESIGNER:

HUFF PARKING STRUCTURE

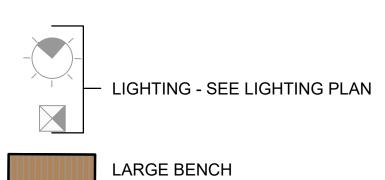CITY OF MOUNTAIN VIEW, CA



LAYOUT - HUFF AND ALTA PEDESTRIAN ENTRY POINTS

| SEAL & SIGNATURE: | DATE | 05/26/20 |
|-------------------|-----------------|------------|
| | PROJECT No: | 3475-65 |
| | SCALE: AS SHOWN | |
| | FORMAT: ARCH D | REV: |
| | DRAWN: LD, CG | 06 |
| | CHK: JMH, KV | |
| | DWG No: | |
| | L102 | 2 D |

DETAIL PLAN AT EAST PEDESTRIAN ACCESS POINT

MULCH - LANDSCAPE AREAS - 3" DEPTH

MULCH - BIORETENTION AREAS - 3" DEPTH

- PER GOOGLE STANDARDS

EX TREE CANOPY TO REMAIN

PLANTING SCHEDULES

FOUNDATION MIX

| SYMBOL | BOTANICAL NAME | COMMON NAME | WUCOLS | OC SPACING (FT) | SIZE |
|--------|--|-----------------------------|--------|-----------------|-------|
| | ACHILLEA MILLEFOLIUM | COMMON YARROW | L | 1 | 1 GAL |
| | ACHILLEA X 'MOONSHINE' | MOONSHINE YARROW | L | 1 | 1 GAL |
| | ARCTOSTAPHYLOS GLAUCA | BIG BERRY MANZANITA | VL | 8 | 1 GAL |
| | ARCTOSTAPHYLOS HOWARD MCMINN | HOWARD MCMINN MANZANITA | L* | 13 | 5 GAL |
| | ARCTOSTAPHYLOS SENTINEL | SENTINEL MANZANITA | L* | 6 | 5 GAL |
| | ARCTOSTAPHYLOS UVA-URSI | BEARBERRY MANZANITA | L | 3 | 1 GAL |
| | ASCLEPIAS CALIFORNICA | CALIFORNIA MILKWEED | L | 2 | 1 GAL |
| | ASCLEPIAS FASCICULARIS | NARROW LEAF MILKWEED | L | 1 | 1 GAL |
| | ASCLEPIAS SPECIOSA | SHOWY MILKWEED | L | 1 | 1 GAL |
| | CEANOTHUS GRISEUS HORIZONTALIS YANKEE POINT | YANKEE POINT CEANOTHUS | L | 8 | 1 GAL |
| | CEANOTHUS THYRSIFLORUS | BLUEBLOSSOM CEANOTHUS | L | 8 | 5 GAL |
| | CERCOCARPUS BETULOIDES | MOUNTAIN MAHOGANY | VL | 8 | 1 GAL |
| | CHLOROGALUM POMERIDIANUM | SOAPROOT | VL | 1.5 | 1 GAL |
| | EPILOBIUM CANUM | CALIFORNIA FUCHSIA | L | 4 | 1 GAL |
| | ERIGERON GLAUCUS | BEACH DAISY | L | 1 | 1 GAL |
| | ERIGERON KARVINSKIANUS | FLEABANE | L | 1 | 1 GAL |
| | ERIOGONUM UMBELLATUM | SULFUR FLOWER BUCKWHEAT | L | 4 | 1 GAL |
| | FESTUCA CALIFORNICA | CALIFORNIA FESCUE | L | 2 | 1 GAL |
| | FESTUCA IDAHOENSIS | IDAHO FESCUE | VL | 1 | 1 GAL |
| | FRANGULA CALIFORNICA | CALIFORNIA COFFEEBERRY | L | 4 | 1 GAL |
| | FRANGULA CALIFORNICA 'MOUND SAN BRUNO' | MOUND SAN BRUNO COFFEEBERRY | L | 3 | 1 GAL |
| | GARRYA ELLIPTICA | COAST SILK TASSEL | L | 6 | 5 GAL |
| | HETEROMELES ARBUTIFOLIA | TOYON | L | 8 | 5 GAL |
| | IRIS DOUGLASIANA | DOUGLAS IRIS | L | 1 | 1 GAL |
| | JUNCUS PATENS | SPREADING RUSH | L | 1 | 1 GAL |
| | LAVANDULA LATIFOLIA | SPIKE LAVENDER | L | 1 | 1 GAL |
| | LAVANDULA STOECHAS | SPANISH LAVENDER | L | 1 | 1 GAL |
| | LIMONIUM CALIFORNICUM | MARSH ROSEMARY | L | 0.5 | 1 GAL |
| | MIMULUS AURANTIACUS | STICKY MONKEYFLOWER | VL | 4 | 1 GAL |
| | ROSA CALIFORNICA | CALIFORNIA ROSE | L | 4 | 1 GAL |
| | RUBUS URSINUS | CALIFORNIA BLACKBERRY | L | 2 | 1 GAL |
| | SALVIA CLEVELANDII | CLEVELAND SAGE | L | 6 | 1 GAL |
| | SALVIA LEUCANTHA | MEXICAN BUSH SAGE | L | 4 | 5 GAL |
| | SALVIA MICROPHYLLA 'HOT LIPS' | HOT LIPS SAGE | L | 4 | 1 GAL |
| | SALVIA SPATHACEA | HUMMINGBIRD SAGE | L | 1 | 1 GAL |
| | SISYRINCHIUM BELLUM | BLUE EYED GRASS | VL | 0.5 | 1 GAL |
| | SPOROBOLUS AIROIDES | ALKALI SACATON | L | 2 | 1 GAL |
| | STIPA PULCHRA | PURPLE NEEDLE GRASS | VL | 1 | 1 GAL |
| | | | ļ | - | |

^{*}WUCOLS VALUE NOT AVAILABLE. WATER REQUIREMENTS ARE ESTIMATED.

DEEP SHADE

| SYMBOL | BOTANICAL NAME | COMMON NAME | WUCOLS | OC SPACING (FT) | SIZE |
|--------|-----------------------|--------------------|--------|-----------------|-------|
| | BLECHNUM SPICANT | DEER FERN | М | 2 | 1 GAL |
| | CLINOPODIUM DOUGLASII | YERBA BUENA | L | 3 | 1 GAL |
| | CORNUS NUTTALLII | MOUNTAIN DOGWOOD | М | 6-10 | 5 GAL |
| | HEUCHERA MAXIMA | ISLAND ALUM ROOT | М | 2 | 1 GAL |
| | MIMULUS GUTTATUS | SEEP MONKEYFLOWER | M* | 1.5 | 1 GAL |
| | POLYSTICHUM MUNITUM | WESTERN SWORD FERN | М | 2 | 1 GAL |
| | RIBES SANGUINEUM | FLOWERING CURRANT | L | 4 | 5 GAL |
| | SYMPHORICARPOS ALBUS | COMMON SNOWBERRY | L | 4 | 1 GAL |
| | WOODWARDIA FIMBRIATA | GIANT CHAIN FERN | М | 4 | 1 GAL |

BIORETENTION

| SYMBOL | BOTANICAL NAME | COMMON NAME | WUCOLS | OC SPACING (FT) | SIZE |
|--------|------------------------------------|-------------------------|--------|-----------------|-------|
| | ACHILLEA MILLEFOLIUM | COMMON YARROW | L | 1 | 1 GAL |
| | FRAGARIA CHILOENSIS | BEACH STRAWBERRY | M | 1 | 1 GAL |
| | HEUCHERA MAXIMA | ISLAND ALUM ROOT | M | 2 | 1GAL |
| | JUNCUS EFFUSUS | SOFT RUSH | M | 0.5 | 1 GAL |
| | JUNCUS PATENS | SPREADING RUSH | L | 1 GAL | 1 GAL |
| | LIMNANTHES DOUGLASII SULPHUREA | DOUGLAS' MEADOWFOAM | M | 0.5 | 1 GAL |
| | ROSA CALIFORNICA | CALIFORNIA ROSE | L | 4 | 1 GAL |
| | SOLIDAGO VELUTINA SSP. CALIFORNICA | CALIFORNIA GOLDENROD | M | 1 | 1 GAL |
| | STACHYS BULLATA | CALIFORNIA HEDGE NETTLE | L | 1 | 1 GAL |
| | SYMPHYOTRICHUM CHILENSE | PACIFIC ASTER | M | 2 | 1 GAL |

VINES

| SYMBOL | BOTANICAL NAME | COMMON NAME | WUCOLS | OC SPACING (FT) | SIZE |
|--------|--------------------|-----------------------|--------|-----------------|-------|
| | CLEMATIS LASIANTHA | CHAPARRAL CLEMATIS | L | 5 | 1 GAL |
| | VITIS CALIFORNICA | CALIFORNIA WILD GRAPE | L | 5 | 1 GAL |

REDWOOD UNDERSTORY

| SYMBOL | BOTANICAL NAME | COMMON NAME | WUCOLS | OC SPACING (FT) | SIZE |
|--------|------------------------|-----------------------|--------|-----------------|-------|
| | CEANOTHUS THYRSIFLORUS | BLUEBLOSSOM CEANOTHUS | L | 8 | 5 GAL |
| | CORNUS NUTTALLII | MOUNTAIN DOGWOOD | М | 6-10 | 5 GAL |
| | CORYLUS CORNUTA | HAZELNUT | L | 7 | 1 GAL |
| | HOLODISCUS DISCOLOR | CREAM BUSH | L | 5 | 1 GAL |
| | RIBES SANGUINEUM | FLOWERING CURRANT | L | 4 | 5 GAL |
| | SYMPHORICARPOS ALBUS | COMMON SNOWBERRY | ı | 2 | 1 GAL |
| | VACCINIUM OVATUM | HUCKLEBERRY | - 1 | 10 | 5 GAL |
| | WOODWARDIA FIMBRIATA | GIANT CHAIN FERN | M | 4 | 1 GAL |

POLLINATOR MEADOW

| SYMBOL | BOTANICAL NAME | COMMON NAME | wucols | OC SPACING (FT) | SIZE |
|--------|-------------------------|---------------------|--------|-----------------|-------|
| | ASCLEPIAS SPECIOSA | SHOWY MILKWEED | L | 1 | 1 GAL |
| | EPILOBIUM CANUM | CALIFORNIA FUCHSIA | L | 4 | 1 GAL |
| | ERIGERON GLAUCUS | BEACH DAISY | L | 1 | 1 GAL |
| | MIMULUS AURANTIACUS | STICKY MONKEYFLOWER | VL | 4 | 1 GAL |
| | MONARDELLA VILLOSA | COYOTE MINT | VL | 2 | 1 GAL |
| | PENSTEMON HETEROPHYLLUS | FOOTHILL PENSTEMON | L | 2 | 1 GAL |
| | PHACELIA TANACETIFOLIA | LACY PHACELIA | VL* | 2 | 1 GAL |
| | STIPA PULCHRA | PURPLE NEEDLE GRASS | VL | 1 | 1 GAL |

^{*}WUCOLS VALUE NOT AVAILABLE. WATER REQUIREMENTS ARE ESTIMATED.

EVV CCHEDITIE

| EVA 3C | EVA SCHEDULE | | | | | | |
|--------|----------------------|---------------------|--------|------|--|--|--|
| SYMBOL | BOTANICAL NAME | COMMON NAME | WUCOLS | ТҮРЕ | | | |
| | FESTUCA IDAHOENSIS | IDAHO FESCUE | VL | | | | |
| | FESTUCA OCCIDENTALIS | WESTERN FESCUE | - | SOD | | | |
| | FESTUCA RUBRA | CREEPING RED FESCUE | L | | | | |

TREES

| BOTANICAL NAME | COMMON NAME | WUCOLS | OC SPACING (FT) | SIZE | DO NOT PLANT AT RETAIL EXTENTS* |
|---------------------------------|-----------------------------|--------|-----------------------|--------------------|---------------------------------|
| ACER CIRCINATUM | VINE MAPLE | М | 15 | SEE TABLE BELOW | |
| AESCULUS CALIFORNICA | CALIFORNIA BUCKEYE | VL | 30 | SEE TABLE BELOW | X |
| ARBUTUS UNEDO | STRAWBERRY TREE MULTI-TRUNK | L | 20 | SEE TABLE BELOW | X |
| CERCIS OCCIDENTALIS | WESTERN REDBUD | VL | 15 | SEE TABLE BELOW | Х |
| CERCIS OCCIDENTALIS MULTI-TRUNK | WESTERN REDBUD MULTI-TRUNK | VL | 15 | SEE TABLE BELOW | X |
| PRUNUS ILICIFOLIA | HOLLYLEAF CHERRY | L | 15 | SEE TABLE BELOW | Х |
| QUERCUS AGRIFOLIA | COAST LIVE OAK | VL | 25 | SEE TABLE BELOW | |
| QUERCUS LOBATA | VALLEY OAK | L | 25 | SEE TABLE BELOW | |

^{*}FOR BIRD SAFE DESIGN, FRUITING TREES SHALL NOT BE PLANTED BETWEEN BUILDING AND PROPERTY LINE AT GLASS RETAIL FAÇADE EXTENTS OR AT ANY OTHER HIGHLY REFLECTIVE SURFACE

TREE SIZE BREAKDOWN - HUFF

| SYMBOL | CONTAINER SIZE | QUANTITY |
|---------|----------------|----------|
| | 24" BOX | 19 |
| | 36" BOX | 1 |
| | 48" BOX | 26 |
| San Mos | 60" BOX | 4 |
| - ~VW | 72" BOX | 5 |

TREE SIZE BREAKDOWN - ALTA

| SYMBOL | CONTAINER SIZE | QUANTITY |
|---|----------------|----------|
| | 24" BOX | 51 |
| • | 36" BOX | 1 |
| £ . ~ ~ ~ ~ ~ ~ ~ ~ ~ ~ ~ ~ ~ ~ ~ ~ ~ ~ | 48" BOX | 18 |
| Sana Mars | 60" BOX | 1 |
| - *** | 72" BOX | 1 |



HUFF PARKING STRUCTURE

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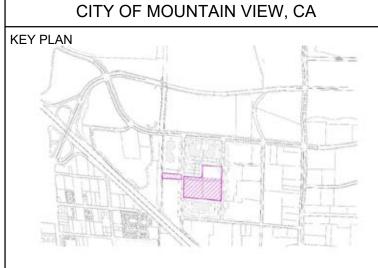
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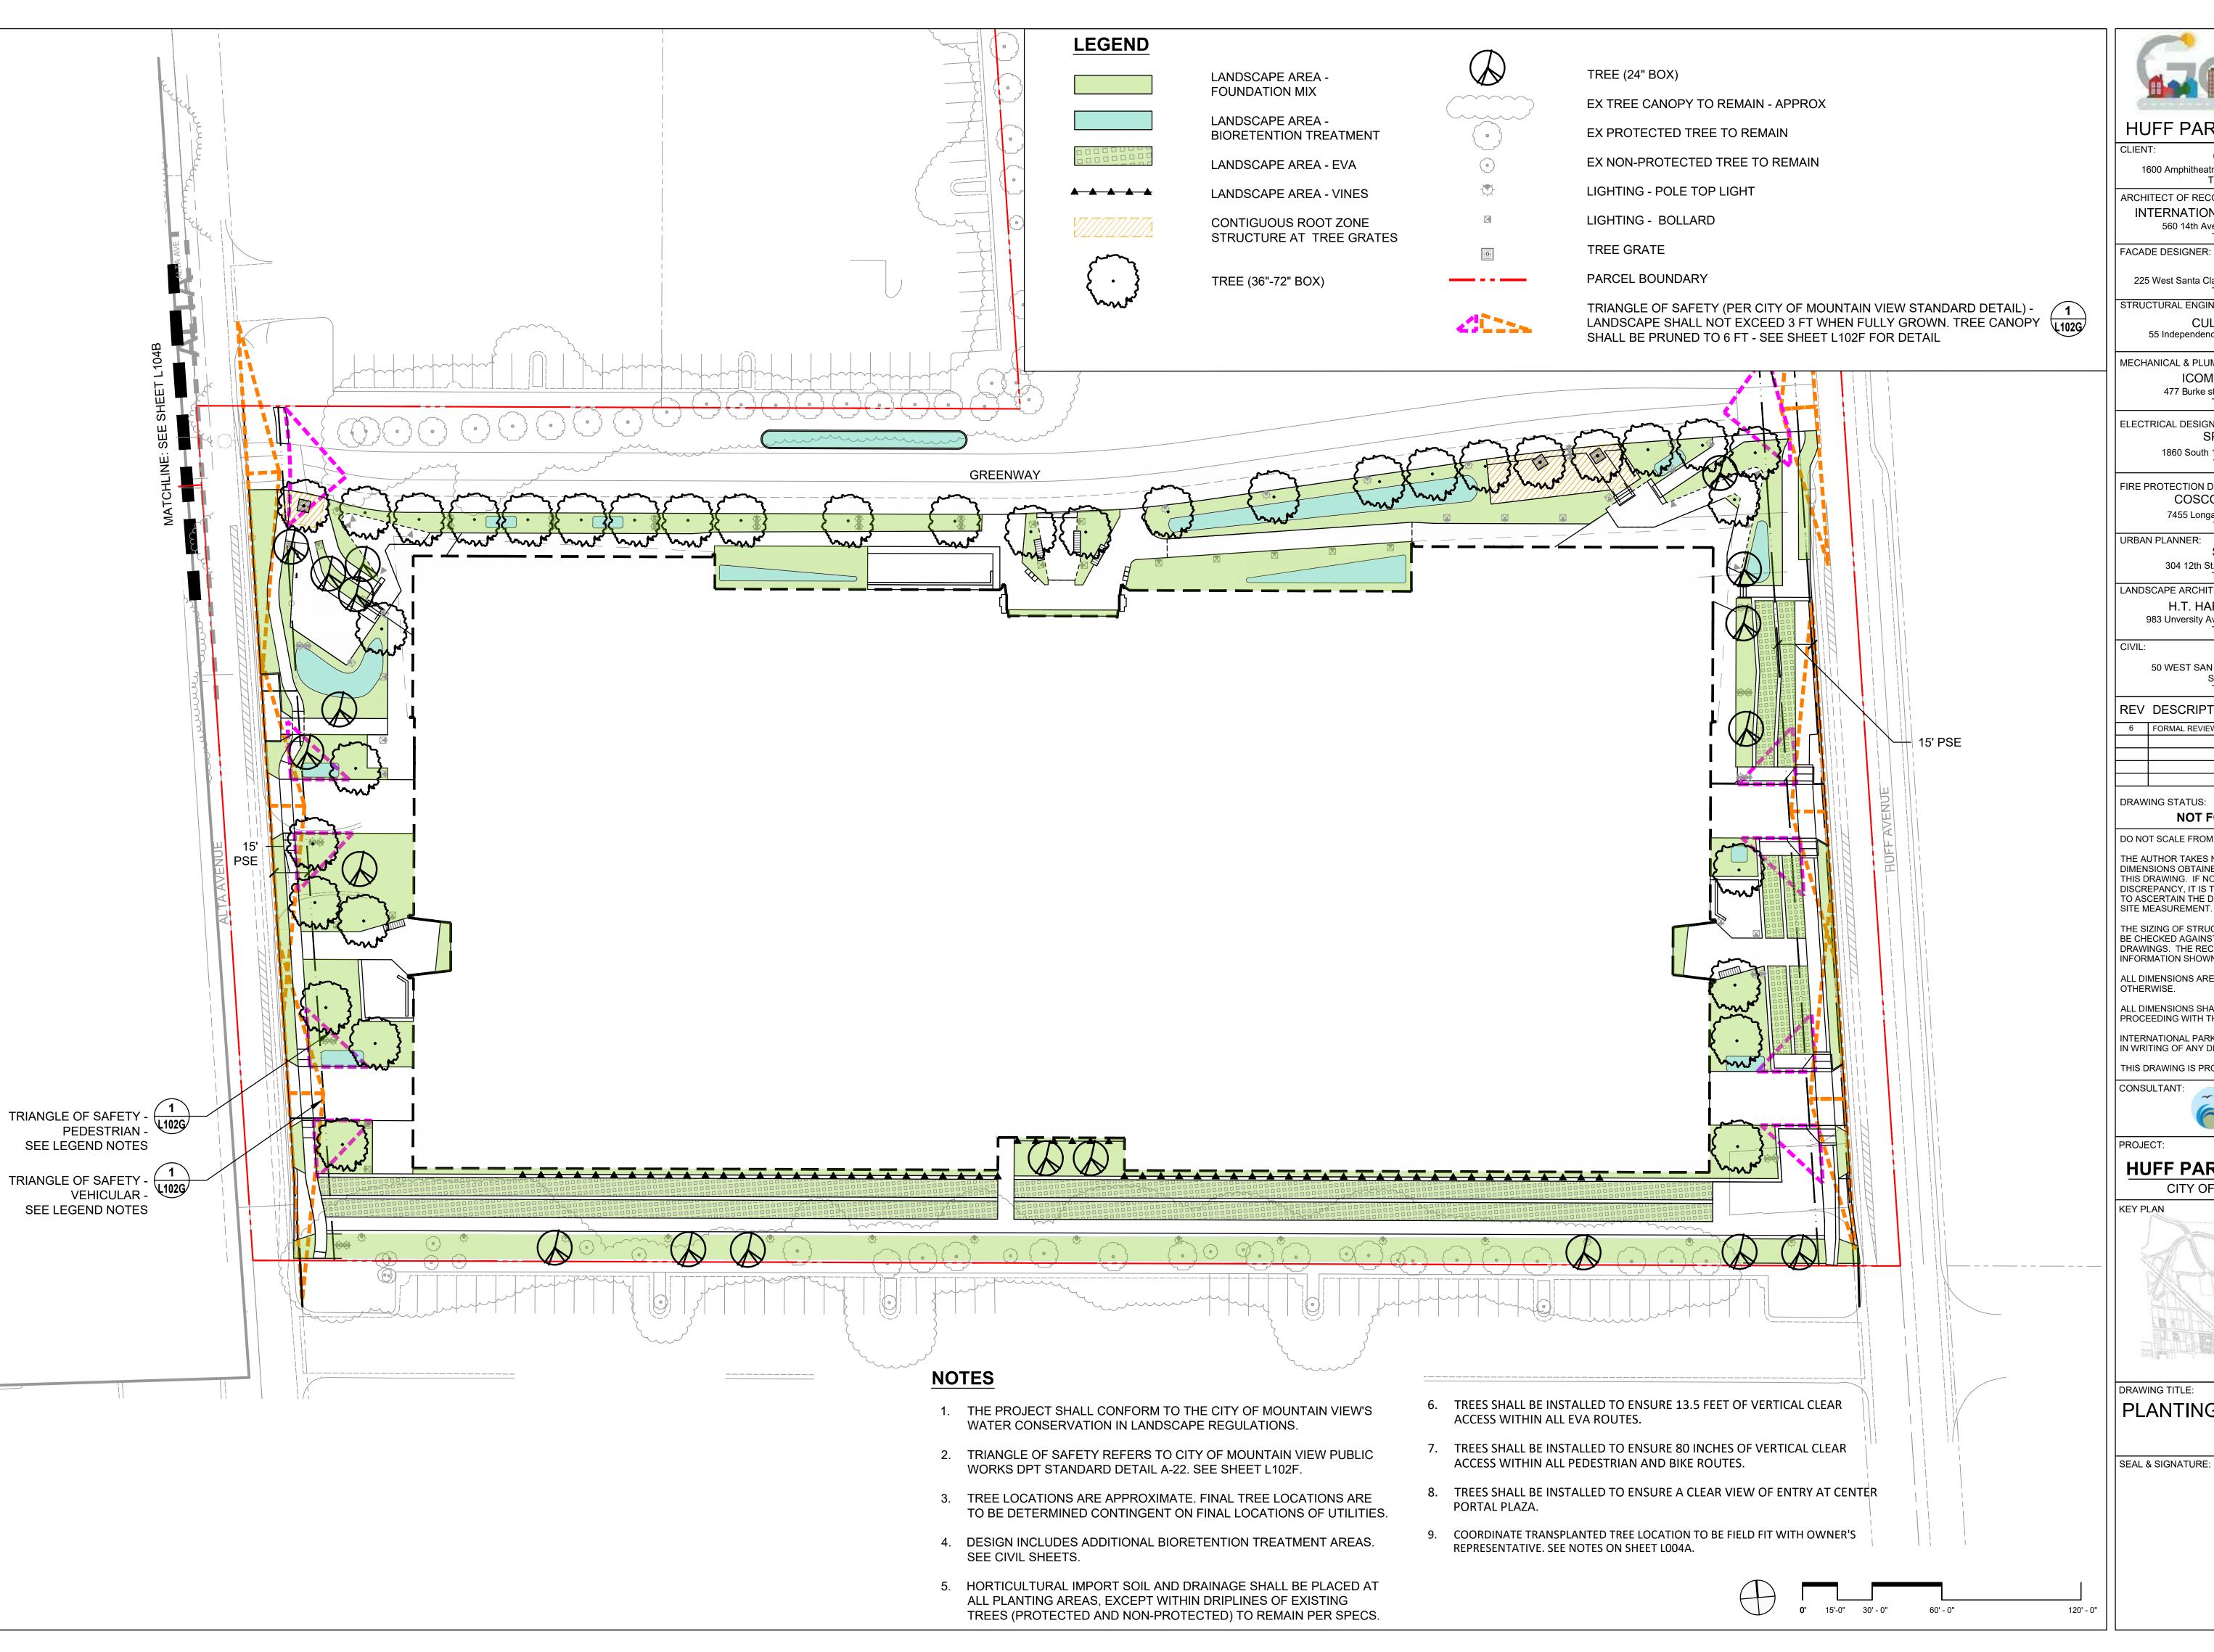
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| | PROJEC | CT No: | 3475- |
| | SCALE: | AS SHOWN | |
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| | DRAWN | :LD, CG | 00 |
| | CHK: | JMH, KV | |
| | DWG No | D : | |
| | | 404 | |

L103





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TEL: (408) 971-7300

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HUFF PARKING STRUCTURE CITY OF MOUNTAIN VIEW, CA




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PLANTING PLAN

| AL & SIGNATURE: | DATE | 05/26/20 |
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| | PROJECT No: | 3475-65 |
| | SCALE: AS SHOWN | |
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| | DRAWN: LD, CG | 06 |
| | CHK: JMH, KV | |
| | DWG No: | |
| | | |

L104A

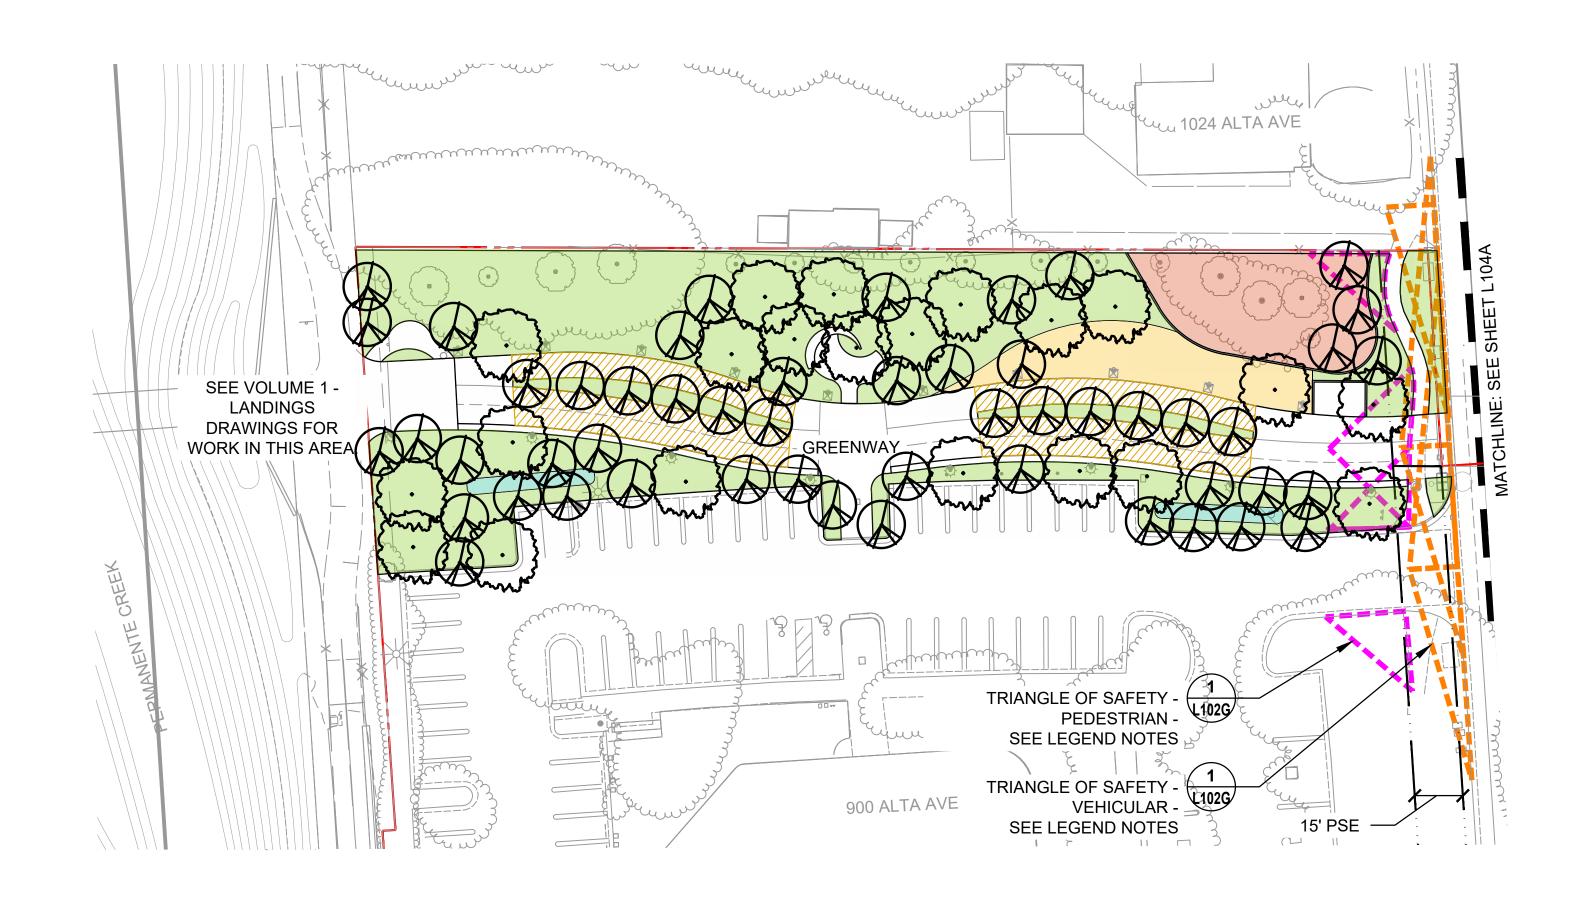

LEGEND

LANDSCAPE AREA - FOUNDATION MIX LANDSCAPE AREA - BIORETENTION TREATMENT LANDSCAPE AREA - REDWOOD UNDERSTORY LANDSCAPE AREA - POLLINATOR MEADOW



TREE (36"-72" BOX)



TREE (15 GAL-24" BOX)

CONTIGUOUS ROOT ZONE STRUCTURE AT TREE GRATES



EX TREE CANOPY TO REMAIN - APPROX

PARCEL BOUNDARY

EX PROTECTED TREE TO REMAIN

EX NON-PROTECTED TREE TO REMAIN

TRIANGLE OF SAFETY (PER CITY OF MOUNTAIN VIEW STANDARD DETAIL) - LANDSCAPE SHALL NOT EXCEED 3 FT WHEN FULLY GROWN. TREE CANOPY SHALL BE PRUNED TO 6 FT - SEE SHEET L102F FOR **DETAIL**

LIGHTING - POLE TOP LIGHT

LIGHTING - BOLLARD

NOTES

- 1. THE PROJECT SHALL CONFORM TO THE CITY OF MOUNTAIN VIEW'S WATER CONSERVATION IN LANDSCAPE REGULATIONS.
- 2. TRIANGLE OF SAFETY REFERS TO CITY OF MOUNTAIN VIEW PUBLIC WORKS DPT STANDARD DETAIL A-22. SEE SHEET L102F.
- 3. TREE LOCATIONS ARE APPROXIMATE. FINAL TREE LOCATIONS ARE TO BE DETERMINED CONTINGENT ON FINAL LOCATIONS OF UTILITIES.
- 4. DESIGN INCLUDES ADDITIONAL BIORETENTION TREATMENT AREAS. SEE CIVIL SHEETS.
- 5. HORTICULTURAL IMPORT SOIL AND DRAINAGE SHALL BE PLACED AT ALL PLANTING AREAS, EXCEPT WITHIN DRIPLINES OF EXISTING TREES (PROTECTED AND NON-PROTECTED) TO REMAIN PER SPECS.



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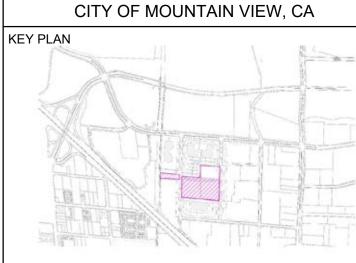
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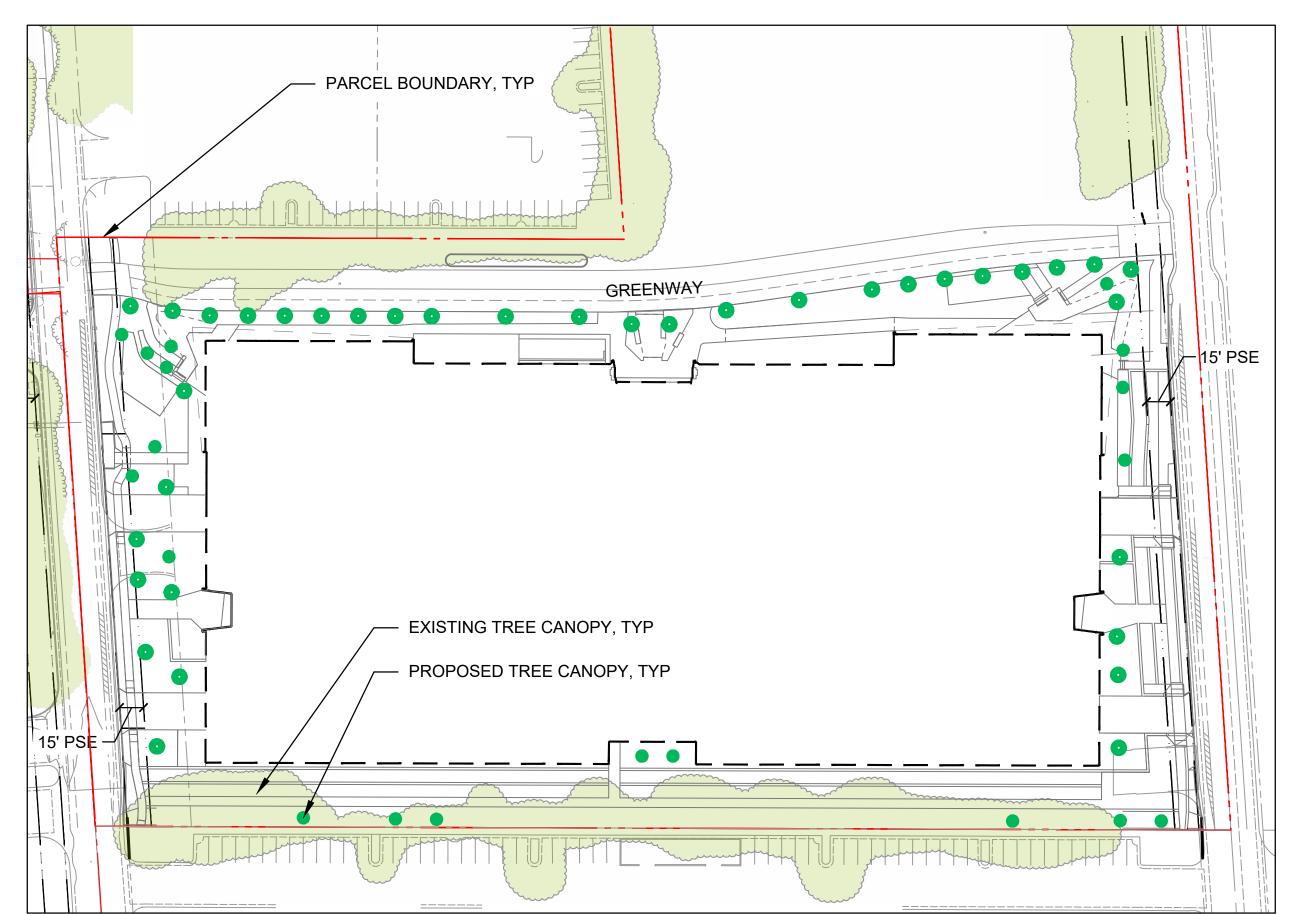
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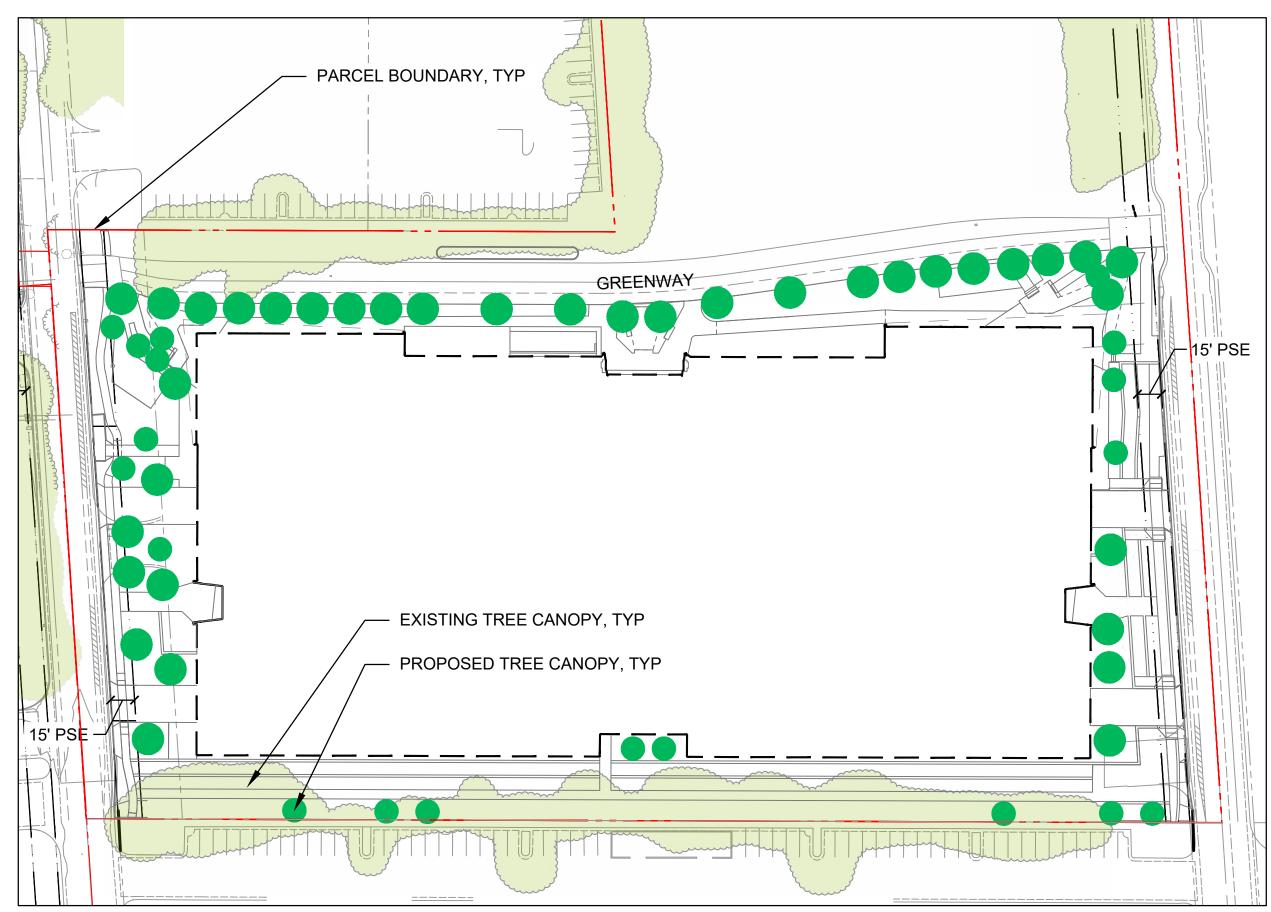


PLANTING PLAN 900 ALTA

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| | CHK: JMH, KV | |
| | DWG No: | |
| | L104 | 4B |




TREE CANOPY AT CONSTRUCTION




TREE CANOPY AT 10 YEARS

1. ALL TREE CANOPIES ARE SHOWN AT THE SAME SIZE FOR PLANNING PURPOSES. SOME TREES WILL BE LARGER AT THE TIME OF INSTALLATION.

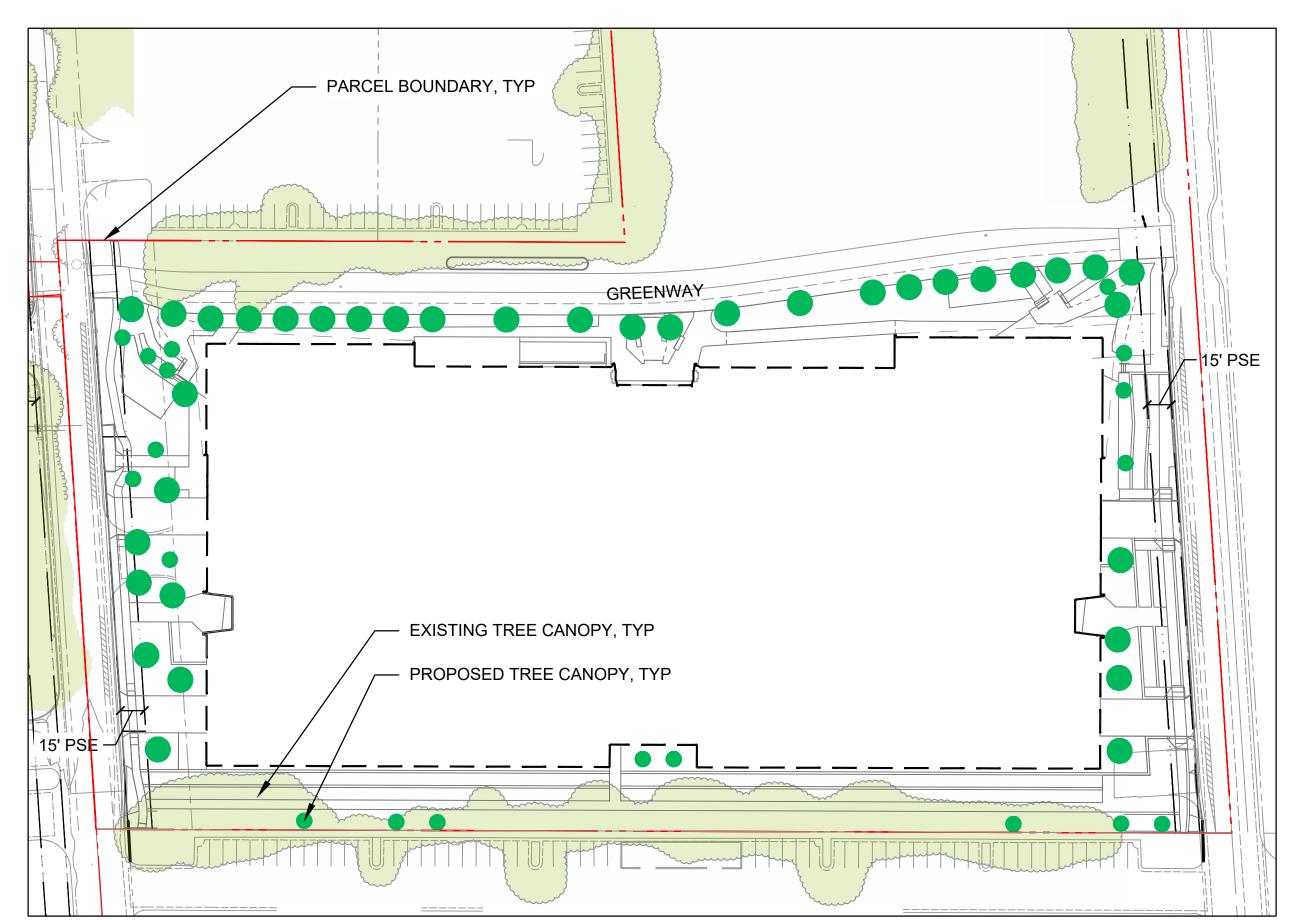

TREE CANOPY AT 5 YEARS

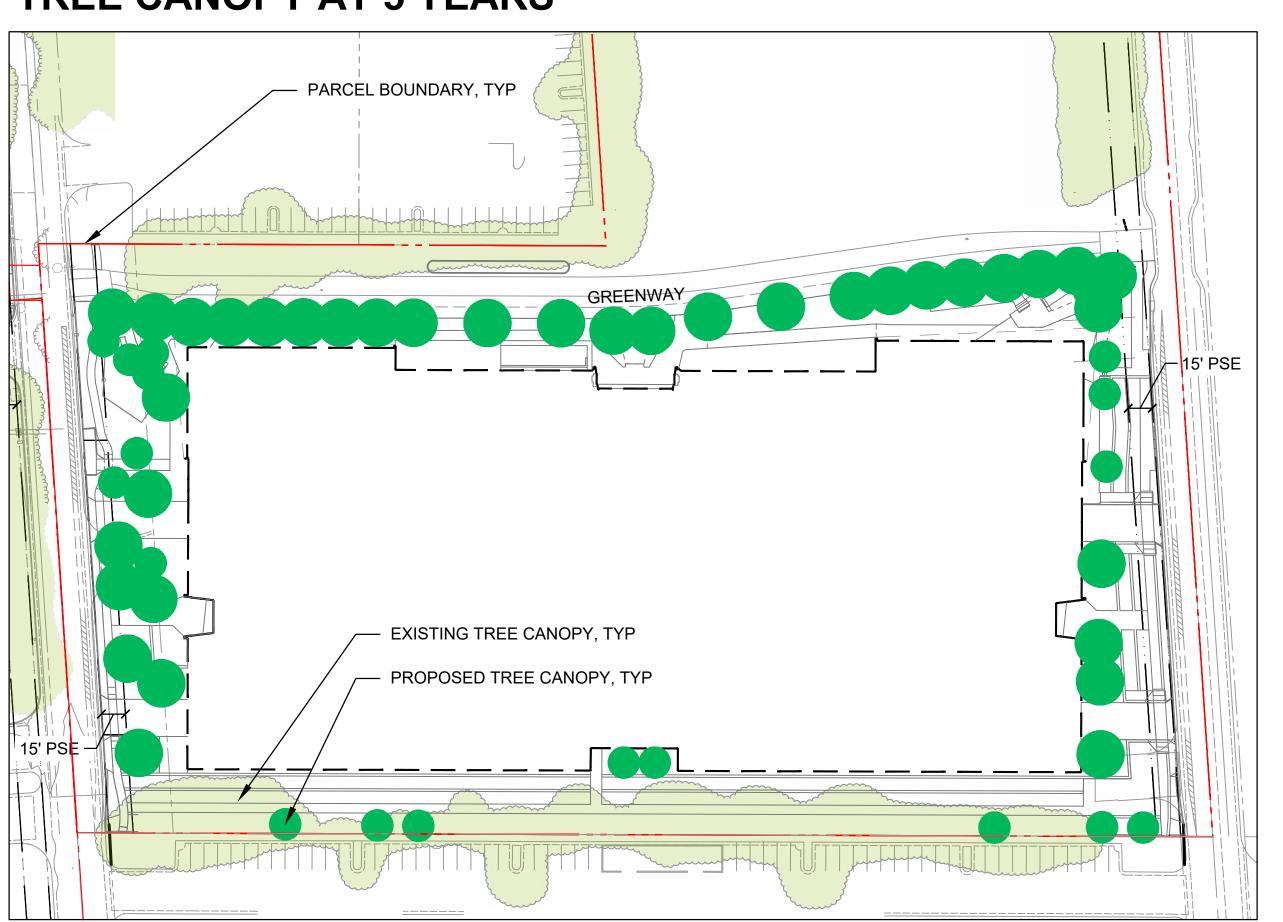

TREE CANOPY AT FULL GROWTH

HUFF - TREE CANOPY PROGRESSION

| TOTAL AREA (SF) | CUMULATIVE TOTAL AREA (SF) | TOTAL AREA (AC) | % OVERALL SITE CANOPY COVER |
|-----------------|--|--|---|
| | | | |
| 74,797 | 74,797 | 1.72 | 22% |
| | | | |
| 43,943 | 43,943 | 1.01 | 13% |
| 3,544 | 47,487 | 1.1 | 14% |
| 8,342 | 52,285 | 1.21 | 15% |
| 13,782 | 57,725 | 1.33 | 17% |
| 26,930 | 70,873 | 1.63 | 20% |
| | 74,797 43,943 3,544 8,342 13,782 | 74,797 74,797 43,943 43,943 3,544 47,487 8,342 52,285 13,782 57,725 | TOTAL AREA (SF) TOTAL AREA (AC) 74,797 74,797 1.72 43,943 43,943 1.01 3,544 47,487 1.1 8,342 52,285 1.21 13,782 57,725 1.33 |



HUFF PARKING STRUCTURE

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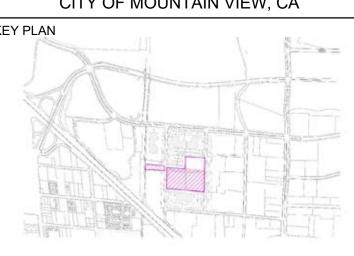
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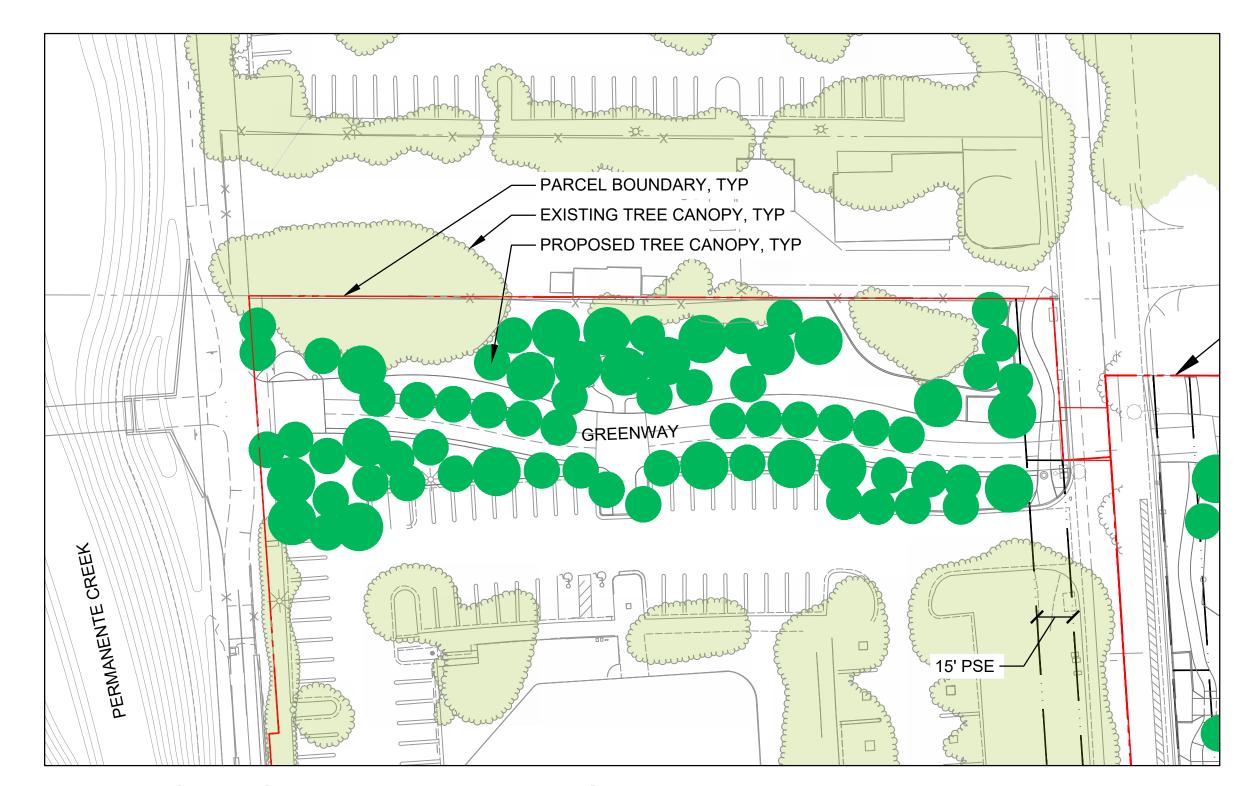
LANDSCAPE CANOPY PROGRESSION PLANS-HUFF PARKING STRUCTURE

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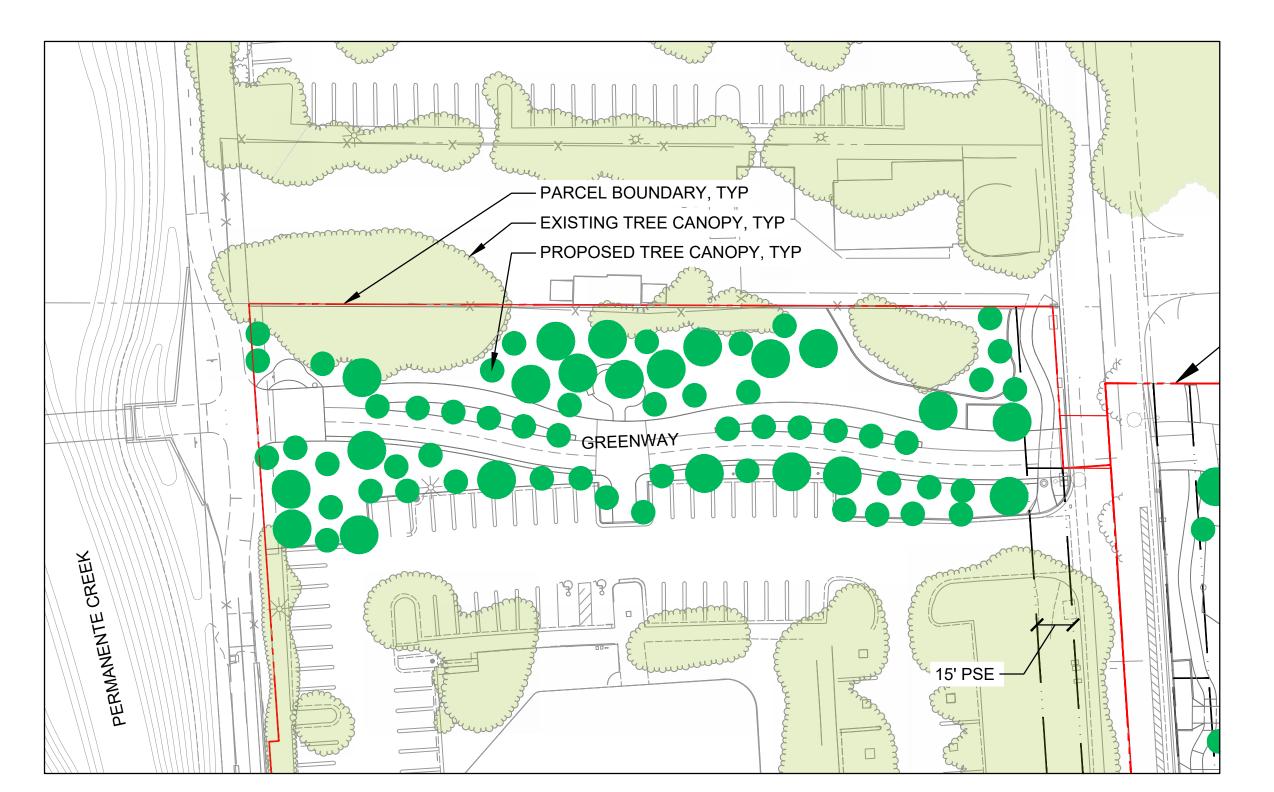
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L105A


TREE CANOPY AT CONSTRUCTION



TREE CANOPY AT 10 YEARS



TREE CANOPY AT 5 YEARS

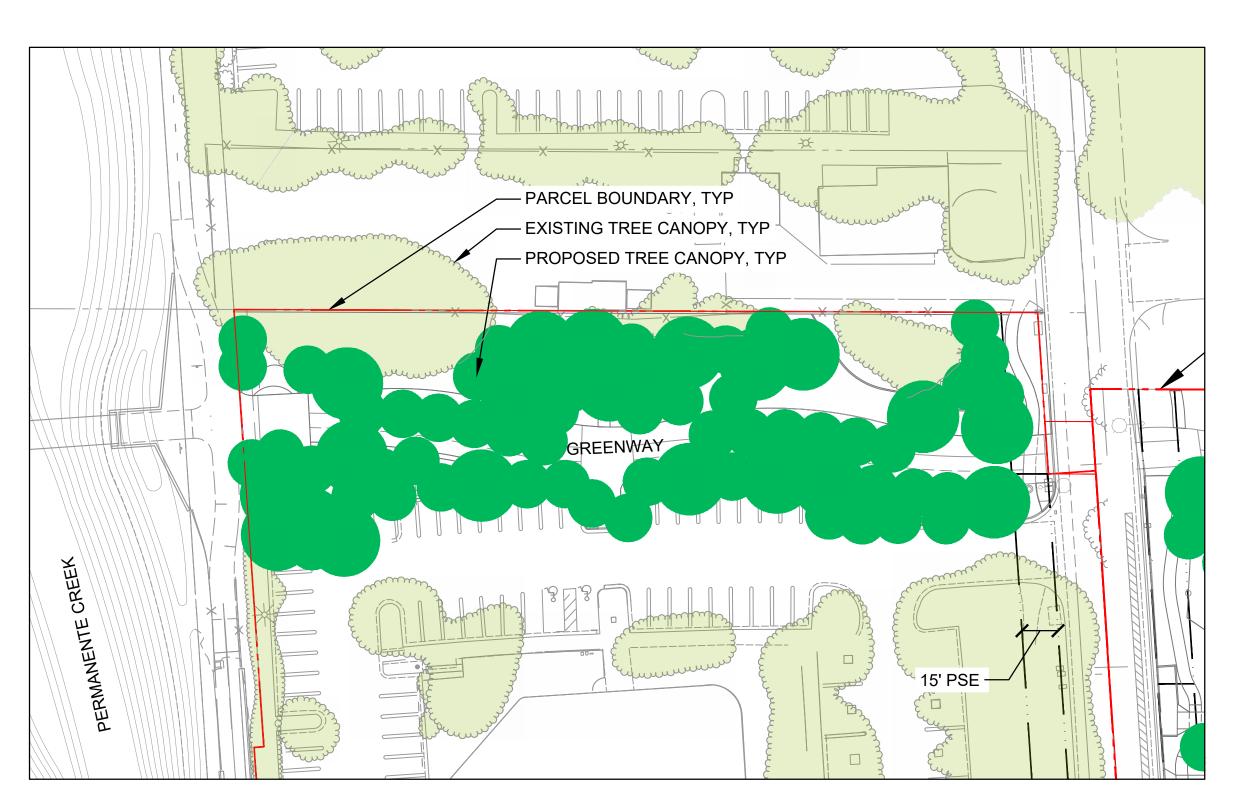

TREE CANOPY AT FULL GROWTH

NOTES

1. SEE NOTES ON SHEET L105A.

900 ALTA - TREE CANOPY PROGRESSION

| STATUS | TOTAL AREA (SF) | CUMULATIVE TOTAL AREA (SF) | CUMULATIVE TOTAL AREA (AC) | % OVERALL SITE CANOPY COVER | | | |
|---------------------------|-----------------|-------------------------------|-------------------------------|-----------------------------|--|--|--|
| EXISTING | | | | | | | |
| EX CANOPY | 97,479 | 97,479 | 2.24 | 32% | | | |
| PROPOSED | | | | | | | |
| EX CANOPY TO REMAIN | 89,446 | 89,446 | 2.06 | 29% | | | |
| PR CANOPY AT INSTALLATION | 4,209 | 93,655 | 2.16 | 31% | | | |
| PR CANOPY AT 5 YEARS | 8,250 | 97,696 | 2.25 | 32% | | | |
| PR CANOPY AT 10 YEARS | 15,621 | 105,067 | 2.42 | 34% | | | |
| PR CANOPY AT FULL GROWTH | 22,318 | 111,765 | 2.57 | 36% | | | |



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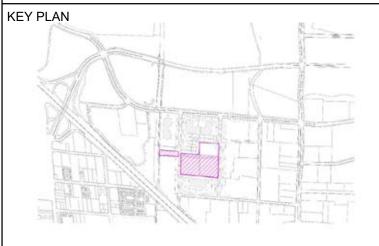
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HUFF PARKING STRUCTURE CITY OF MOUNTAIN VIEW, CA



PANDSCAPE CANOPY PROGRESSION PLANS 900 ALTA

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|-----------------|---------|
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| DRAWN: LD, CG | 00 |
| CHK: JMH, KV | |
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L105B



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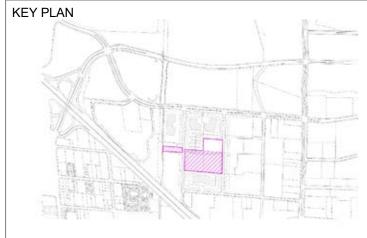
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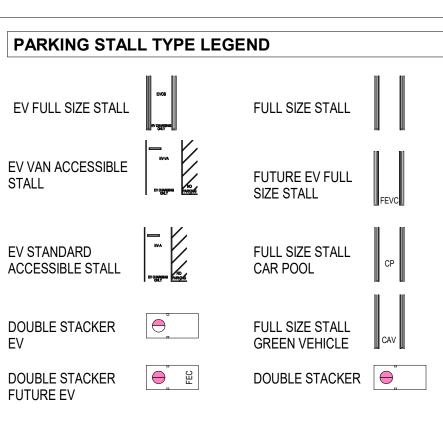



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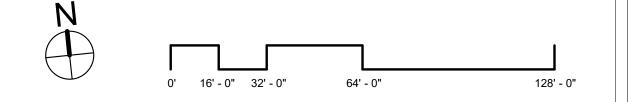
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1 SECOND LEVEL PARKING PLAN SCALE: 1/32" = 1'-0"





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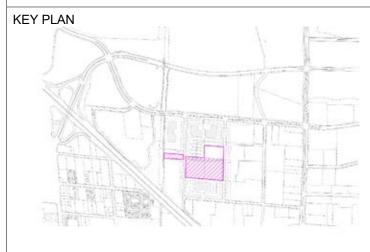
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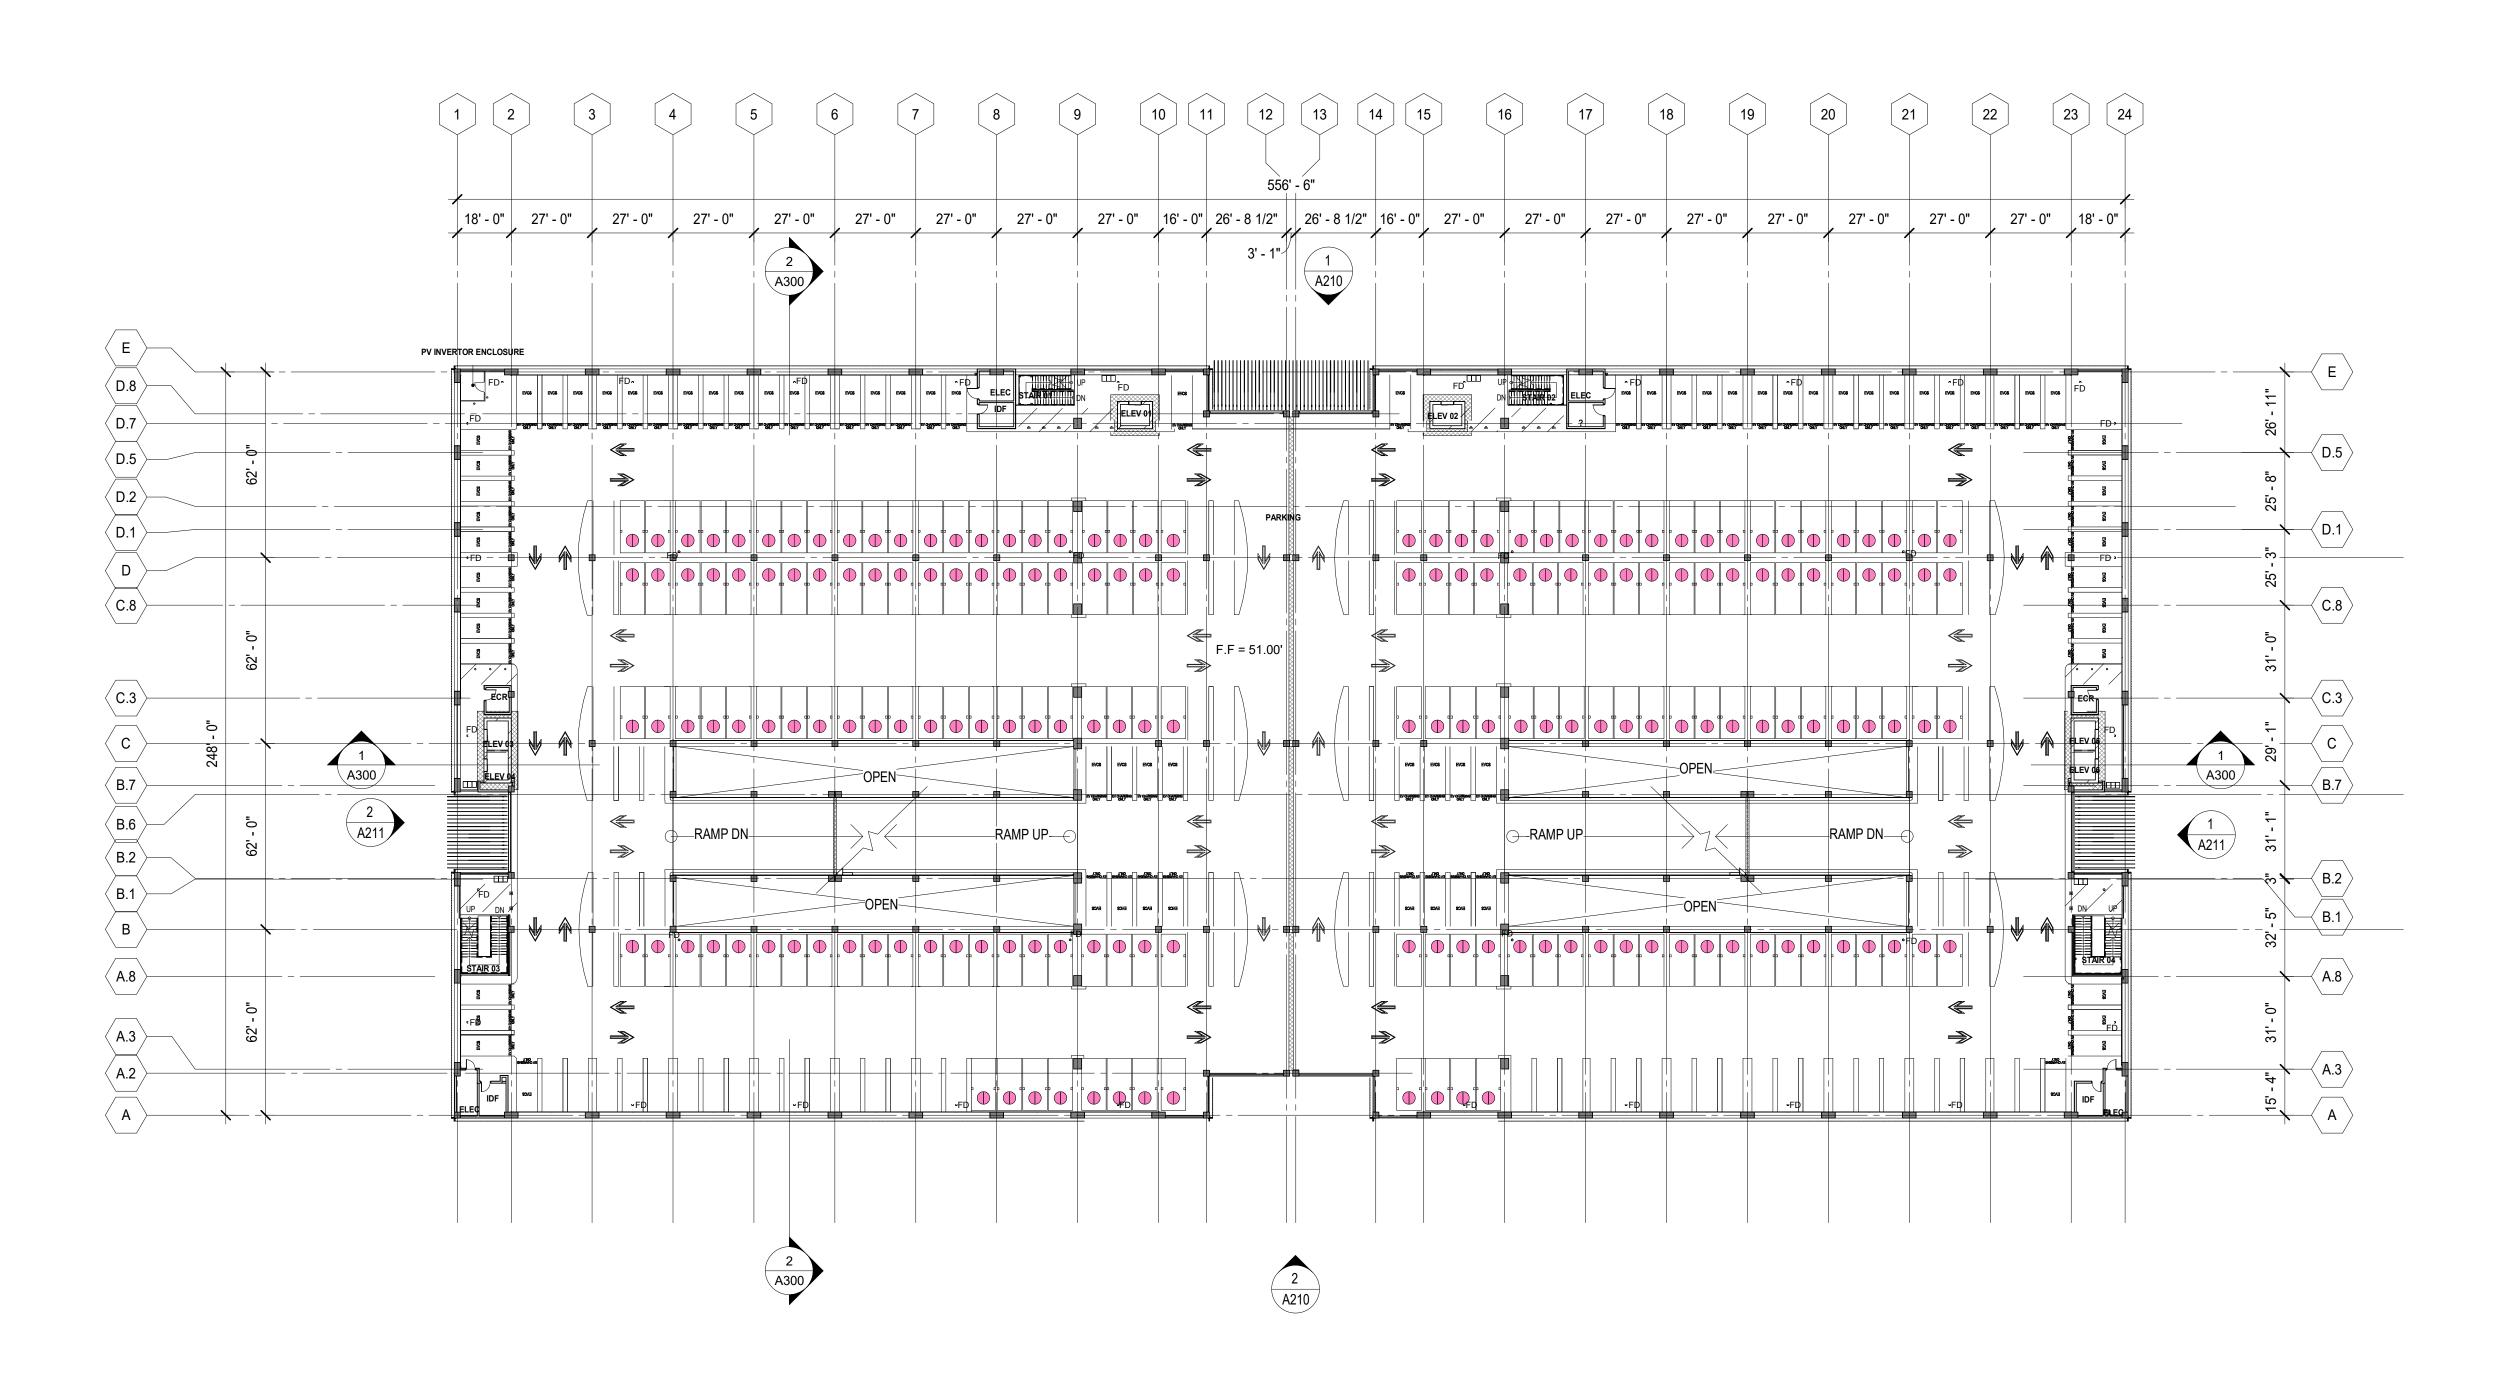
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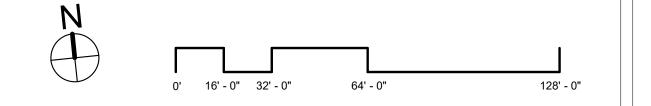
DRAWING TITLE:

SECOND LEVEL PARKING PLAN
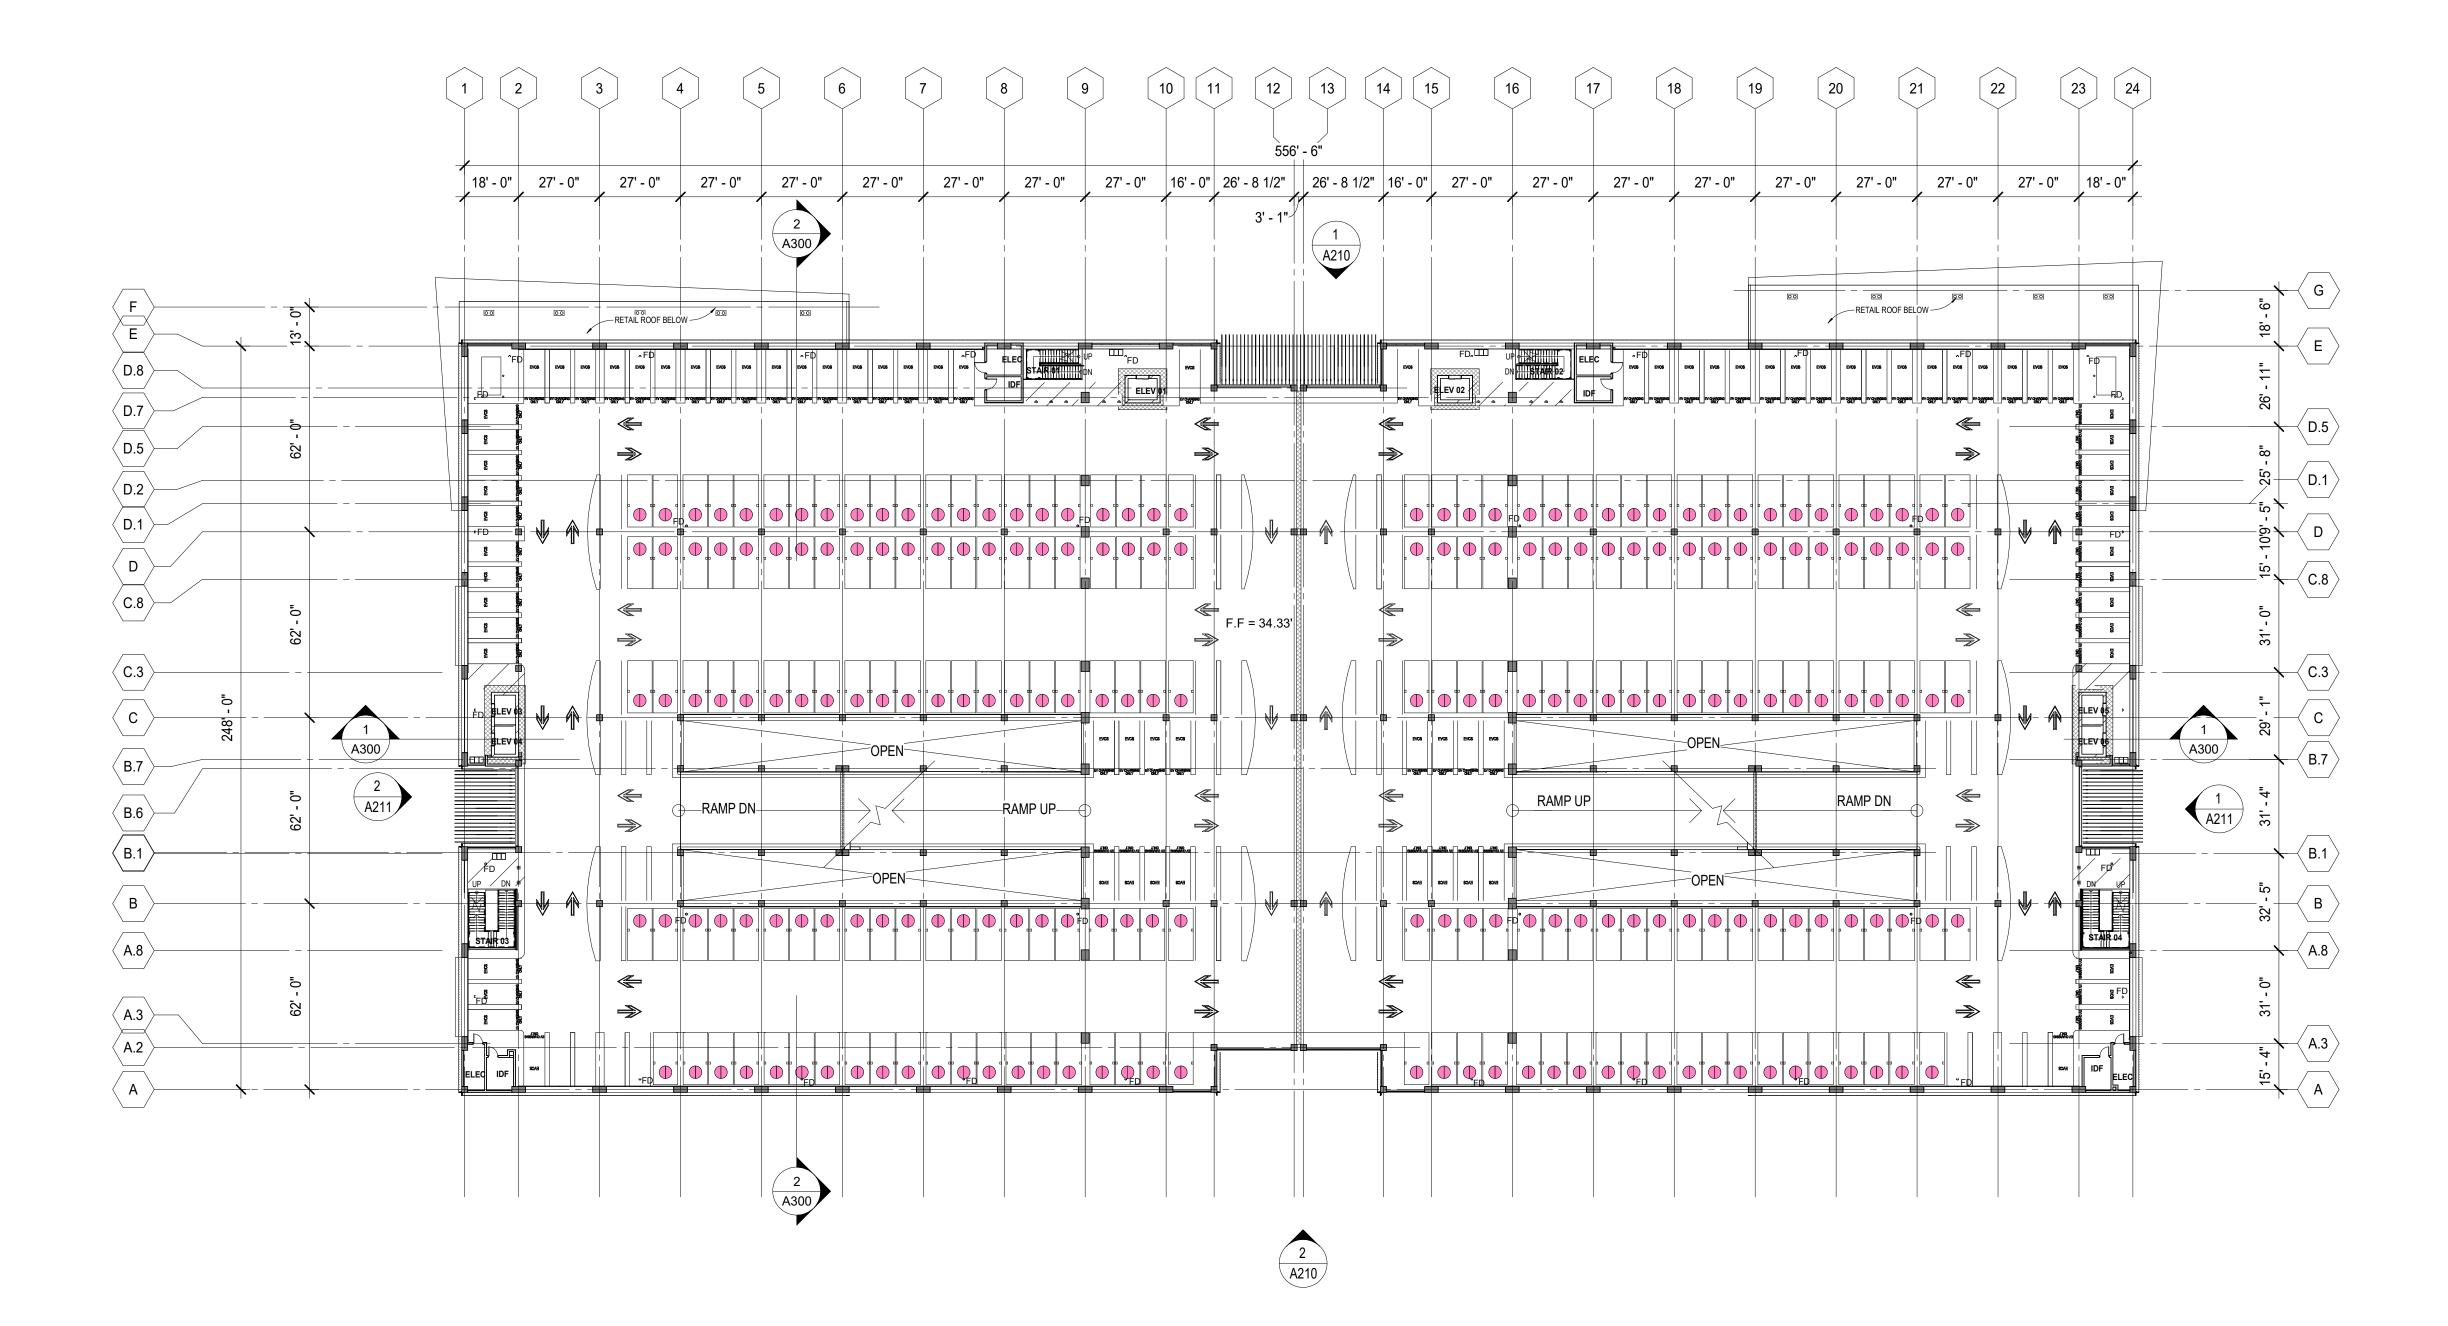
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1 THIRD LEVEL PARKING PLAN
SCALE: 1/32" = 1'-0"





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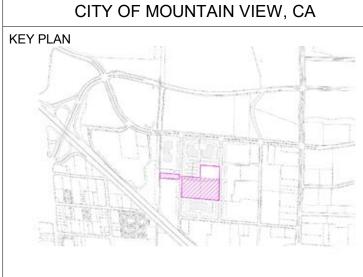
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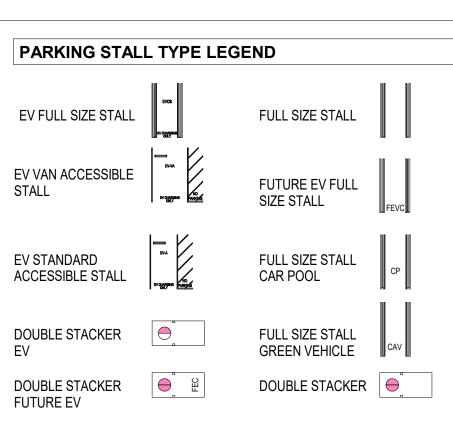



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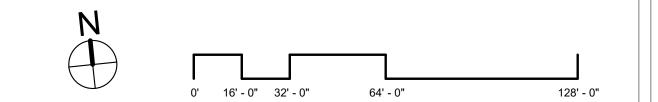
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1 FOURTH (ROOF) LEVEL PARKING PLAN SCALE: 1/32" = 1'-0"





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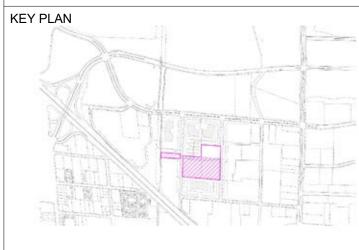
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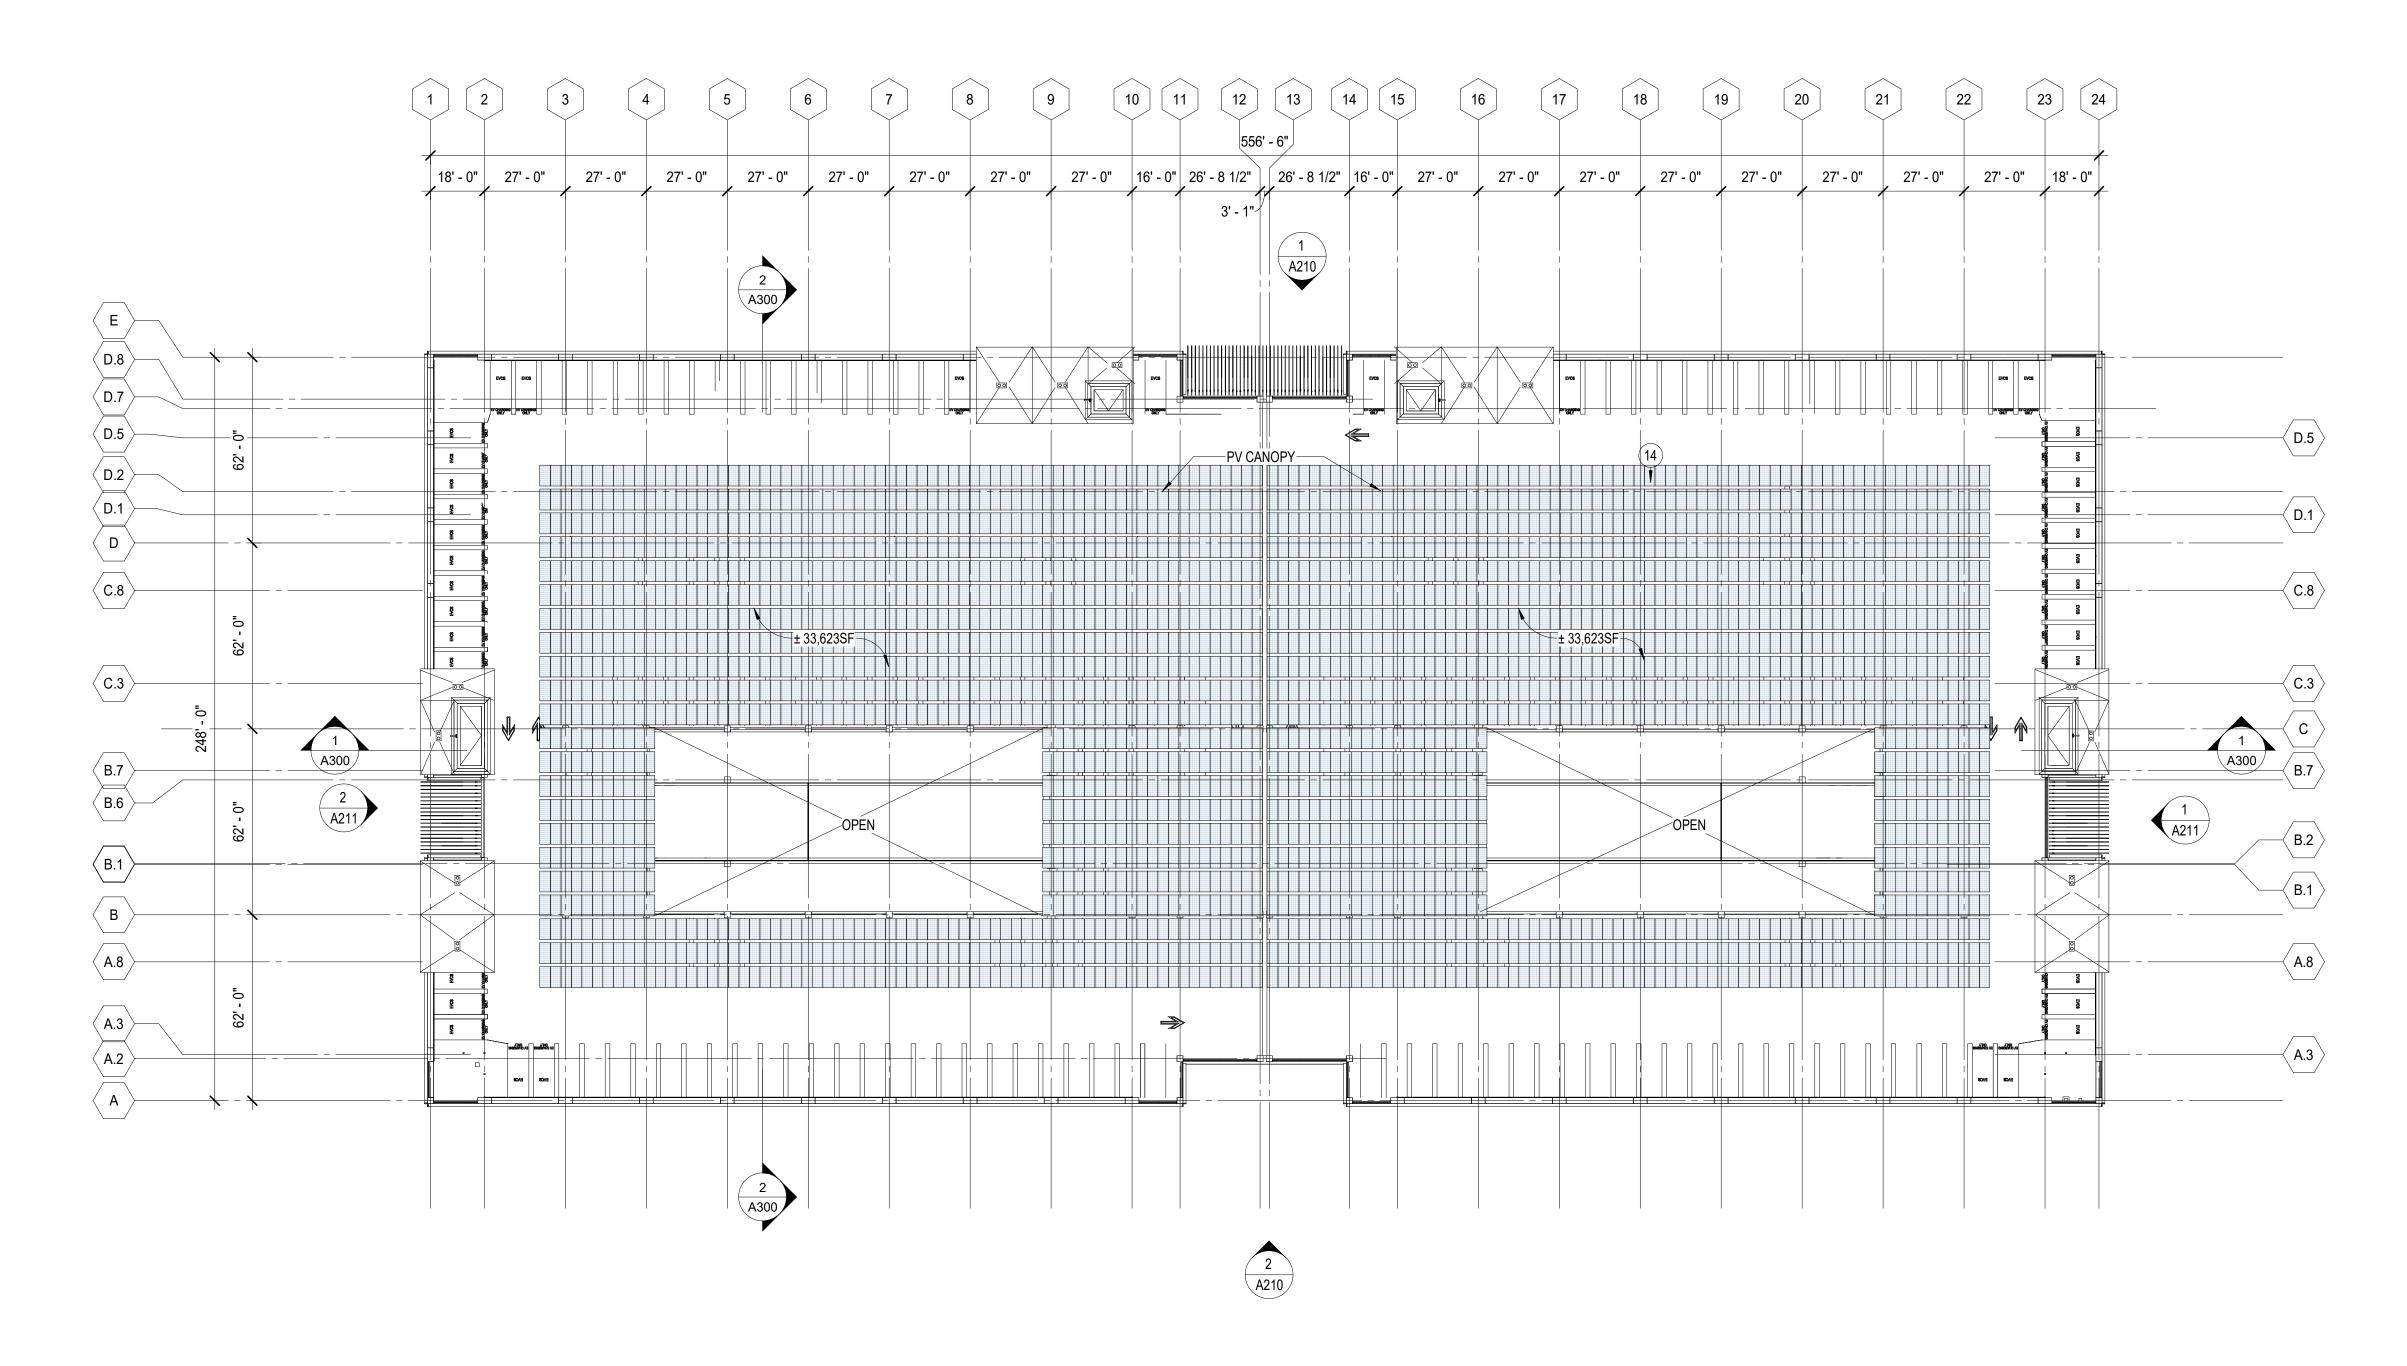
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DRAWING TITLE:

FOURTH (ROOF) LEVEL PARKING PLAN
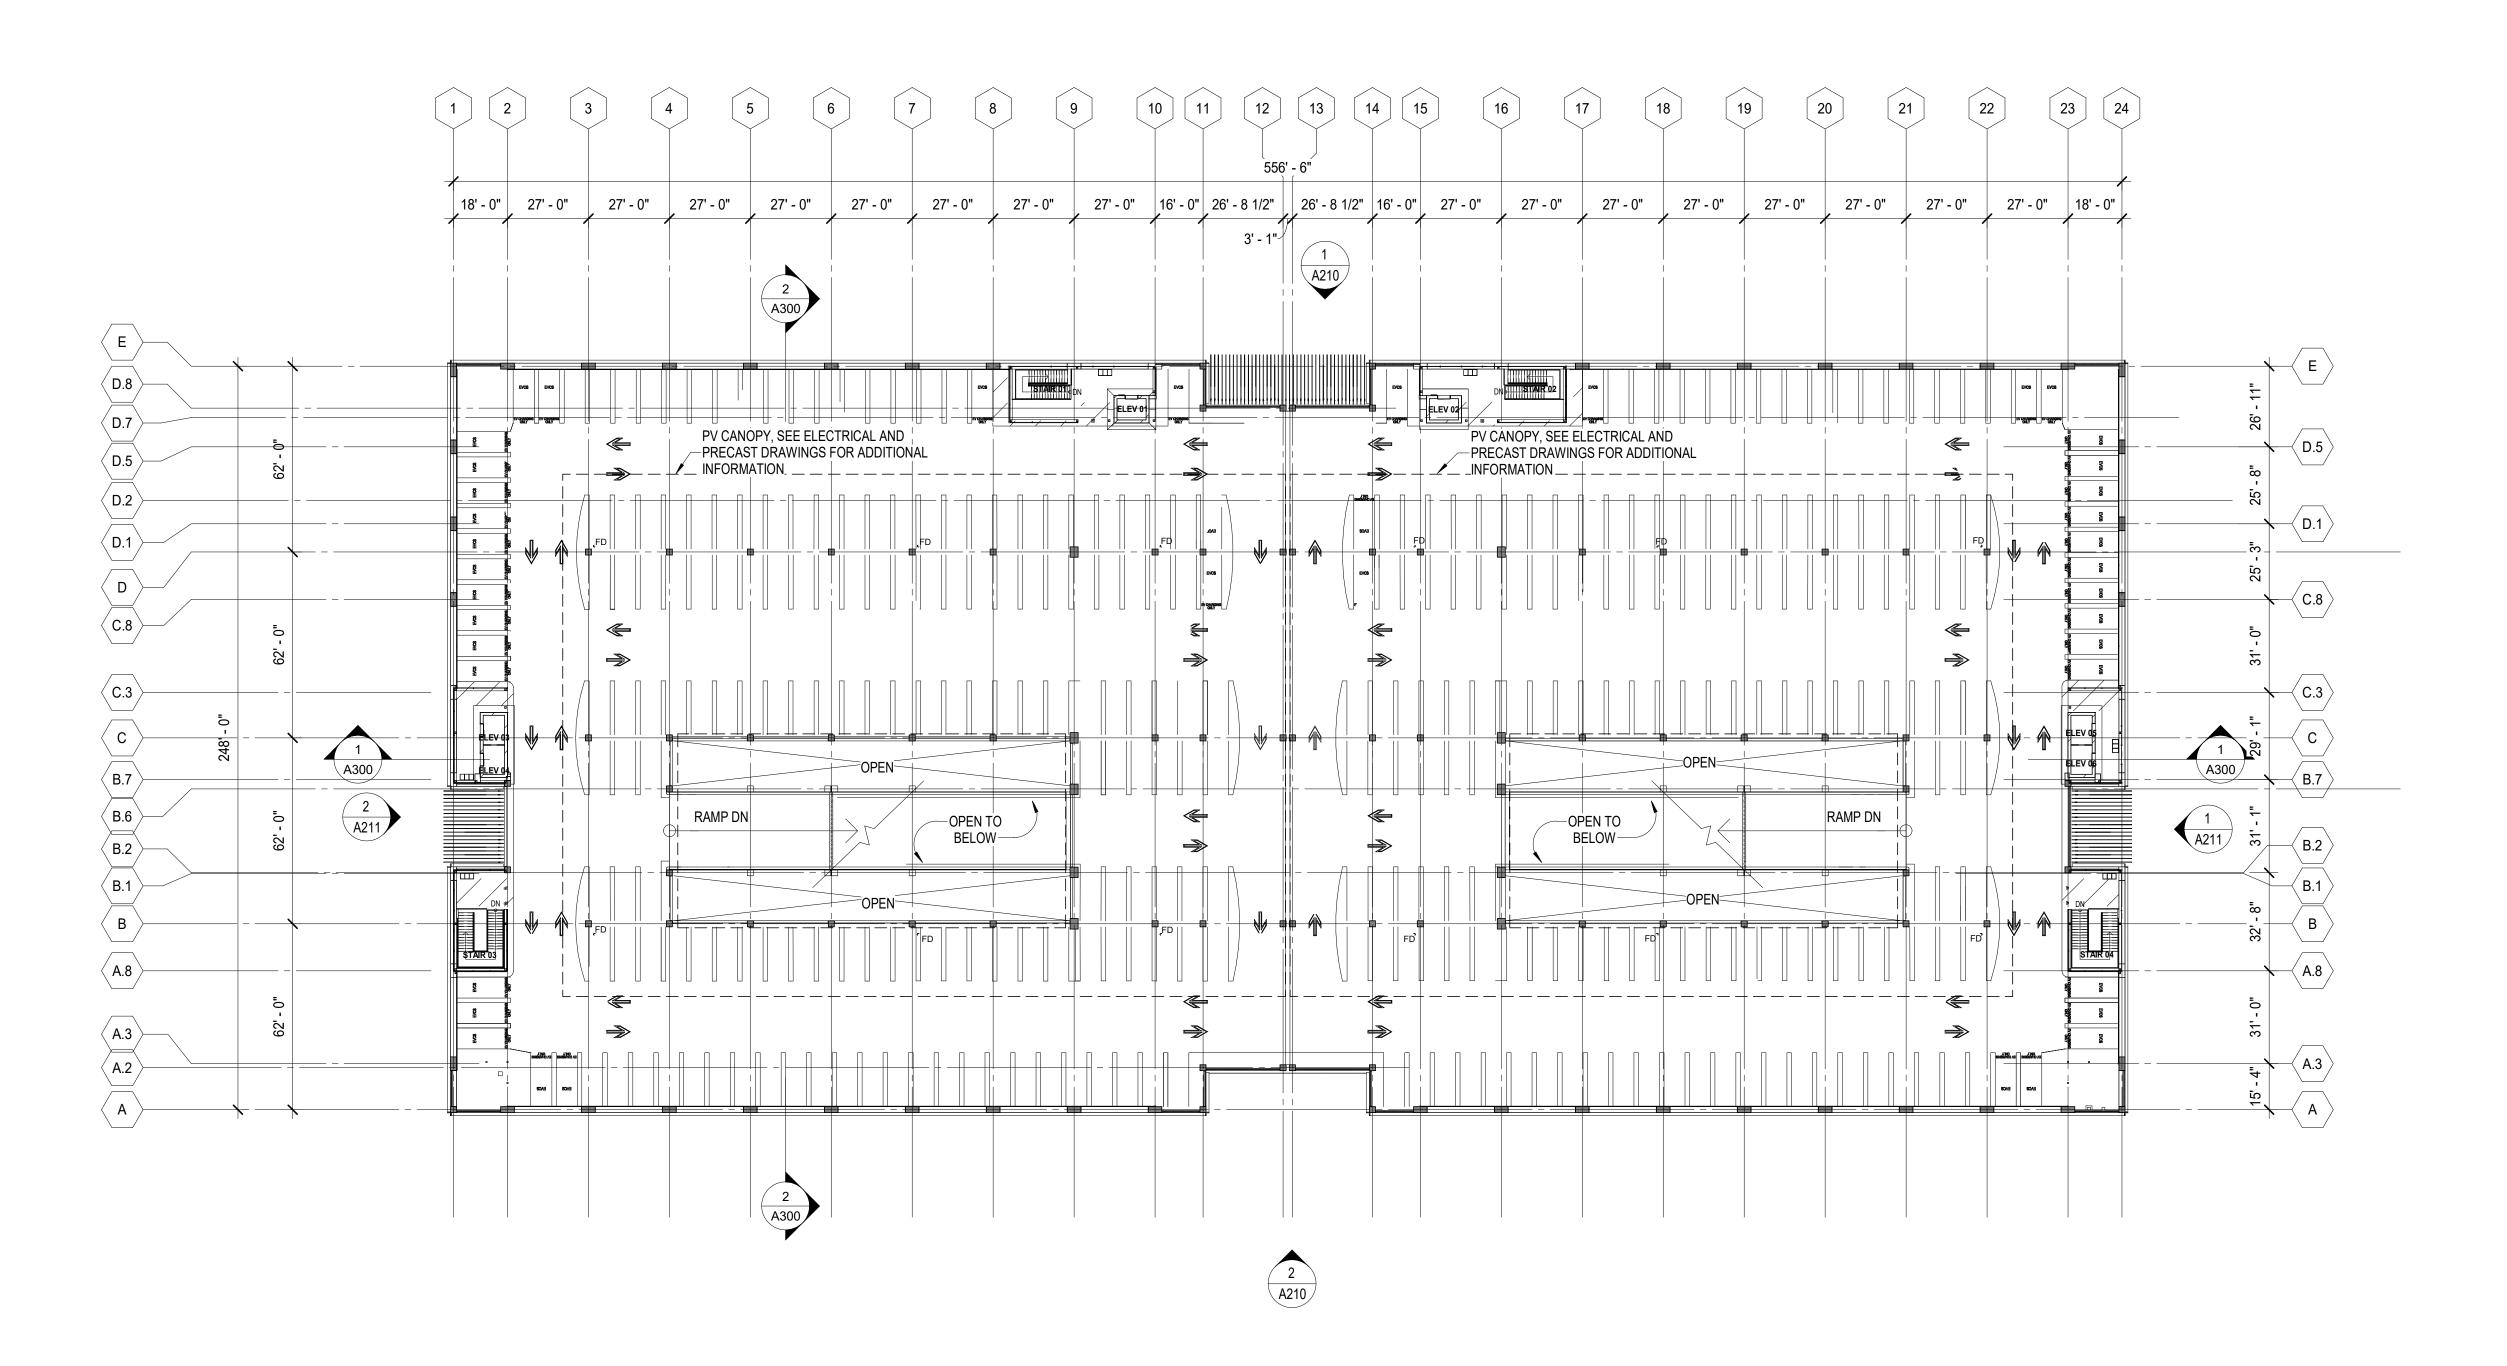
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| AL & SIGNATURE: | DATE | 05/26/20 | |
| | PROJECT No: | 18243 | |
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| | A10 | 4 | |



1 PV CANOPY PLAN
SCALE: 1/32" = 1'-0"



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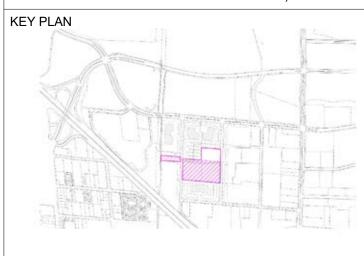
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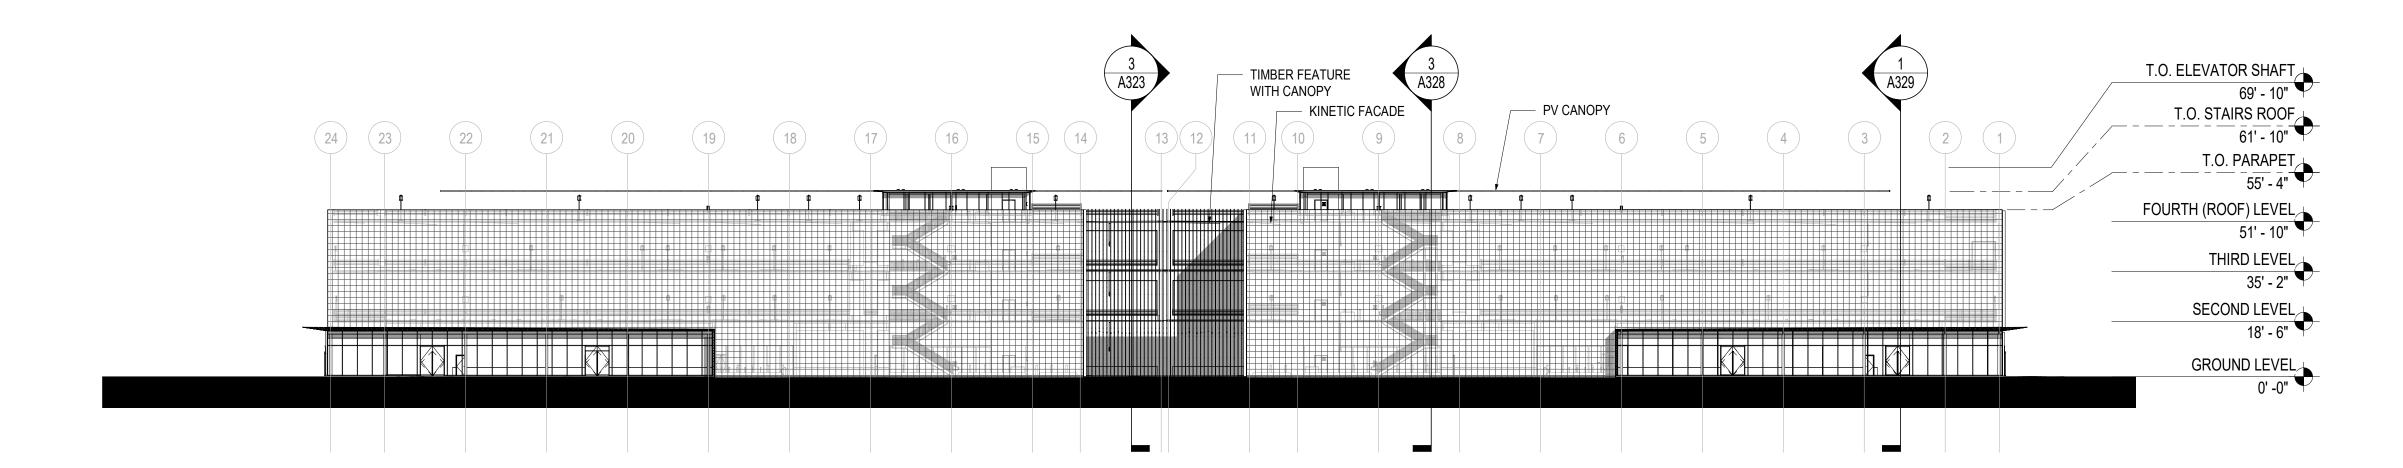
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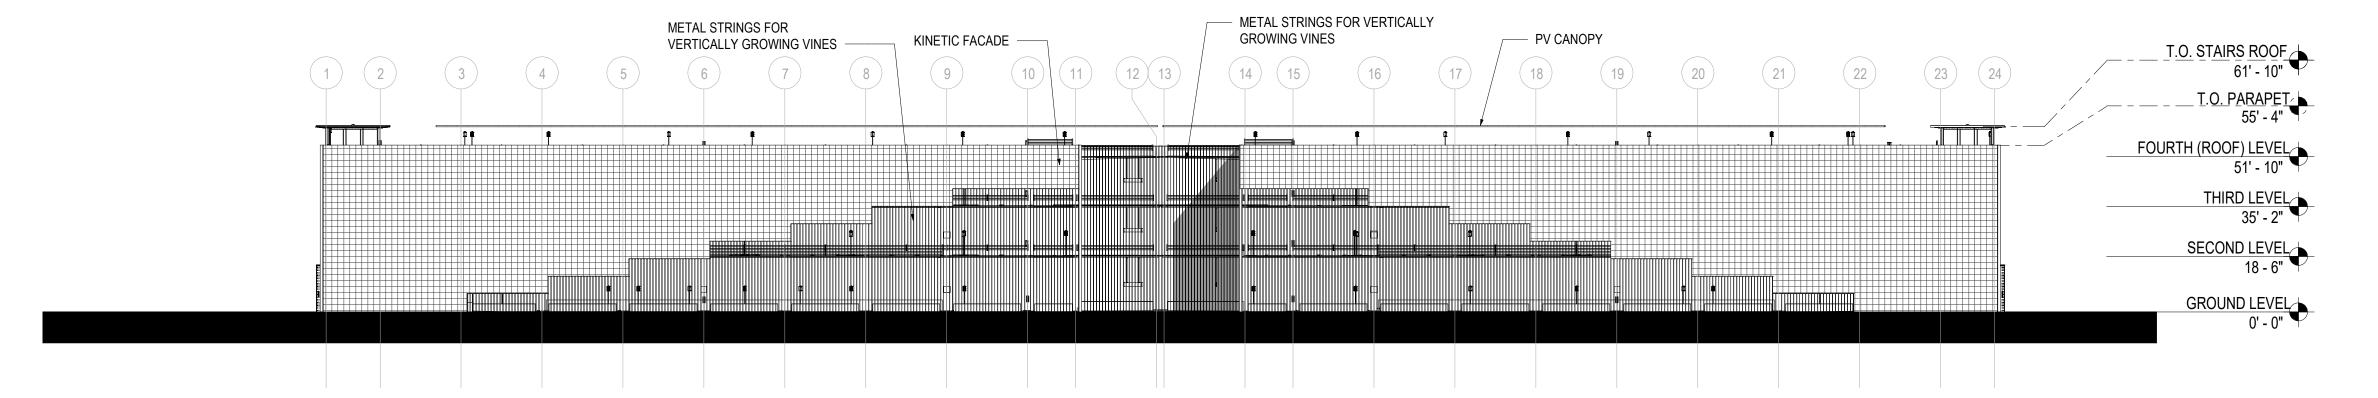
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PV CANOPY PLAN

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| | PROJECT No: | 18243 |
| SEAL & SIGNATURE: | DATE | 05/26/20 |



ELEVATION NORTH SCALE: 1/32" = 1'-0"



ELEVATION SOUTH

SCALE: 1/32" = 1'-0"



HUFF PARKING STRUCTURE

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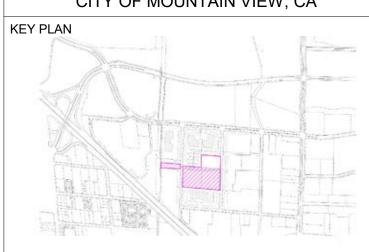
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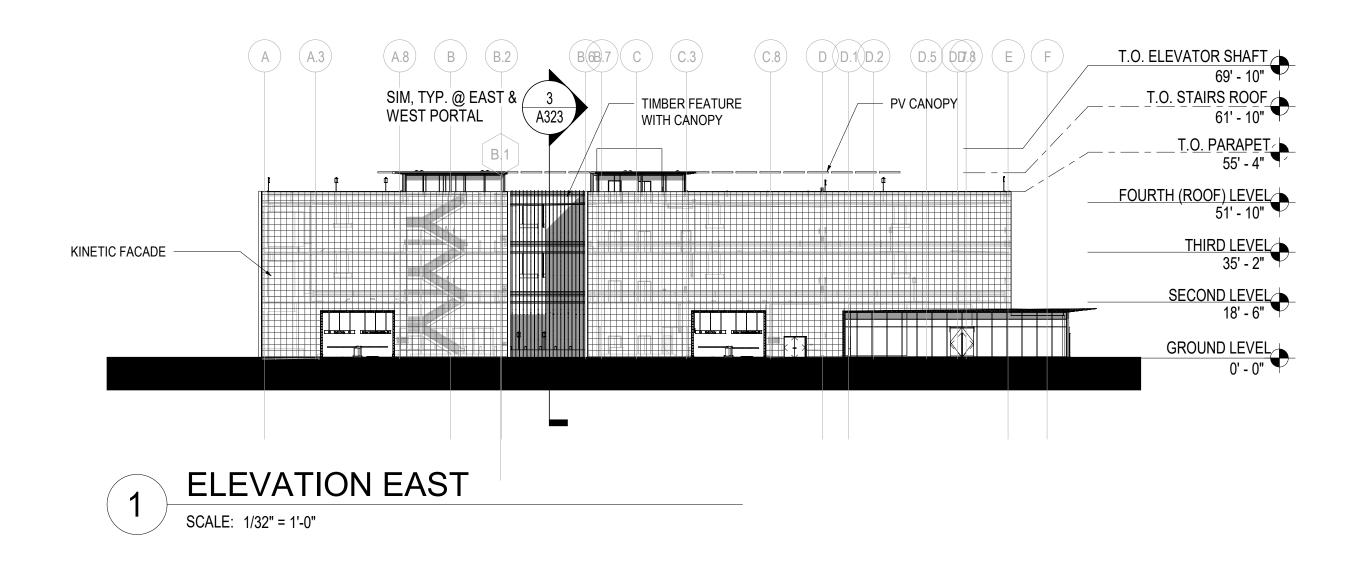



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BUILDING ELEVATIONS

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HUFF PARKING STRUCTURE

CITY OF MOUNTAIN VIEW, CA

KEY PLAN

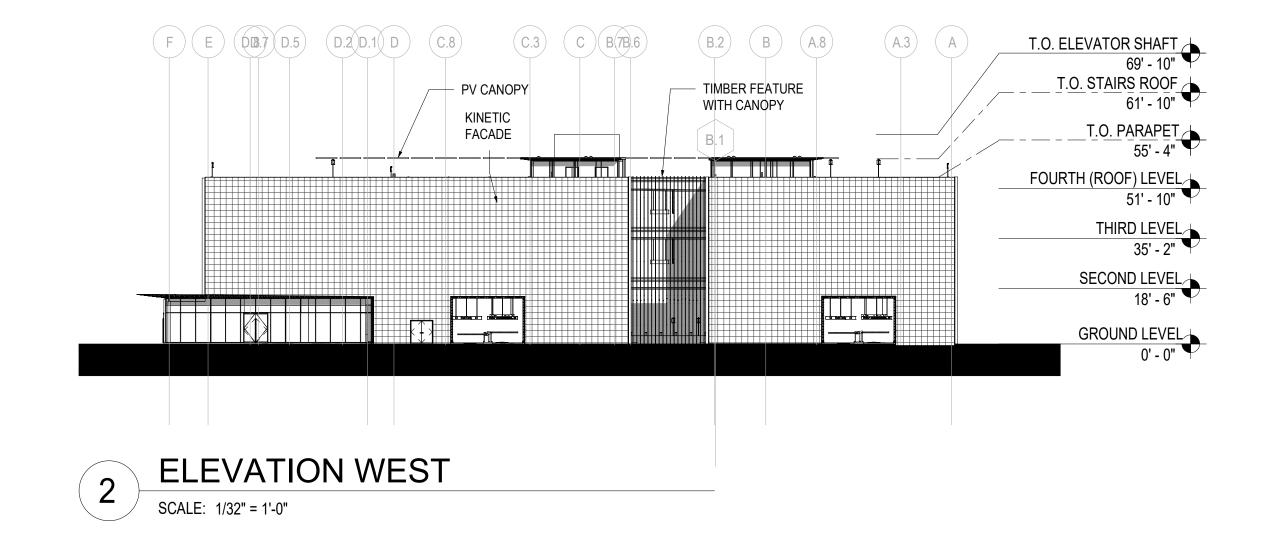

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BUILDING ELEVATIONS

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SOLAR STUDY


The architectural expression of the building facade is a series of undulating louvers that compose a transforming skin on all four sides. Based on the angle of rotation on each louver, it can admit light or block out light. The quantity of light admitted will change daily based on the solar angle and the season, hence resulting in a dynamic quality of daylighting and shadow effects.

Two large light wells are formed where the ramps travel from one floor to the next. It provides daylight deep into the center of the floor plate.

In summary, the intent is to introduce day-lighting from both the perimeter as well as from the center of the building in order to create occupant visual comfort.

SOLAR INCIDENCE ON NORTH AND EAST FACADES

SOLAR INCIDENCE ON SOUTH AND WEST FACADES

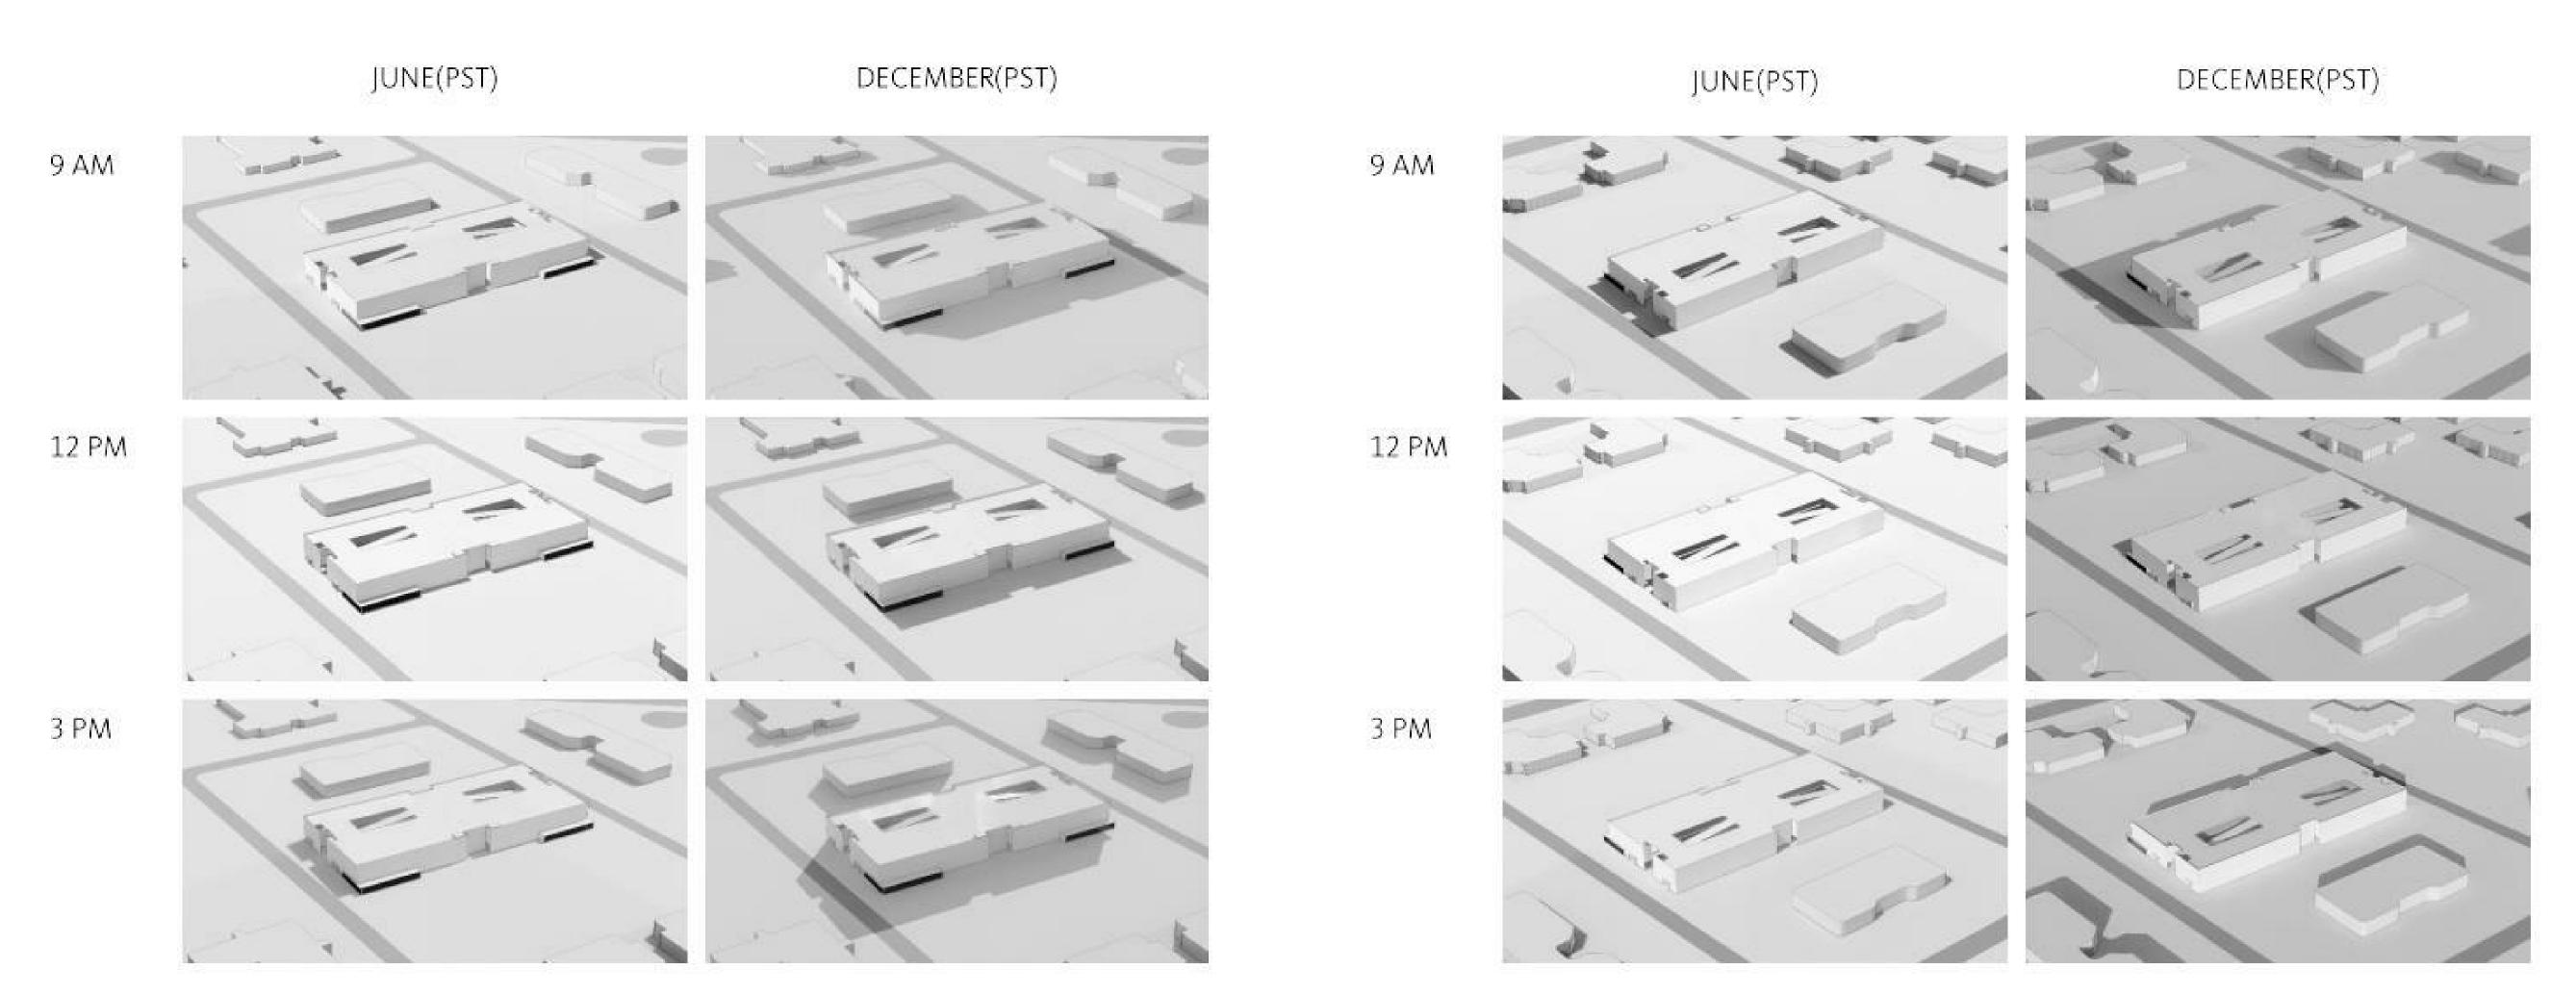

SOLAR STUDIES

SCALE: 1/4" = 1'-0"



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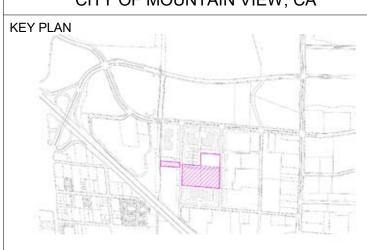
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| | 26 | G008 | Klaus Muitiparking | Klaus Muitiparking |
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