GENESIS/HYUNDAI SERVICE CENTER 2150 Old Middlefield Way, Mountain View, CA 94043 Formal Application for Conditional Use Permit and Development Review Permit

A.B. ABV. ABOVE A/C ACOUS ADJ. ADJ. ALT. AMP. AVG. AVERAGE BD. BOARD BLDG. BUILDING BLK'G. BLOCKING BLT-IN BUILT-IN BM. BEAM B.N. BRG. BEARING B.S. BAR SINK CABT. CABINET CALC. CMBR. CAMBER C.H.C. CHANGE C.I. C.J. C.L CLG. CEILING CLR. CLEAR CNTR. CNTRTP. C.O. CONC. CONT. CPT. CARPET C.R. CSMT.WDW CULT. DRYER DBL. DOUBLE DF DIA. OR DIAG DIM. DISP. DISPOSAL DP DEEP DR DOOR DRP. DROP D.S. DTL. DETAIL D.W. DWG. DRAWING DWR. DRAWER EACH ELEV. E.N. EO EXH. EQUAL EXT. EXHAUST E.W. EXTERIOR FΔII FG FG FIN FUEL GAS FIN.FLR FINISH

FLUOR.

F.M.C.

FND.

F.O.C

F.O.M.

F.O.S.

FR.DR.

FTG

FLUSH

FACE OF CURB

FACE OF STUDS

FRENCH DOOR FOOTING

FACE OF MASONRY

ANCHOR BOLT GALV. G.B. AIR CONDITIONING G.D. ACOUSTICAL G.D.O. ADJACENT ADJUSTABLE G.F.I. AL. ALUMINUM G.I. ALT. ALTERNATE AMPERAGE GL. GRD. GRND. GYP. G.L.B. G.T. BOUNDARY NAILING H.C. H.D. HDR. CALCULATION HGT. HNGR. CEILING HEIGHT INSUL CAST IRON INT. **CEILING JOIST** CENTER LINE LAV. LAM. L.F. COUNTER L.L. COUNTER TOP LUM. CASED OPENING LVR. CONCRETE MAR. CONTINUOUS MAS. MAX. CURTAIN ROD M.B. CASEMENT WINDOW M.C. CERAMIC TILE CULTURED MFR. MIN. MIR. M=L DOUGLAS FI M.O. DIAMETER MTD. DIAGONAL MTL. DIMENSION N.G. N.I.C. NOM. N.T.S. DOWNSPOUT 0/ DISHWASHER O.A. OBS. O.H. OSA ELECTRICAL O.S.B. ELEVATION EDGE NAILING P.B. P.C. P.C. PCE. EACH WAY PH. PLT. FORCED AIR UNIT PLAS. FINISH GRADE PLYWD. FIXED GLASS PR. PSF PSI **FINISH FLOOR** P=L FLOOR JOIST P.T.D.F. FLUORESCENT FLOOR MATERIAL PVC CHANGE FIELD NAILING FOUNDATION

ABBREVIATIONS GALVANIZED GYPSUM BOARD GARBAGE DISPOSAL GARAGE DOOR OPERATOR **GROUND-FAULT CIRCUIT- INTERRUPTER** GALVANIZED IRON GLASS GRADE GROUND GYPSUM **GLUED-LAMINATED** BEAM GIRDER TRUSS HOLLOW CORE HOLD DOWN ANCHOR HEADER HEIGHT HANGER INSULATION INTERIOR LAVATORY LAMINATED LINEAL FEET/FOOT LOG LIGHTER LUMINOUS LOUVER MARBLE MASONRY MAXIMUM MACHINE BOLT MEDICINE CABINET MFR. MANUFACTURER MIN. MINIMUM MIR. MIRROR MICRO LAM MASONRY OPENING MOUNTED METAL NATURAL GRADE NOT IN CONTRACT NOMINAL NOT TO SCALE OVER OVERALL OBSCURE O.C. OR O/C ON CENTER OVERHEAD OPENING OUTSIDE AIR ORIENTED STRAND BOARD PUSH BUTTON PORTLAND CEMENT PULL CHAIN PIECE PHONE PLATE PLASTER PLYWOOD PAIR POUNDS/SQUARE FOOT | W/ POUNDS/SQUARE INCH W.C. PARALLAM PRESSURE TREATED DOUGLAS FIR POLY VINYL CHLORIDE

RISER RADIAL/RADIUS **RETURN AIR GRILLE** RECEPTACLE REFERENCE REFRIGERATOR REINFORCING RE-SAWN REQUIRED REVERSE **REVISION/REVISE** ROOF JOIST ROUGH-IN ROUGH OPENING ROUGH SAWN ROOF RAFTER REDWOOD SINK SOLID CORE SCHEDULE SCRND. SCREENED SECOND SECTION SELECT SEL.STR. SELECT STRUCTURAL SERVICE SINGLE HUNG SHEET SHTHG SHEATHING SHOWER SLIDING SPLASH SHELF & POLE SERVICE SINK STANDARD SHEET VINYL STRUCT. STRUCTURAL SWITCH TREAD TOP & BOTTOM TEMP.GL. TEMPERED GLASS **TONGUE & GROOVE** TRUSS JOIST TOP OF CURB TOP OF SLAB TOP OF WALL TELEVISION UNFIN. UNFINISHED URINAL U.N.O. UNLESS NOTED **OTHERWISE** VANITY VENEER VERTICAL VERTICAL GRAIN VAPOR BARRIER VAPORPROOF WASHER WITH WATER CLOSET WOOD WINDOW WATER HEATER

RAD.

R.A.G.

RECPT

REFER.

REINF.

RE/S

REQ'D

RE.

REV.

R.J.

RO-IN

R.O.

RO/S

RWD.

R.R.

S.C.

SCH.

SEC.

SEL.

SER.

S.H.

SHT.

SL.

SPL.

SPN.

S & P

S.S.

STD.

S.V.

SW.

T & B

T.C.

T & G

TJI.

T.O.C.

T.O.M.

T.O.S.

T.O.W.

T.V.

UR.

VAN.

VEN.

VERT.

V.G.

V.B.

V.P.

WD.

WDW.

W.H.

W/O

W.P.

W/R

WT.

SHWR.

SECT.

REF.

SILL PLATE NAILING TRASH COMPACTOR

TOP OF MASONRY

WITHOUT WEATHER PROOF WARDROBE WEIGHT

PROJECT DESCRIPTION:

CONDITIONAL USE PERMIT - THIS CONDITIONAL USE PERMIT IS FOR THE TENANT IMPROVEMENTS. OCCUPANCY AND OPERATIONS OF A NEW GENES-HYUNDAI AUTOMOTIVE SERVICE CENTER ("SERVICE CENTER") FOR " AUTOMOBILE REPAIR, MINOR USE " LOCATED AT PROJE 2150 OLD MIDDLEFIELD WAY WITHIN AN EXISTING, 11,130 SQUARE FOOT WAREHOUSE STYLE BUILDING ON A 0.81 ACRE LOT ("THE PROJECT"). THE EXISTING BUILDING, BUILT IN 1965, HAS 3 GRADE LEVEL ROLL UP DOOR, 5 DOUBLE DOORS, 13' - 15' CLEAR HEIGHT, AND 800-AMPS, 120/240-VOLTS OF POWER. THE EXISTING SURFACE PARKING LOT HAS 42 SPACES. THE ASSOCIATED GENESIS-HYUNDAI STUDIO SHOWROOM ("SHOWROOM") IS LOCATED APPROXIMATELY 1.5 MILES AWAY AT 2575 CALIFORNIA STREET, SUITES 90 & 92, AT THE VILLAGE AT SAN ANTONIO NORTH IN MOUNTAIN VIEW, CA. THE SHOWROOM IS NOT A PART OF THIS APPLICATION.

PARKING REDUCTION

THE CITY HAS DETERMINED THAT THE PROJECT FALLS WITHIN THE CATEGORY OF "REPAIR AND MAINTENANCE - VEHICLE - REPAIR GARAGE" UNDER THE MOUNTAIN VIEW PARKING AND LOADING CODE SECTION 32.36.50, WHICH REQUIRES 5 SPACES PLUS 1 SPACE FOR EACH 200 SW. FT. OOF GROSS FLOOR AREA. THIS CONDITIONAL USE PERMIT PROVIDES FOR A PARKING REDUCTION IN CONFORMANCE WITH SECTION 36.32.65 SPECIFICALLY, THE PROJECT REQUESTS A REDUCTION IN PARKING TO PROVIDE 38 SPACES WHERE 61 ARE REQUIRED

DEVELOPMENT REVIEW PERMIT THIS DEVELOPMENT REVIEW PERMIT IS FOR THE ADDITION OF MINOR FACADE ENHANCEMENTS THAT INCORPORATE MATERIALS. TEXTURES, AND COLOR COMPLIMENTARY AND CONSIST WITH THE GENESIS-HYUNDAI BRANDS

MOUNTAIN VIEW 2030 GENERAL PLAN -THE SITE IS DESIGNATED GENERAL COMMERCIAL UNDER THE MOUNTAIN VIEW GENERAL PLAN, WHICH SUPPORTS A BROAD RANGE OF COMMERCIAL AND LIGHT INDUSTRIAL SERVING BUSINESSES AND RESIDENTS (SUCH AS AUTOMOTIVE REPAIR).

ZONING -THE SITE IS LOCATED WITHIN THE (CS) COMMERCIAL - SERVICE ZONING DISTRICT, WHICH ALLOWS SERVICE COMMERCIAL AND INDUSTRIAL USES THAT SERVE LOCAL RESIDENTS AND BUSINESSES. THESE USES INCLUDE AUTOMOTIVE REPAIR, RETAIL AND WHOLESALE BUSINESSES, CARPENTRY SHOPS, VETERINARY CLINICS AND SIMILAR AND RELATED COMPATIBLE USES.

TENANT IMPROVEMENTS

THE FRONT QUARTER OF THE BUILDING WILL BE DIVIDED INTO SEPARATE GENESIS AND HYUNDAI SERVICE FACILITIES WITH COVERED DROP-OFF AREAS ("PORTE COCHERES"), RECEPTION AREAS, AND SERVICE WRITERS OFFICES. EACH BRAND WILL HAVE LUNGES WITH COFFEE BARS AND RESTROOMS. THE REMAINDER OF THE FACILITIES WILL CONSIST OF 01 SERVICE BAYS (7 FOR GENESIS AND 7 FOR HYUNDAI) FOR GASOLINE AND ELECTRIC POWERED VEHICLES. INTERIOR ROOMS ARE PROVIDED FOR TRASH AND EV STORAGE. INTERIORS ARE DECORATED WITH A MODERN SOPHISTICATED, MINIMALIST AESTHETIC WITH HIGH END FINISHES. THE FRONT FACADE OF THE BUILDING, INCLUDING THE TWO PORTE-COCHERES, FEATURE ACM FASCIAS IN LINE WITH EACH BRAND'S MATERIALS. COLOR PALATE AND DESIGN OBJECTIVES. MINIMAL SITE IMPROVEMENTS ARE PROPOSED.

EMPLOYEES APPROXIMATELY 15 - 20 EMPLOYEES.

HOURS OF OPERATION

NOTES ALL SIGNS ARE CONCEPTUAL AND WILL BE SUBMITTED UNDER SEPARATE PERMIT



GENERAL NOTES

SAFETY, THE GENERAL CONTRACTOR IS RESPONSIBLE FOR ALL SAFETY PRECAUTIONS OR SAFETY PROGRAMS USED TO PROVIDE A SAFE WORKING ENVIRONMENT ON THE JOB SITE. CONSTRUCTION EXECUTION, EACH CONTRACTOR SHALL FURNISH ALL LABOR, MATERIALS, TOOLS, TRANSPORTATION, AND EQUIPMENT NECESSARY TO PERFORM ALL WORK UNDER HIS TRADE IN FULL ACCORDANCE WITH THE WORKING DRAWINGS, SPECIFICATIONS AND CONTRACTS.

JOB SITE CONDITIONS, EACH CONTRACTOR SHALL CLEAN UP AND REMOVE ALL DEBRIS RESULTING FROM HIS WORK PRIOR TO SUBMITTING REQUEST FOR PROGRESS PAYMENT. IN NO CASE WILL FINAL PAYMENT BE DISPERSED TO EITHER THE PRIME CONTRACTOR OR ANY SUB-CONTRACTOR UNTIL ALL DEBRIS AND EQUIPMENT OWNED BY SAID CONTRACTOR'S, HAS BEEN REMOVED FROM THIS PROJECT SITE OR UNTIL OWNER APPROVAL HAS BE GRANTED.

THE RESPONSIBLE PARTY, EITHER THE PROJECT OWNER OR THIS SIGNED DESIGNER, SHALL BE NOTIFIED OF ERRORS OR OMISSIONS FOR CORRECTIONS BEFORE PROCEEDING WITH THE WORK. STORAGE, MATERIALS STORED ON SITE SHALL BE PROTECTED FROM DAMAGE BY MOISTURE, WIND, SUN, ABUSE OR ANY OTHER HARMFUL AFFECTS.

CHANGES, ANY MINOR OR REQUIRED CHANGES OR MODIFICATIONS TO THIS PLAN DO NOT REDUCE OR VOID THE COPYRIGHTS COVERING THIS SET OF PLANS IN ANY WAY. MODIFICATIONS TO THIS PLAN, FOR ANY REASON, SHOULD BE ATTEMPTED BY AND ARCHITECT OR ENGINEER ONLY. DESIGNER ACCEPTS NO RESPONSIBILITY FOR THE QUALITY AND COMPLETENESS OF ANY CHANGES ATTEMPTED.

MATERIALS, ALL MATERIALS, SUPPLIES AND EQUIPMENT SHALL BE INSTALLED PER MANUFACTURERS RECOMMENDATIONS AND PER APPLICABLE CODES AND REOUIREMENTS. THE DESIGNER SHALL HAVE NO CONTROL OR CHARGE OF AND SHALL NOT BE RESPONSIBLE FOR CONSTRUCTION MEANS, METHODS, TECHNIQUES, SEQUENCES, OR PROCEDURES IN CONNECTION WITH THE WORK, FOR THE ACTS OR OMISSIONS OF THE CONTRACTOR, SUB-CONTRACTOR, OR ANY OTHER PERSON PERFORMING ANY OF THE WORK, OR FOR THE FAILURE OF ANY OF THEM TO CARRY OUT THE WORK IN ACCORDANCE WITH THE CONTRACT DOCUMENTS.

TENANT: CARDINALE AUTO GROUP 3239 IMJIN RD MARINA, CA 93933 CONTACT: MICHAEL WARD EMAIL: MWARD@CARDINALEWAY.COM

ARCHITECT AND G.C. :

DARCO LLC 999 WEST TAYLOR ST, SUITE A SAN JOSE, CA 95126 CONTACT: DARWIN FAJARDO EMAIL: DARWIN@DARCO-CA.COM

STRUCTURAL ENGINEER:

TY ENGINEERING AND DESING 952 MANHATTAN BEACH BLVD., SUITE 260 MANHATTAN BEACH, CA 90266 (310) 935-0060 (PHONE) WWW.TY-ENG.COM

PROJECT DESCRIPTION

THE SERVICE CENTER WILL BE OPEN 6 DAYS PER WEEK: MONDAY - FRIDAY 7:30 AM - 6:00 PM, AND SATURDAYS 8:00 AM - 3:00 PM.

PROJECT DATA LOCAL JURISDICTION: CITY OF MOUNTAIN VIEW, CA ASSESOR'S PARCEL NUMBER: 147-07-077

PROJECT ADDRESS:	2150 OLD MIDDLEFIELD WAY, MOUNTAIN VIEW, CA 94043
ZONING:	CS - COMMERCIAL-SERVICE
OCCUPANCY GROUP:	B & S-1
CONSTRUCTION TYPE:	TYPE V-B 1 STORY 9,000 SF
NO. OF STORIES:	1 STORY
LOT NUMBER:	77
FIRE SPRINKLES SYSTEM:	PROPOSED NEW
AREA:	GROSS LAND AREA OF RECORD IS 34,592 SQ.FT. / 0.81 ACRE

ZONING - THE PROPERTY IS IN THE CS (COMMERCIAL –SERVICE) ZONING DIS WHICH ALLOWS SERVICE COMMERCIAL AND INDUSTRIAL USES. THESE USES AUTOMOTIVE REPAIR, RETAIL AND WHOLESALE BUSINESSES, DISTRIBUTION, RESEARCH AND DEVELOPMENT, WAREHOUSING, VETERINARY CLINICS AND I

ALLOWABLE CALCULATION TABLE 506.2 OCCUP. GROUP B& S-1

CONSTRUCTION TYPE: VB 1-STORY 9000SF FULLY SPRINKLERED: 36,000 SF

FLOOR AREA RATIO AND REQUIRED PARKING CALCULATION

TOTAL BUILDING SQUARE FOOTAGE: 11,130 SF TOTAL SITE SQUARE FOOTAGE: (.81 ACRE) 34,592 SF

FLOOR AREA RATIO:

MAIN BUILDING: 11,130 SF

11,130 / 34,592 SF = 32.2 %

REQUIRED AND PROPOSED PARKING: REPAIR GARAGE : 5 + 11,130 SF / 200 = 61 STALLS REQUIRED

PROPOSED PARKING SPACES: (PROVIDED)

DIAGONAL PARKING STALLS	13
ADA PARKING (VAN)	1
TEMPORARY PARKING FOR SERVICE PERSONNEL	10
SERVICE BAYS	14
TOTAL PARKING PROVIDED	38
BICYCLE PARKING:	0


MEP ENGINEER : STEVEN T. TOYAMA, M.E. JORGE HOYOS, E.E. TOYAMA & ASSOCIATES (661) 296-3880 OFFICE

CIVIL ENGINEER : SMP ENGINEERS SAEID RAZAVI 1534 CAROB LANE LOS ALTOS, CA, 94024 (408) 472-5062 SRAZAVI@SMPENGINEERS.COM

CODE REFERENCE

ALL CONSTRUCTION SHALL COMPLY WITH THE MINIMUM REQUIREMENTS OF THE FOLLOWING 2022 CALIFORNIA BUILDING STANDARDS CODE, CCR TITLE 24:

APPLICABLE BUILDING CODES: 2022 CALIFORNIA ENERGY CODE 2022 CALIFORNIA FIRE CODE 2022 CALIFORNIA STANDARDS CODE 2022 CALIFORNIA BUILDING CODE (CBC) 2022 MECHANICAL CODE (CMC) 2022 PLUMBING CODE (CPC) 2022 CALIFORNIA ELECTRICAL CODE (CEC) 2022 CALIFORNIA GREEN BUILDING CODE CODE OF ORDINANCES SAN MATEO COUNTY 2022 CALIFORNIA RESIDENTIAL CODE (CRC)

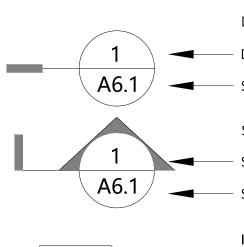

A6.1

OFFICE 101

GENE

DETAIL REFERENCE

- DETAIL NUMBER
- SHEET NUMBER
- SECTION REFERENCE
- SECTION NUMBER
- SHEET NUMBER

SECTION NUMBER

- INTERIOR ELEVATION REFERENCE
- ELEVATION NUMBER/LETTER

ROOM NAME AND NUMBER

		DARCON DESIGN - ARCHITECTURE - CONSTRUCTION 999 W TAYLOR ST. SUITE A SAN JOSE, CA 95126
	SHEET INDEX	PHONE: 408-827-4591 EMAIL: INFO@DARCO-CA.COM
	GENERAL CS PROJECT DATA AND INFORMATION A0.1 HEXAGON SITE PLAN AND VEHICLE CIRCULATION PLAN	CSLB #1079457
	ARCHITECTURALA1.1EXISTING SITE CONDITIONS 1A1.2EXISTING SITE CONDITIONS 2A1.3EXISTING AND NEW SITE PLAN	
	A1.4 NEW SITE PLAN A1.5 SITE PARKING CIRCULATION PLAN A1.6 TRASH MANAGEMENT PLAN A2.1 RENDERINGS 1	PROJECT:
	A2.2 RENDERINGS 2 A3.1 EXISTING SITE PLAN	HYUNDAI - GENESIS SERVICE CENTER
STRICT S INCLUDE N, OFFICE, MORE.	 A3.2 EXISTING FLOOR PLAN AND DEMO A3.3 ZONING DIAGRAM AND EGRESS PLAN A3.4 NEW ROOF PLAN 	PROJECT ADDRESS: 2150 Old Middlefield Way, Mountain View,CA 94043
	A4.1 EXISTING ELEVATIONS A4.2 NEW ELEVATIONS A4.3 NEW SECTIONS	CLIENT: Cardinale Automotive Group
	A5.2 SITE PHOTOMETRIC PLAN	
	A5.3 SHADOW STUDY A6.1 SITE DETAILS	
	A6.2 ACM DETAILS SURVEY	<u><u> </u></u>
	T1-1 PRELIMINARY BOUNDARY AND TOPOGRAPHIC SURVEY MAP T1-2 PRELIMINARY BOUNDARY AND TOPOGRAPHIC SURVEY MAP	A SERVICE R ield Way, CA 94043
		TER MDAI JIefield V v, CA 94
	CITY APPROVAL STAMPS	
Colony St		GENESIS/HYUNDAI SER CENTER 2150 Old Middlefield Way, Mountain View, CA 94043
Bayer Academy S Academy S Academy S Eol Eol		PROJECT NO. : 2024-03 REVISION:
		PER CITY COMMENTS 06.27.24
	EXISTING FULL	SHEET TITLE:
	HEIGHT WALL NEW FULL HEIGHT WALL REVISION	COVER SHEET DESIGNED BY:
E		KK DRAFTING BY: KC
	AREA/WALLS TO DEMO	SHEET NO:
	DETAIL OR PLAN ENLARGEMENT 1 COLUMN LINES 1 DETAIL NUMBER A6.1 SHEET NUMBER	CS

Summary of Proposed Site Operations

The proposed service center would include 14 service bays and would be split evenly between services for Genesis vehicles and services for Hyundai vehicles. The Service Center facility would be for service and maintenance only and would not include a showroom or new car inventory. It is anticipated that the proposed Service Center would be open 6 days per week, Monday through Friday, from 7:30 AM to 6:00 PM and Saturday 8:00 AM to 3:00 PM.

The Applicant's Showroom and Service Center locations will operate as one dealership. There will be approximately 15 - 20 employees at the Service Center. Of this total, approximately 8 - 12 employees will be technicians servicing cars in the 14 on-site service bays. A single technician may service more than one bay. The remaining personnel will be Staff members supporting Service Center operations such as service writers and concierge pick up/delivery personnel. Some personnel from the Showroom may also be deployed for concierge pick up/delivery. The project would maintain the two existing driveways along Old Middlefield Way. The eastern driveway would be full access and would provide direct access to the Hyundai side of the Service Center. The western driveway would be inbound only and would provide direct access to the Genesis side of the Service Center. Vehicles that enter via the eastern driveway would require a three-point turn to turn around and exit the site. Vehicles that enter via the western driveway would navigate through the site in a clockwise direction.

The proposed Service Center would handle mostly routine maintenance, and small warranty repairs covered under the first three years of vehicle purchase. This would include minor maintenance such as oil changes, tire rotation, changing transmission fluid, replacement of air and oil filters, and safety inspections. The proposed service center would not perform any collision or body shop repair services. The proposed Service Center would also sell parts to local repair shops.

The Project proposes a new concept in vehicle service and maintenance to increase customer convenience. Customers would make an appointment, and staff would pick-up and drop-off the vehicle at the customer's home, work, or preferred location. Customers also could drop off vehicles by appointment, but the project applicant estimates that approximately 100% of Genesis customers and approximately 50% or more of Hyundai customers would use the concierge service. With this concierge service, on-site management of vehicles would be tightly coordinated. Staff would control the scheduling of pick-ups and returns, and customers would generally not have to visit the service center. Therefore, no AM/PM queuing by customers is expected since service of vehicles would primarily be handled by appointment only, spread throughout the day, and centrally managed by staff to pick-up/drop-off vehicles.


The Applicant expects that each service bay would serve approximately 1 to 2.5 vehicles per day on average; thus, the average total number of vehicles estimated to be serviced each day is approximately 14 to 35. Employees would not park on-site. The proposed project would work in conjunction with the Genesis-Hyundai Showroom at the Village at San Antonio North (2575 California Street, Suites 90 - 92 in Mountain View, California). The employees for the Service Center would park at the showroom site and be shuttled over to the Service Center site in one of the dealership vehicles.

Deliveries


It is estimated that parts would be delivered to the site approximately 3 times per week. Parts typically would be delivered in the early morning or at night in a small box van. Delivery vans would drop off the parts at the proposed Service Center and retrieve any discarded parts boxes for reuse purposes. No large trucks would need to travel through the site.

Parking


The proposed site plan shows a total of 24 parking spaces, including 12 diagonal spaces and 1 ADA space, and 10 exterior parking spaces for temporary "staging" of vehicles operated by Service Center employees during daily service operations. Additionally, the site includes 14 service bays that can house cars, if needed, overnight. In total, the site has capacity for 38 cars at one time without stacking or tandem parking. A Parking Analysis for the Proposed Genesis-Hyundai Service Center, dated Oct. 11, 2024, prepared by Hexagon Transportation Analysis demonstrates that the proposed supply of parking on-site is greater than the anticipated demand and would be adequate to serve the operational needs of the Project.

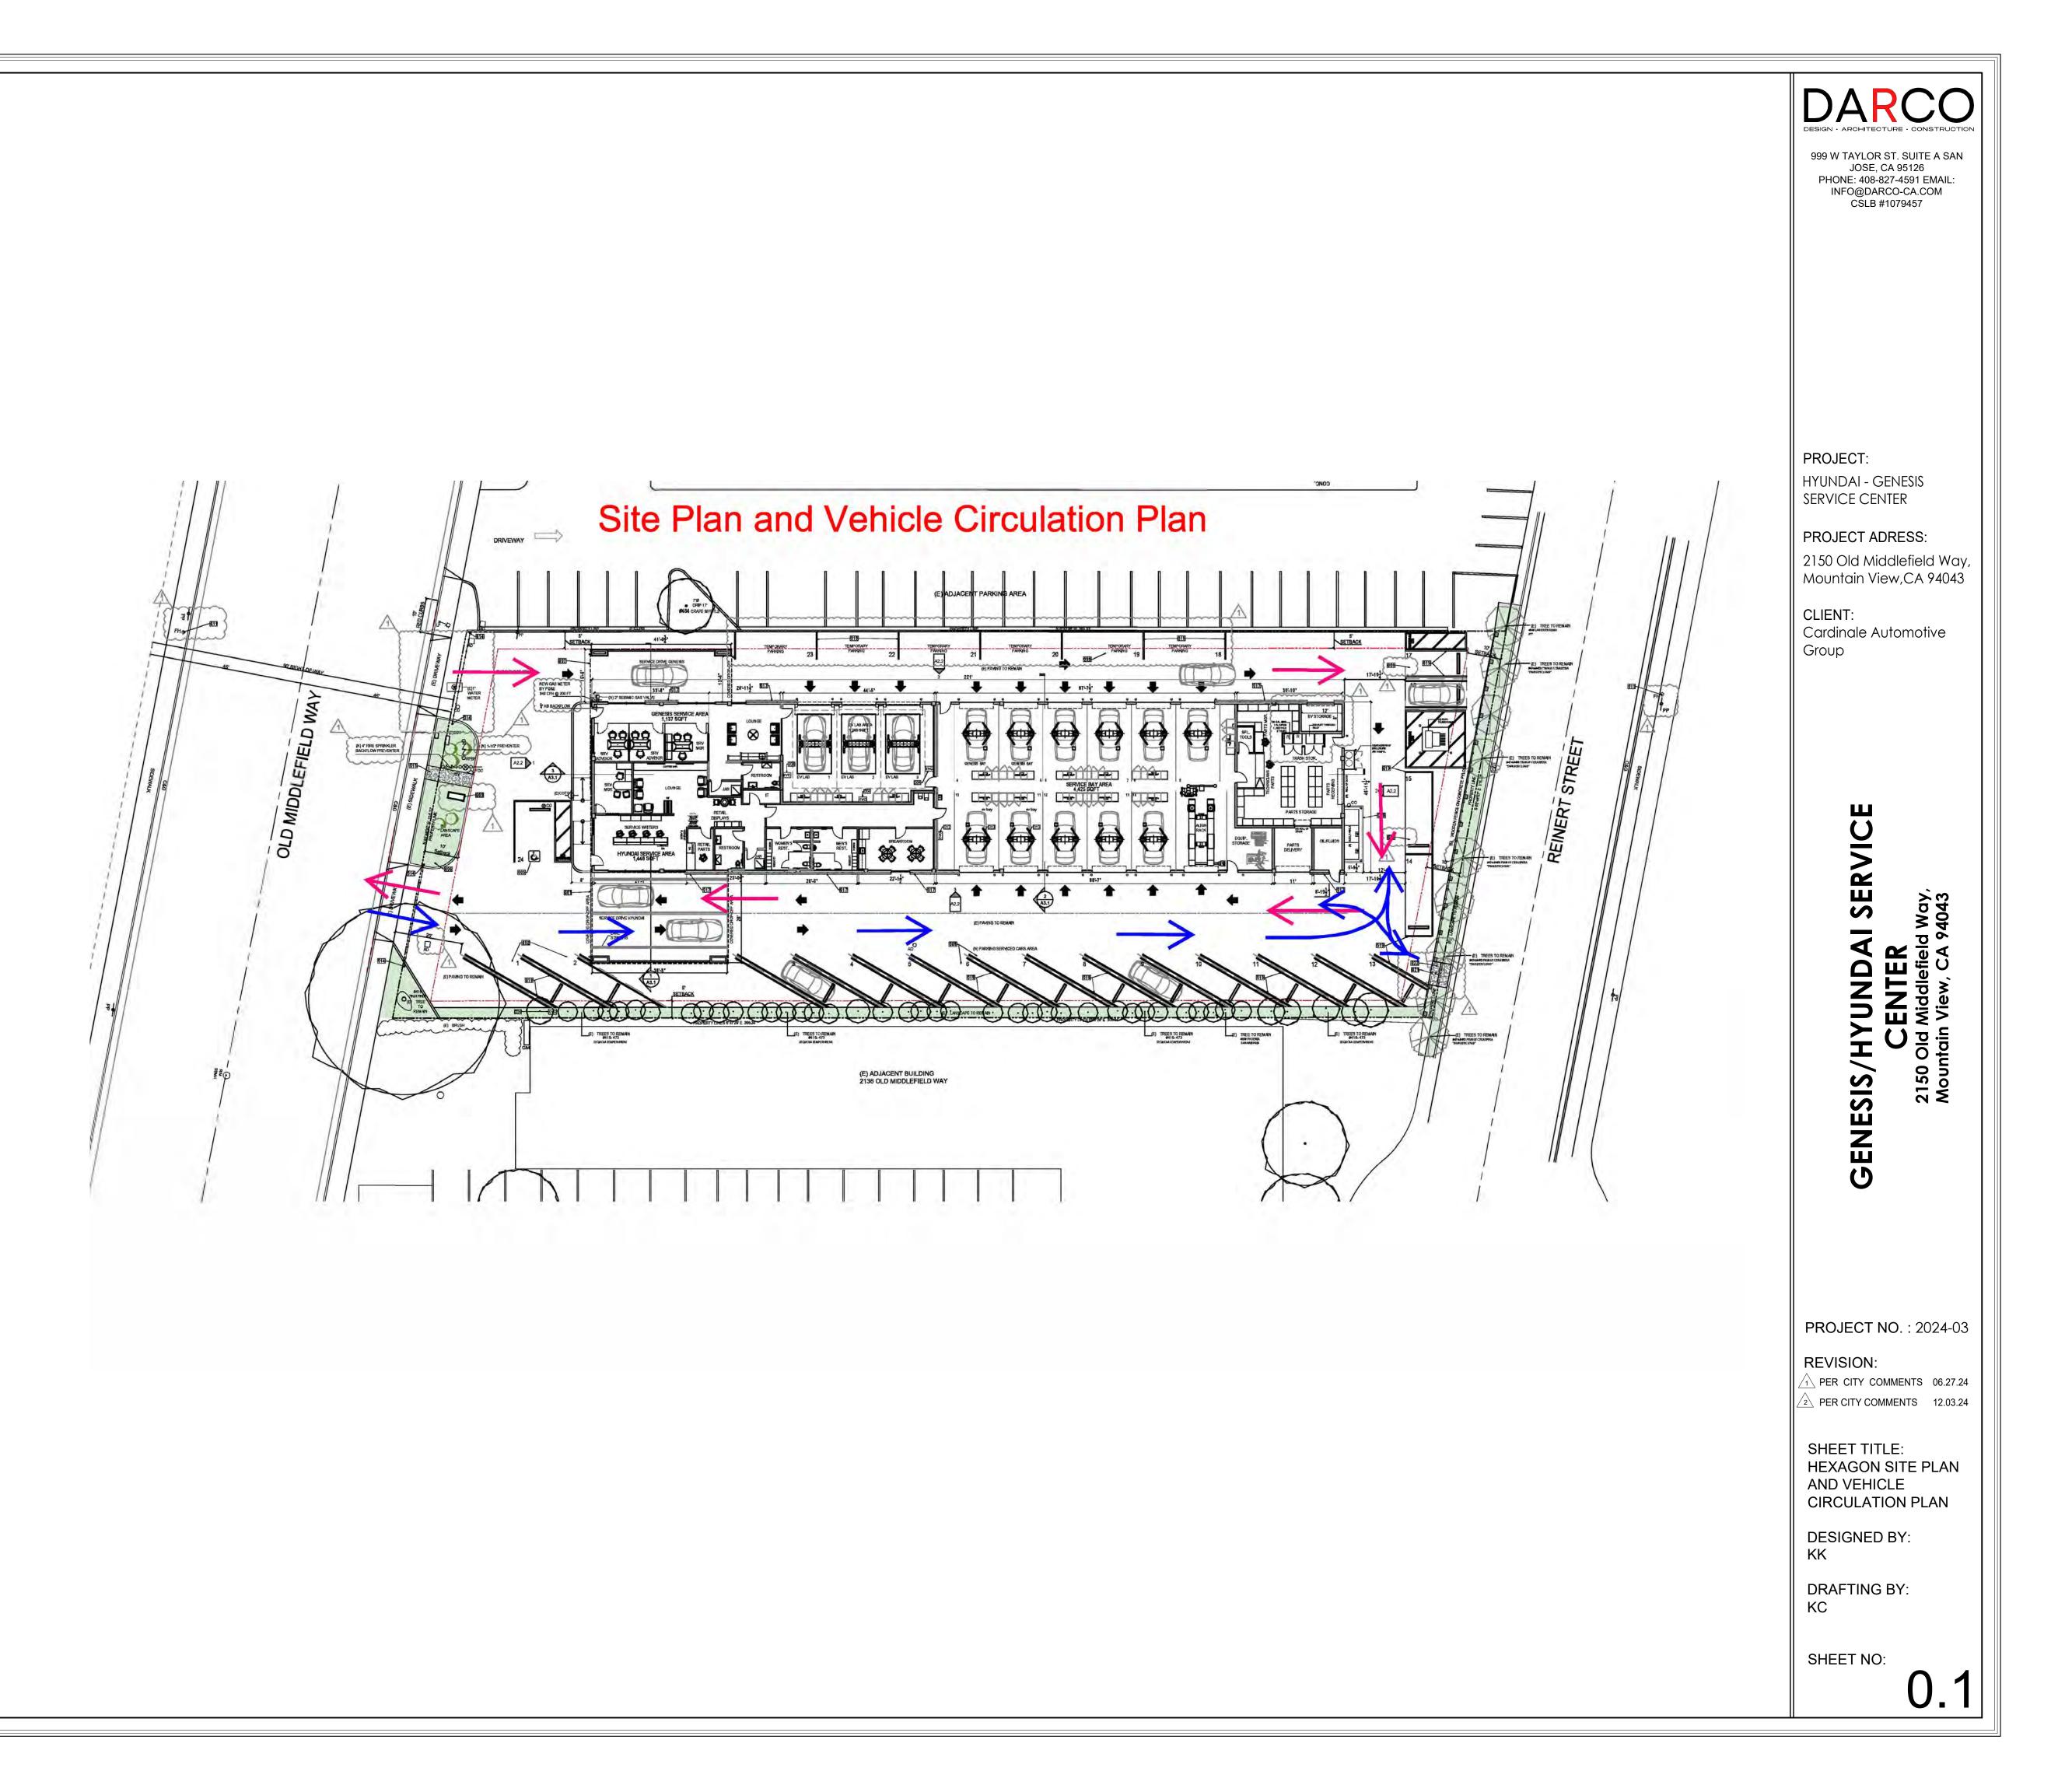



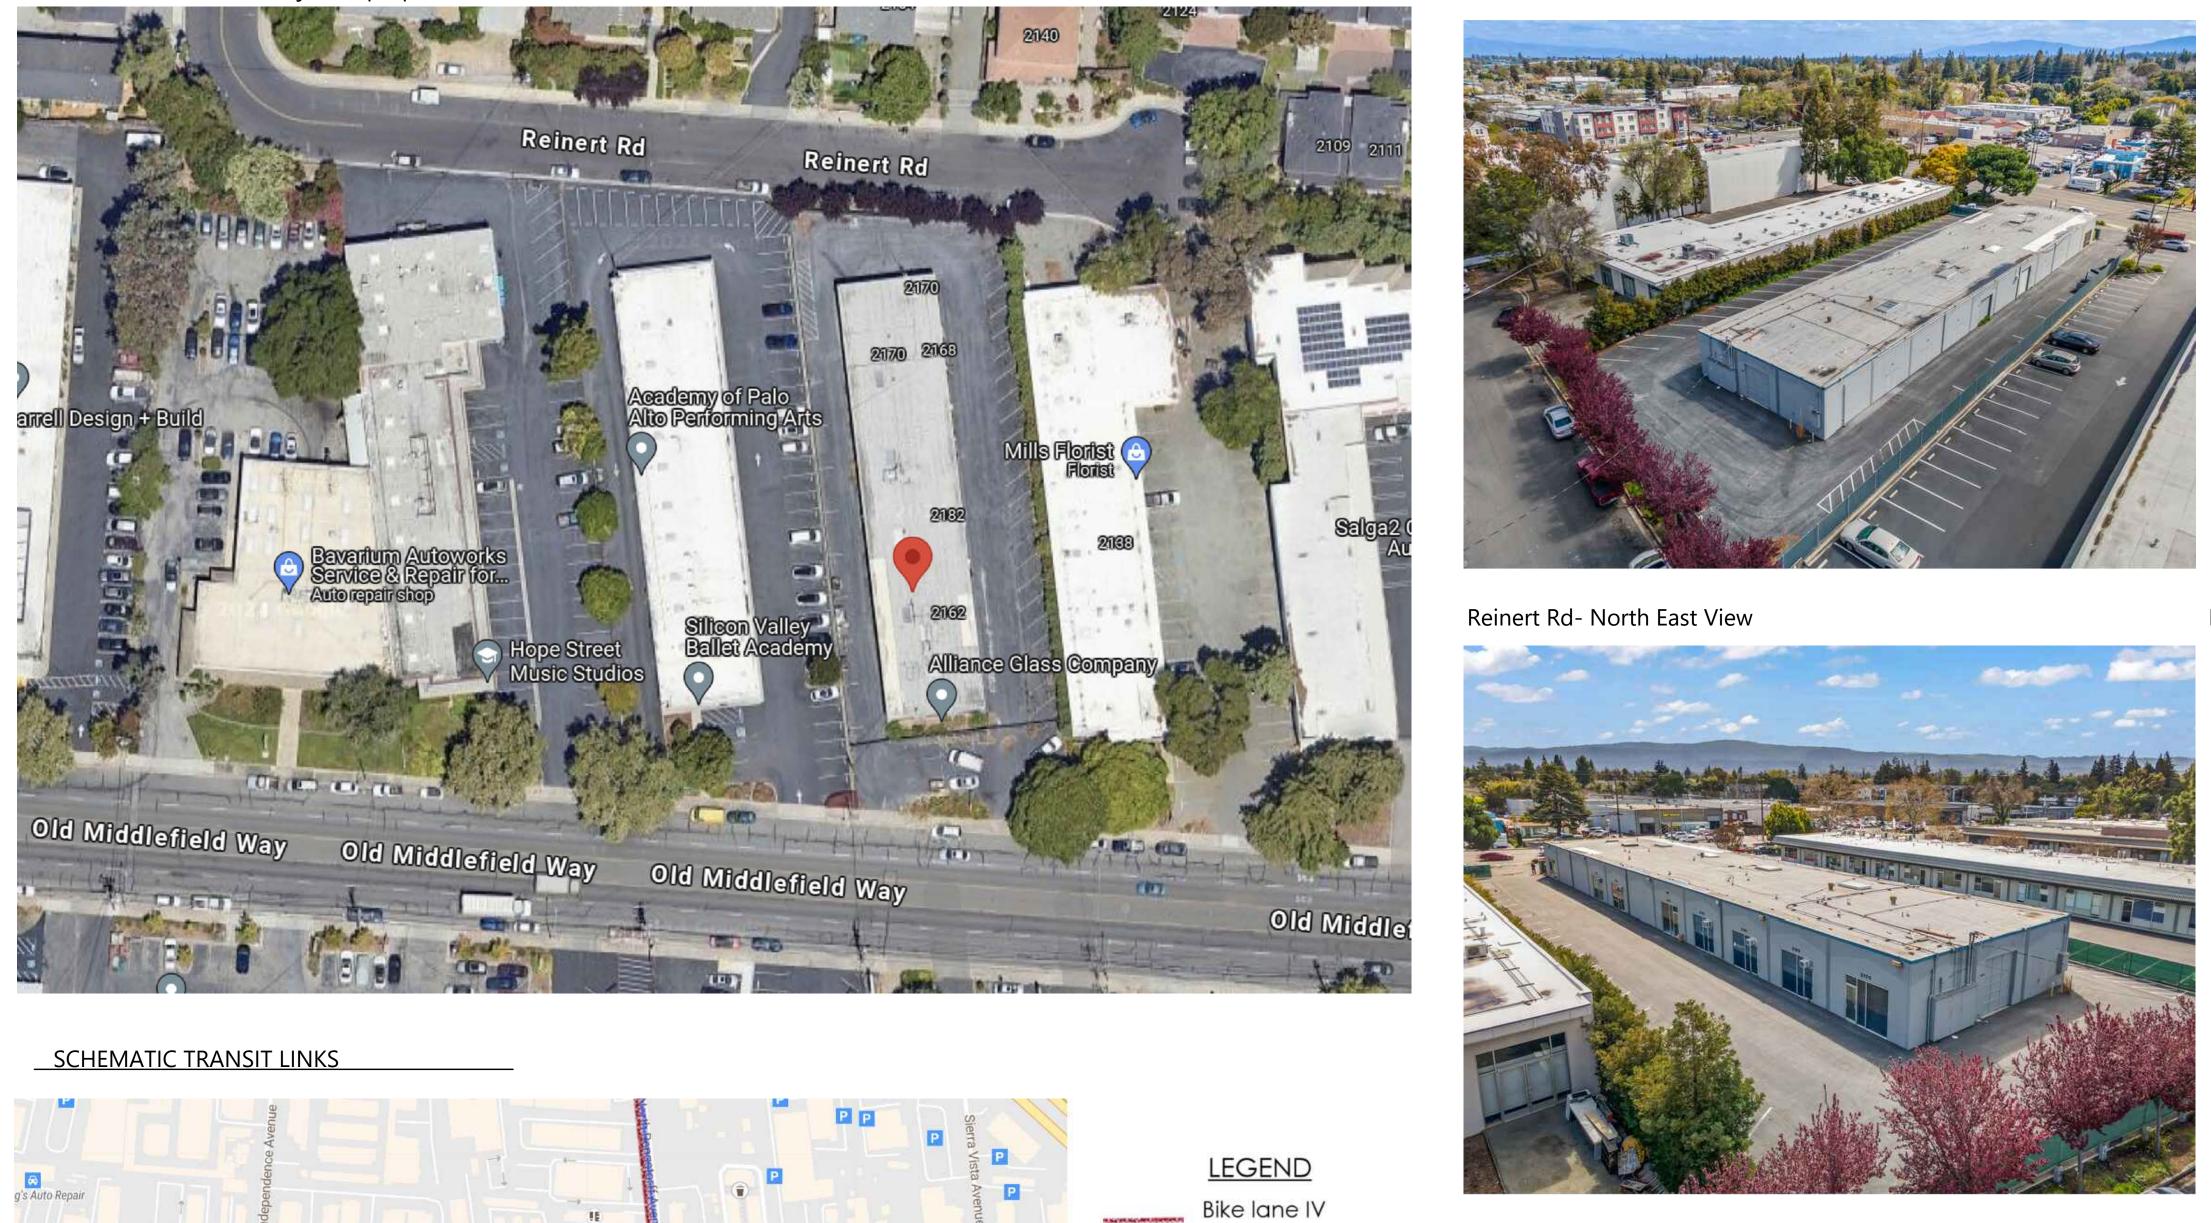


Aerial View- Site and adjacent properties

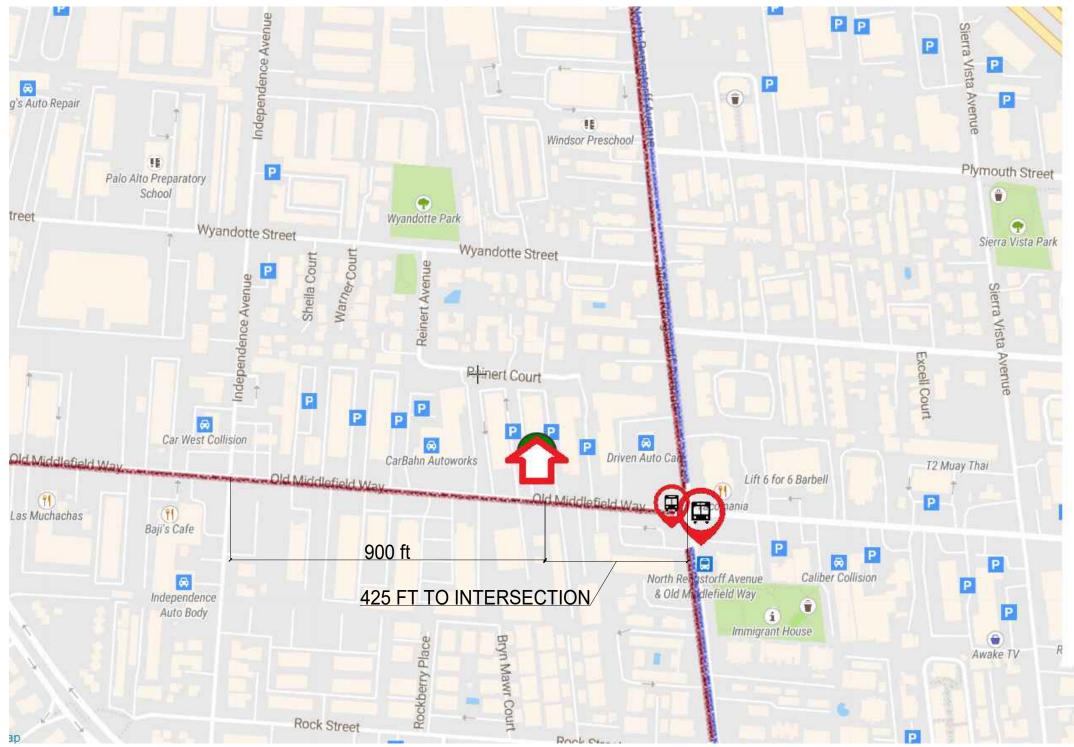


Reinert Rd- North West View

Reinert Rd- Rear View

EXISTING SITE CONDITIONS -INTERIOR (2)

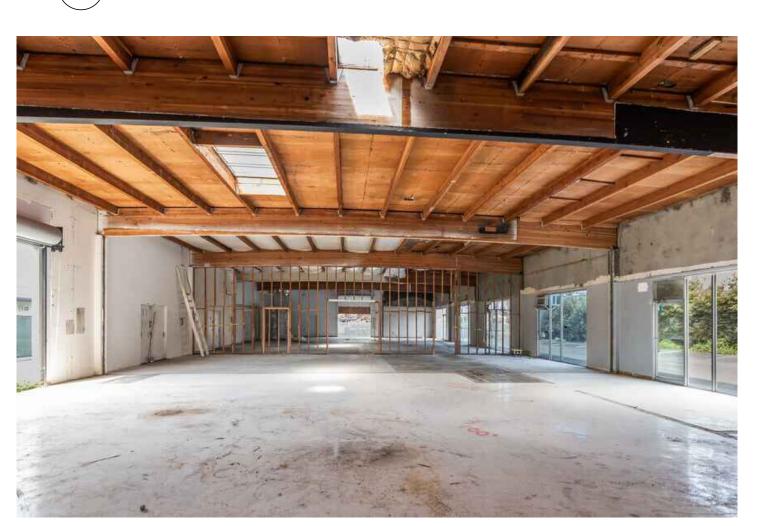



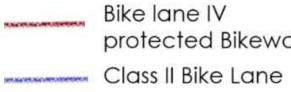

P

Bus stop

protected Bikeway

Parking


Old Middlefield Way- South West View







DARCO DESIGN - ARCHITECTURE - CONSTRUCTION 999 W TAYLOR ST. SUITE A SAN JOSE, CA 95126 PHONE: 408-827-4591 EMAIL: INFO@DARCO-CA.COM CSLB #1079457 PROJECT: HYUNDAI - GENESIS SERVICE CENTER PROJECT ADDRESS: 2150 Old Middlefield Way, Mountain View,CA 94043 CLIENT: Cardinale Way SERVICE Way, 4043 GENESIS/HYUNDAI CENTER 2150 Old Middlefield M Mountain View, CA 940 PROJECT NO. : 2024-03 **REVISION**: PER CITY COMMENTS 06.27.24 PER CITY COMMENTS 12.03.24 SHEET TITLE: EXISTING SITE **CONDITIONS 1** DESIGNED BY: KK DRAFTING BY: КC SHEET NO: A1.

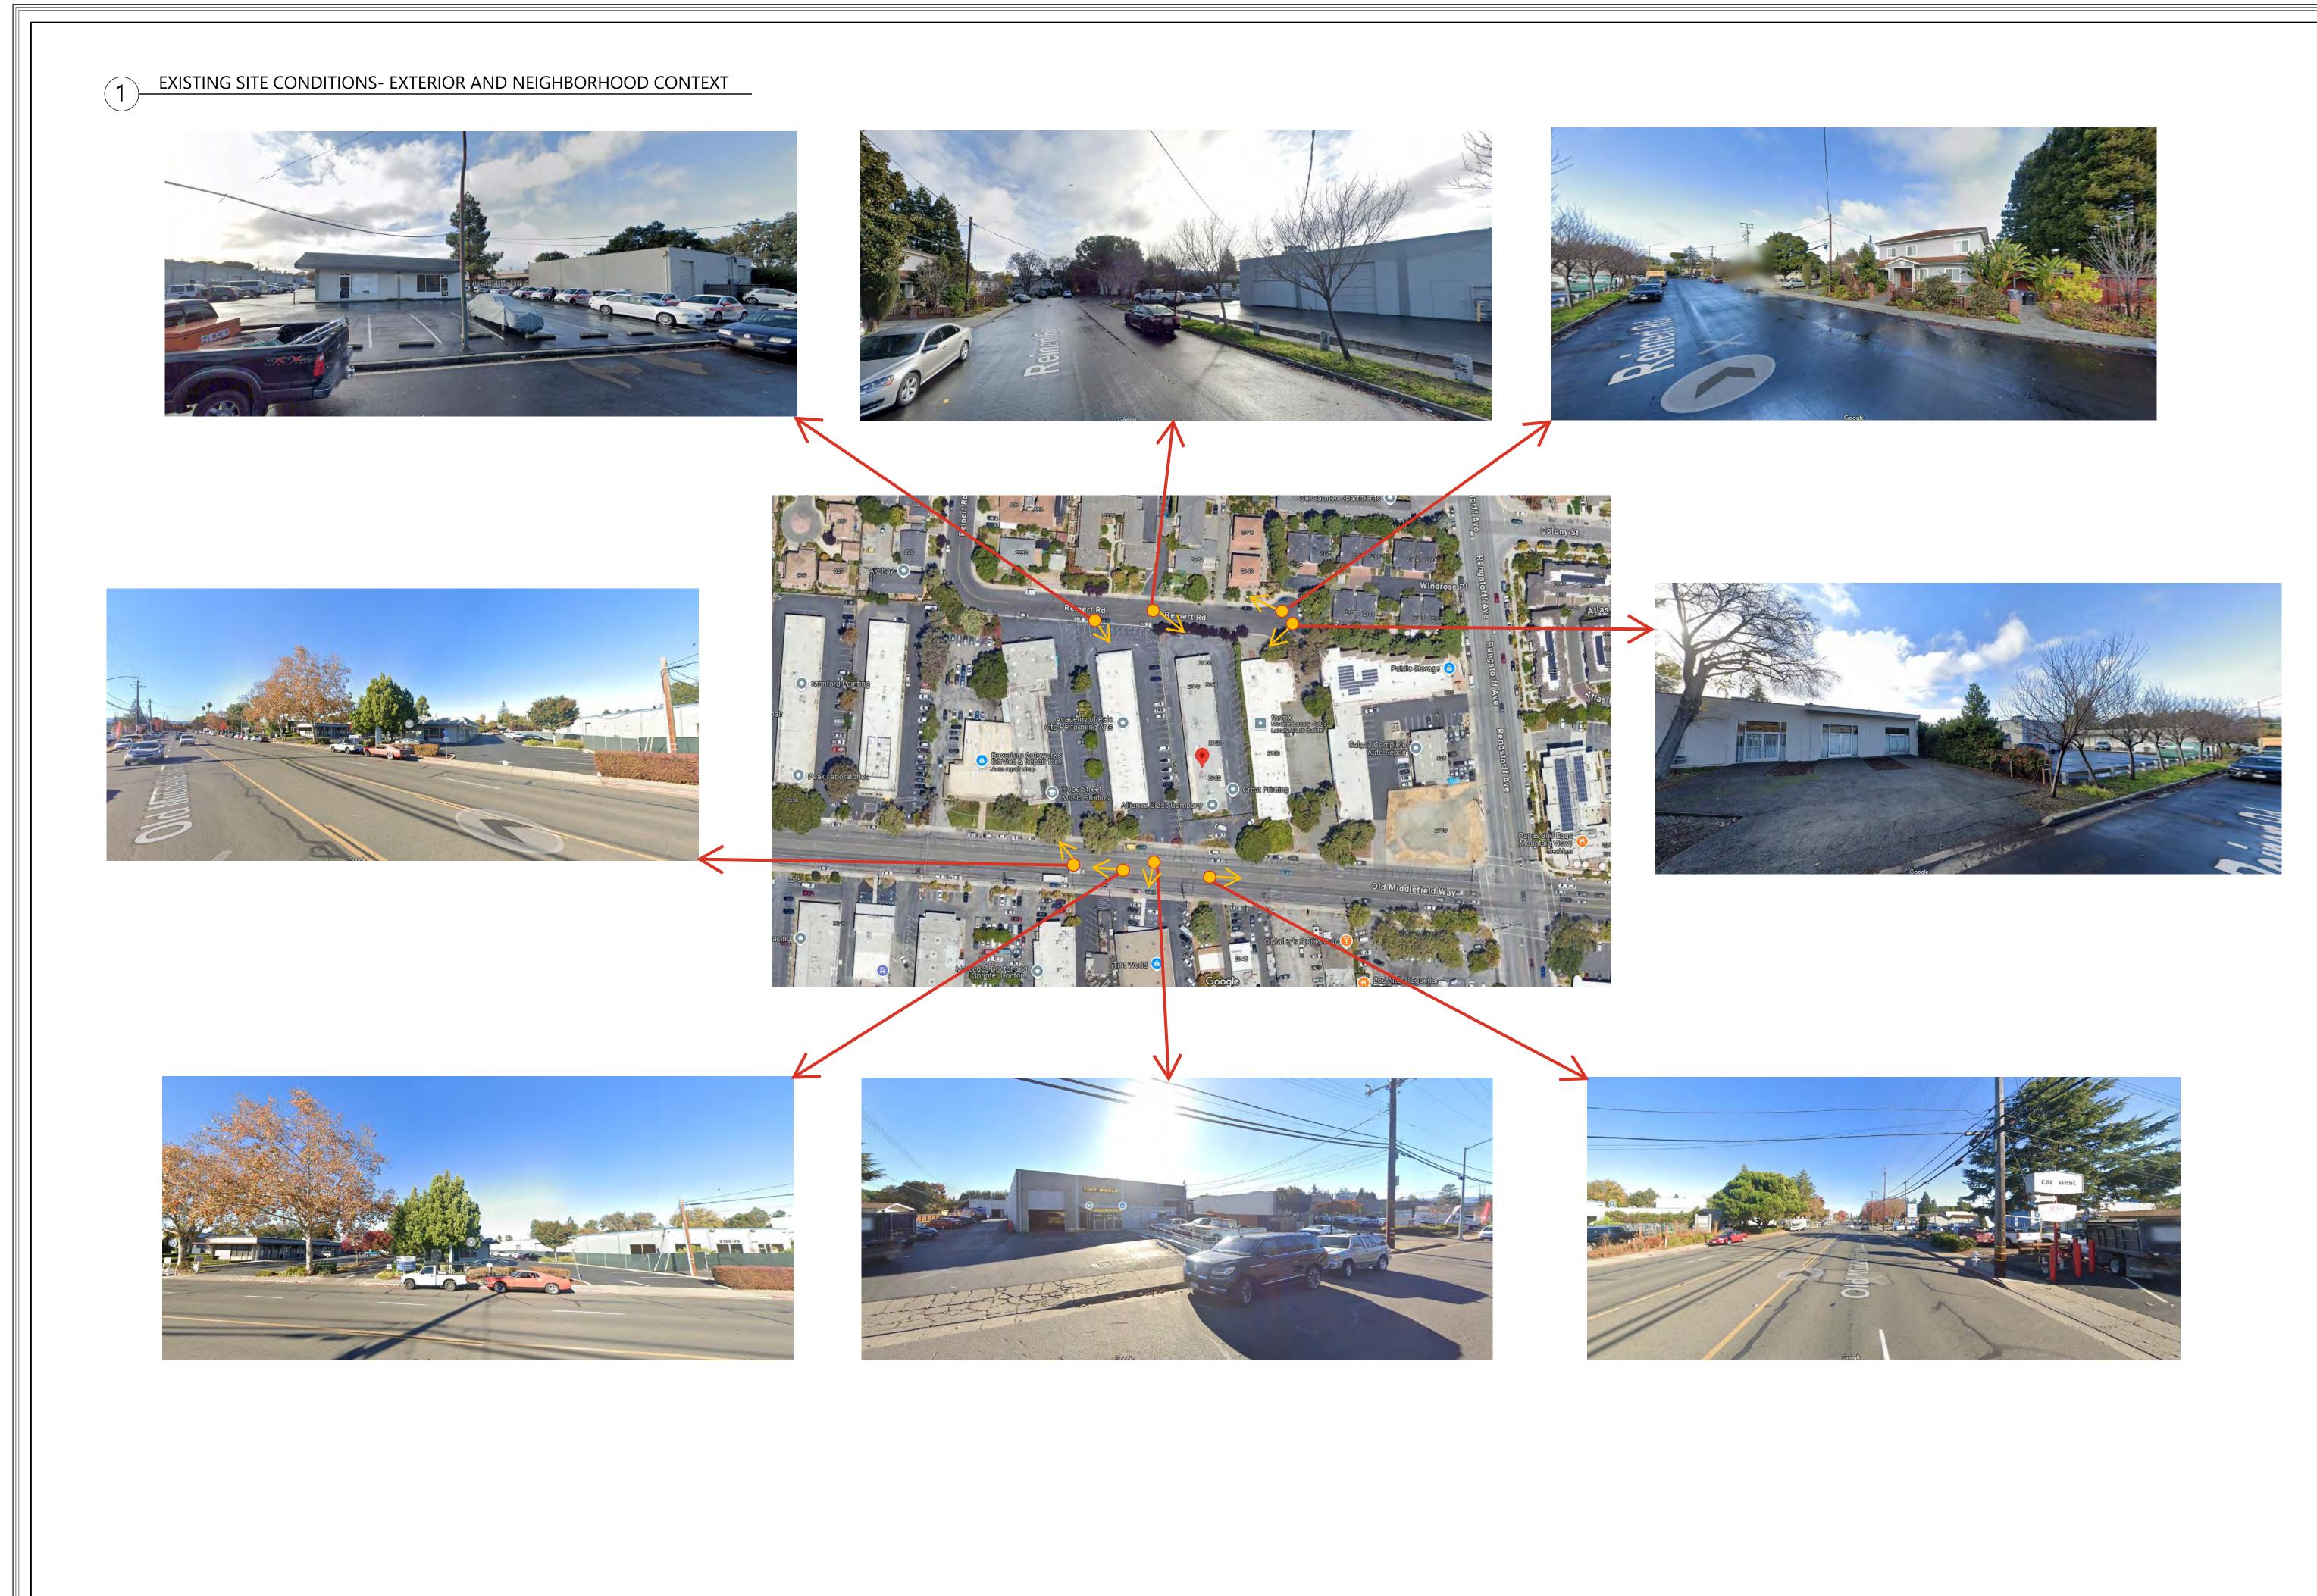

DARCO DESIGN - ARCHITECTURE - CONSTRUCTION 999 W TAYLOR ST. SUITE A SAN JOSE, CA 95126 PHONE: 408-827-4591 EMAIL: INFO@DARCO-CA.COM CSLB #1079457 PROJECT: HYUNDAI - GENESIS SERVICE CENTER PROJECT ADDRESS: 2150 Old Middlefield Way, Mountain View,CA 94043 CLIENT: Cardinale Way SERVICE Way, 4043 **, , UNDAI CENTER** 2150 Old Middlefiel **GENESIS/ PROJECT NO**. : 2024-03 REVISION: PER CITY COMMENTS 06.27.24 PER CITY COMMENTS 12.03.24


SHEET TITLE: EXISTING SITE CONDITIONS 2

DESIGNED BY: KK

DRAFTING BY: KC


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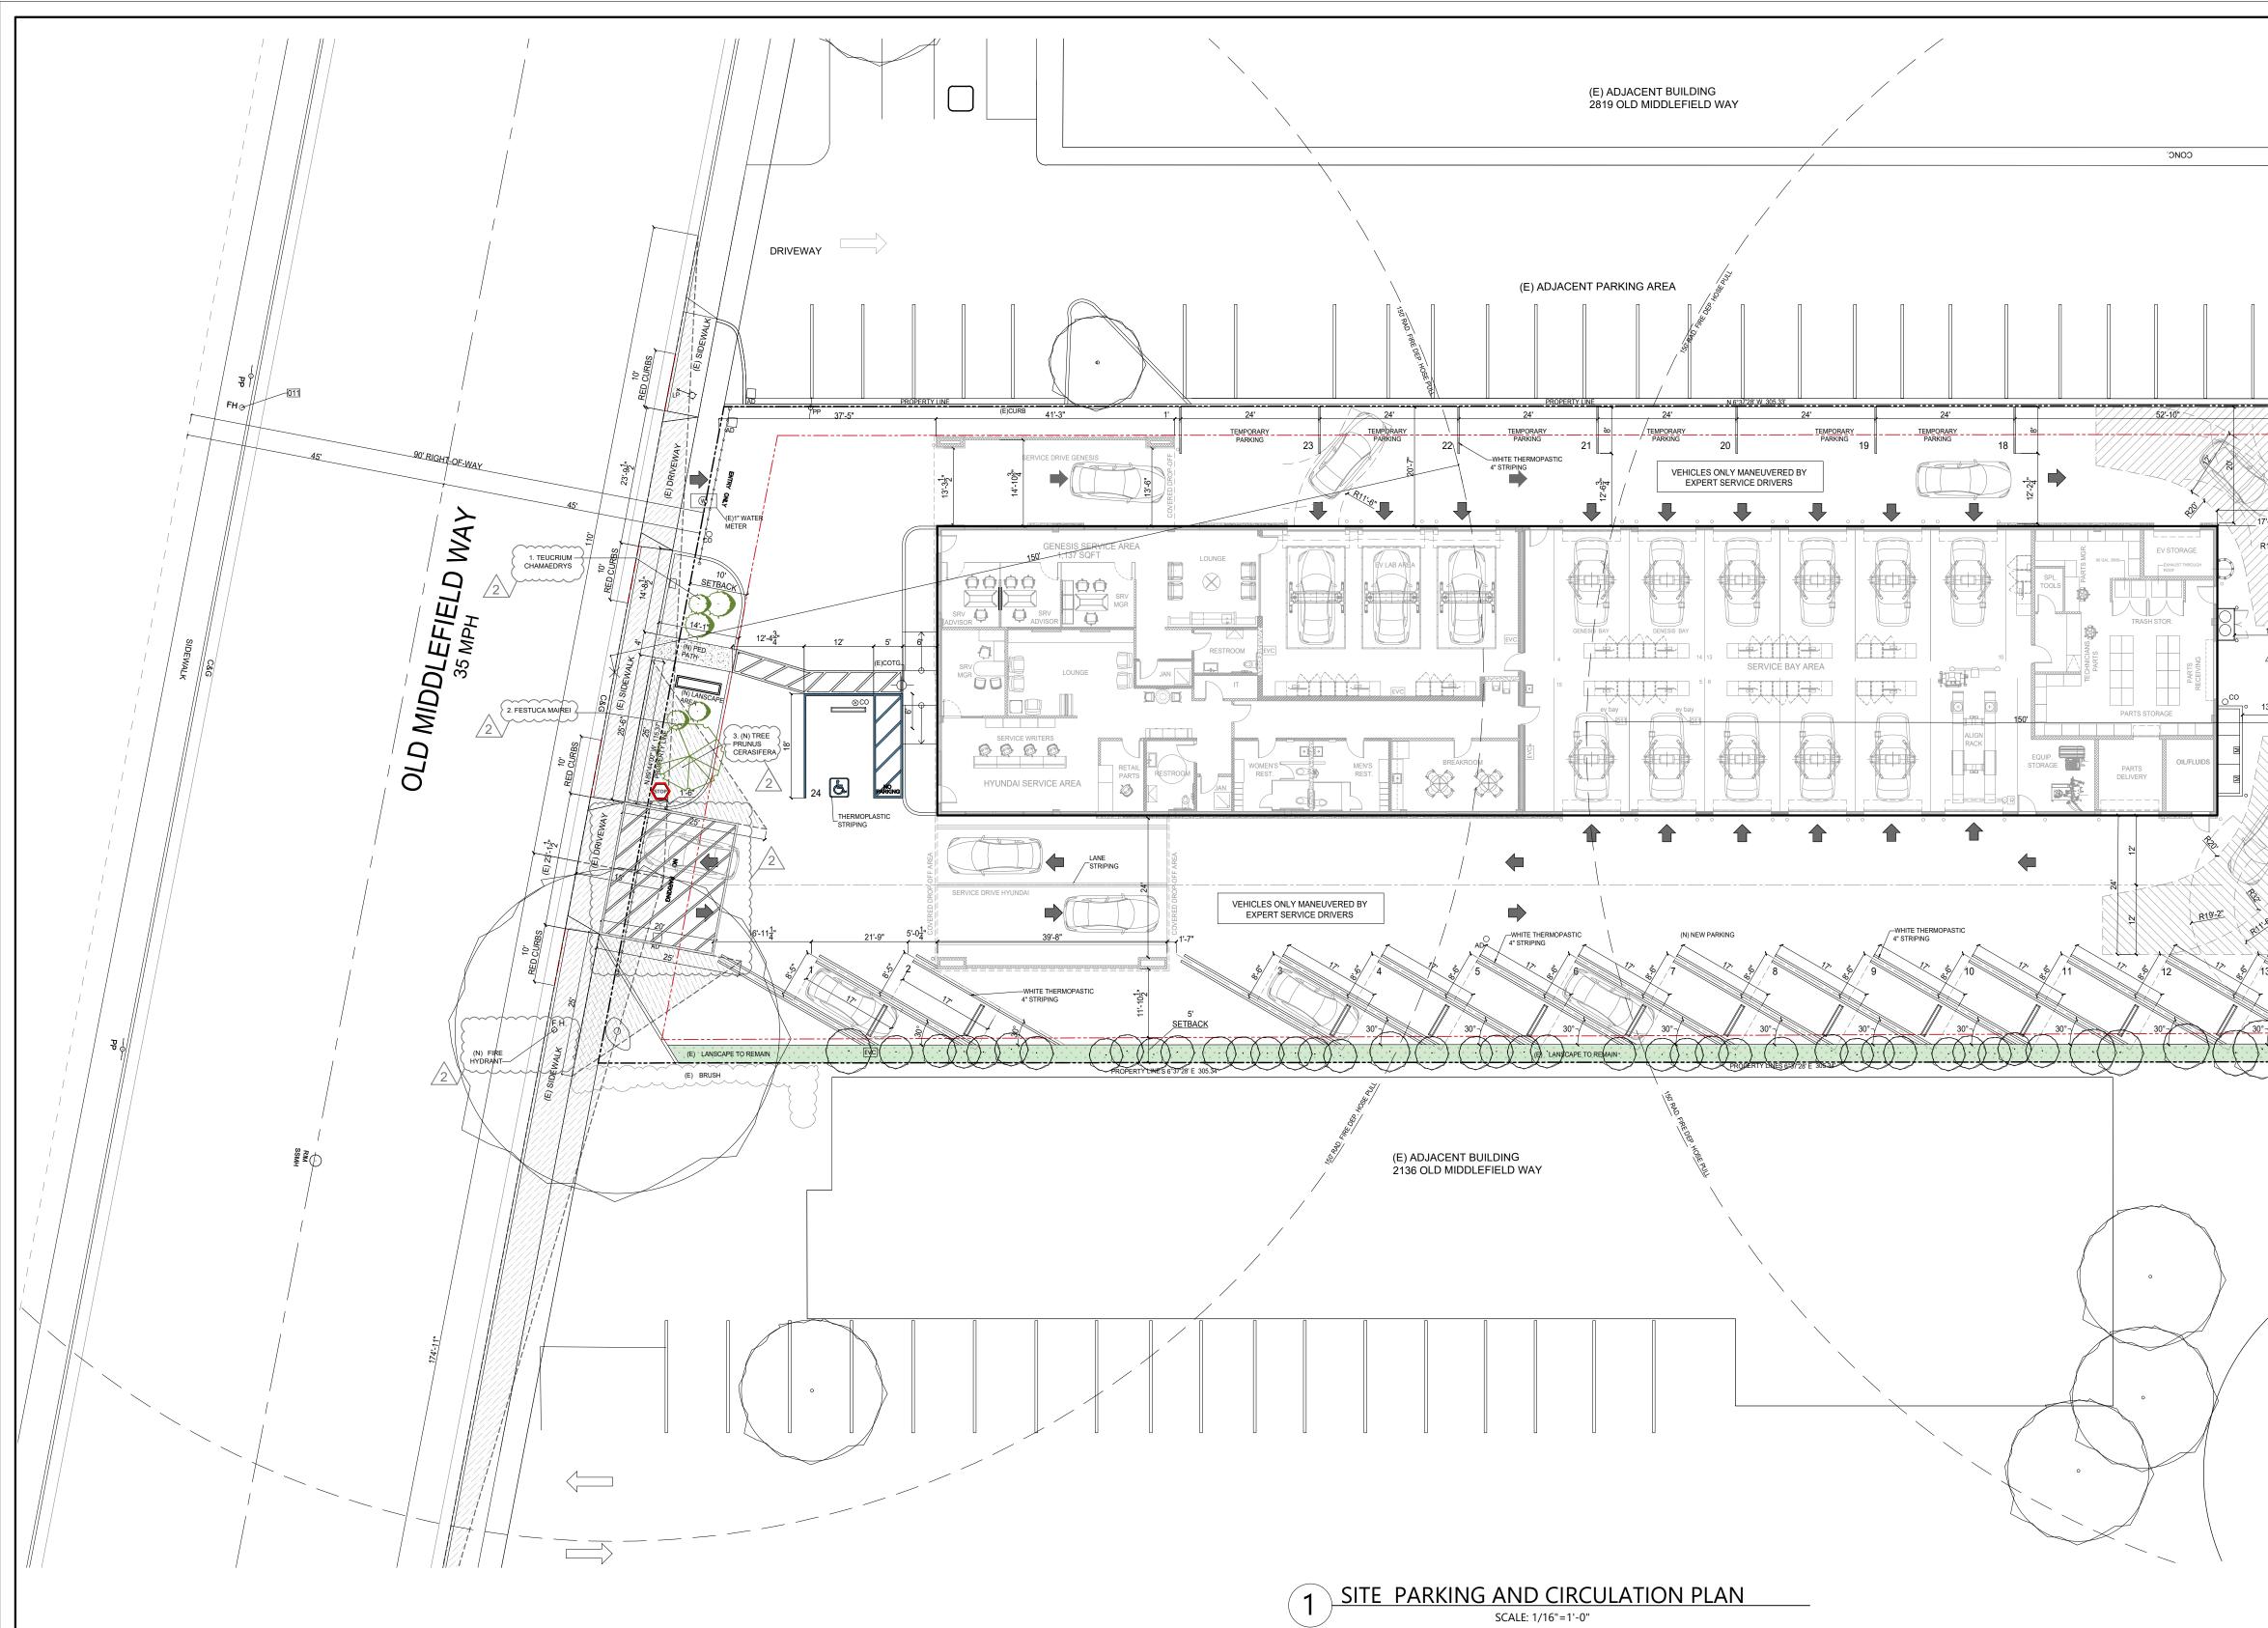


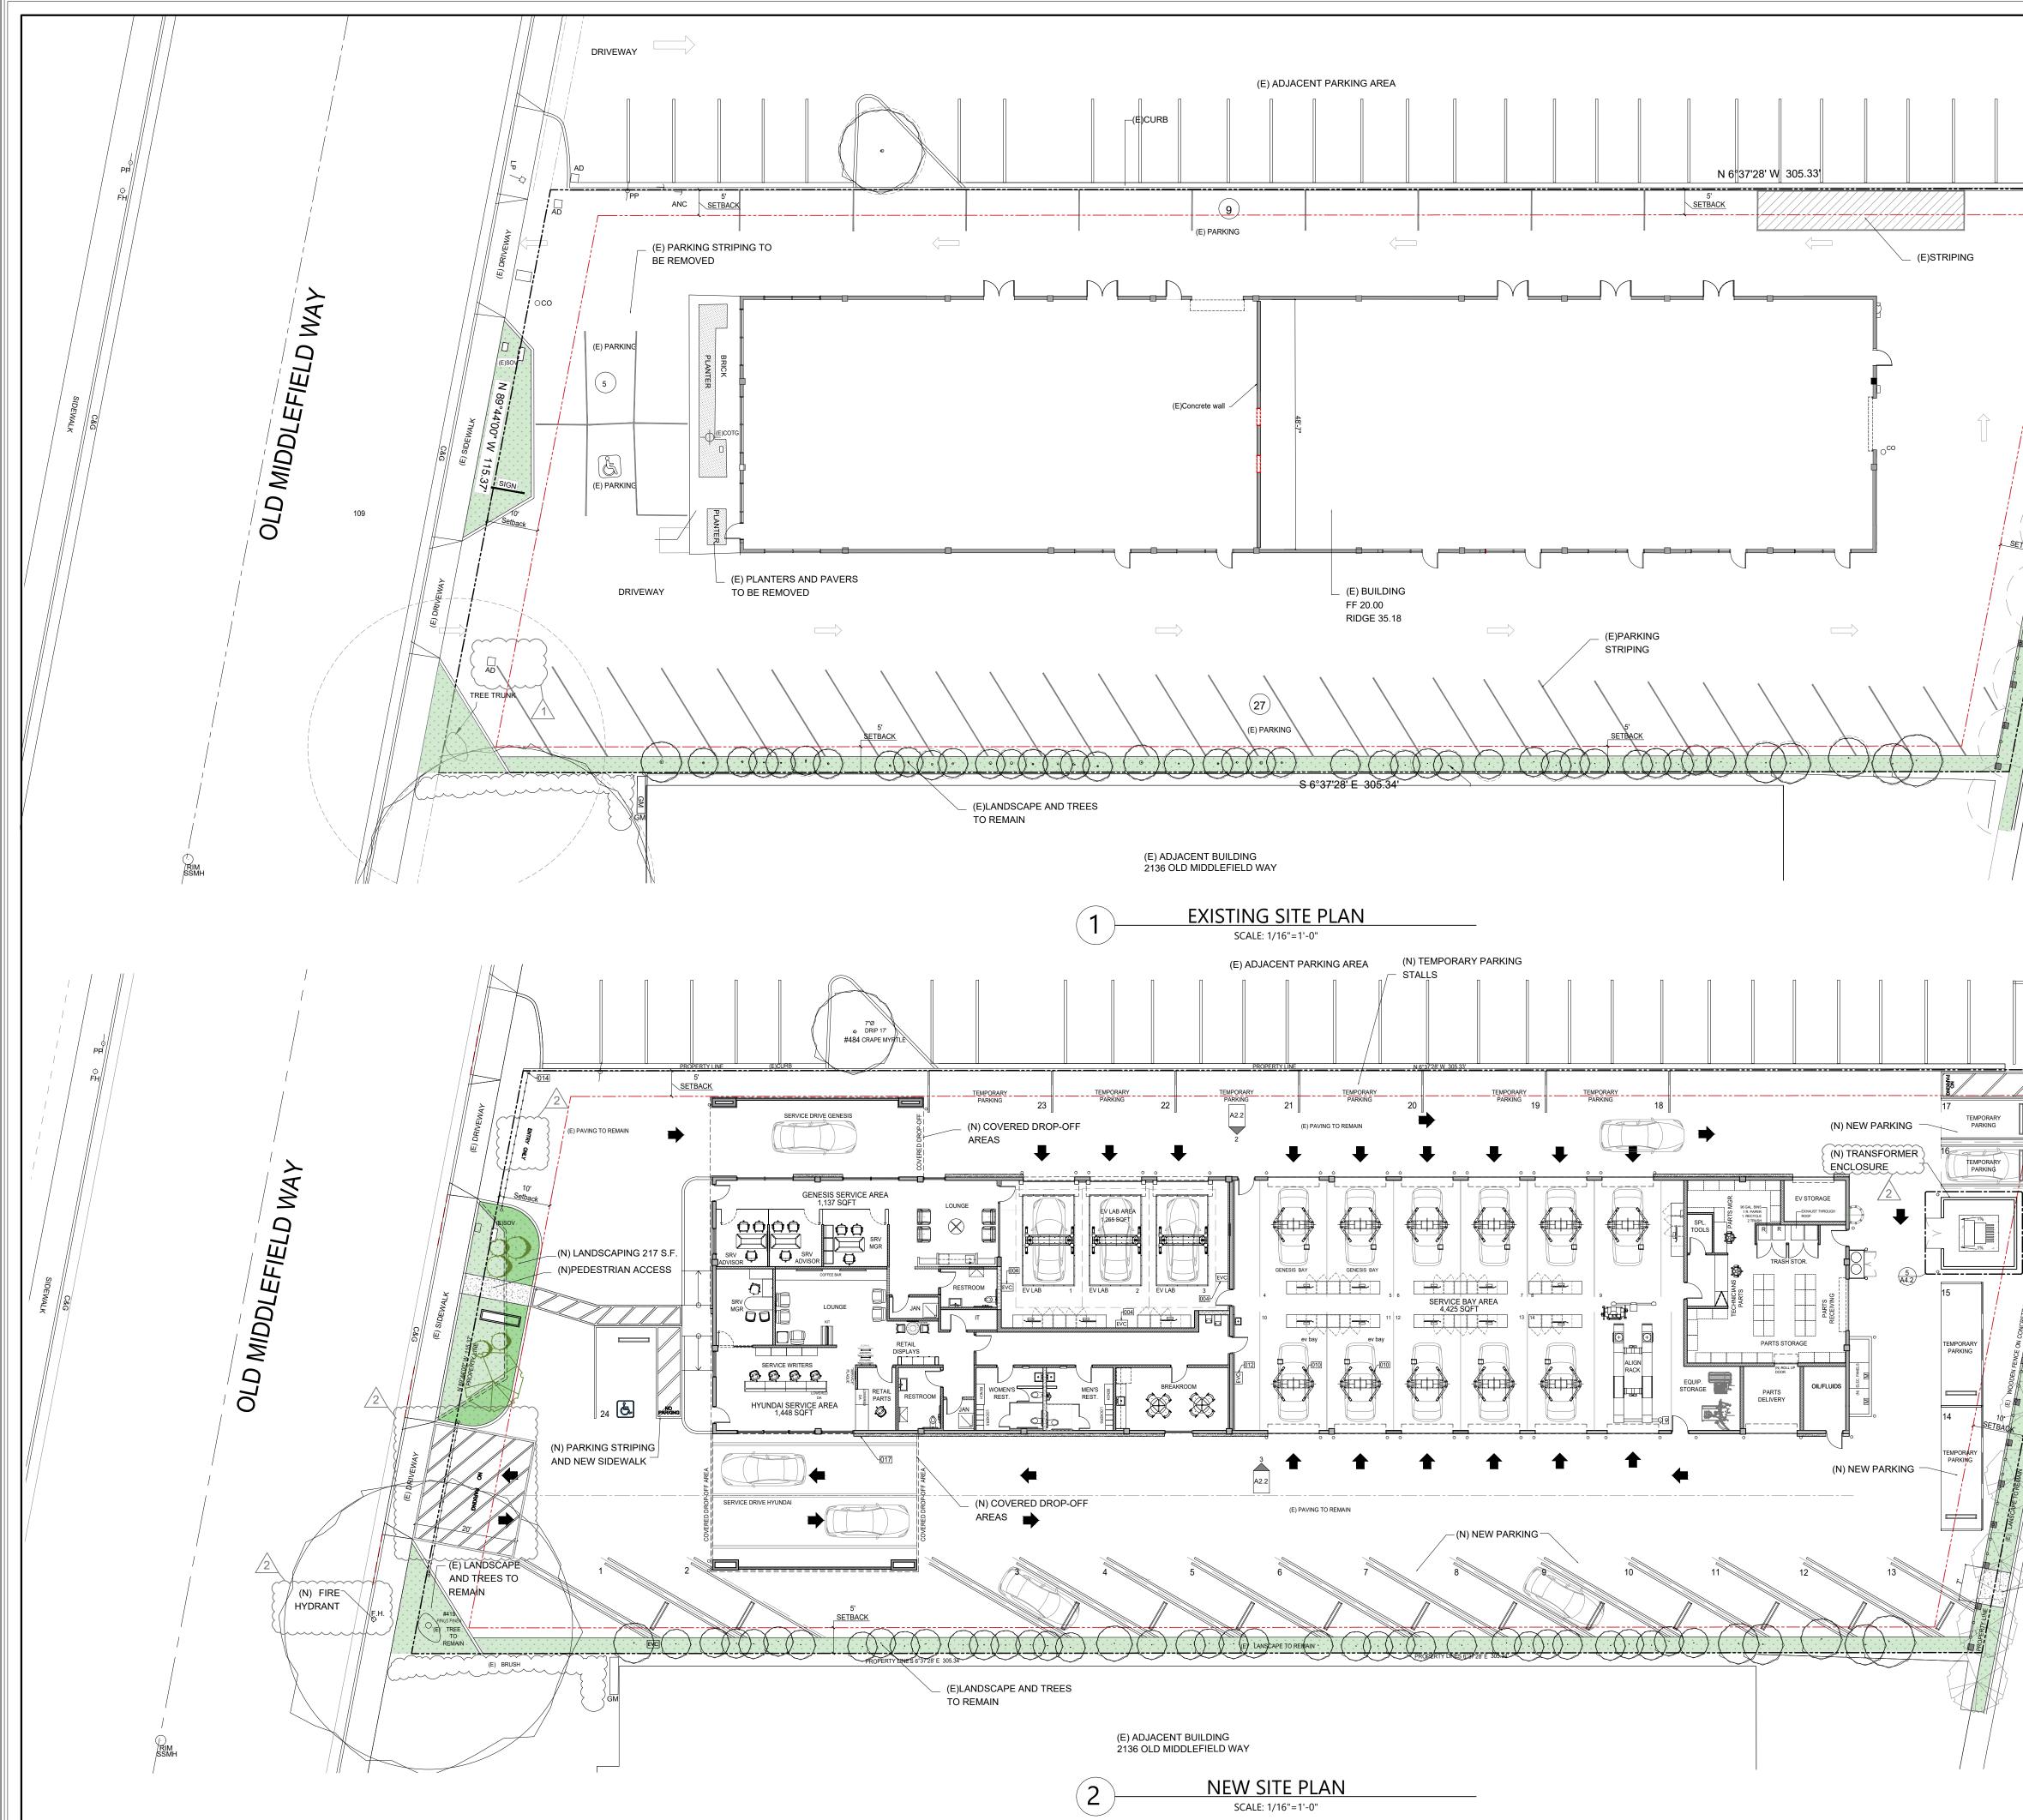

	REQUIRED PARKING CALCULATIONTOTAL BUILDING SQUARE FOOTAGE: 11,130 SFTOTAL SITE SQUARE FOOTAGE: (.81 ACRE) 34,592 SFBUILDING AREA : MAIN BUILDING: 11,130 SF11,130 / 34,592 SF = 32.2 %REQUIRED AND PROPOSED PARKING: REPAIR GARAGE : 5 + 11,130 SF / 200 =61 STALLS REQUIREDPROPOSED PARKING: REPAIR GARAGE : 5 + 11,130 SF / 200 =61 STALLS REQUIREDPROPOSED PARKING SPACES: (PROVIDED)DIAGONAL PARKING STALLS13 ADA PARKING (VAN)1TEMPORARY PARKING FOR SERVICE PERSONNEL10 SERVICE BAYS14 TOTAL PARKING PROVIDEDBICYCLE PARKING:0	DARRCO DESIGN - ARCHITECTURE - CONSTRUCTION 999 W TAYLOR ST. SUITE A SAN JOSE, CA 95126 PHONE: 408-827-4591 EMAIL: INFO@DARCO-CA.COM CSLB #1079457
(E)FENCE TO REMAIN	BUILDING AREA CALCULATION TOTAL LOT AREA: 34,592 SF (N) HYUNDAI SERVICE AREA 1,416 SF (N) GENESIS SERVICE AREA 1,138 SF (N) EMPLOYEE AREA 1,185 SF (N) EV LAB 1,330 SF (N) SERVICE BAYS 4,580 SF (N) PARTS AND STORAGE 1,318 SF (N) TRASH STORAGE 47 SF (N) EV STORAGE 116 SF TOTAL BUILDING AREA 11,130 SF LANDSCAPING AREA 1,120 SF EXISTING LANDSCAPING AREA: 1,120 SF PROPOSED LANDSCAPE AREA: 1,120 SF (N) FRONT LANDSCAPE AREA: 1,120 SF (E) FRONT LANDSCAPING AREA: 1,120 SF (DTAL (E) : 1,444 SF 1000000000000000000000000000000000000	HYUNDAI - GENESIS SERVICE CENTER PROJECT ADDRESS: 2150 Old Middlefield Way, Mountain View,CA 94043 CLIENT: Cardinale Way
(E)LANDSCAPE AND TREES TO REMAIN		GENESIS/HYUNDAI SERVICE CENTER 2150 Old Middlefield Way, Mountain View, CA 94043
(N) PAVING FOR TRASH		PROJECT NO. : 2024-03 REVISION: PER CITY COMMENTS 06.27.24 PER CITY COMMENTS 12.03.24 SHEET TITLE: EXISTING AND NEW SITE PLAN DESIGNED BY: KK DRAFTING BY: KC
	0 5' 10' 20' 50' тн SCALE 1/16 "= 1'-0"	A1.3


		DRIVEWAY	
1 3 8 011	RED CURBS		7'Ø © DRIP 17 #484 CRAPE МУТТЕ
FH @			5' SETBACK, 41'-0 ³ . SETBACK, SERVICE DRIVE GENESIS
		BY PGAE BY PGAE 940 CFH @ 300 FT METER 014	φ i i i i i i i i i i i i i
	(N) 4" FIRE SPRINKLER BACKFLOW PREVENTER 013	(N) 1-1/2" PREVENTER	
		PTV PTV PTV PTV PTV PTV PTV PTV	
		3. (N) TREE PRUNUS CERASIFERA 24 C	SERVICE WRITERS SERVICE WRITERS HYUNDAI SERVICE AREA 1,448 SQFT
	A CONTRACTOR		6 27-1" 0117
			Service DRIVE HYUNDAI
	(N) FIRE HYDRANT F.H. (E) TREE	(E) PAVING TO REMAIN	2 39-6" 1 A3.1 5' SETBACK
	TO REMAIN	(E) BRUSH	(E) TREES TO REMAIN #416-473 SEQUOIA SEMPERVIENS
Rim SSMH			
REQUIRED PARKING CALCULATION TOTAL BUILDING SQUARE FOOTAGE: 11,130 SF TOTAL SITE SQUARE FOOTAGE: (.81 ACRE) 34,592 SF	(N) HYUNDAI SERVICE AREA	,592 SF	
BUILDING AREA : MAIN BUILDING: 11,130 SF 11,130 / 34,592 SF = 32.2 % REQUIRED AND PROPOSED PARKING:	N) EMPLOYEE AREA (N) EV LAB (N) SERVICE BAYS	I,138 SF { I,185 SF } I,330 SF } I,580 SF } I,318 SF }	
REPAIR GARAGE : 5 + 11,130 SF / 200 = 61 STALLS REQUIRED PROPOSED PARKING SPACES: (PROVIDED) DIAGONAL PARKING STALLS 13 ADA PARKING (VAN) 1	TOTAL BUILDING AREA 1 LANDSCAPING AREA CALCULATION	47 SF 116 SF J,130 SF	
ADA PARKING (VAN) 1 TEMPORARY PARKING FOR SERVICE PERSONNEL 10 SERVICE BAYS 14 TOTAL PARKING PROVIDED 38 BICYCLE PARKING: 0	EXISTING LANDSCAPING AREA: EXISTING FRONT PLANTER: 324 SF EAST SIDE LANDSCAPING AREA: 1,12 PROPOSED LANDSCAPE AREA:	20 SF FOTAL (E) : <u>1,444 SF</u>	
	(N) FRONT LANDSCAPE ADDITION: <u>16</u> (E) FRONT LANDSCAPING AREA: 324 (E) EAST SIDE LANDSCAPING AREA: 1		



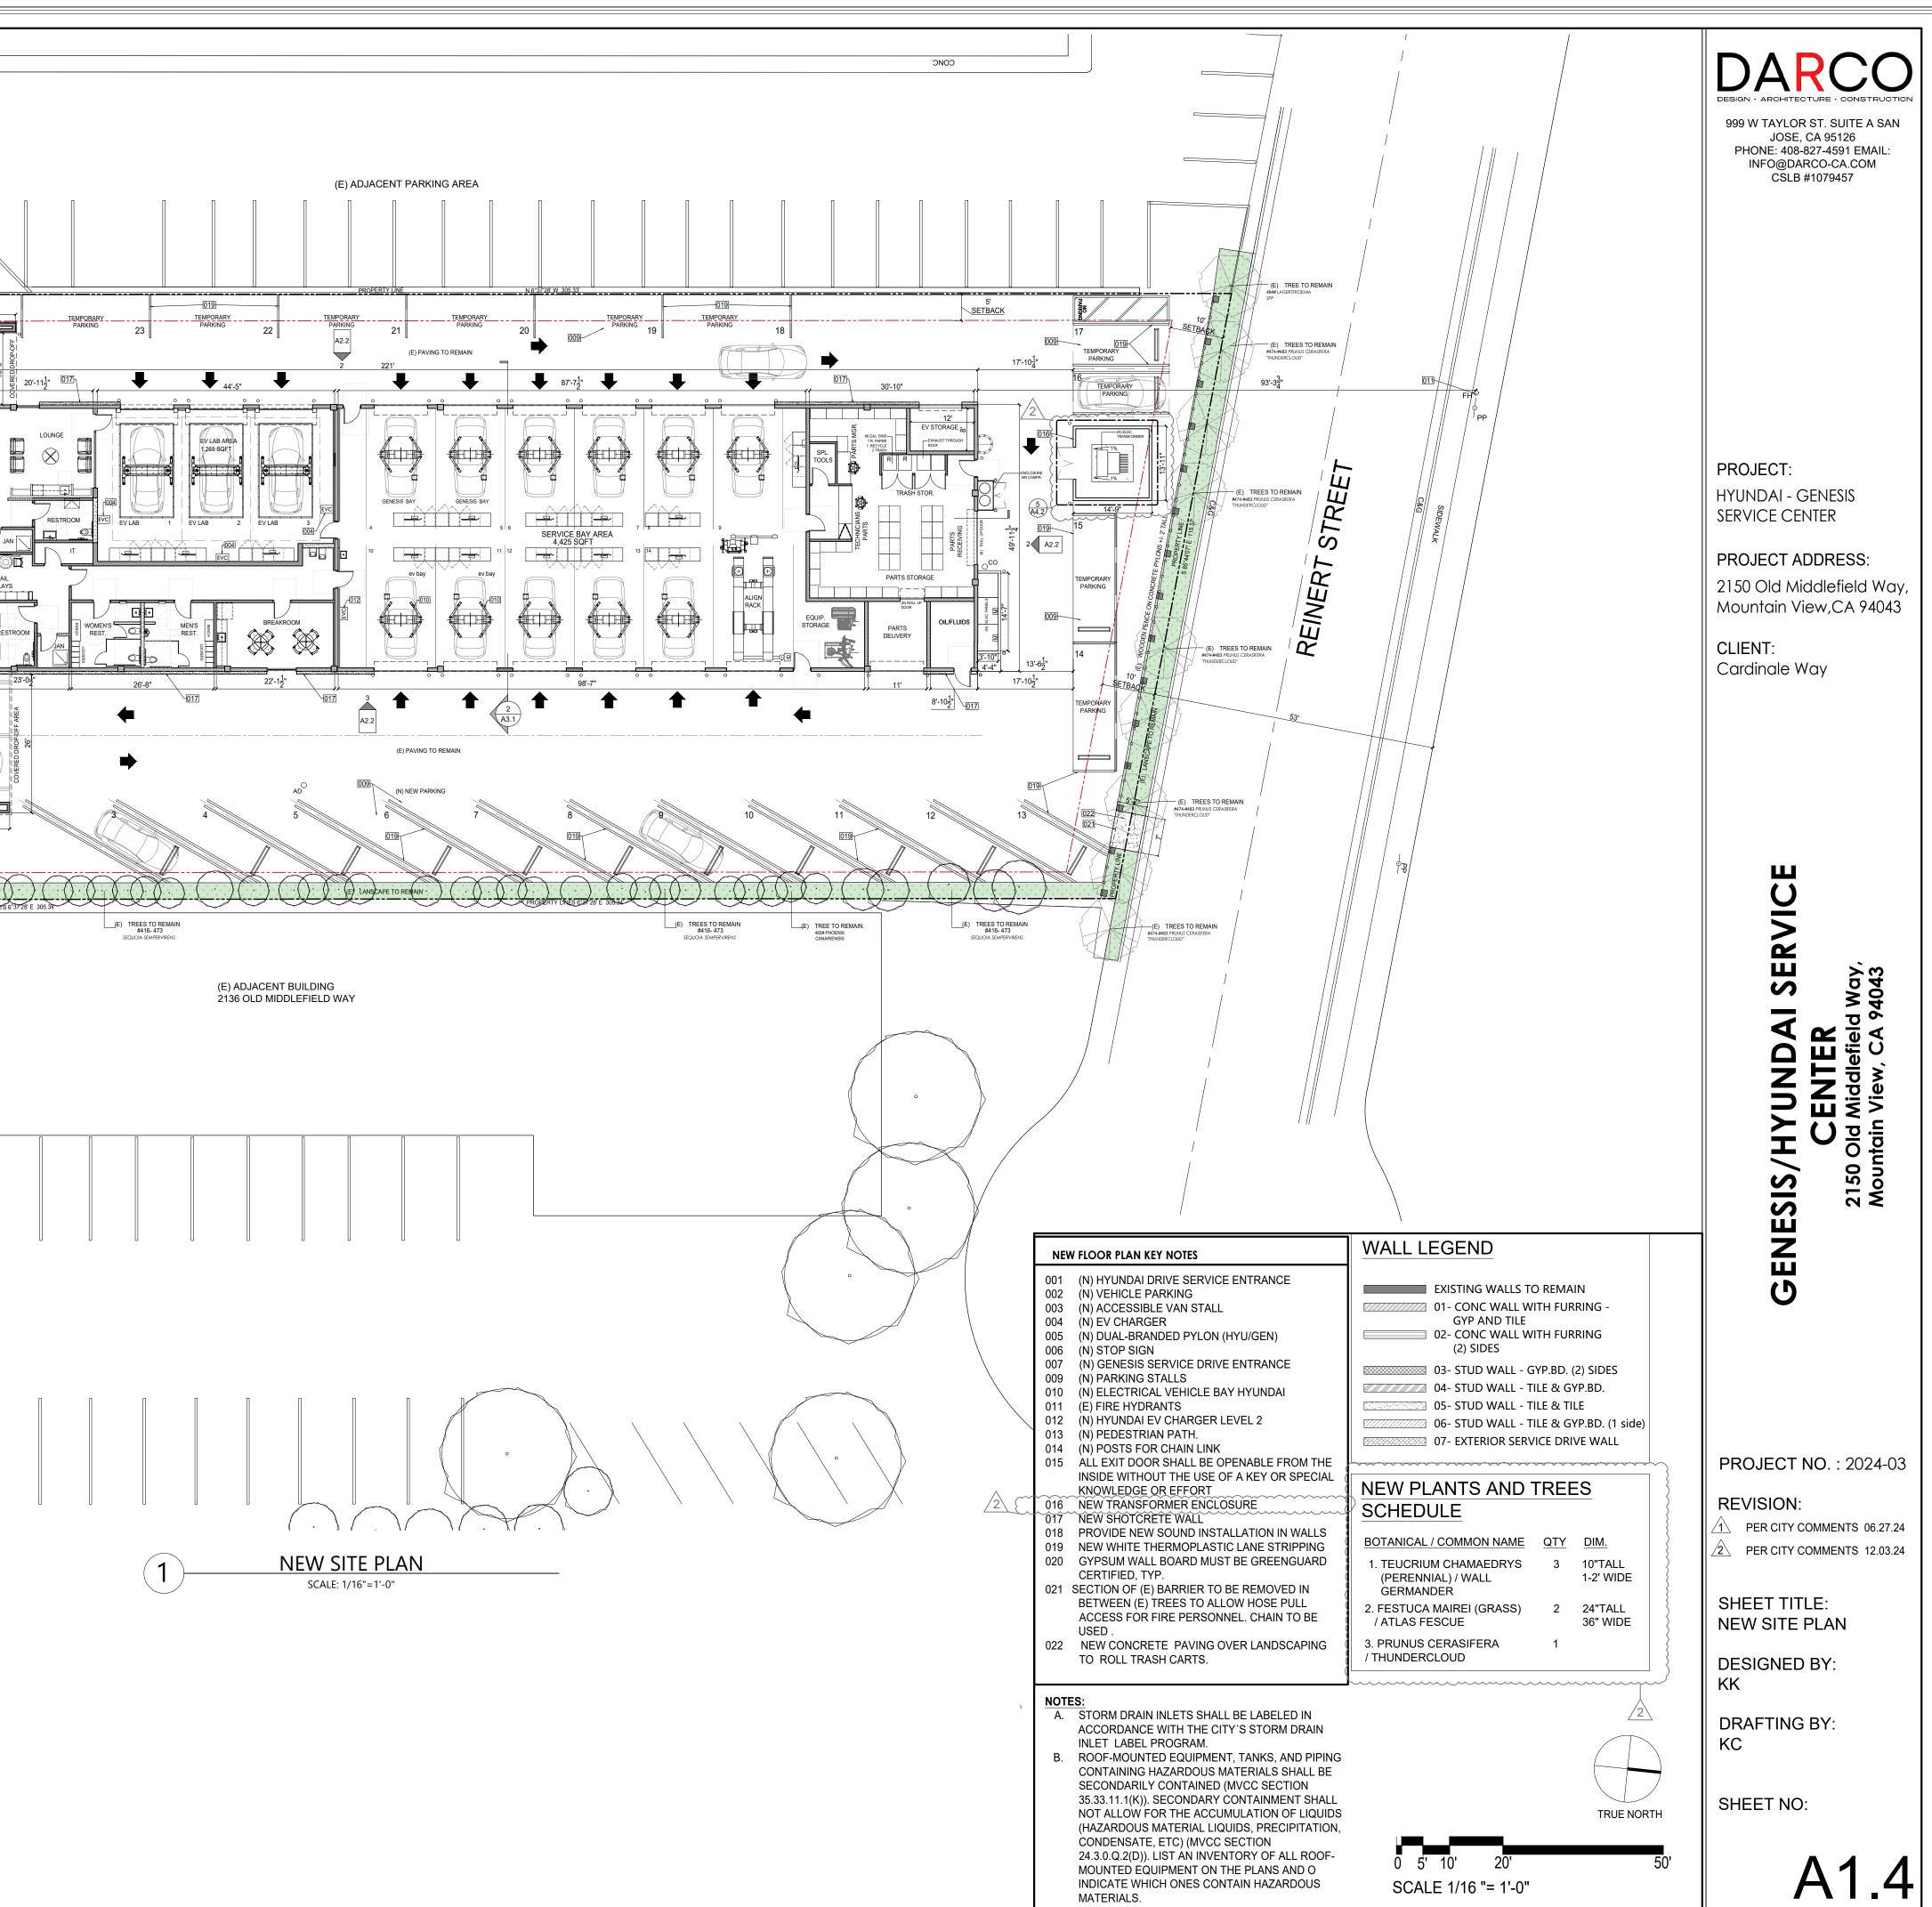

REQUIRED PARKING CALCULATION	BUILDING AREA CALCULATION	
TOTAL BUILDING SQUARE FOOTAGE: 11,130 SF TOTAL SITE SQUARE FOOTAGE: (.81 ACRE) 34,592 SF	TOTAL LOT AREA: 34,592 SF	
BUILDING AREA : MAIN BUILDING: 11,130 SF	(N) HYUNDAI SERVICE AREA1,416 SF(N) GENESIS SERVICE AREA1,138 SF(N) EMPLOYEE AREA1,185 SF	
11,130 / 34,592 SF = 32	2 % (N) EV LAB 1,330 SF (N) SERVICE BAYS 4,580 SF	
REQUIRED AND PROPOSED PARKING: REPAIR GARAGE : 5 + 11,130 SF / 200 = <u>61 STALLS REQU</u>	(N) PARTS AND STORAGE1,318 SFRED(N) TRASH STORAGE47 SF(N) EV STORAGE116 SF	WALL LEGEND
PROPOSED PARKING SPACES: (PROVIDED)	TOTAL BUILDING AREA 11,130 SF	EXISTING WALLS TO REMAIN
DIAGONAL PARKING STALLS13ADA PARKING (VAN)1TEMPORARY PARKING FOR SERVICE PERSONNEL10SERVICE BAYS14TOTAL PARKING PROVIDED38	LANDSCAPING AREA CALCULATION EXISTING LANDSCAPING AREA: EXISTING FRONT PLANTER: 324 SF EAST SIDE LANDSCAPING AREA: 1,120 SF TOTAL (E) : 1,444 SF	01- CONC WALL WITH FURRING - GYP AND TILE 02- CONC WALL WITH FURRING (2) SIDES 03- STUD WALL - GYP.BD. (2) SIDES
BICYCLE PARKING:	PROPOSED LANDSCAPE AREA: (N) FRONT LANDSCAPE ADDITION: <u>161 SF</u> (E) FRONT LANDSCAPING AREA: 324 (E) EAST SIDE LANDSCAPING AREA: 1,120 SF TOTAL (N) : <u>1,605 SF</u>	04- STUD WALL - TILE & GYP.BD. 05- STUD WALL - TILE & TILE 06- STUD WALL - TILE & GYP.BD. (1 side) 07- EXTERIOR SERVICE DRIVE WALL

	DARCOCCA.COM DESIGN - ARCHITECTURE - CONSTRUCTION 999 W TAYLOR ST. SUITE A SAN JOSE, CA 95126 PHONE: 408-827-4591 EMAIL: INFO@DARCO-CA.COM CSLB #1079457
ASST ASTRONOM	PROJECT: HYUNDAI - GENESIS SERVICE CENTER PROJECT ADDRESS: 2150 Old Middlefield Way, Mountain View,CA 94043 CLIENT: Cardinale Way
	GENESIS/HYUNDAI SERVICE CENTER 2150 Old Middlefield Way, Mountain View, CA 94043
	PROJECT NO. : 2024-03 REVISION: PER CITY COMMENTS 06.27.24 PER CITY COMMENTS 12.03.24 SHEET TITLE: SITE PARKING AND
	DESIGNED BY: KK DRAFTING BY: KC
0 5' 10' 20' 50' TRUE NORTH SCALE 1/16 "= 1'-0"	SHEET NO: A A1.5

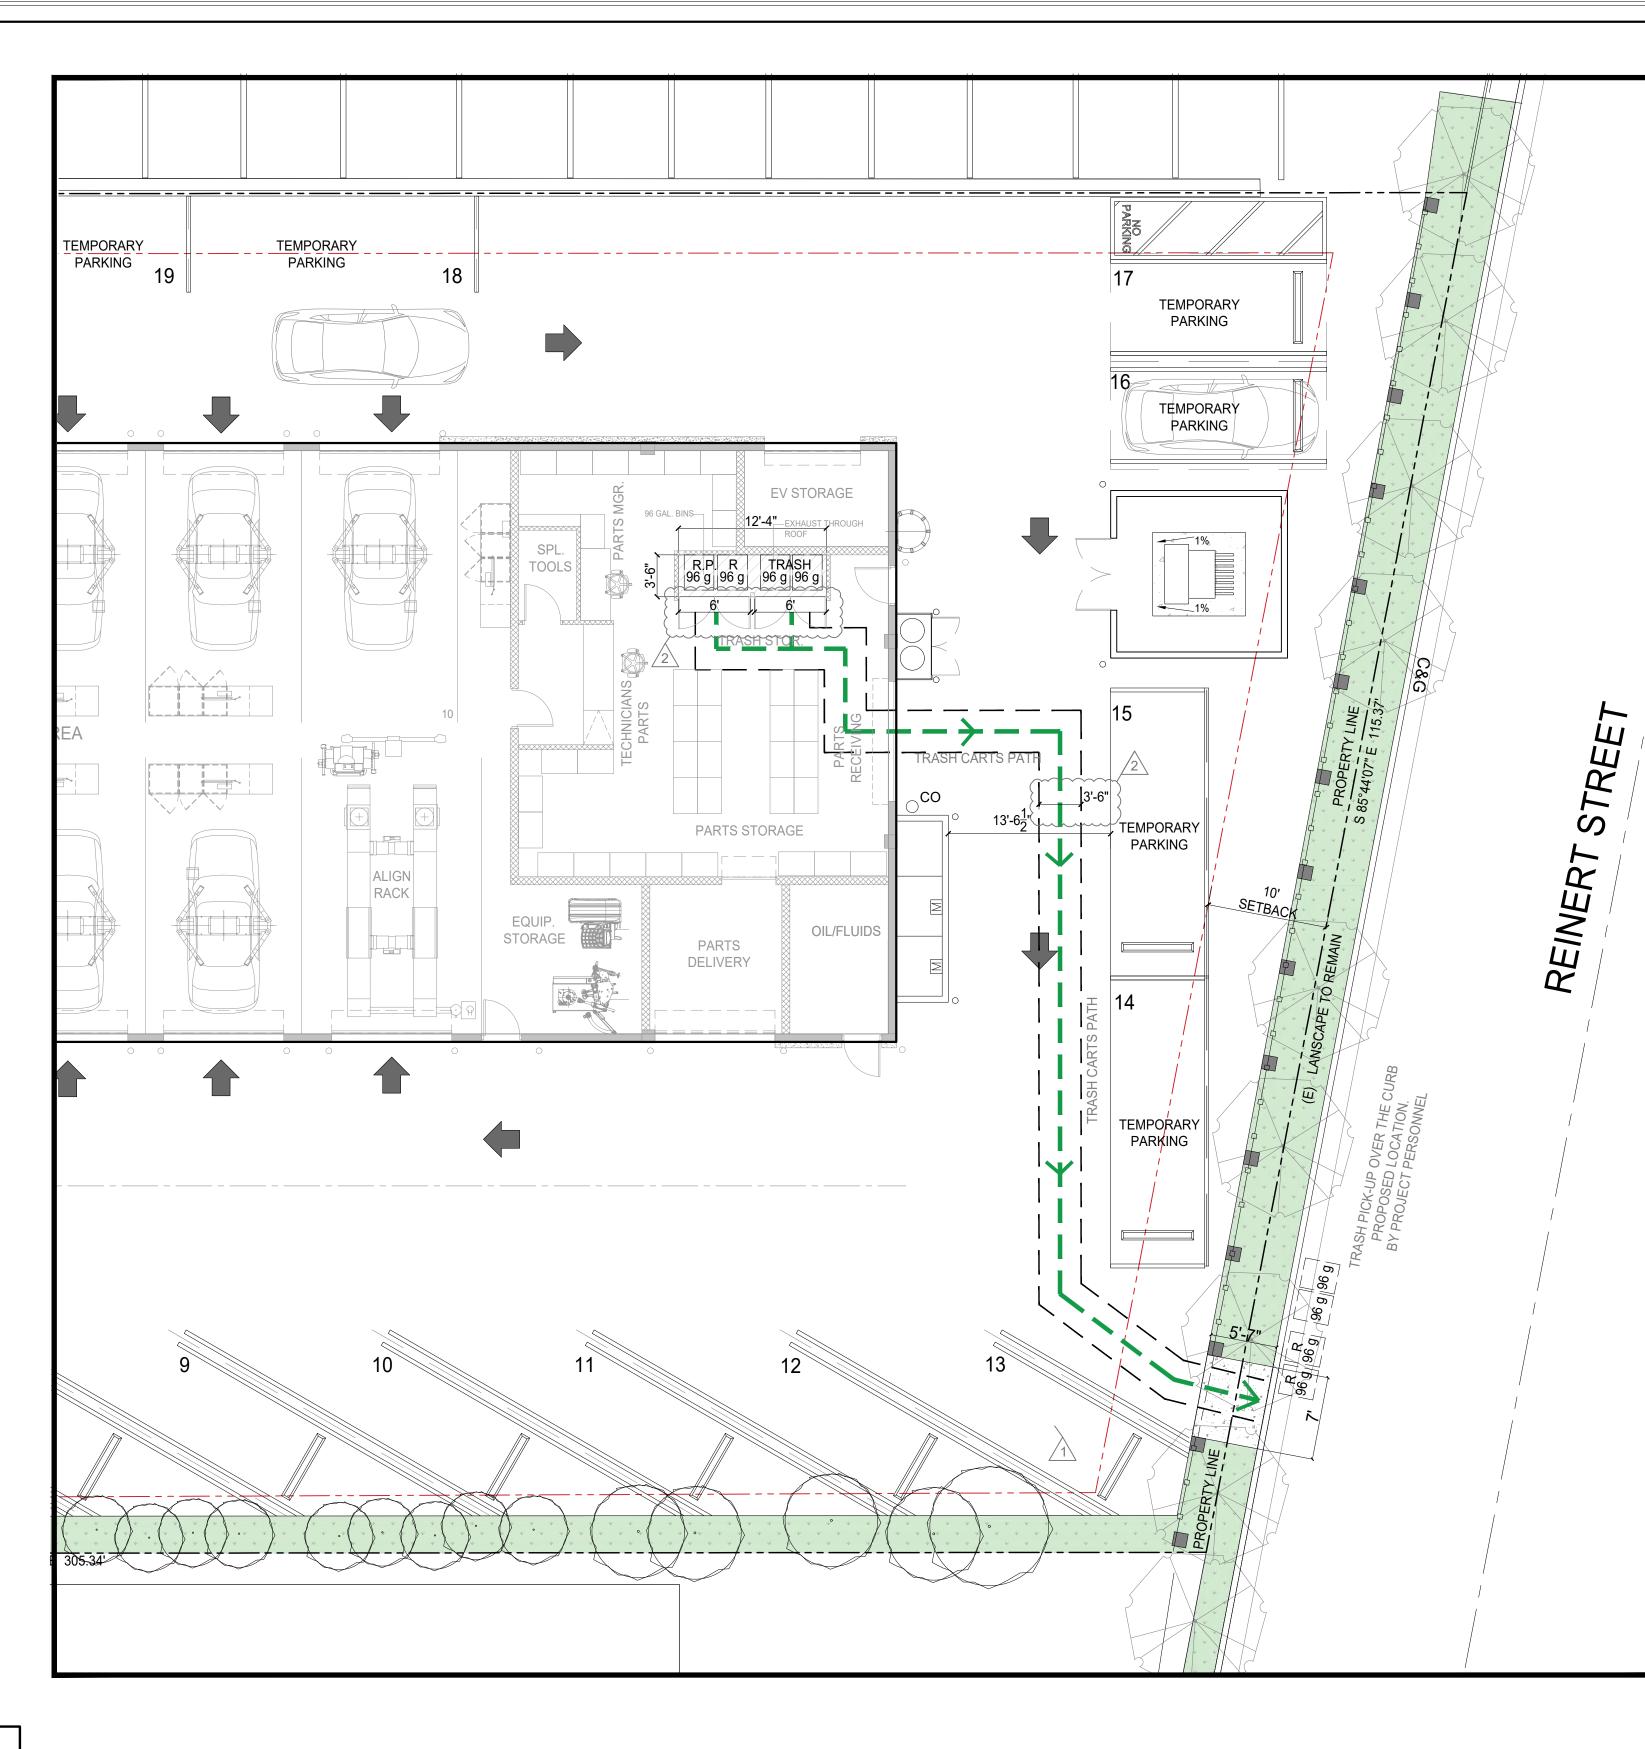

REQUIRED PARKING CALCULATION		BUILDING AREA CALCULATION	
TOTAL BUILDING SQUARE FOOTAGE: 11,130 SF TOTAL SITE SQUARE FOOTAGE: (.81 ACRE) 34,592 SF		TOTAL LOT AREA:	34,592 SF
BUILDING AREA : Main Building: 11,130 SF 11,130 / 34,592 SF	[:] = 32.2 %	 (N) HYUNDAI SERVICE AREA (N) GENESIS SERVICE AREA (N) EMPLOYEE AREA (N) EV LAB (N) SERVICE BAYS 	1,416 SF 1,138 SF 1,185 SF 1,330 SF 4,580 SF
REQUIRED AND PROPOSED PARKING: REPAIR GARAGE : 5 + 11,130 SF / 200 = <u>61 STALLS F</u> PROPOSED PARKING SPACES: (PROVIDED)	REQUIRED	 (N) PARTS AND STORAGE (N) TRASH STORAGE (N) EV STORAGE TOTAL BUILDING AREA 	1,318 SF 47 SF 116 SF 11,130 SF
DIAGONAL PARKING STALLS	13	LANDSCAPING AREA CALCUL	
ADA PARKING (VAN) TEMPORARY PARKING FOR SERVICE PERSONNEL SERVICE BAYS TOTAL PARKING PROVIDED	10 <u>14</u> 38	EXISTING LANDSCAPING AREA: EXISTING FRONT PLANTER: 3/ EAST SIDE LANDSCAPING ARE	
BICYCLE PARKING:	0	PROPOSED LANDSCAPE AREA: (N) FRONT LANDSCAPE ADDIT (E) FRONT LANDSCAPING ARE (E) EAST SIDE LANDSCAPING	EA: 324

WALL LEGEND

	EXISTING WALLS TO REMAIN
	01- CONC WALL WITH FURRING -
	GYP AND TILE
	02- CONC WALL WITH FURRING
	(2) SIDES
*****	03- STUD WALL - GYP.BD. (2) SIDES
	04- STUD WALL - TILE & GYP.BD.
	05- STUD WALL - TILE & TILE
	06- STUD WALL - TILE & GYP.BD. (1 side)
	07- EXTERIOR SERVICE DRIVE WALL

TRASH MANAGEMENT PLAN SCALE: 1/8"=1'-0"

DARRCO DESIGN - ARCHITECTURE - CONSTRUCTION 999 W TAYLOR ST. SUITE A SAN JOSE, CA 95126 PHONE: 408-827-4591 EMAIL: INFO@DARCO-CA.COM CSLB #1079457
PROJECT:HYUNDAI - GENESISSERVICE CENTERPROJECT ADDRESS:2150 Old Middlefield Way, Mountain View, CA 94043CLIENT:Cardinale Way
GENESIS/HYUNDAI SERVICE CENTER 2150 Old Middlefield Way, Mountain View, CA 94043
PROJECT NO. : 2024-03 REVISION: A PER CITY COMMENTS 06.27.24 PER CITY COMMENTS 12.03.24 SHEET TITLE: TRASH MGMT. PLAN DESIGNED BY: KK DRAFTING BY: KC SHEET NO:
SHEET TITLE: TRASH MGMT. PLAN DESIGNED BY: KK DRAFTING BY: KC





<u>3D VIEW FROM OLD MIDDLEFIELD WAY</u> FRONT VIEW








3D VIEW FROM OLD MIDDLEFIELD WAY AERIAL






4 3D VIEW FROM OLD MIDDLEFIELD WAY

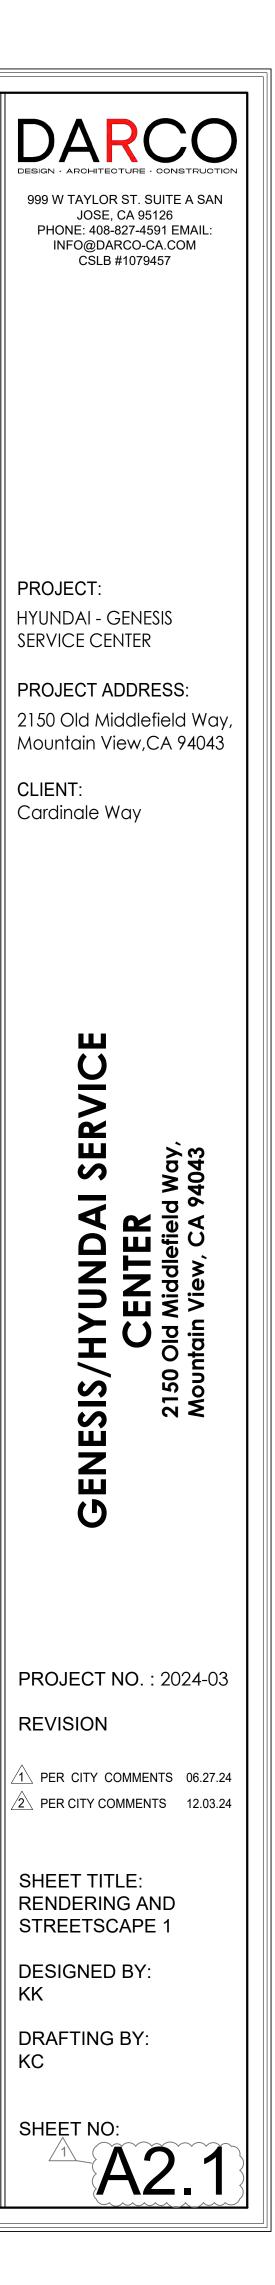



3D VIEW GENESIS WEST ELEVATION

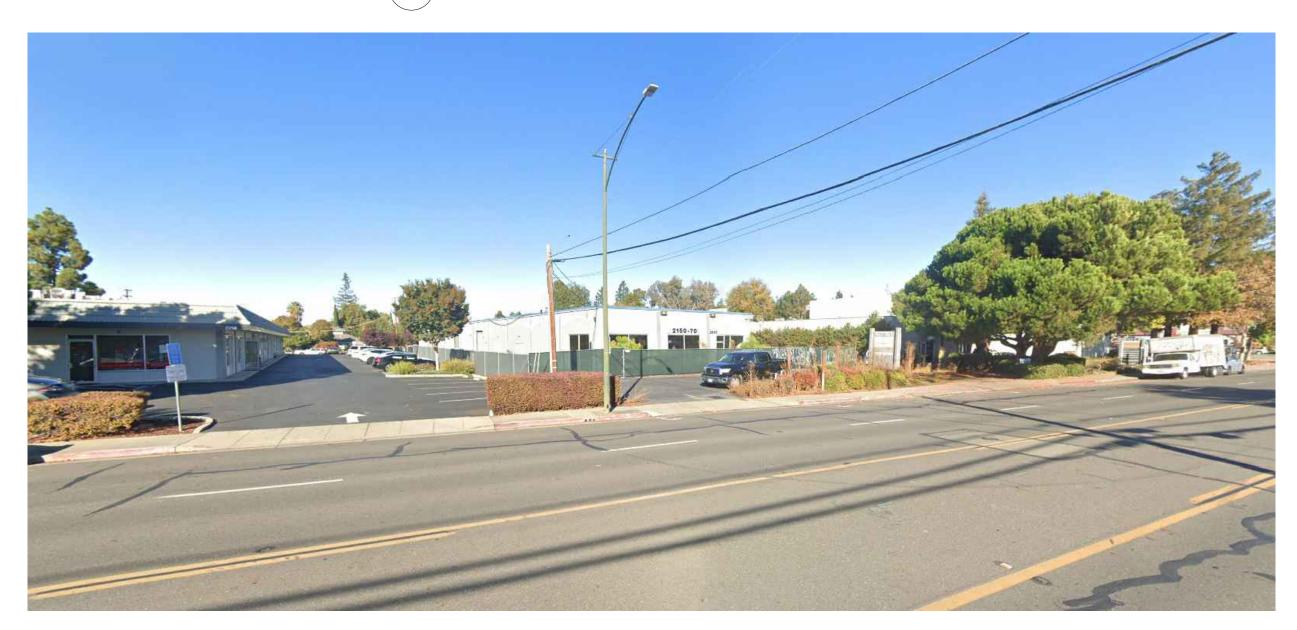




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EXISTING STREETSCAPE FROM OLD MIDDLEFIELD WAY






3D VIEW HYUNDAI EAST ELEVATION (2)



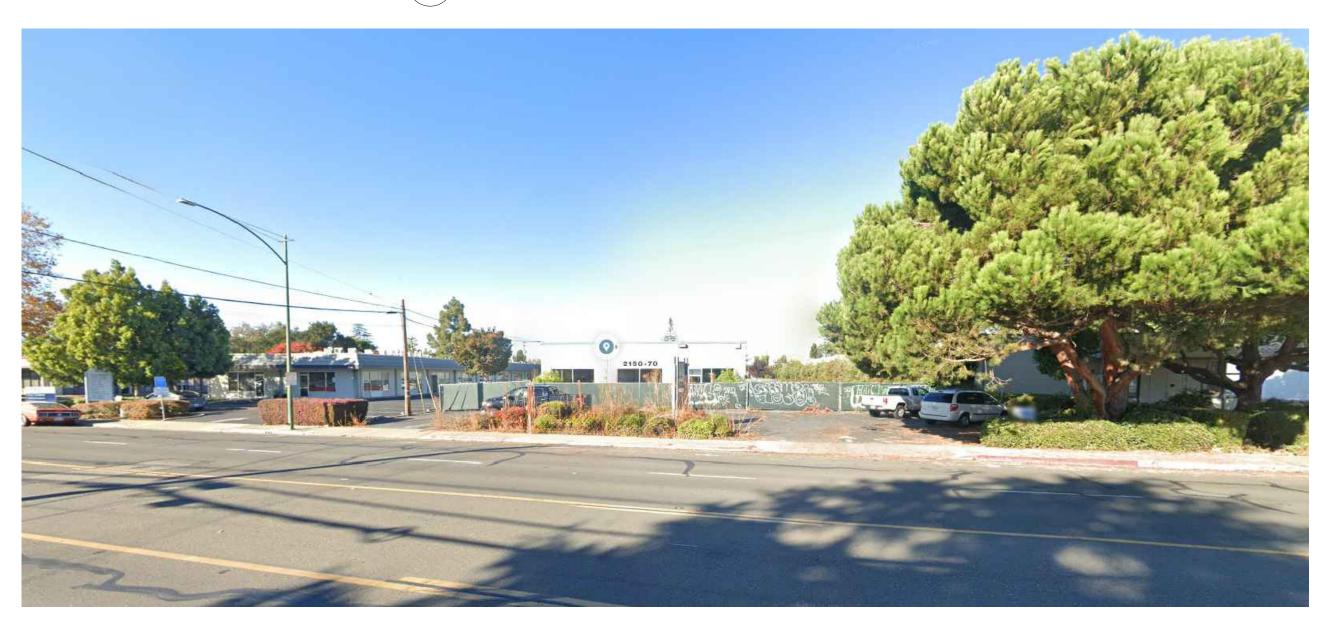


EXISTING STREETSCAPE FROM OLD MIDDLEFIELD WAY

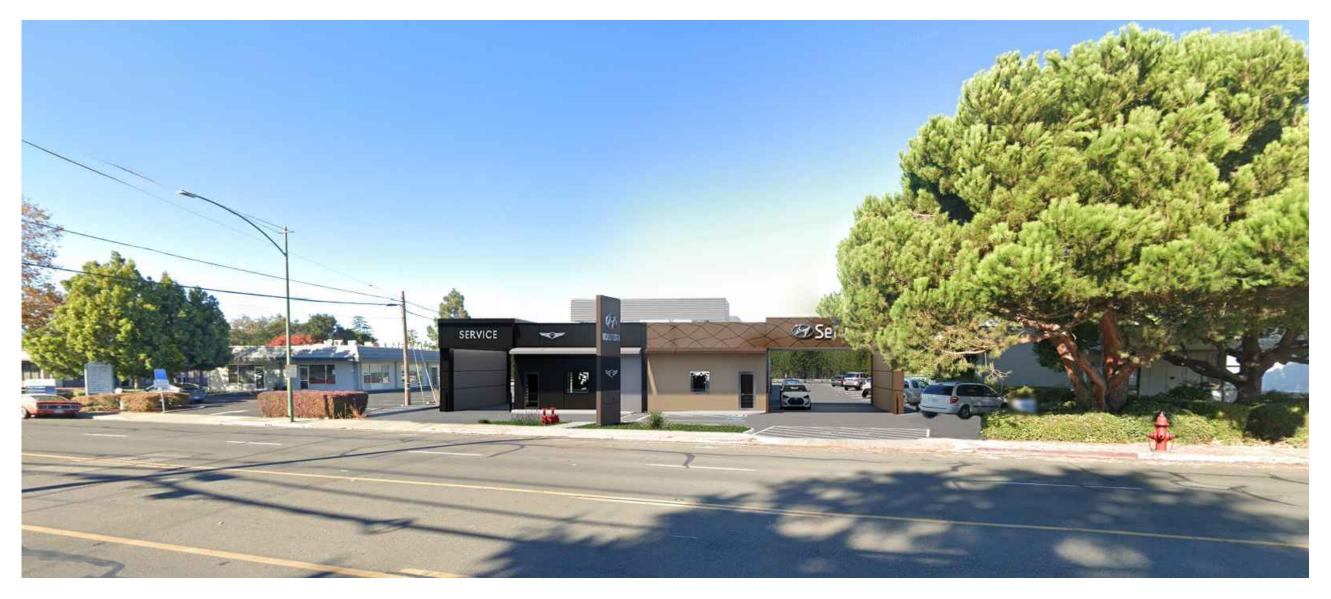





PROPOSED STREETSCAPE FROM OLD MIDDLEFIELD WAY

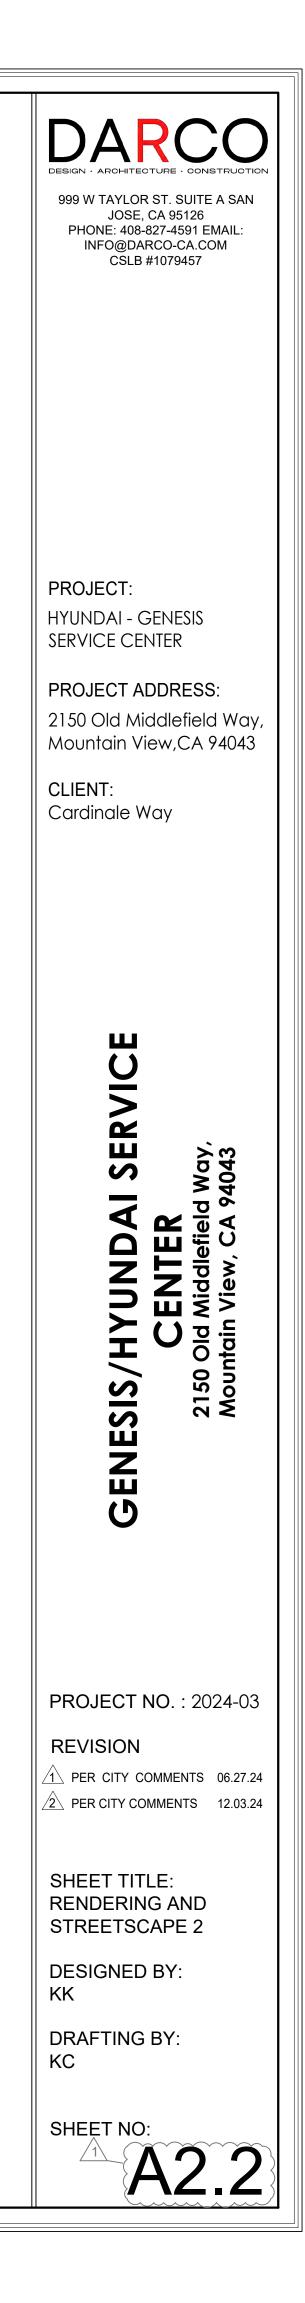


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				AD	108 111 111 DR
	O FH	/ 100			
	45'	90' RIGHT-OF-WAY		AD	20 ⁻ .41
		45	(E)1"V	VATER 3	
				(E) PARKING 119	
				(ð.)	
	SIDEWALK		N 89°44'00" W		
 			C&G C&G		
		MIM	115.37. SIGN	(E) PARKING NO PAR	
/			9'-7 ³ "	30'-4 ¹ / ₄ " [110]	
				DRIVEWAY	
		101		·	
		CONNECTED TO CITY STORMWATER LINE			¢
		116			4"Ø 4"Ø DRIP 6' DRIP 6' 4"Ø DRIP 6'
	 				$\frac{1}{2} \left(\frac{1}{2} \left(\frac{1}{2} \right) \right) \left(\frac{1}{2} \right)$
) 5"Ø) 8"Ø DRIP 6' 2X3"Ø DRIP 8' DRIP 6' (E) ADJA
	Хім SSMH				
			24"Ø DRIP 56'		
			N I		
			DRIVEWAY	θ	
	Ι				// 11 11 11 11
	KEYNOTE	S			LEGEND
100					STREET CENTERLINE PROPERTY LINE
102		IRED FOR (N)		o	WOOD FENCE
103	3 (E) FENCE			WM GM	WATER METER GAS METER
105	(E) GAS METERS TO BE REMC			EM	ELECTRIC METER
106 107	(E) ELECTRIC METERS TO BE			AD	AREA DRAIN
108				PP CO	POWER POLE SANITARY SEWER CLEANOUT
110			IOVED	SSMH	SANITARY SEWER MANHOLE
111	PROPERTY LINE			SDMH	STORM DRAINAGE MANHOLE
113	(E) BOLLARDS TO BE REMOVE			FH C&G	FIRE HYDRANT CURB & GUTTER
<u> </u>	5 REMOVE (E) LANDSCAPING(H			₩V	WATER VALVE
116		REMOVE (E) LANDSCAPE A		L	
117		RKING AISLE			
118 119	REMOVE (E) LANDSCAPING AS	S REQUIRED FOR NEW			
120		CART AREA			
121 122					
122					




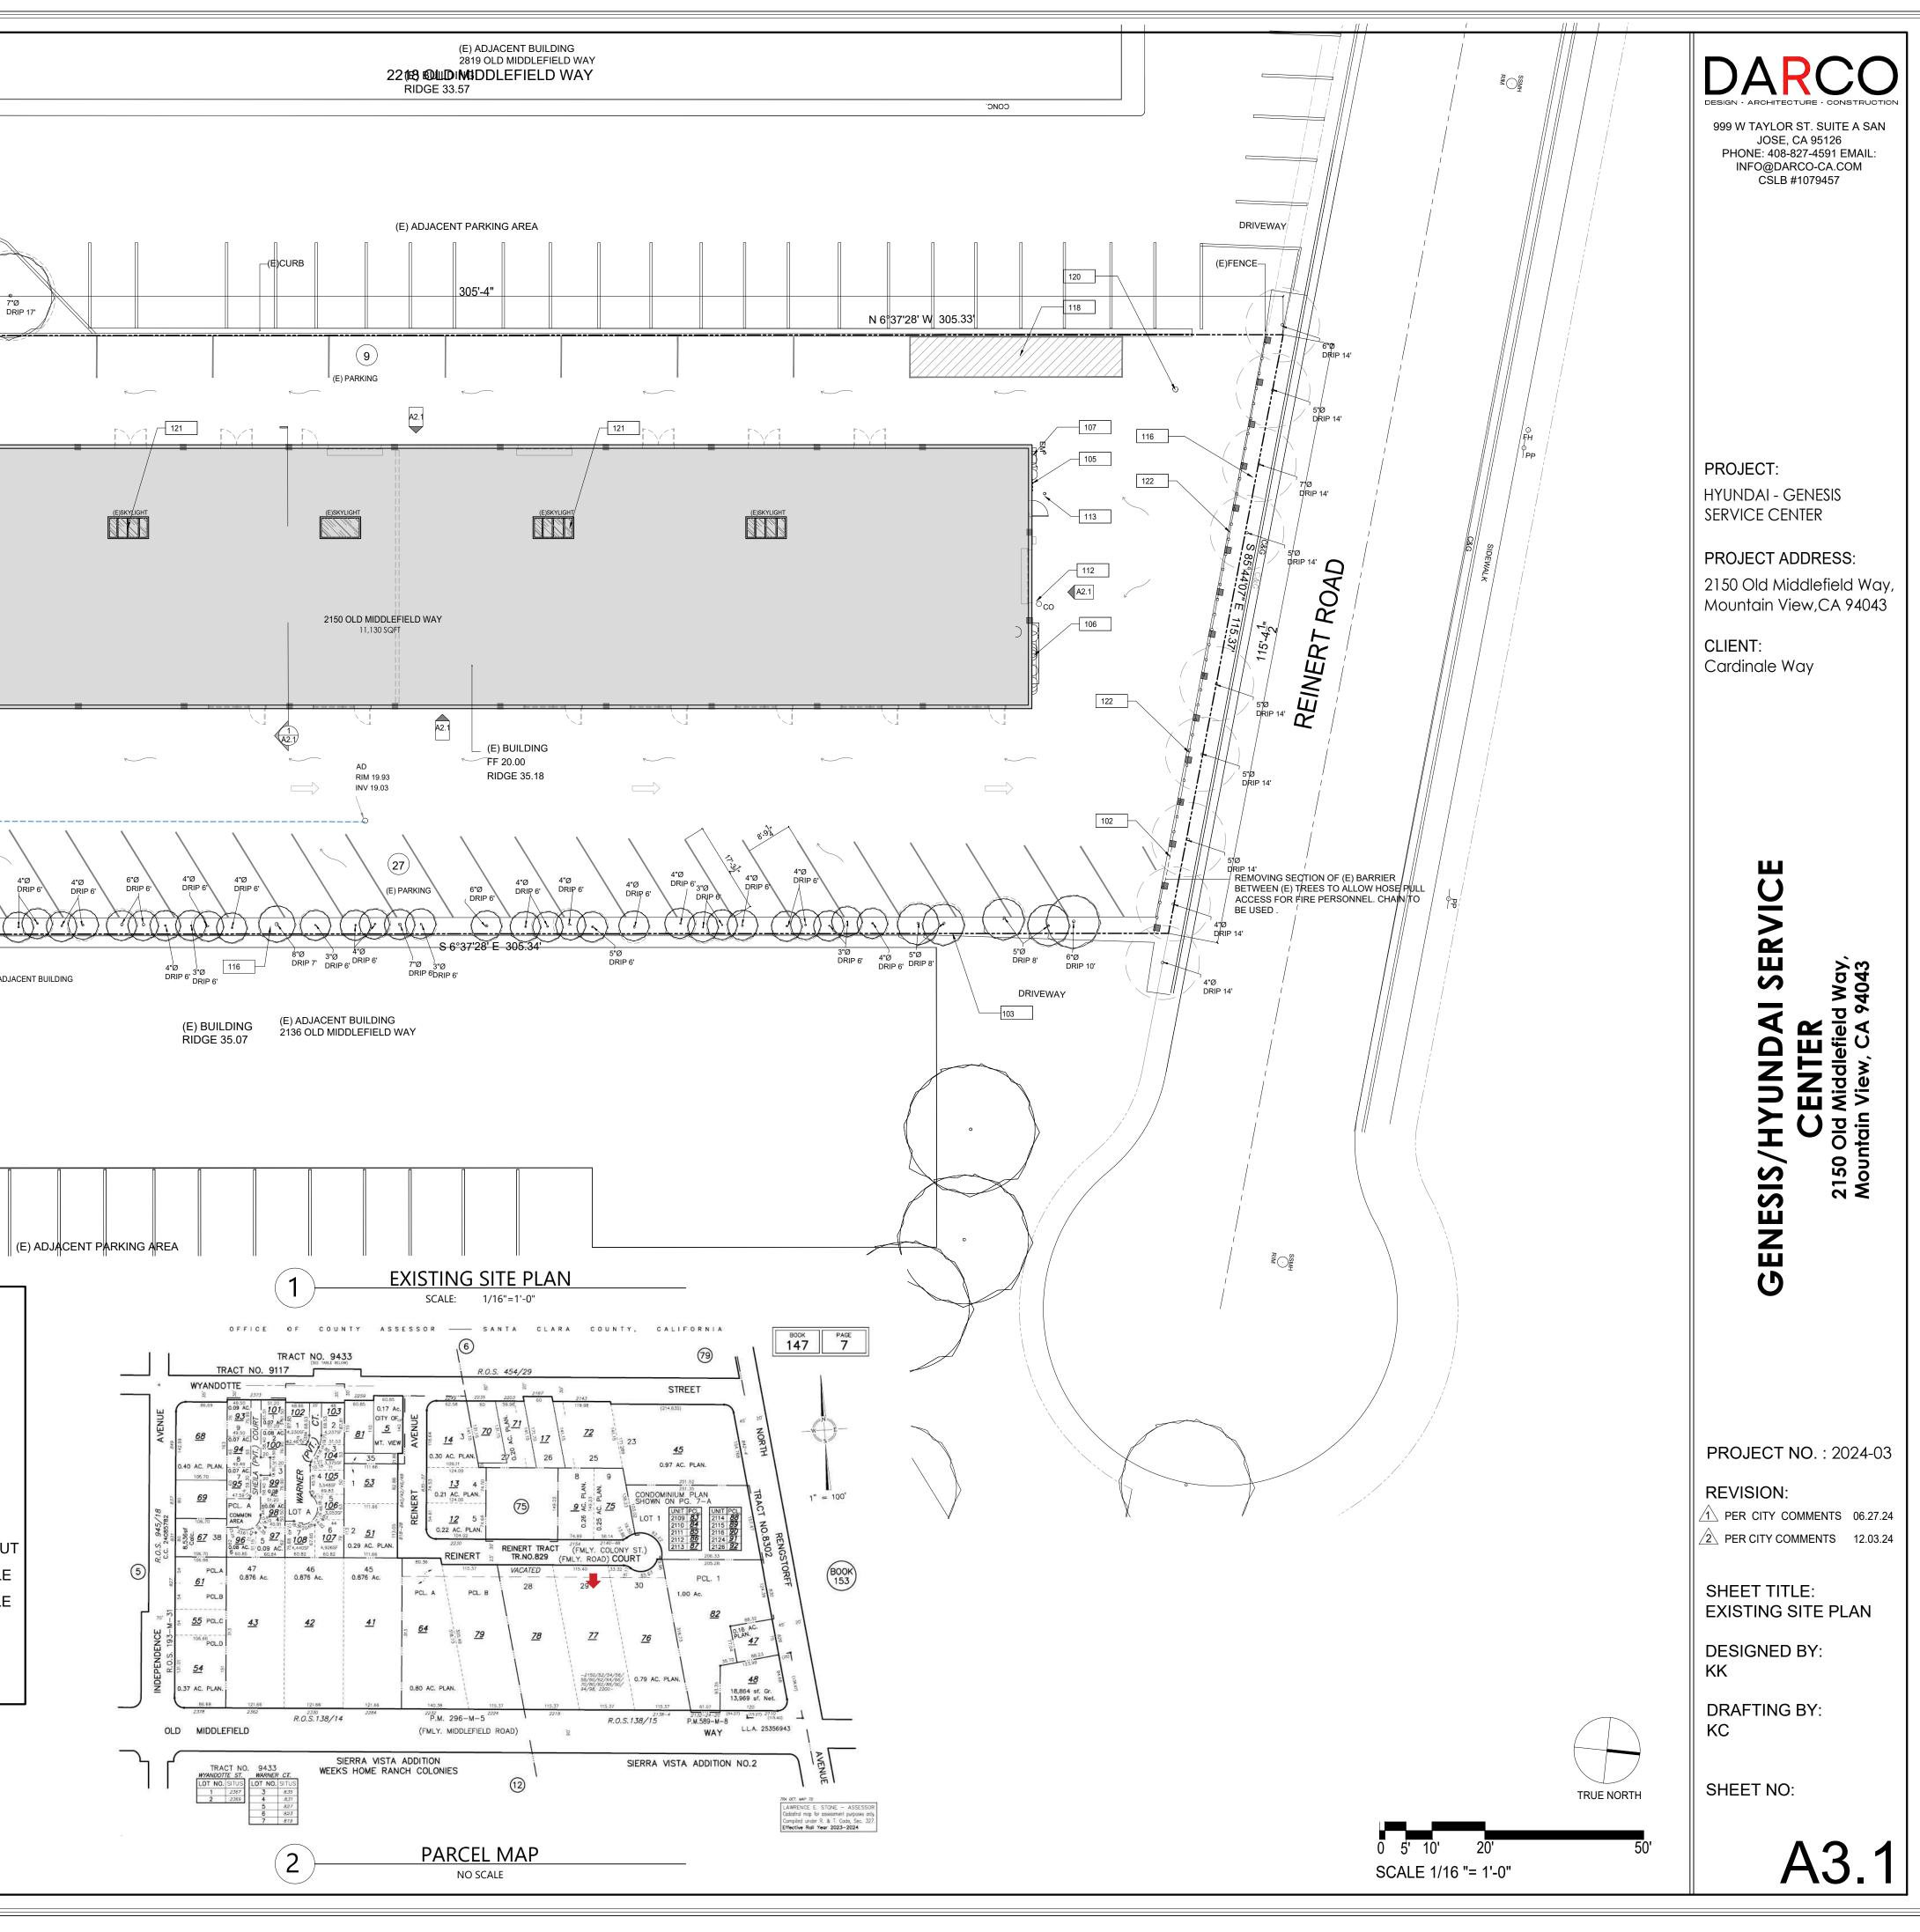

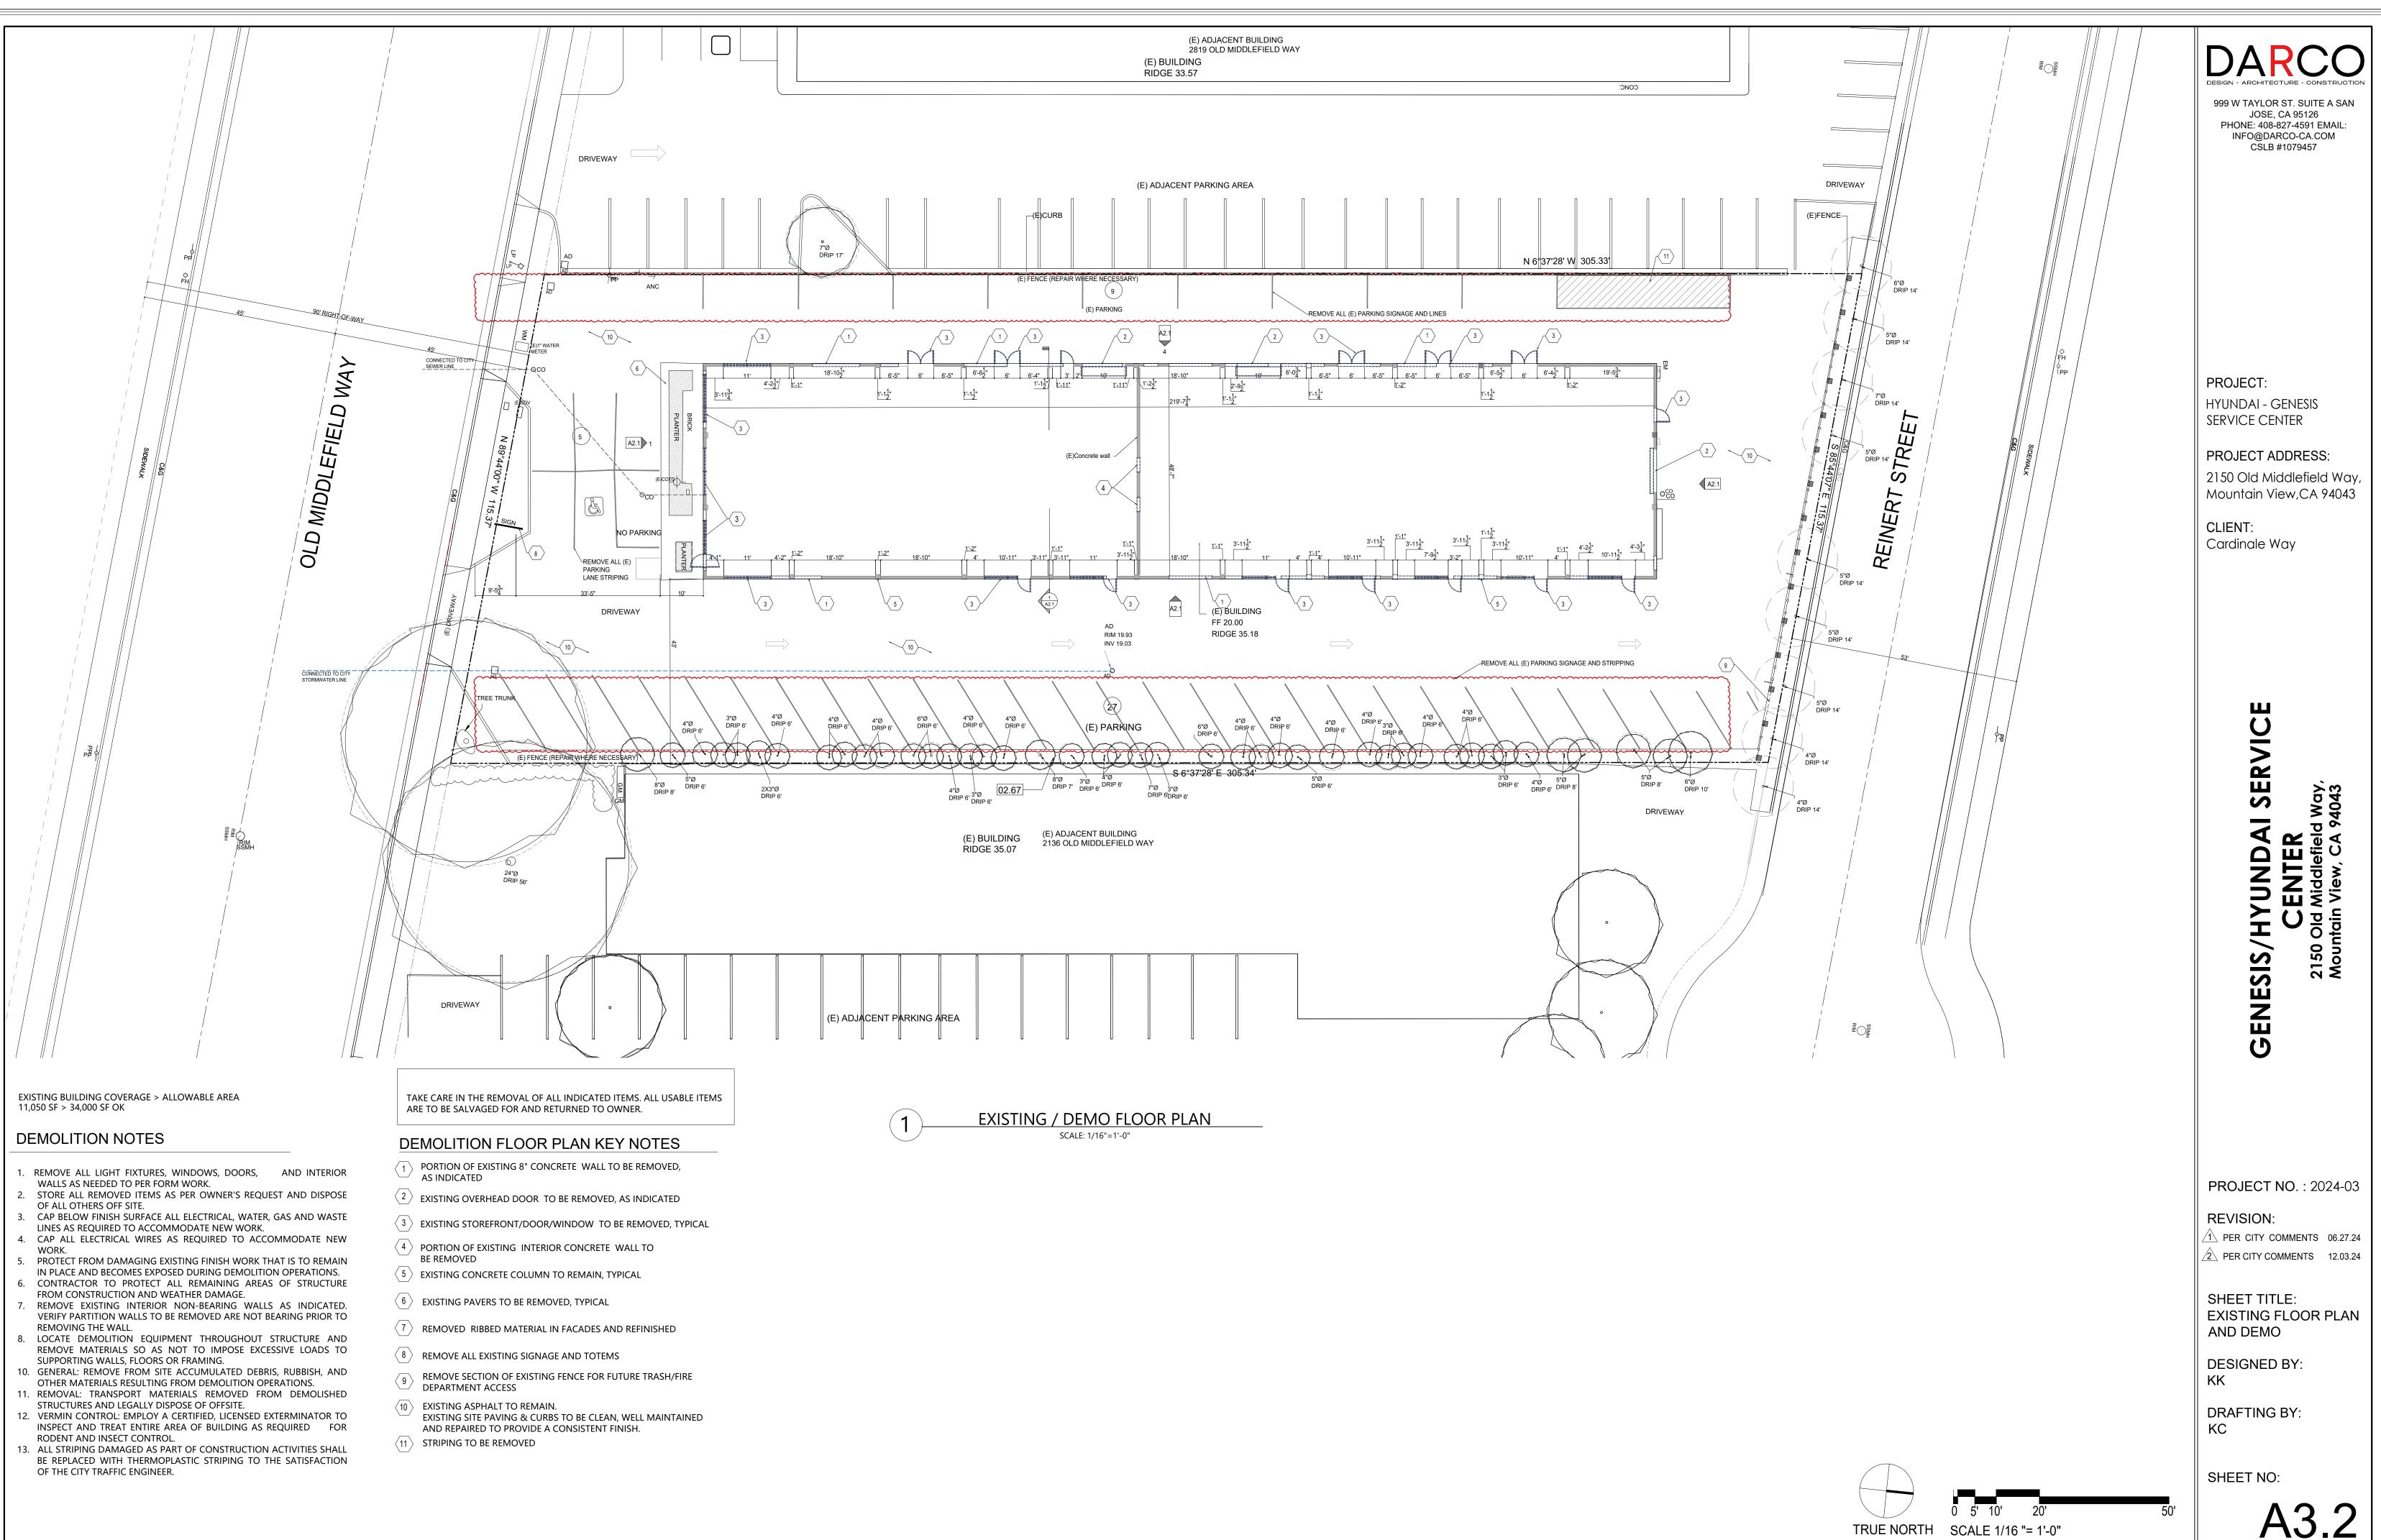



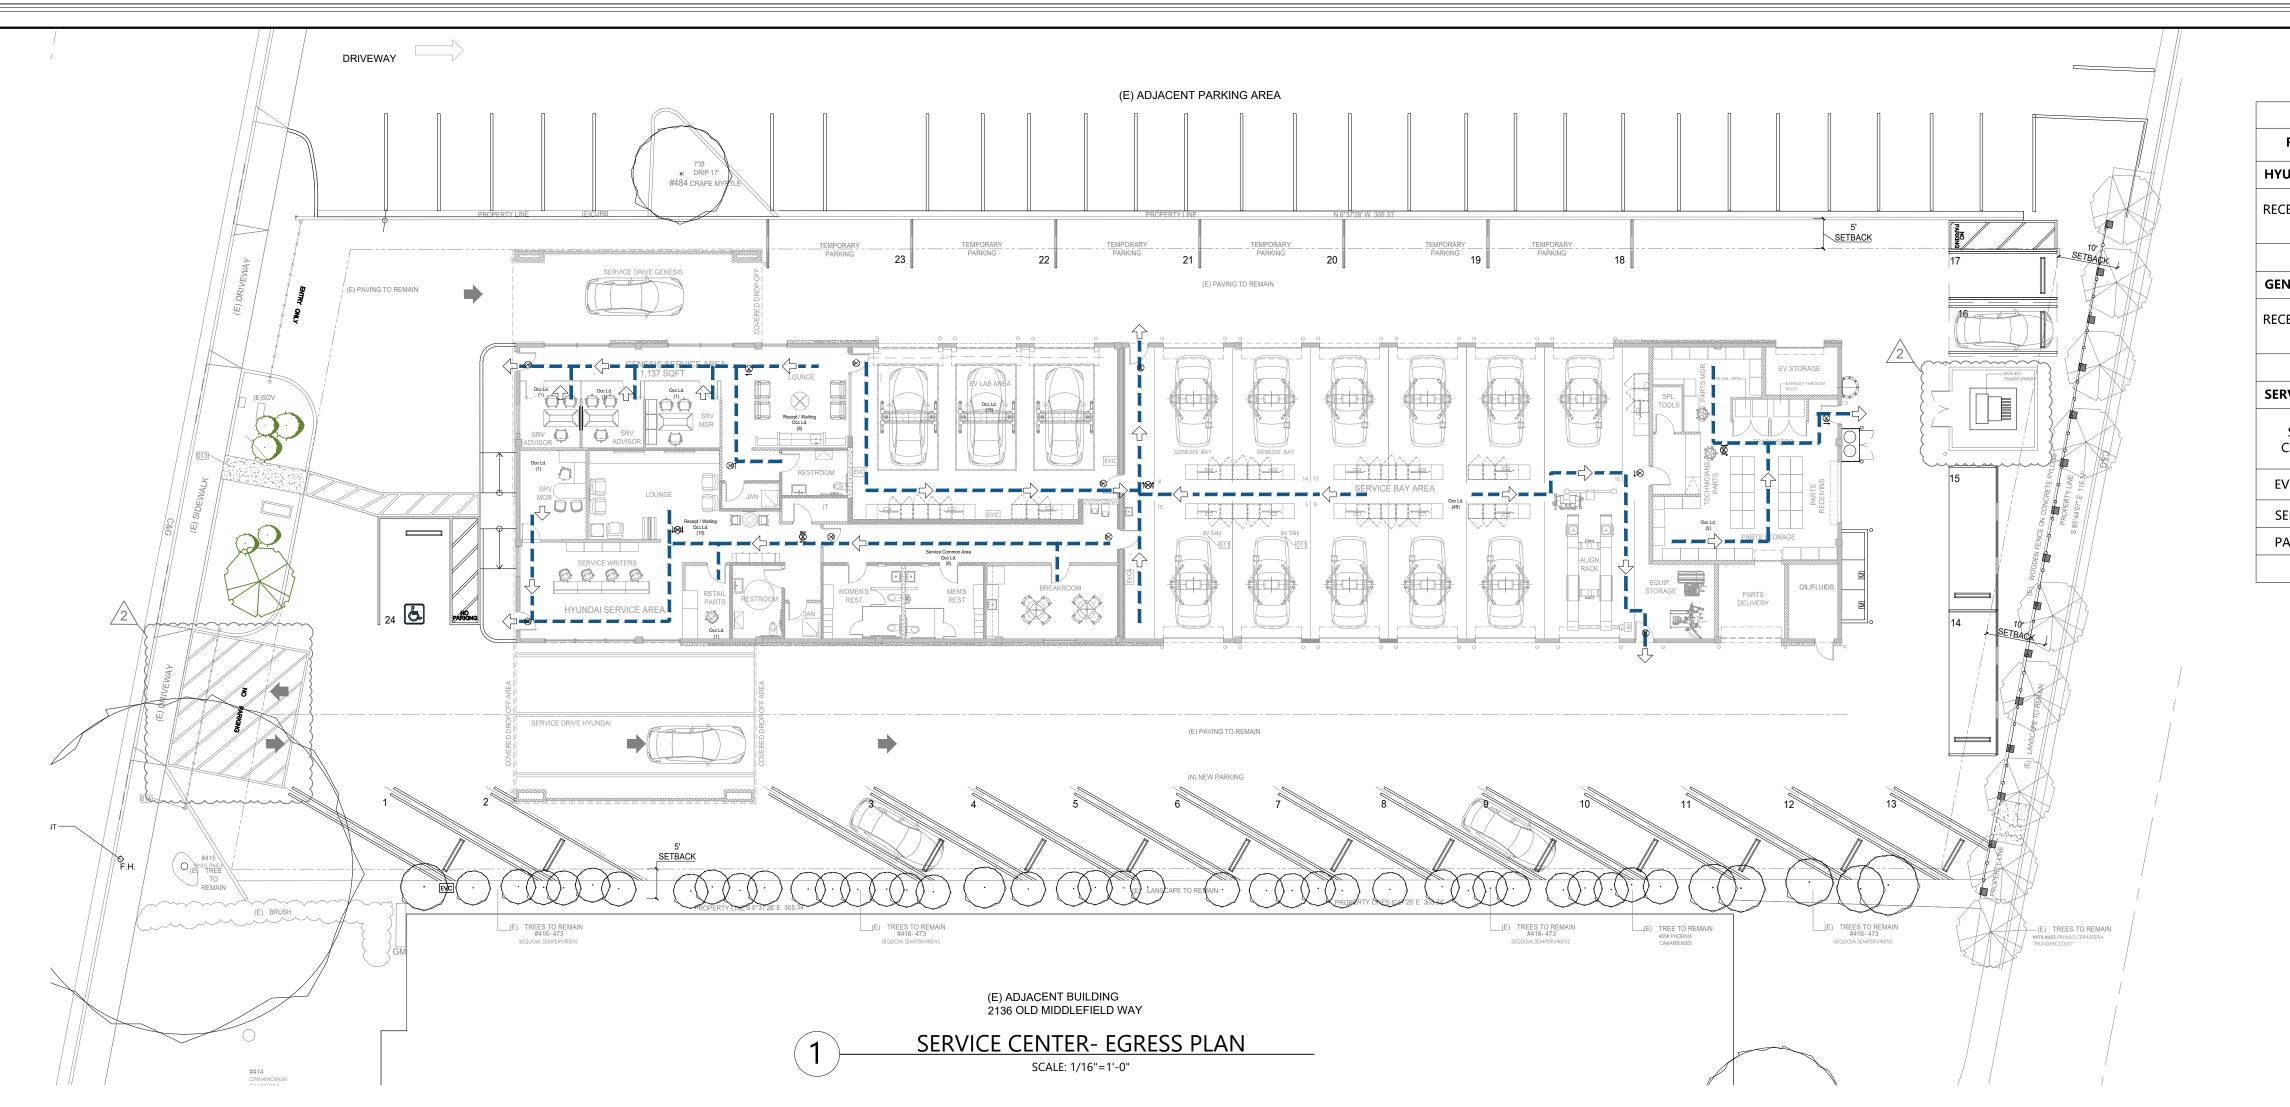

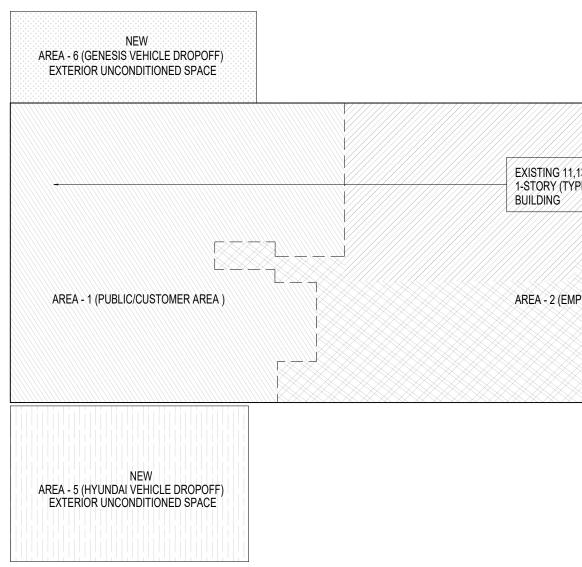

130.SF PE V-B)	AREA - 3 BATT STOR.) AREA - 4 (TRASH ENCLOSURE) NEW
PLOYEE ONLY AREA)	

REQUIRED PARKING CALCULATION	BUILDING AREA CALCULATION
TOTAL BUILDING SQUARE FOOTAGE: 11,130 SF TOTAL SITE SQUARE FOOTAGE: (.81 ACRE) 34,592 SF	TOTAL LOT AREA: 34,592 SF
BUILDING AREA : MAIN BUILDING: 11,130 SF	(N) HYUNDAI SERVICE AREA1,416 SF(N) GENESIS SERVICE AREA1,138 SF(N) EMPLOYEE AREA1,185 SF
11,130 / 34,592 SF = 32.2 %	(N) EV LAB 1,330 SF (N) SERVICE BAYS 4,580 SF (N) DADES AND STOPACE 1.010 SE
REQUIRED AND PROPOSED PARKING: REPAIR GARAGE : 5 + 11,130 SF / 200 = <u>61 STALLS REQUIRED</u>	(N) PARTS AND STORAGE1,318 SF(N) TRASH STORAGE47 SF(N) EV STORAGE116 SF
PROPOSED PARKING SPACES: (PROVIDED)	TOTAL BUILDING AREA 11,130 SF
DIAGONAL PARKING STALLS13ADA PARKING (VAN)1TEMPORARY PARKING FOR SERVICE PERSONNEL10SERVICE BAYS14TOTAL PARKING PROVIDED38BICYCLE PARKING:0	LANDSCAPING AREA CALCULATION EXISTING LANDSCAPING AREA: EXISTING FRONT PLANTER: 324 SF EAST SIDE LANDSCAPING AREA: 1,120 SF TOTAL (E) : <u>1,444 SF</u> PROPOSED LANDSCAPE AREA: (N) FRONT LANDSCAPE ADDITION: <u>161 SF</u> (E) FRONT LANDSCAPING AREA: 324 (E) EAST SIDE LANDSCAPING AREA: 1,120 SF TOTAL (N) : <u>1,605 SF</u>

BUILDING AREA								
SYMBOL	DESCRIPTION	SF						
AREA -1	MAIN BUILDING - SERVICE CENTER PUBLIC AREA, CUSTOMER RESTROOMS AND LOUNGES	2,554	PORTION OF EXISTING STRUCTURE					
AREA - 2	MAIN BUILDING - EMPLOYEE COMMON AREAS, SERVICE BAYS AND PARTS/STORAGE AREAS	8,413	PORTION OF EXISTING STRUCTURE					
AREA - 3	EV BATTERY STORAGE	116	PORTION OF EXISTING STRUCTURE					
AREA- 4	TRASH STORAGE	47	PORTION OF EXISTING STRUCTURE					
AREA - 5	HYUNDAI - COVERED VEHICLE DROP-OFF AREA	1,052	NEW ADDITION (EXTERIOR UNCONDITIONED SPACE)					
AREA- 6	GENESIS - COVERED VEHICLE DROP-OFF AREA	625	NEW ADDITION (EXTERIOR UNCONDITIONED SPACE)					
	TOTAL:	11,130						

OCCUPANCY AND AREA CALCULATION								
AREA DESCRIPTION	OCCUPANCY GROUP	AREA (SF)	OCC. LOAD FACTOR	OCC. LOAD PER AREA				
BUSINESS	В	1,416	1/150	10				
BUSINESS	В	1,138	1/150	8				
BUSINESS	В	1,185	1/150	8				
BUSINESS/INDUSTRIAL	S-1	1,330	1/100	13				
BUSINESS/INDUSTRIAL	S-1	4,580	1/100	46				
ACCESSORY STORAGE	S-1	1,318	1/300	5				
	DESCRIPTION BUSINESS BUSINESS BUSINESS BUSINESS/INDUSTRIAL BUSINESS/INDUSTRIAL	DESCRIPTIONGROUPBUSINESSBBUSINESSBBUSINESSBBUSINESSBBUSINESS/INDUSTRIALS-1BUSINESS/INDUSTRIALS-1	DESCRIPTIONGROUPAREA (SF)BUSINESSB1,416BUSINESSB1,416BUSINESSB1,138BUSINESSB1,138BUSINESSB1,185BUSINESS/INDUSTRIALS-11,330BUSINESS/INDUSTRIALS-14,580	DESCRIPTION GROUP AREA (SF) FACTOR BUSINESS B 1,416 1/150 BUSINESS B 1,416 1/150 BUSINESS B 1,138 1/150 BUSINESS B 1,138 1/150 BUSINESS B 1,138 1/150 BUSINESS B 1,185 1/150 BUSINESS/INDUSTRIAL S-1 1,330 1/100 BUSINESS/INDUSTRIAL S-1 4,580 1/100				




A3.

0 5' 10'


TRUE NORTH SCALE 1/16 "= 1'-0"


20'

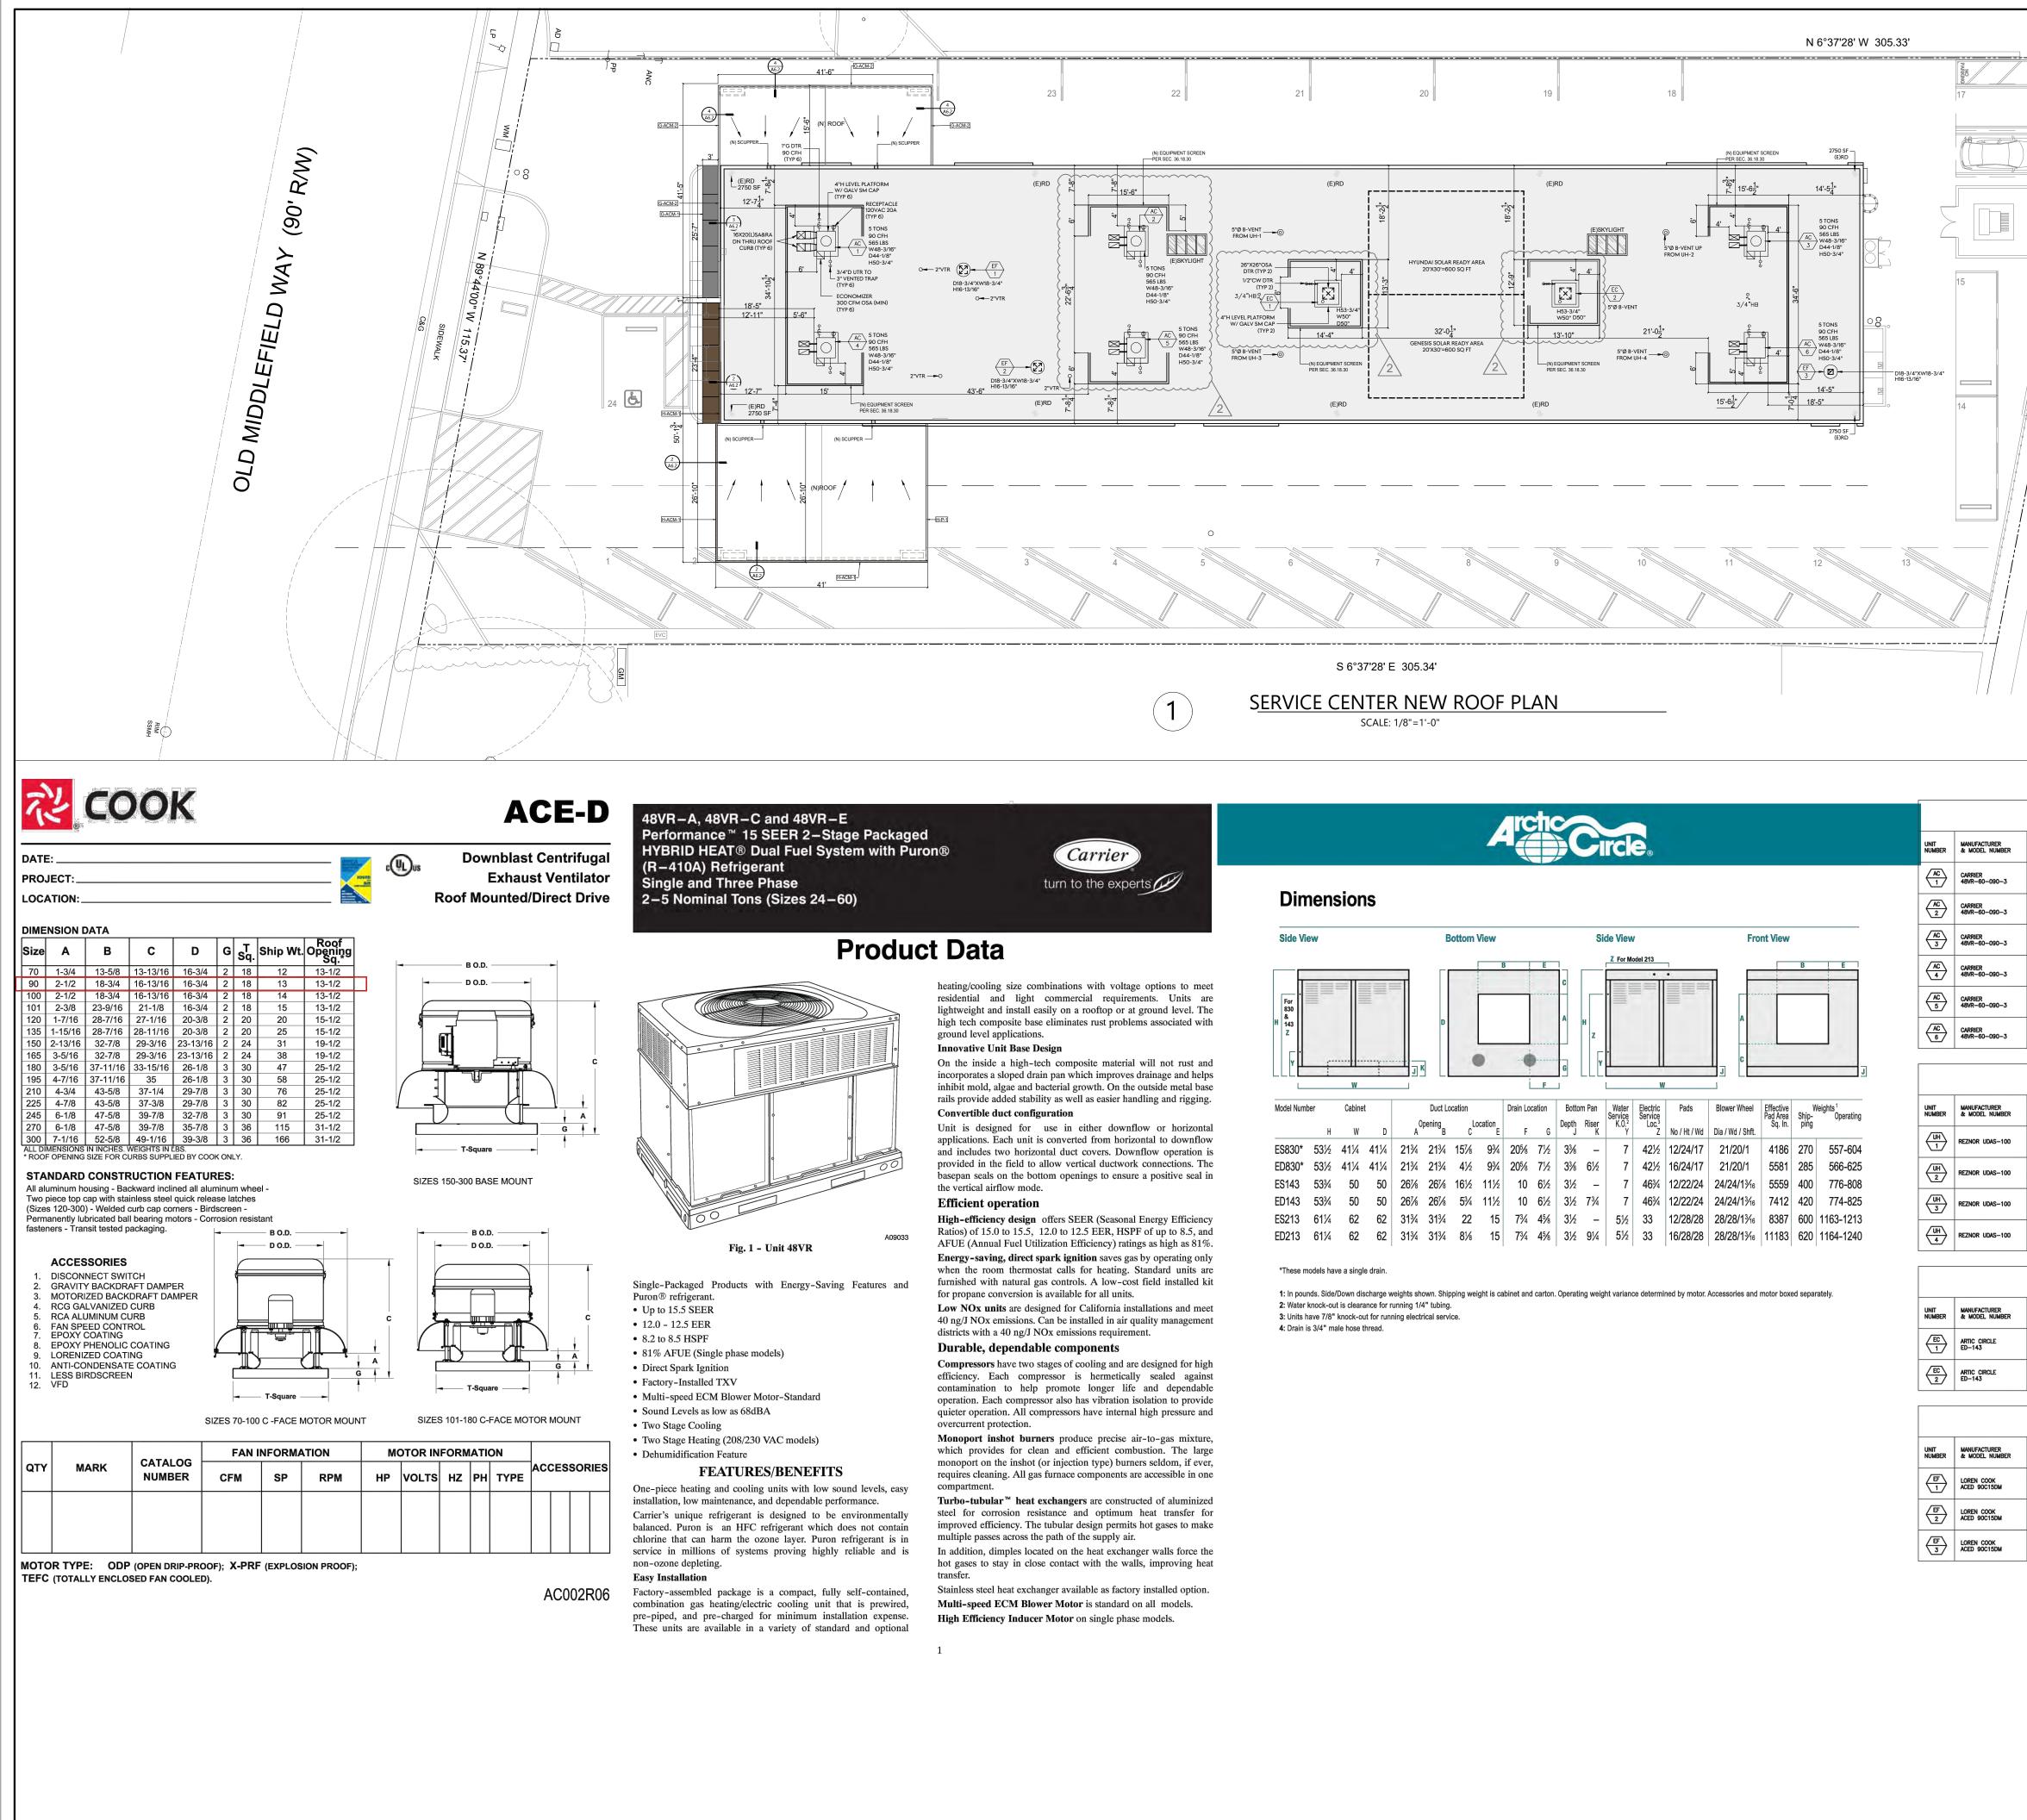



								4				ICI	₩®							NUMBER	& M
																				AC 1	CARI 48Vi
Dim	nens	sion	IS																	AC 2	CARI 48VF
Side Vie	ew				B	Bottom	View				Si	de View	/		Fro	nt View				AC 3	CARF 48VR
-								B	E			Z For Mo		•			В	E		AC 4	CARF 48VF
For 830																				AC 5	CARF 48VR
& 143 Z					D					A	H Z				A					AC 6	CARI 48VF
v I	-				۹		D	-0		G	_Y	•		_					1		
		W						Ĺ	F				W						1		
Model Numb	ber	Cabine	t		Duct Lo	ocation		Drain Lo	cation	Botto	m Pan	Water Service K.0,2	Electric Service	Pads	Blower Wheel	Effective Pad Area	V Ship-	Veights ¹ Operating		UNIT NUMBER	MANU & M
	Н	W	D	A	pening B	C	ocation E	F	G	Depth J	Riser K	K.0. ² Y	Loc. ³ Z	No / Ht / Wd	Dia / Wd / Shft.	Sq. In.	Ship- ping	opolouilg			
S830*	53 ½	41¼	41 ¼	21¾	21 ¾	151/8	9 ¾	205%	7 ½	33%	_	7	42½	12/24/17	21/20/1	4186	270	557-604			REZN
ED830*	53½	41¼	41¼	21¾	21 ¾	4½	9 ¾	205%	7½	33%	6½	7	42 ½	16/24/17	21/20/1	5581	285	566-625			REZN
ES143	53 ¾	50	50	261/8	261/8	16½	11½	10	6½	3½	_	7	46¾	12/22/24	24/24/1 ³ ⁄16	5559	400	776-808			
ED143	53 ¾	50	50	261/8	261/8	5 ¾	11½	10	6½	3½	7¾	7	46¾	12/22/24	24/24/1 ³ / ₁₆	7412	420	774-825		$\left\langle \frac{UH}{3} \right\rangle$	REZN
ES213	61¼	62	62	31¾	31 ¾	22	15	7¾	4%	3½	-	5½	33	12/28/28	28/28/1 ³ ⁄16	8387	600	1163-1213			
ED213	61¼	62	62	31¾	31¾	81/8	15	7¾	45⁄8	3½	9¼	5½	33	16/28/28	28/28/1 ³ ⁄16	11183	620	1164-1240			REZN


47XW18-3/4" 16"		Card						1.	CG 1 MAN SCR BRAI REFI FOR PLAC MEC	UFACTU EEN PST CING. ER TO M OTHER CE ROOF	Rdinat Irer o Is. Ref Echan Roof ⁻ Walk L Equii	E WITH N LOCA ER TO NICAL, E EQUIPM (PAD A ⁻ PMENT,	MECHA TION OI STRUCI LECTRI ENT. F PERIM ROOF I	NICAL SCREEN F MECHANICAL FURAL FOR CAL, AND PLUMBING IETER OF HATCHES AND	PROJECT: HYUNDAI - GENESIS SERVICE CENTER PROJECT ADDRESS: 2150 Old Middlefield Way, Mountain View, CA 94043 CLIENT: Cardinale Way
		PACKAG SUPPLY FAN					INIT (ID GAS			HEAT	PUM	P)	
	MANUFACTURER & MODEL NUMBER	CFM ESP	TOTAL	SENSIBLE	SEER2	INPUT	OUTPUT	AFUE	VOLTAGE	PHASE	HERTZ	MCA	operating Weight	REMARKS & OPTIONAL ACCESSORIES	
AC 1	CARRIER 48VR-60-090-3	2,000 0.5"	58,500	42,900	15.0	90,000	74,000	82%	208/230	1	60	44.8	600	ECONOMIZER, MERV 13 FILTER RACK, LOW AMBIENT KIT, TIME GUARD II,	
AC 2	CARRIER 48VR-60-090-3	2,000 0.5"	58,500	42,900	15.0	90,000	74,000	82%	208/230	1	60	44.8	600	COMPRESSOR START KIT, CRANKCASE HEATER, ECONOMIZER, MERV 13 FLITER RACK, LOW AMBIENT KIT, TIME GUARD II, COMPRESSOR START KIT, CRANKCASE HEATER,	SERVIC Way, 4043
AC 3	CARRIER 48VR-60-090-3	2,000 0.5*	58,500	42,900	15.0	90,000	74,000	82%	208/230	1	60	44.8	600	ECONOMIZER, MERV 13 FILTER RACK, LOW AMBIENT KIT, TIME GUARD II,	DAI SE ER CA 94043
AC 4	CARRIER 48VR-60-090-3	2,000 0.5"	58,500	42,900	15.0	90,000	74,000	82%	208/230	1	60	44.8	600	COMPRESSOR START KIT, CRANKCASE HEATER, ECONOMIZER, MERV 13 FILTER RACK, LOW AMBIENT KIT, TIME GUARD II,	
AC 5	CARRIER 48VR-60-090-3	2,000 0.5"	58,500	42,900	15.0	90,000	74,000	82%	208/230	1	60	44.8	600	COMPRESSOR START KIT, CRANKCASE HEATER, ECONOMIZER, MERV 13 FILTER RACK, LOW AMBIENT KIT, TIME GUARD II,	
AC 6	CARRIER 48VR-60-090-3	2,000 0.5*	58,500	42,900	15.0	90,000	74,000	82%	208/230	1	60	44.8	600	COMPRESSOR START KIT, CRANKCASE HEATER, ECONOMIZER, MERV 13 FILTER RACK, LOW AMBIENT KIT, TIME GUARD II,	View,
						UNI	HEA'	FERS							Ded A CE
UNIT NUMBER	MANUFACTURER & MODEL NUMBER	CONFIGURATION	SUPPL	y fan Esp	HEATIN	IG CAPACITY	Ø ARI AFUE	VOLTAGE	ELECT	IRICAL HERTZ	FLA	OPERATING	REMARKS &	: OPTIONAL ACCESSORIES	
	REZNOR UDAS-100	CEILING SUSPENDED	1,300	0.1*	100,000	83,000	83%	120	1	60	3.9	250	AIR & EXH	SPENSION KIT, CONCENTRIC OUTSIDE AUST VENT ADAPTER FOR VERTICAL THERMOSTAT.	SIS/ Moul
	REZNOR UDAS-100	CEILING SUSPENDED	1,300	0.1*	100,000	83,000	83%	120	1	60	3.9	250	AIR & EXH	SPENSION KIT, CONCENTRIC OUTSIDE AUST VENT ADAPTER FOR VERTICAL THERMOSTAT.	L L L
	REZNOR UDAS-100	CEILING SUSPENDED	1,300	0.1"	100,000	83,000	83%	120	1	60	3.9	250	AIR & EXH	SPENSION KIT, CONCENTRIC OUTSIDE AUST VENT ADAPTER FOR VERTICAL THERMOSTAT.	
	REZNOR UDAS-100	CEILING SUSPENDED	1,300	0.1"	100,000	83,000	83%	120	1	60	3.9	250	AIR & EXH/	SPENSION KIT, CONCENTRIC OUTSIDE AUST VENT ADAPTER FOR VERTICAL THERMOSTAT.	<u>U</u>
				EVAD	יזידΩ		OLERS			I		•		,	
UNIT	MANUFACTURER & MODEL NUMBER	CONFIGURATION	SUPPL	y fan		ELECI	RICAL		OPERATING	REMARKS &	optional a	CCESSORIES			
	ARTIC CIRCLE ED-143	DOWN DISCHARGE	CFM 8000	SP 0.4*	VOLTAGE 230	PHASE 1	HERTZ 60	HP 1-1/2	825	SINGLE STAG	E FAN CONT	TROLLER/THER	Mostat, Dr cm240a		
	ARTIC CIRCLE ED-143	DOWN DISCHARGE	8000	0.4"	230	1	60	1-1/2	825			TROLLER/THER			
	1	L	I			(m - · ·		L	1	I					PROJECT NO. : 2024-03
UNIT	MANUFACTURER	CUNEIOI ID171011	EXHAUS		AHAUS	ST FAN			OPERATING	PEWARKE	OPTION	005000			
NUMBER	& MODEL NUMBER	CONFIGURATION CURB MOUNTED	CFM 100	SP 0.375*	VOLTAGE	PHASE 1	HERTZ 60	HP 1/20	WEIGHT 30		ROOF VCG10	6, BACKDRAFT			1 PER CITY COMMENTS 06.27.24 2 PER CITY COMMENTS 12.03.24
	ACED 90C15DM	CURB MOUNTED	400	0.5*	120	1	60	1/8	40			6, BACKDRAFT CONTROLLER			
	LOREN COOK ACED 90C15DM	CURB MOUNTED	100	0.375"	120	1	60	1/20	30			6, BACKDRAFT CONTROLLER			
		<u> </u>		l						<u>I</u>				I	SHEET TITLE: NEW ROOF PLAN
															DESIGNED BY:
															KK
															DRAFTING BY: KC
								\frown							SHEET NO:
							F							50'	
							T		ORTH	0 5' SCAL	-	ے =" 16	20' 1'-0"	00	A3.4

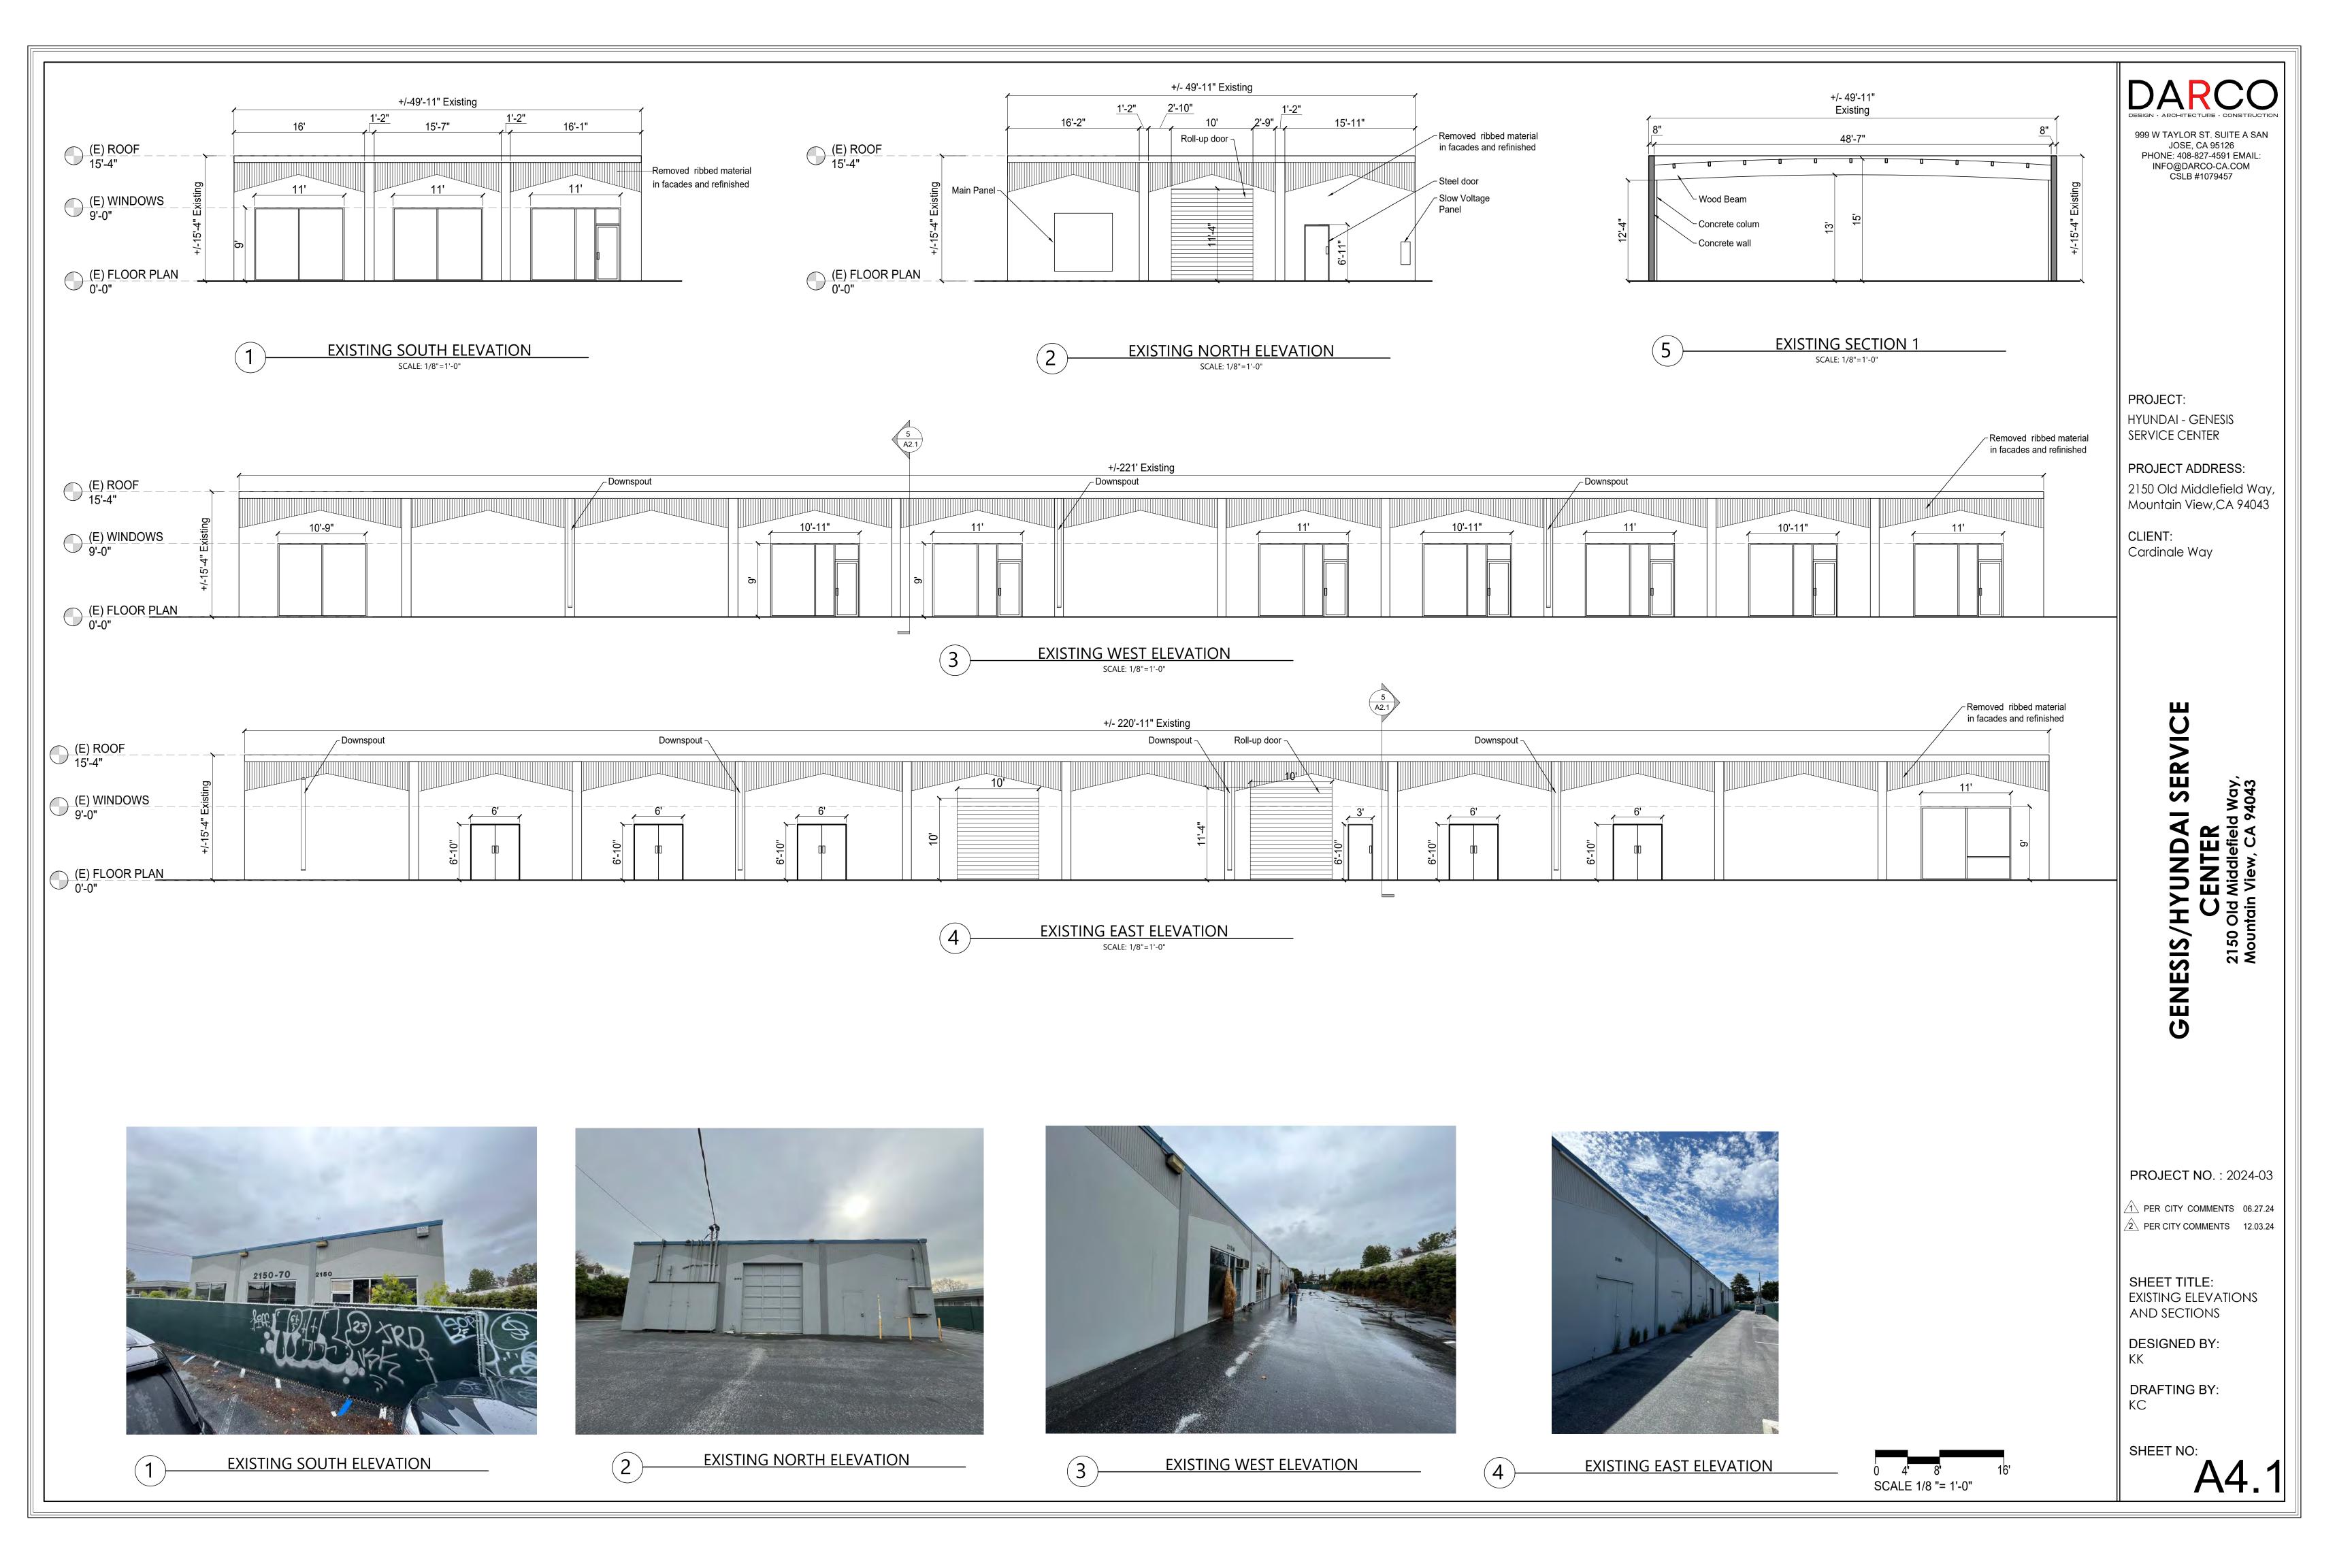


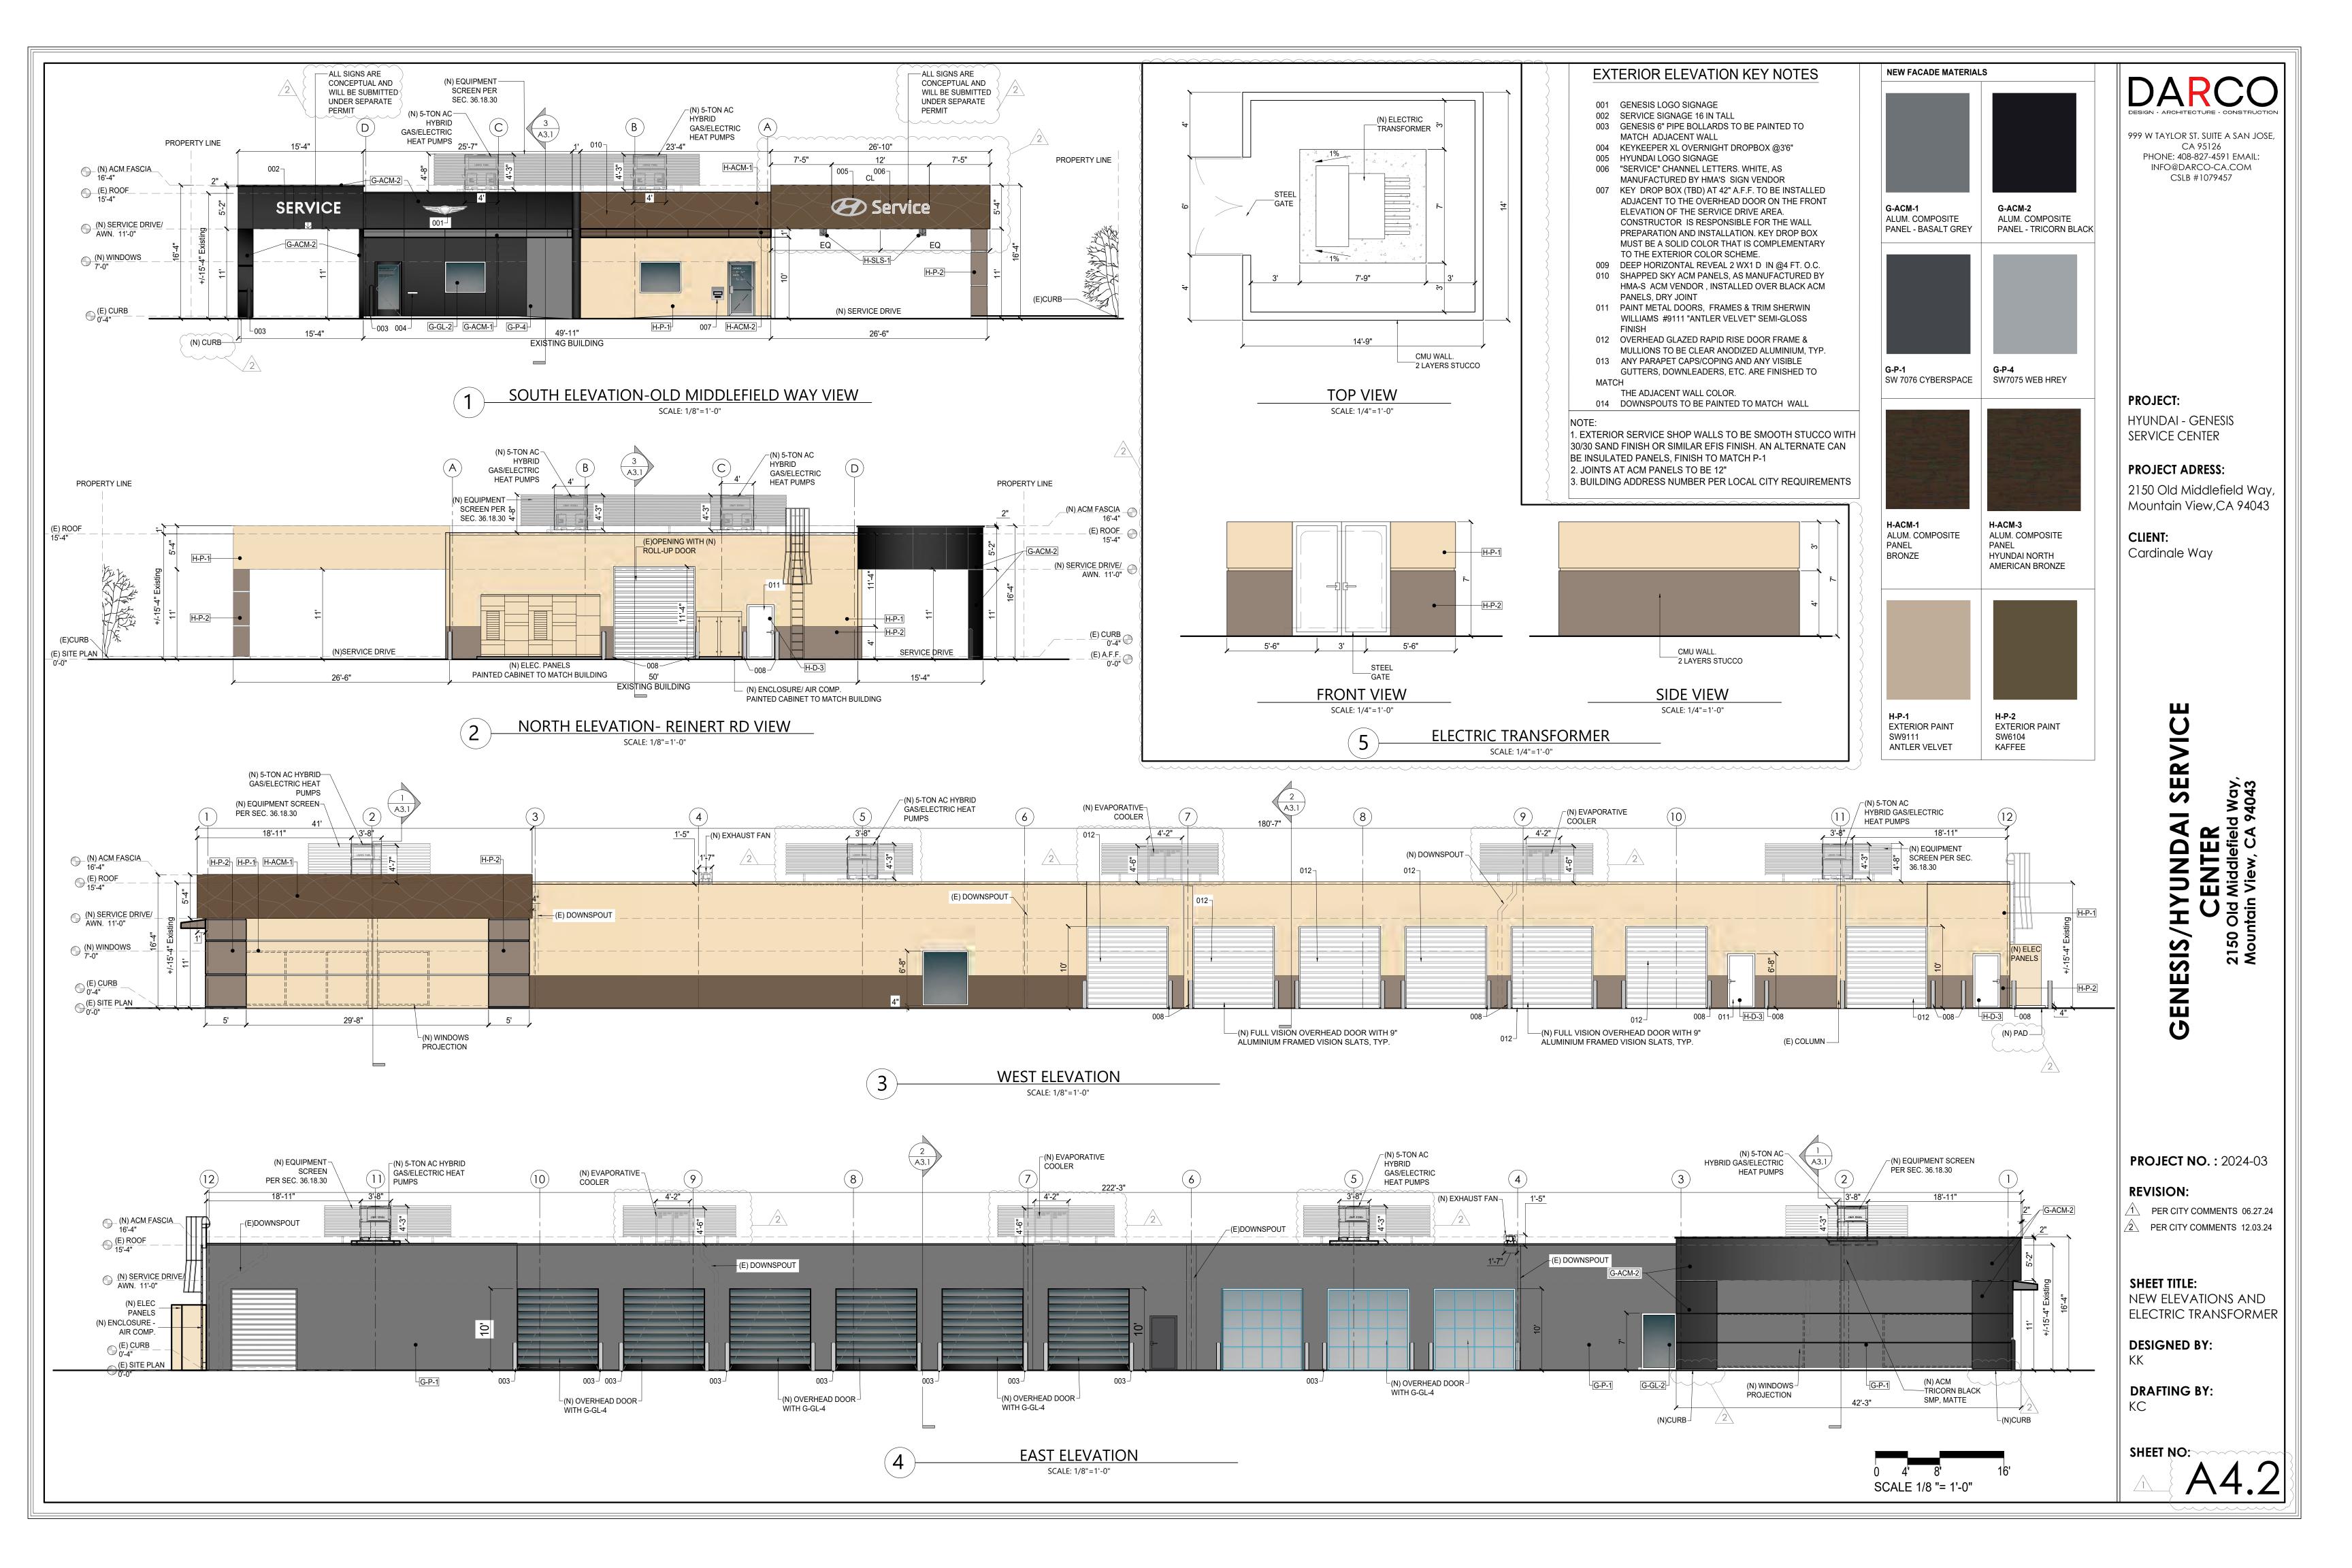


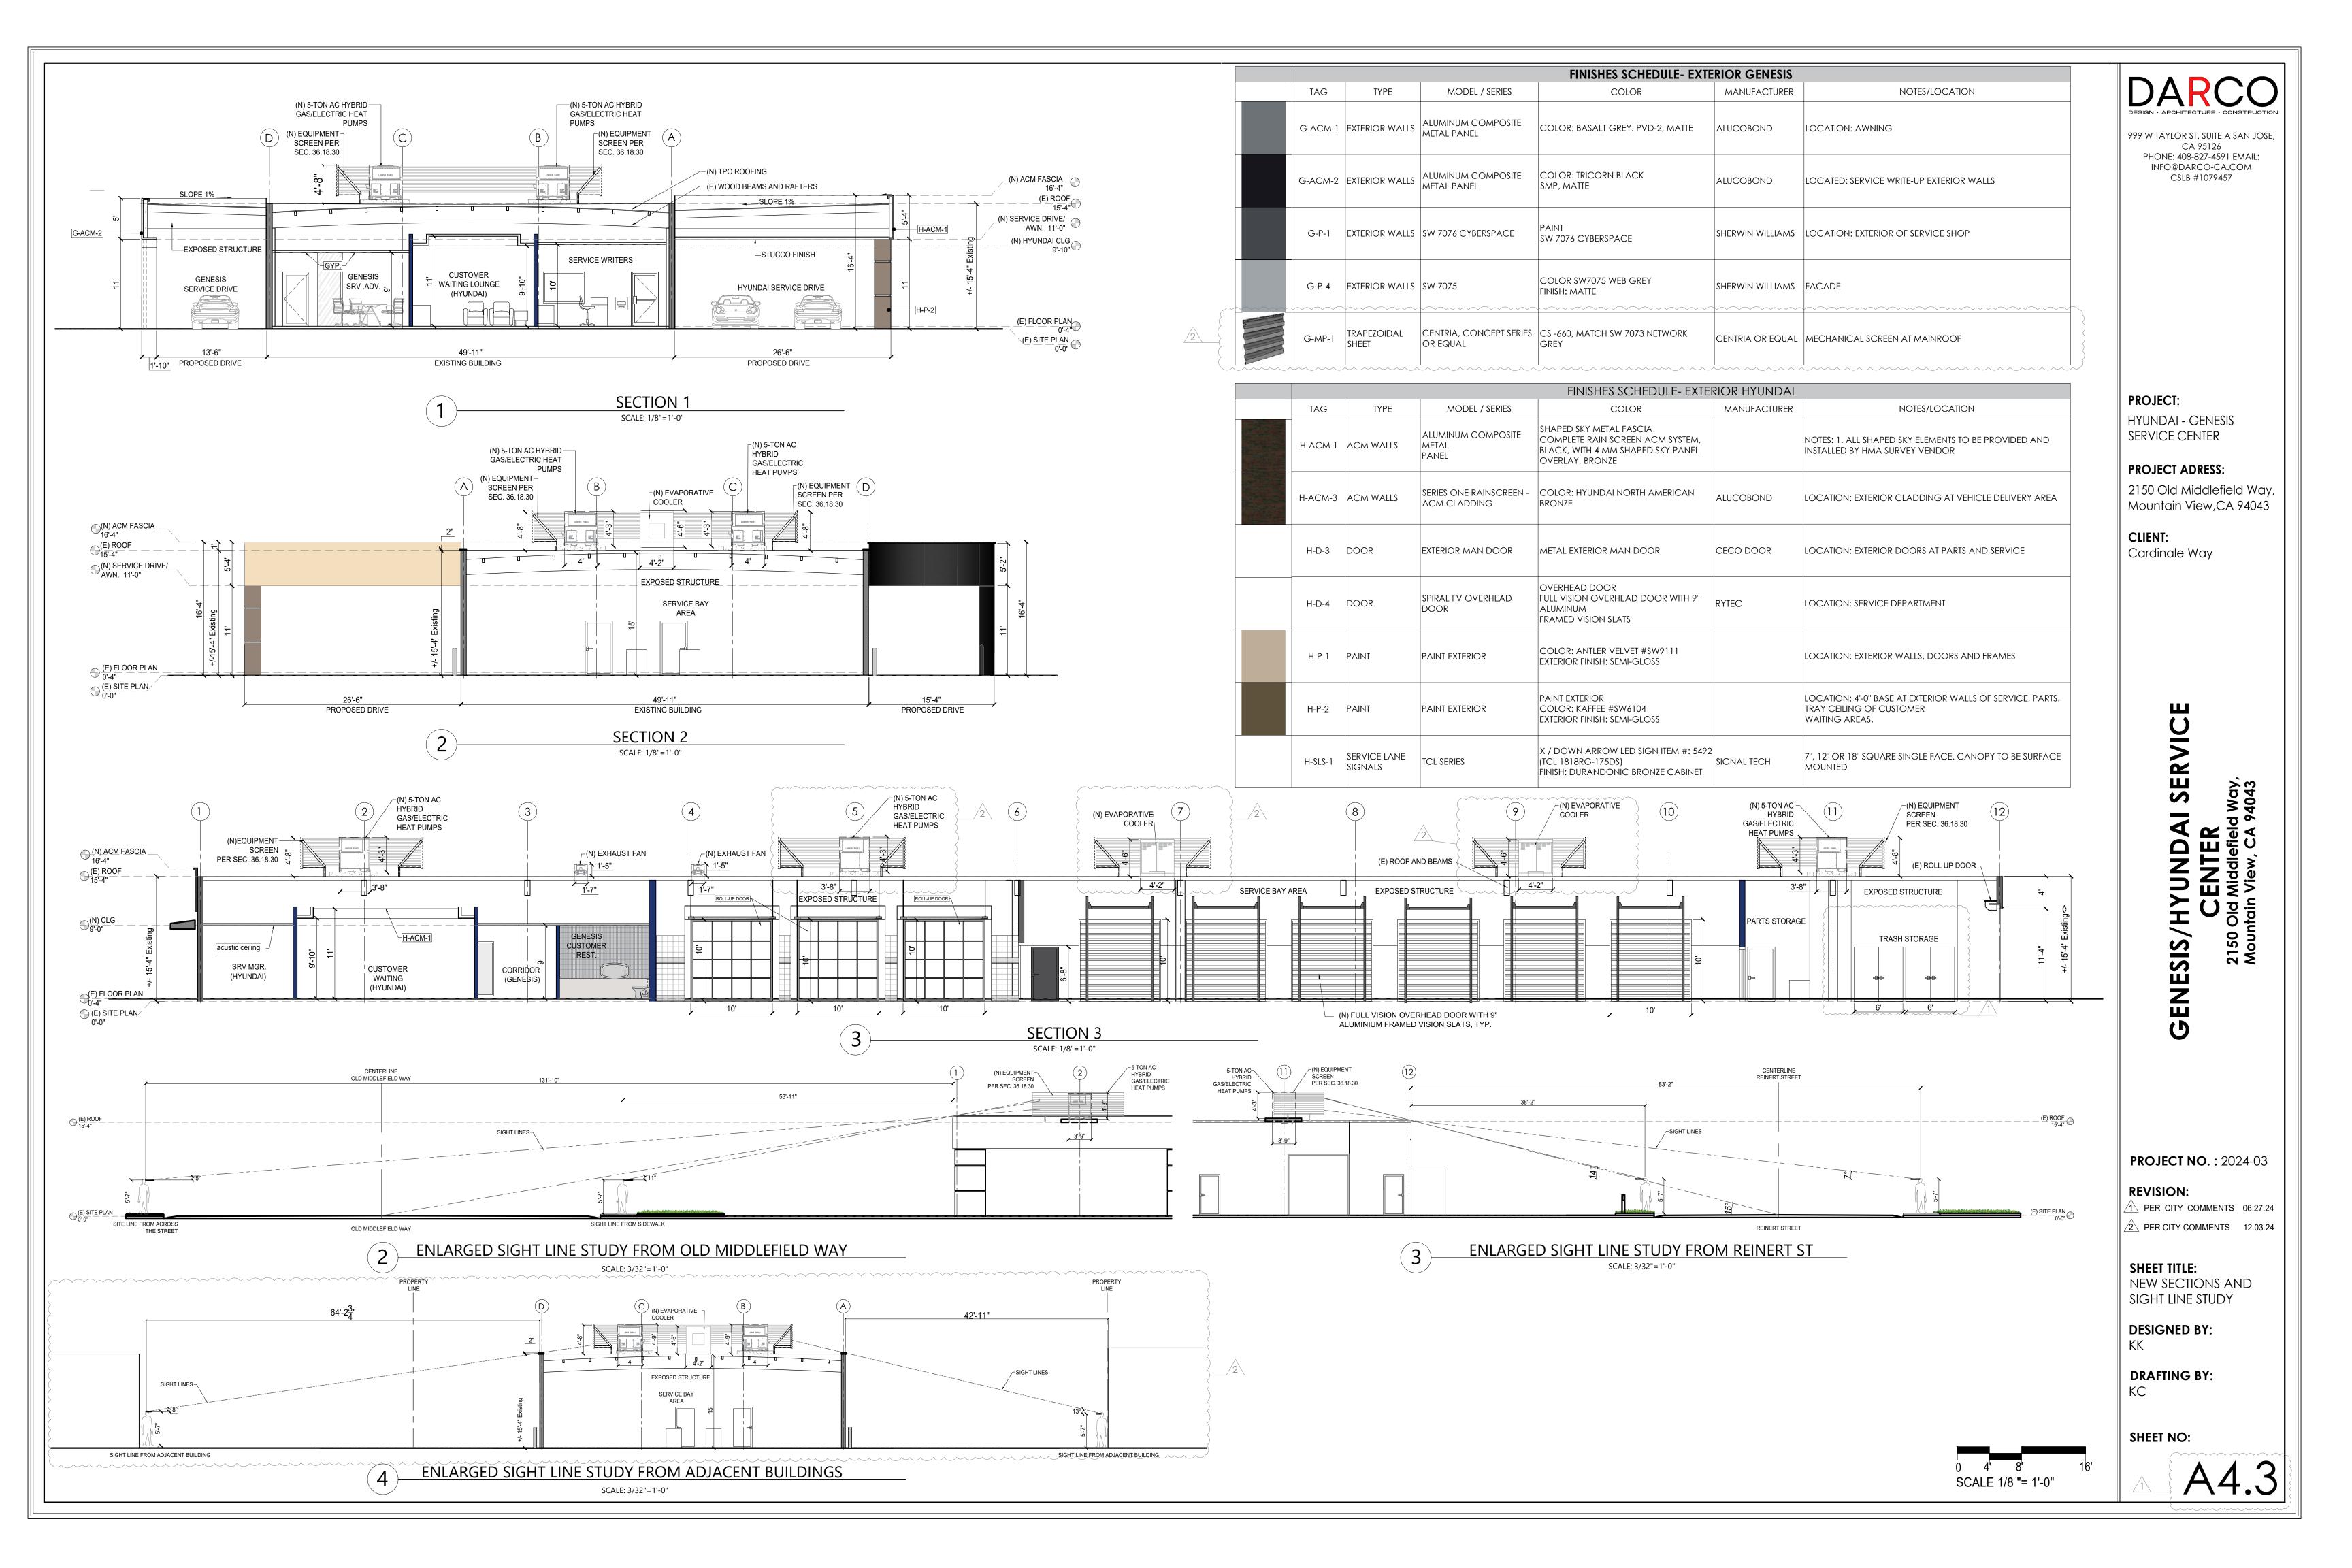

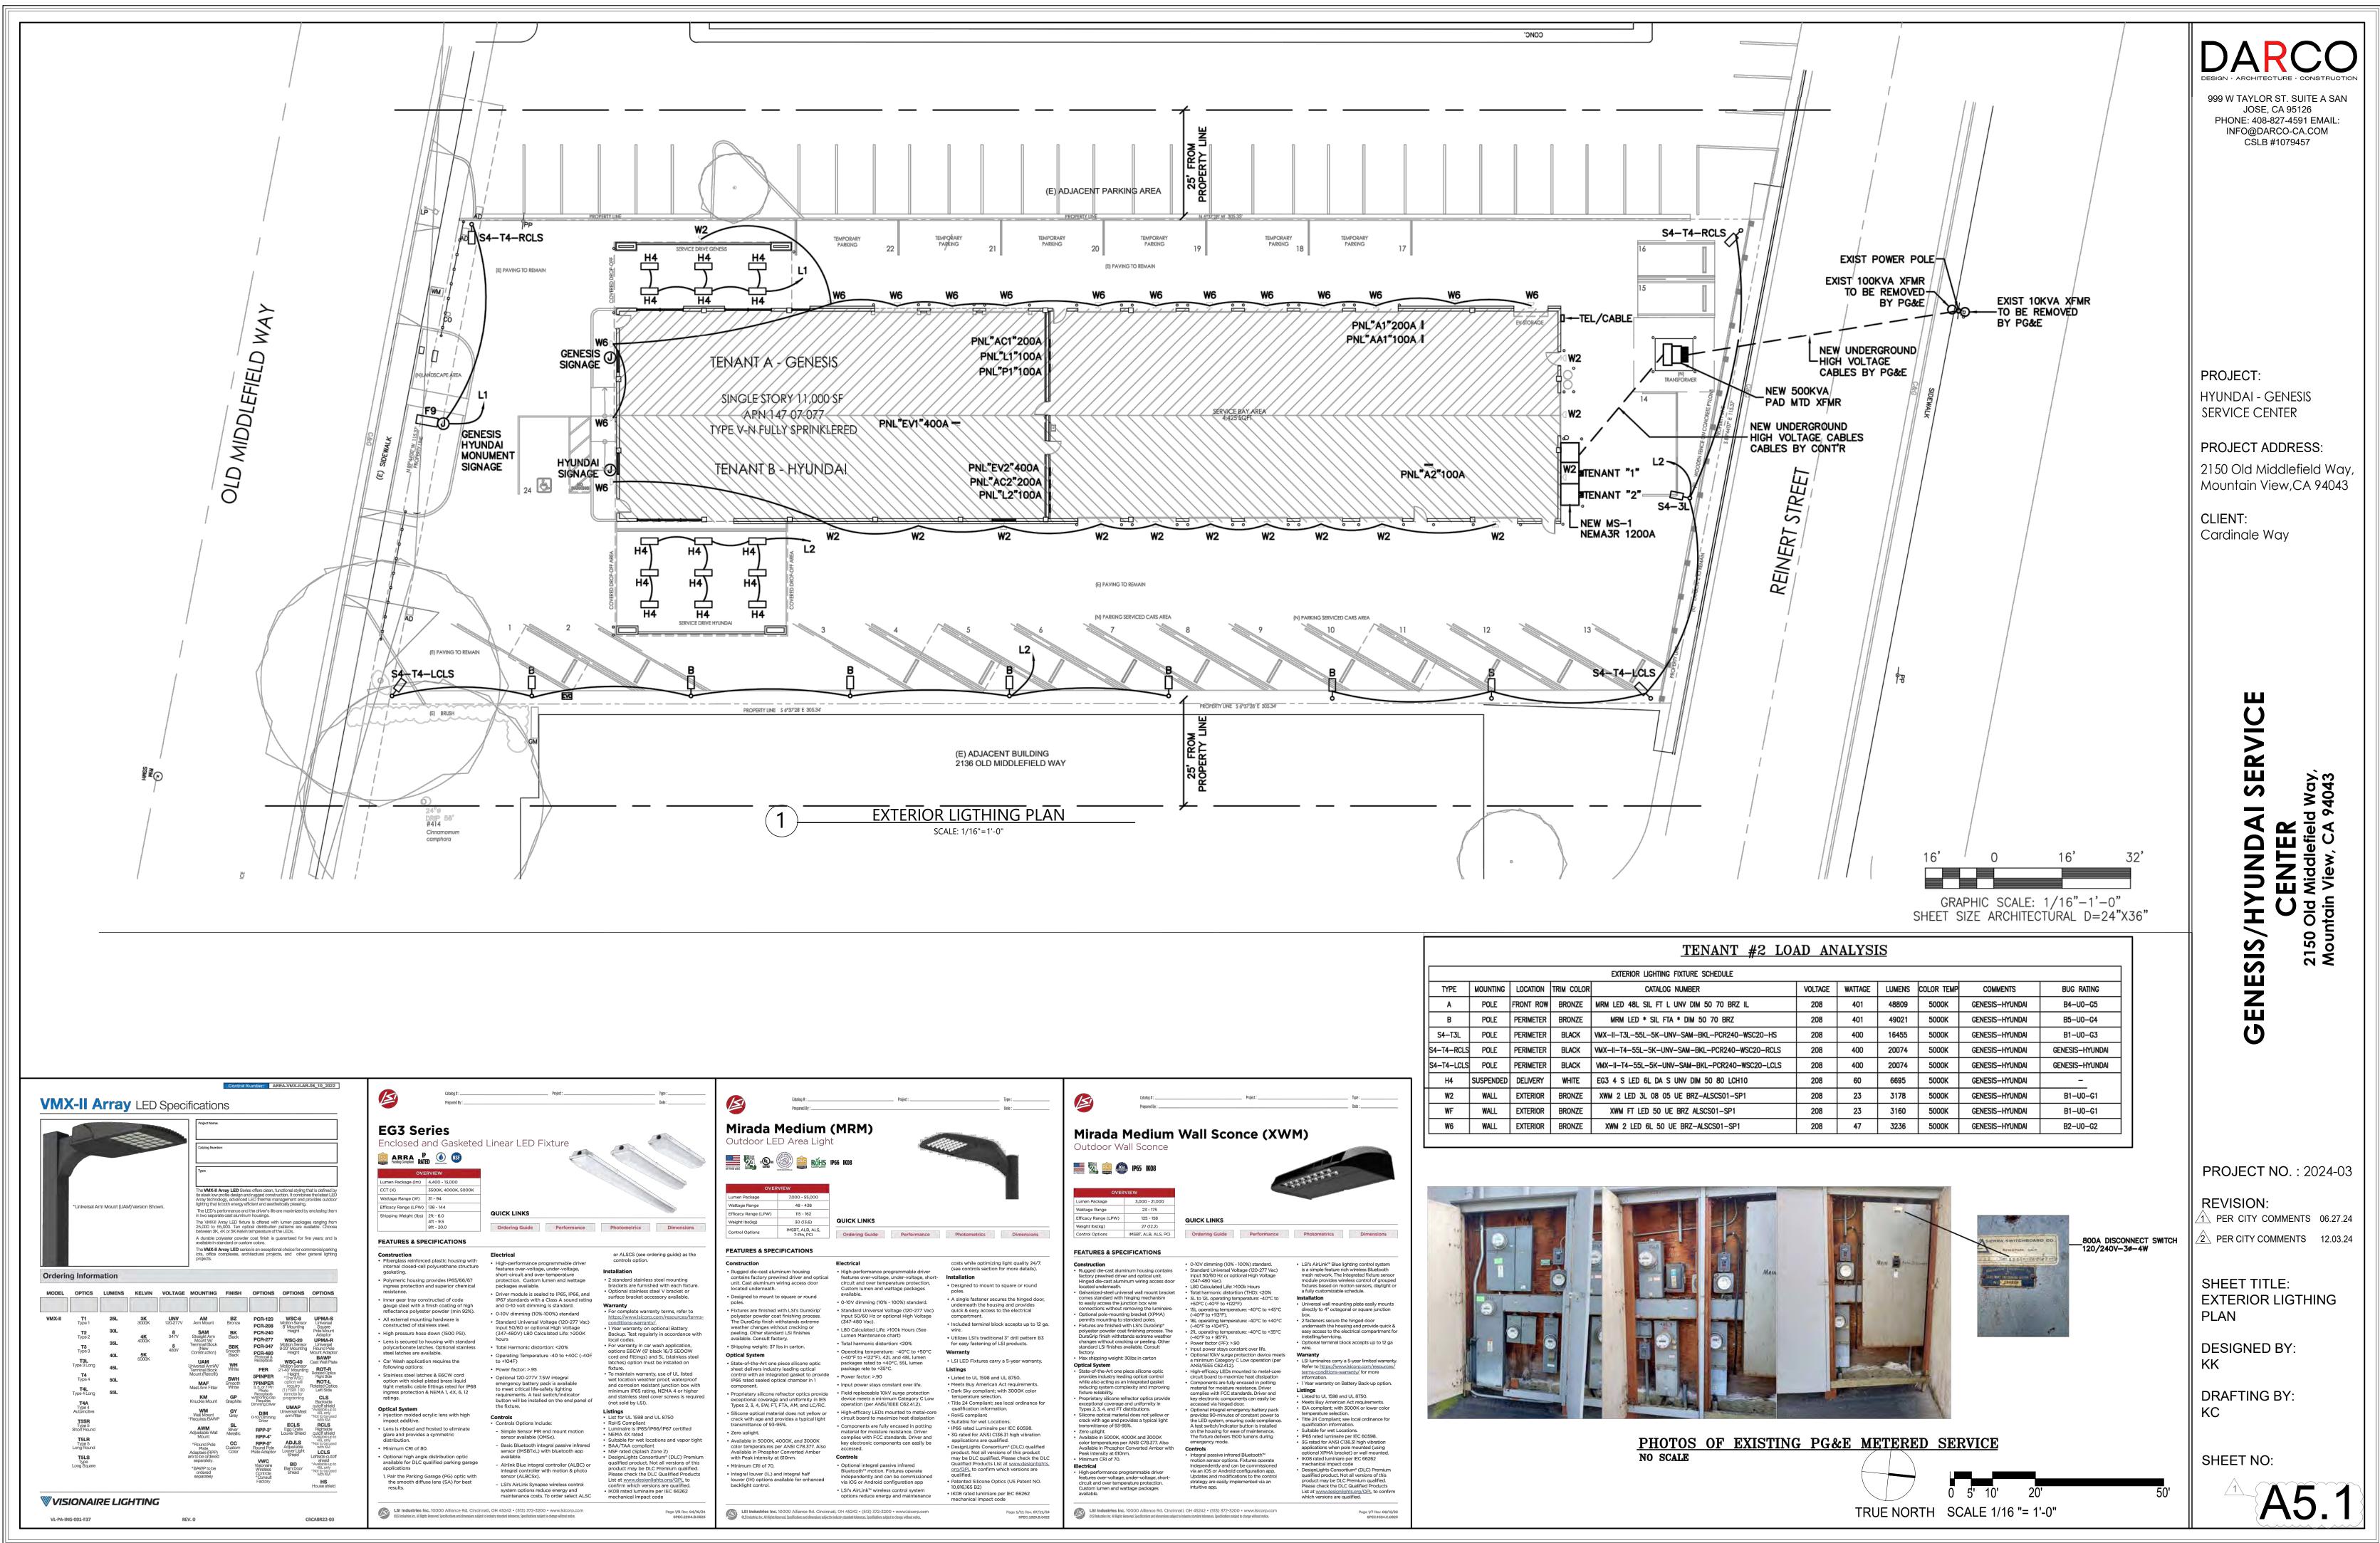


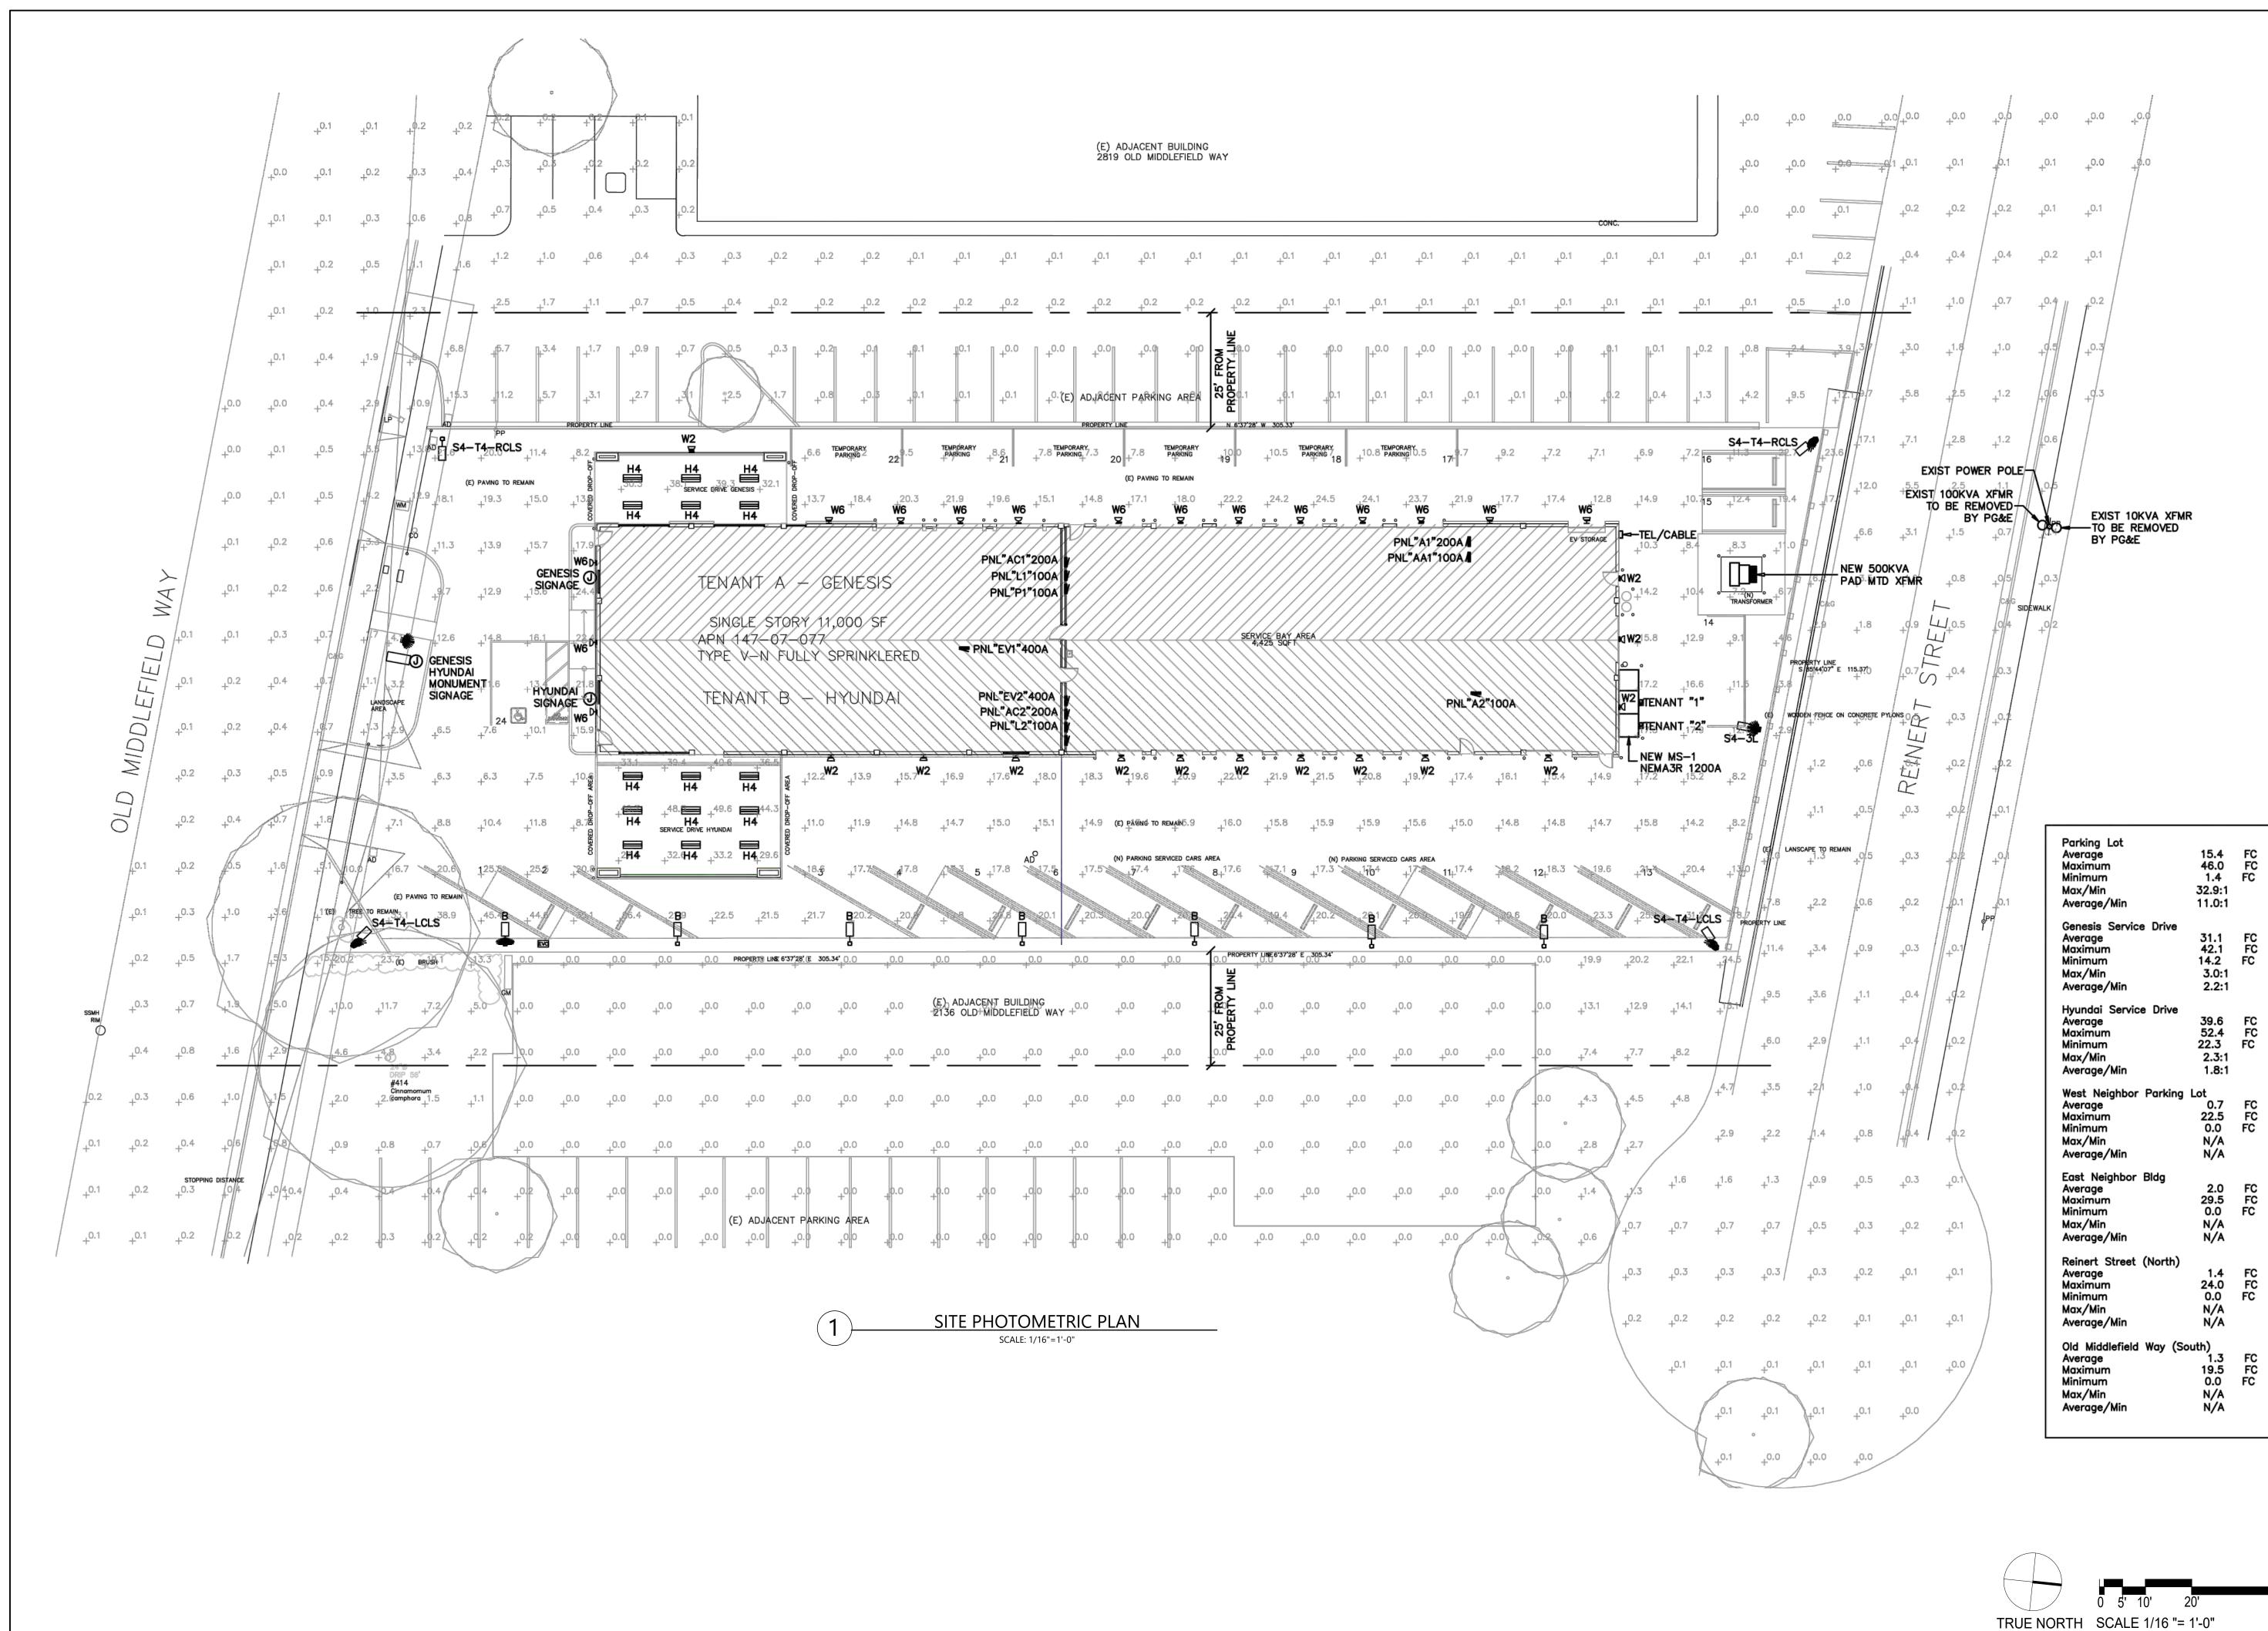


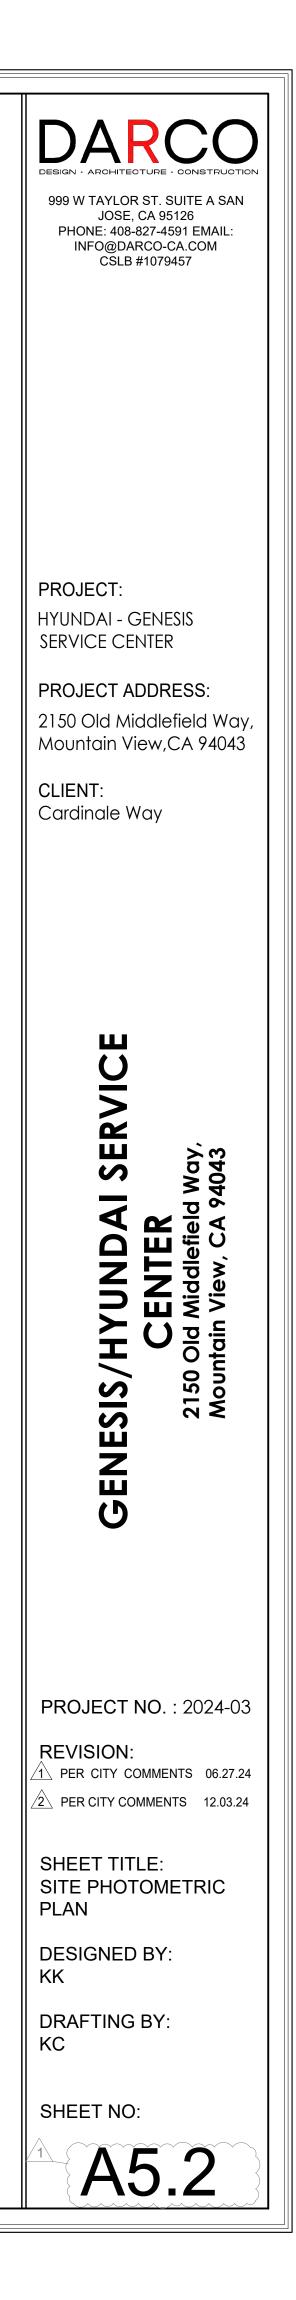


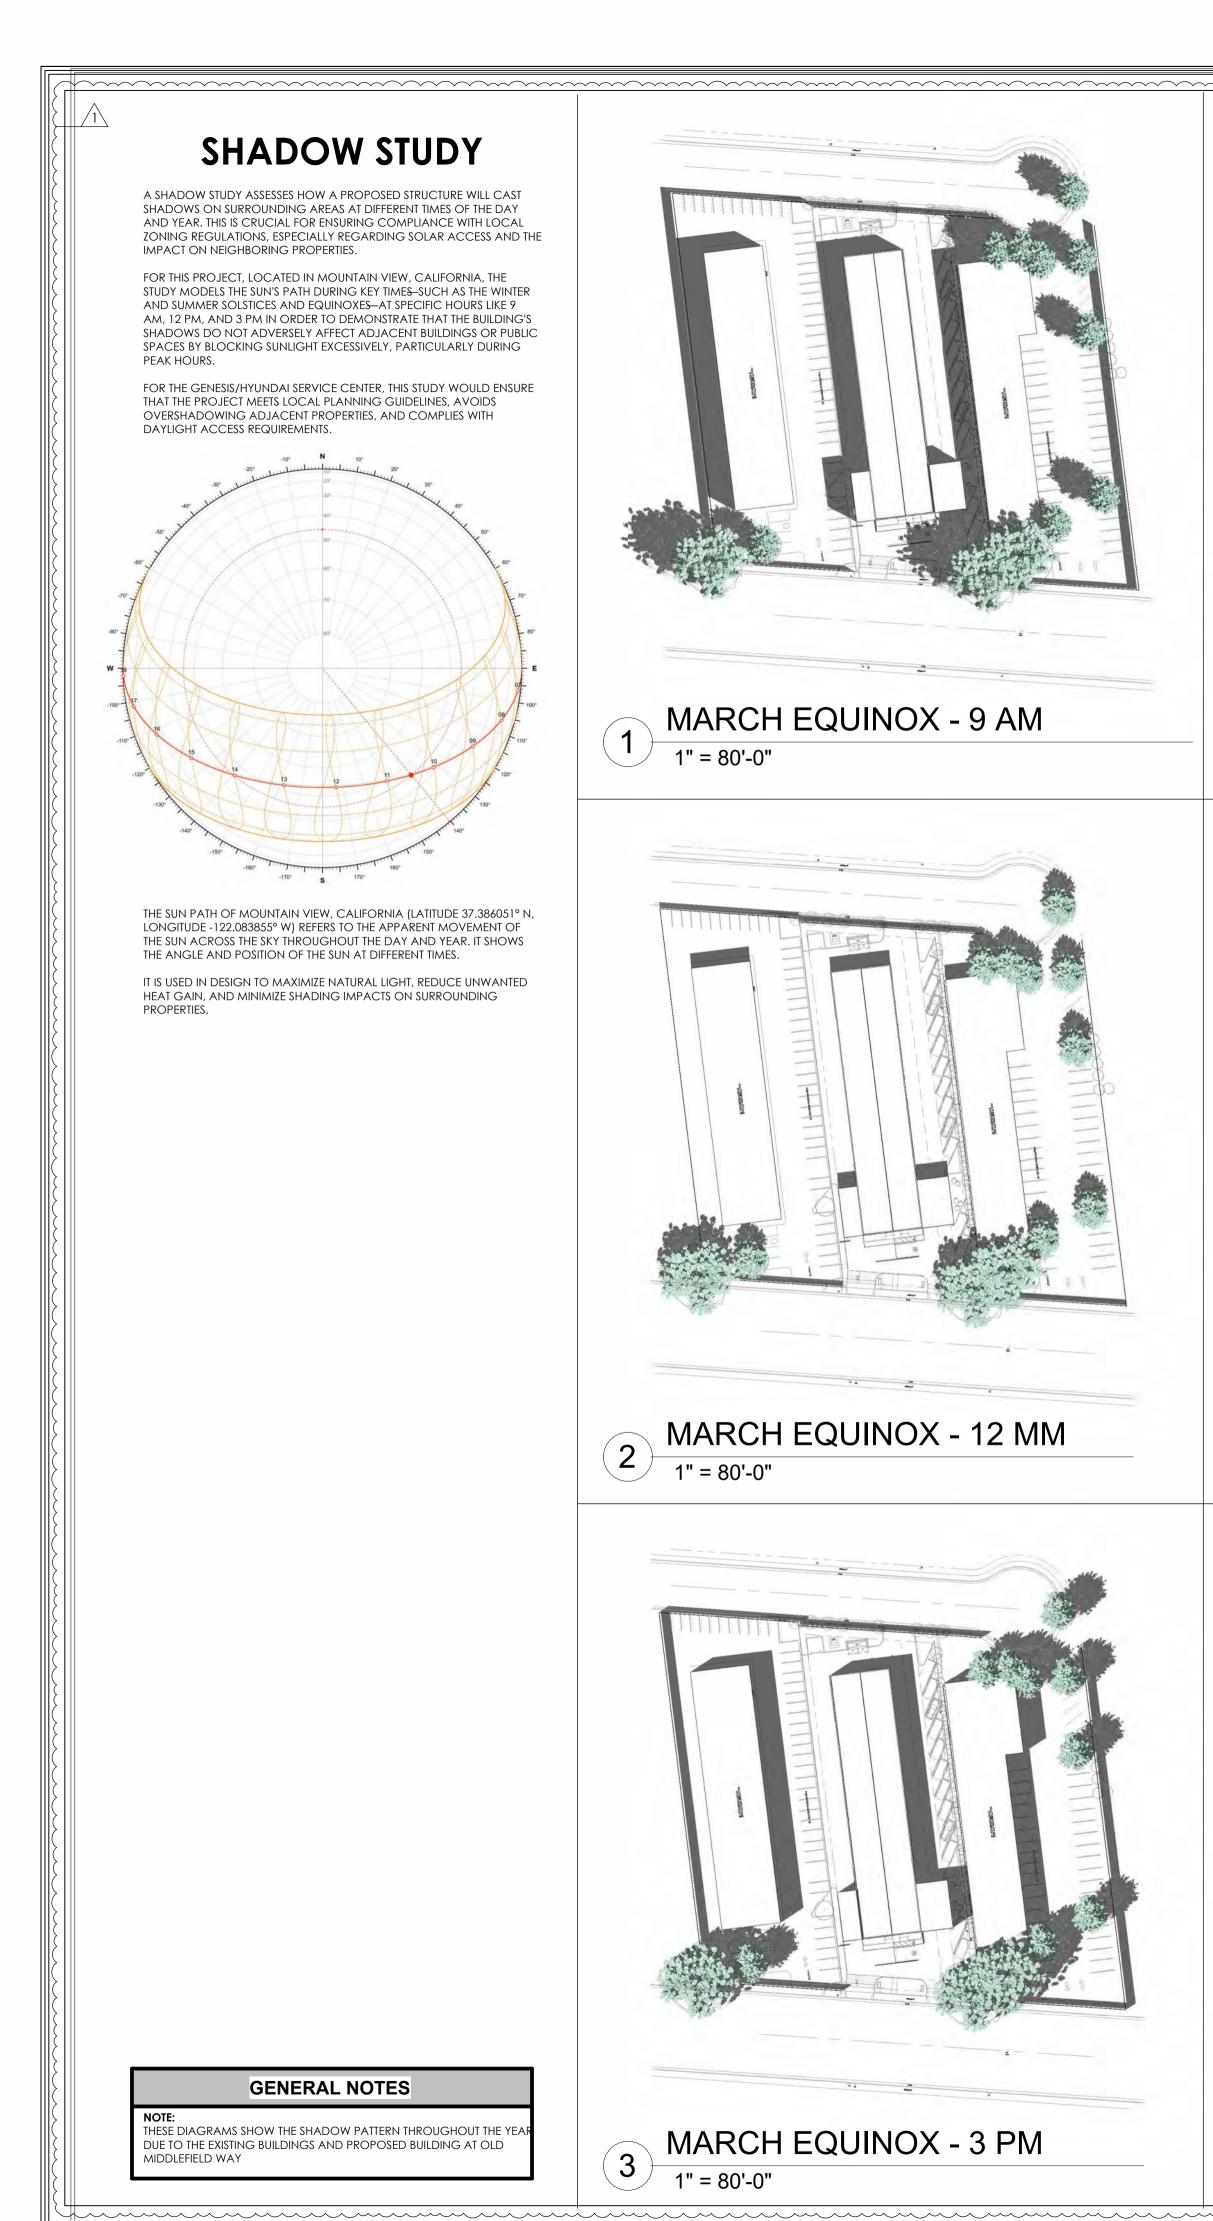




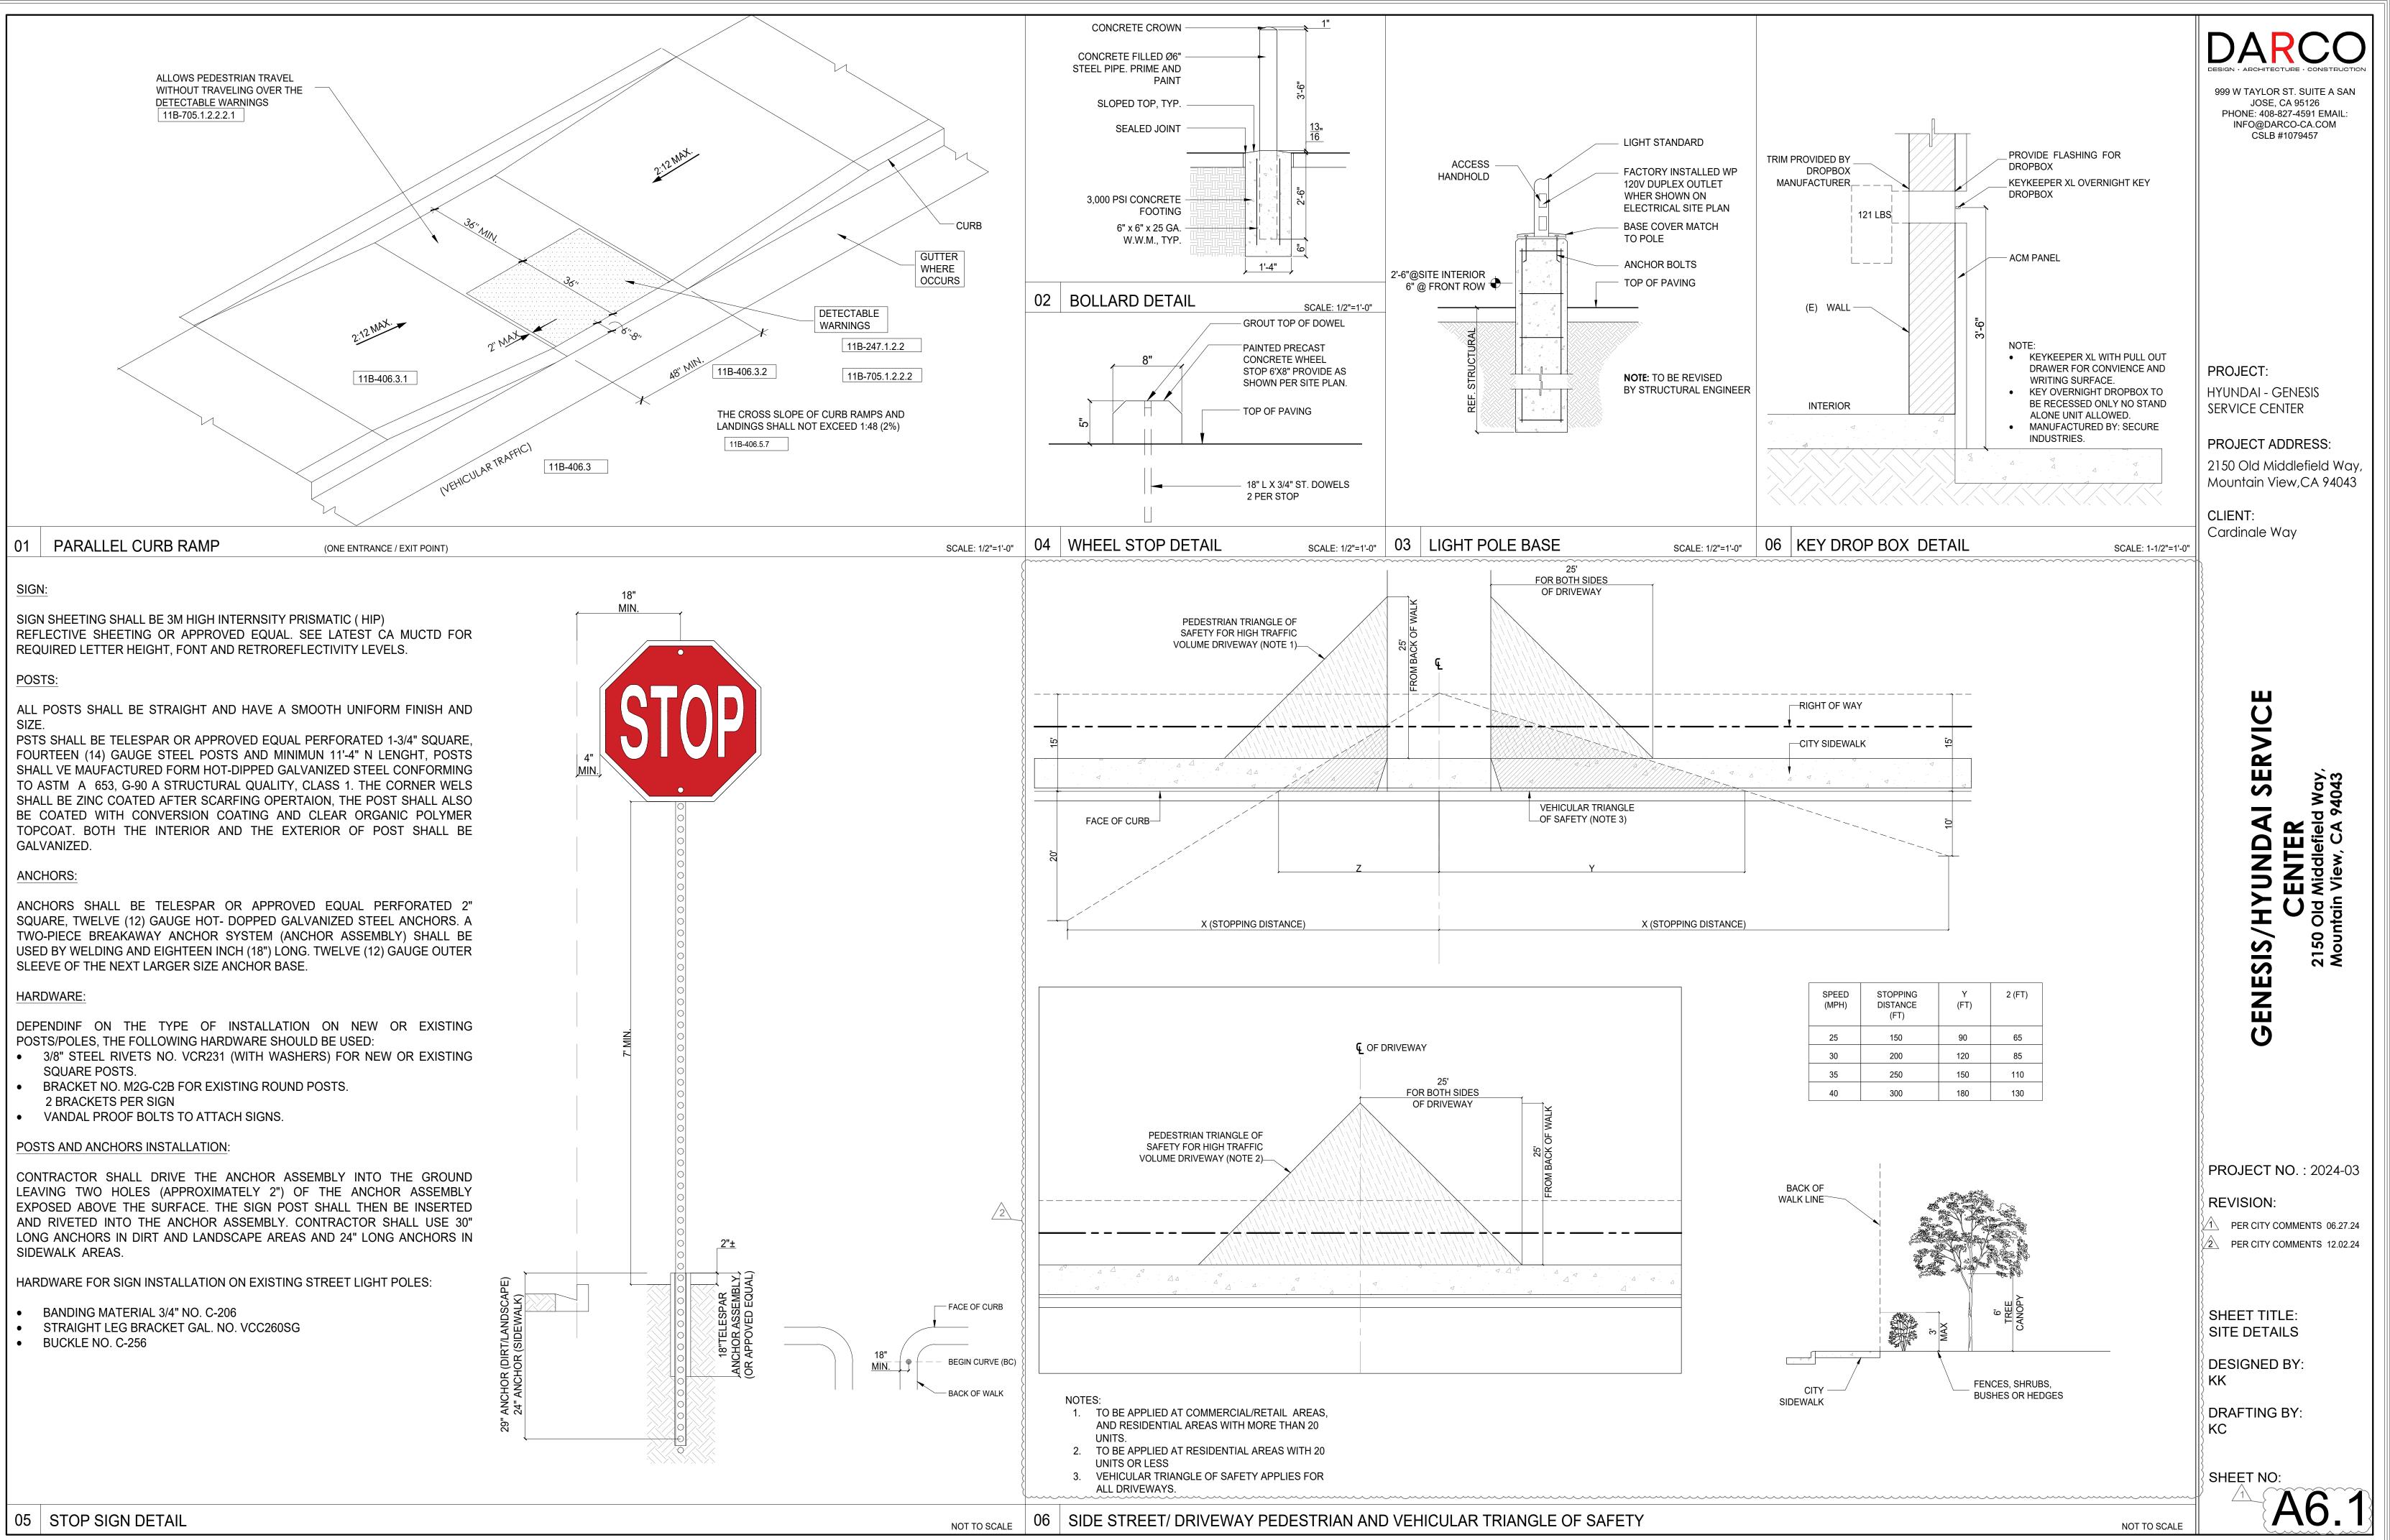

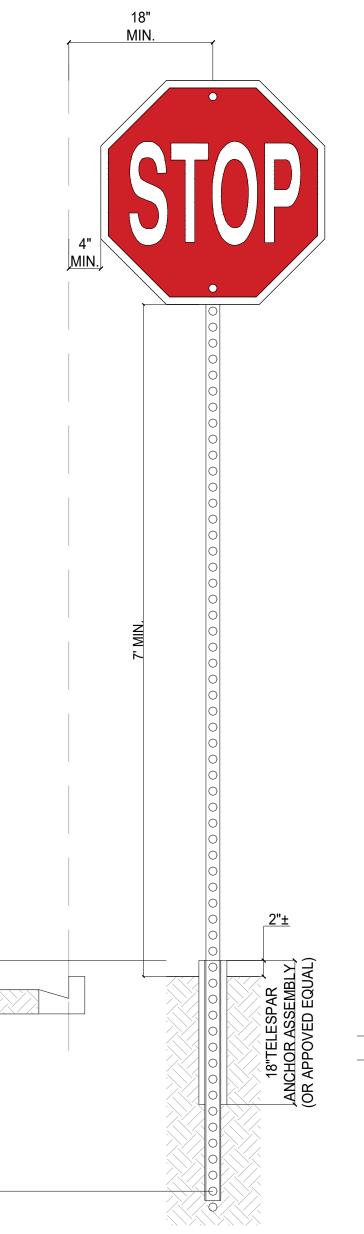

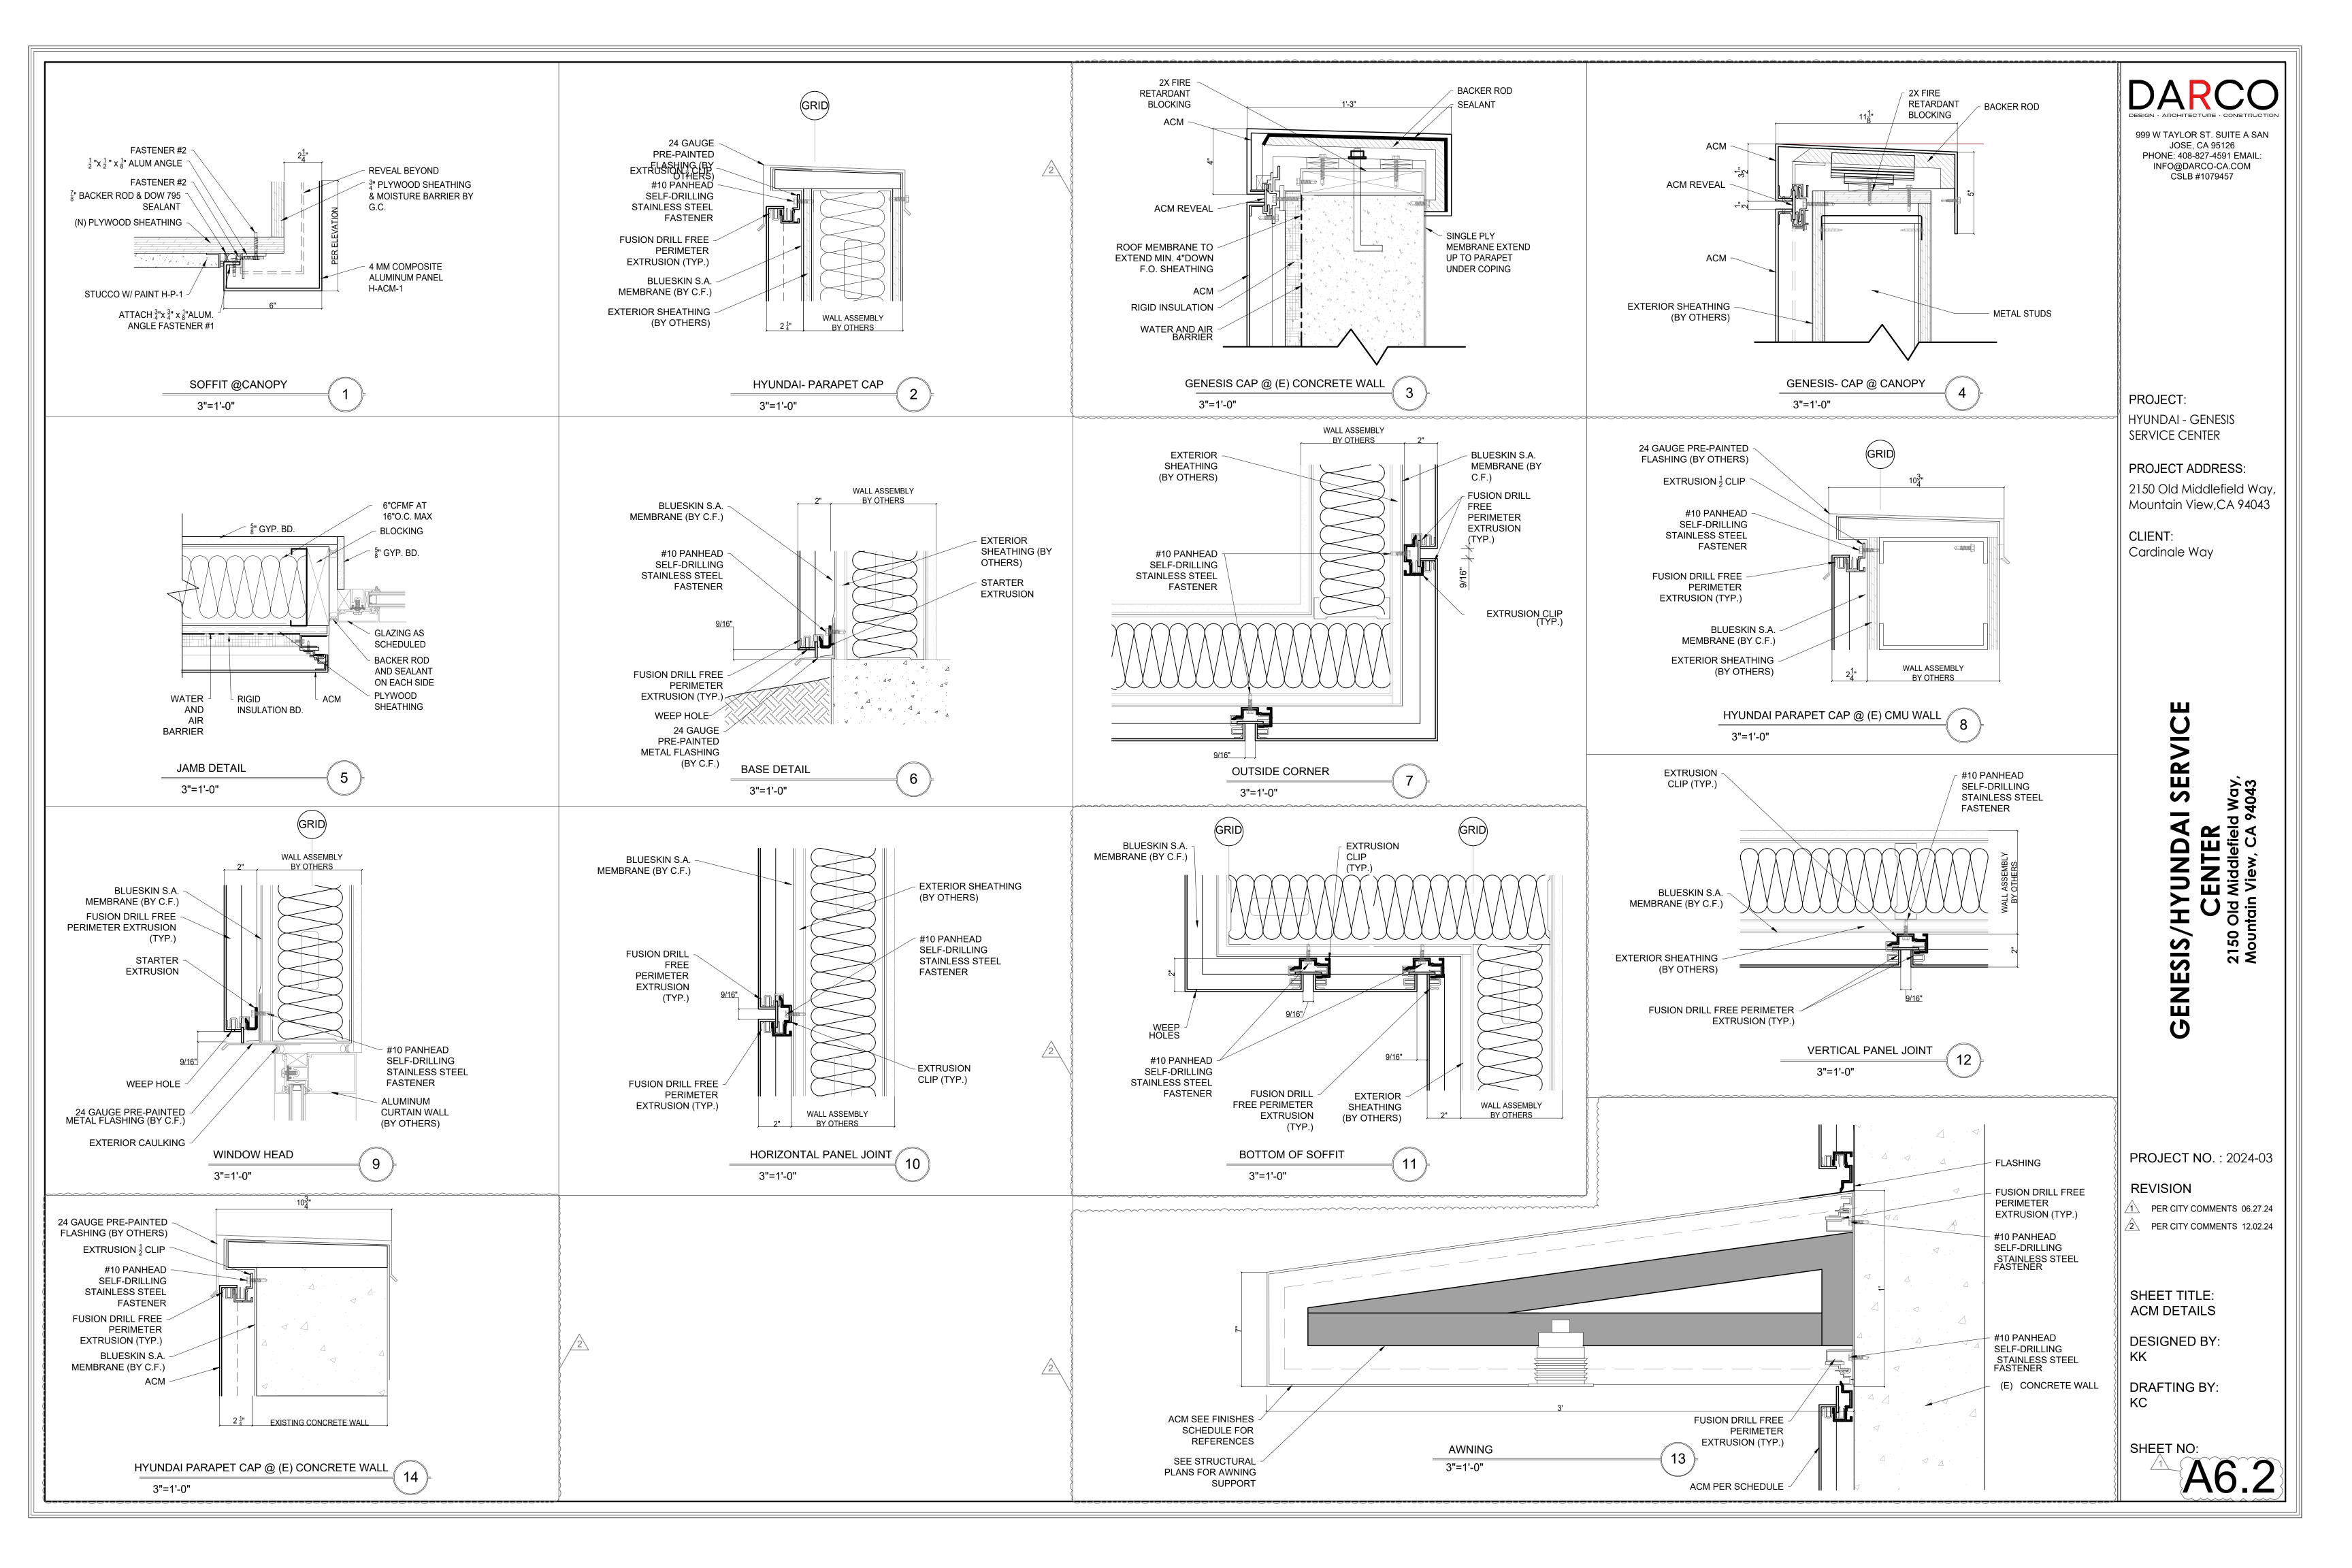

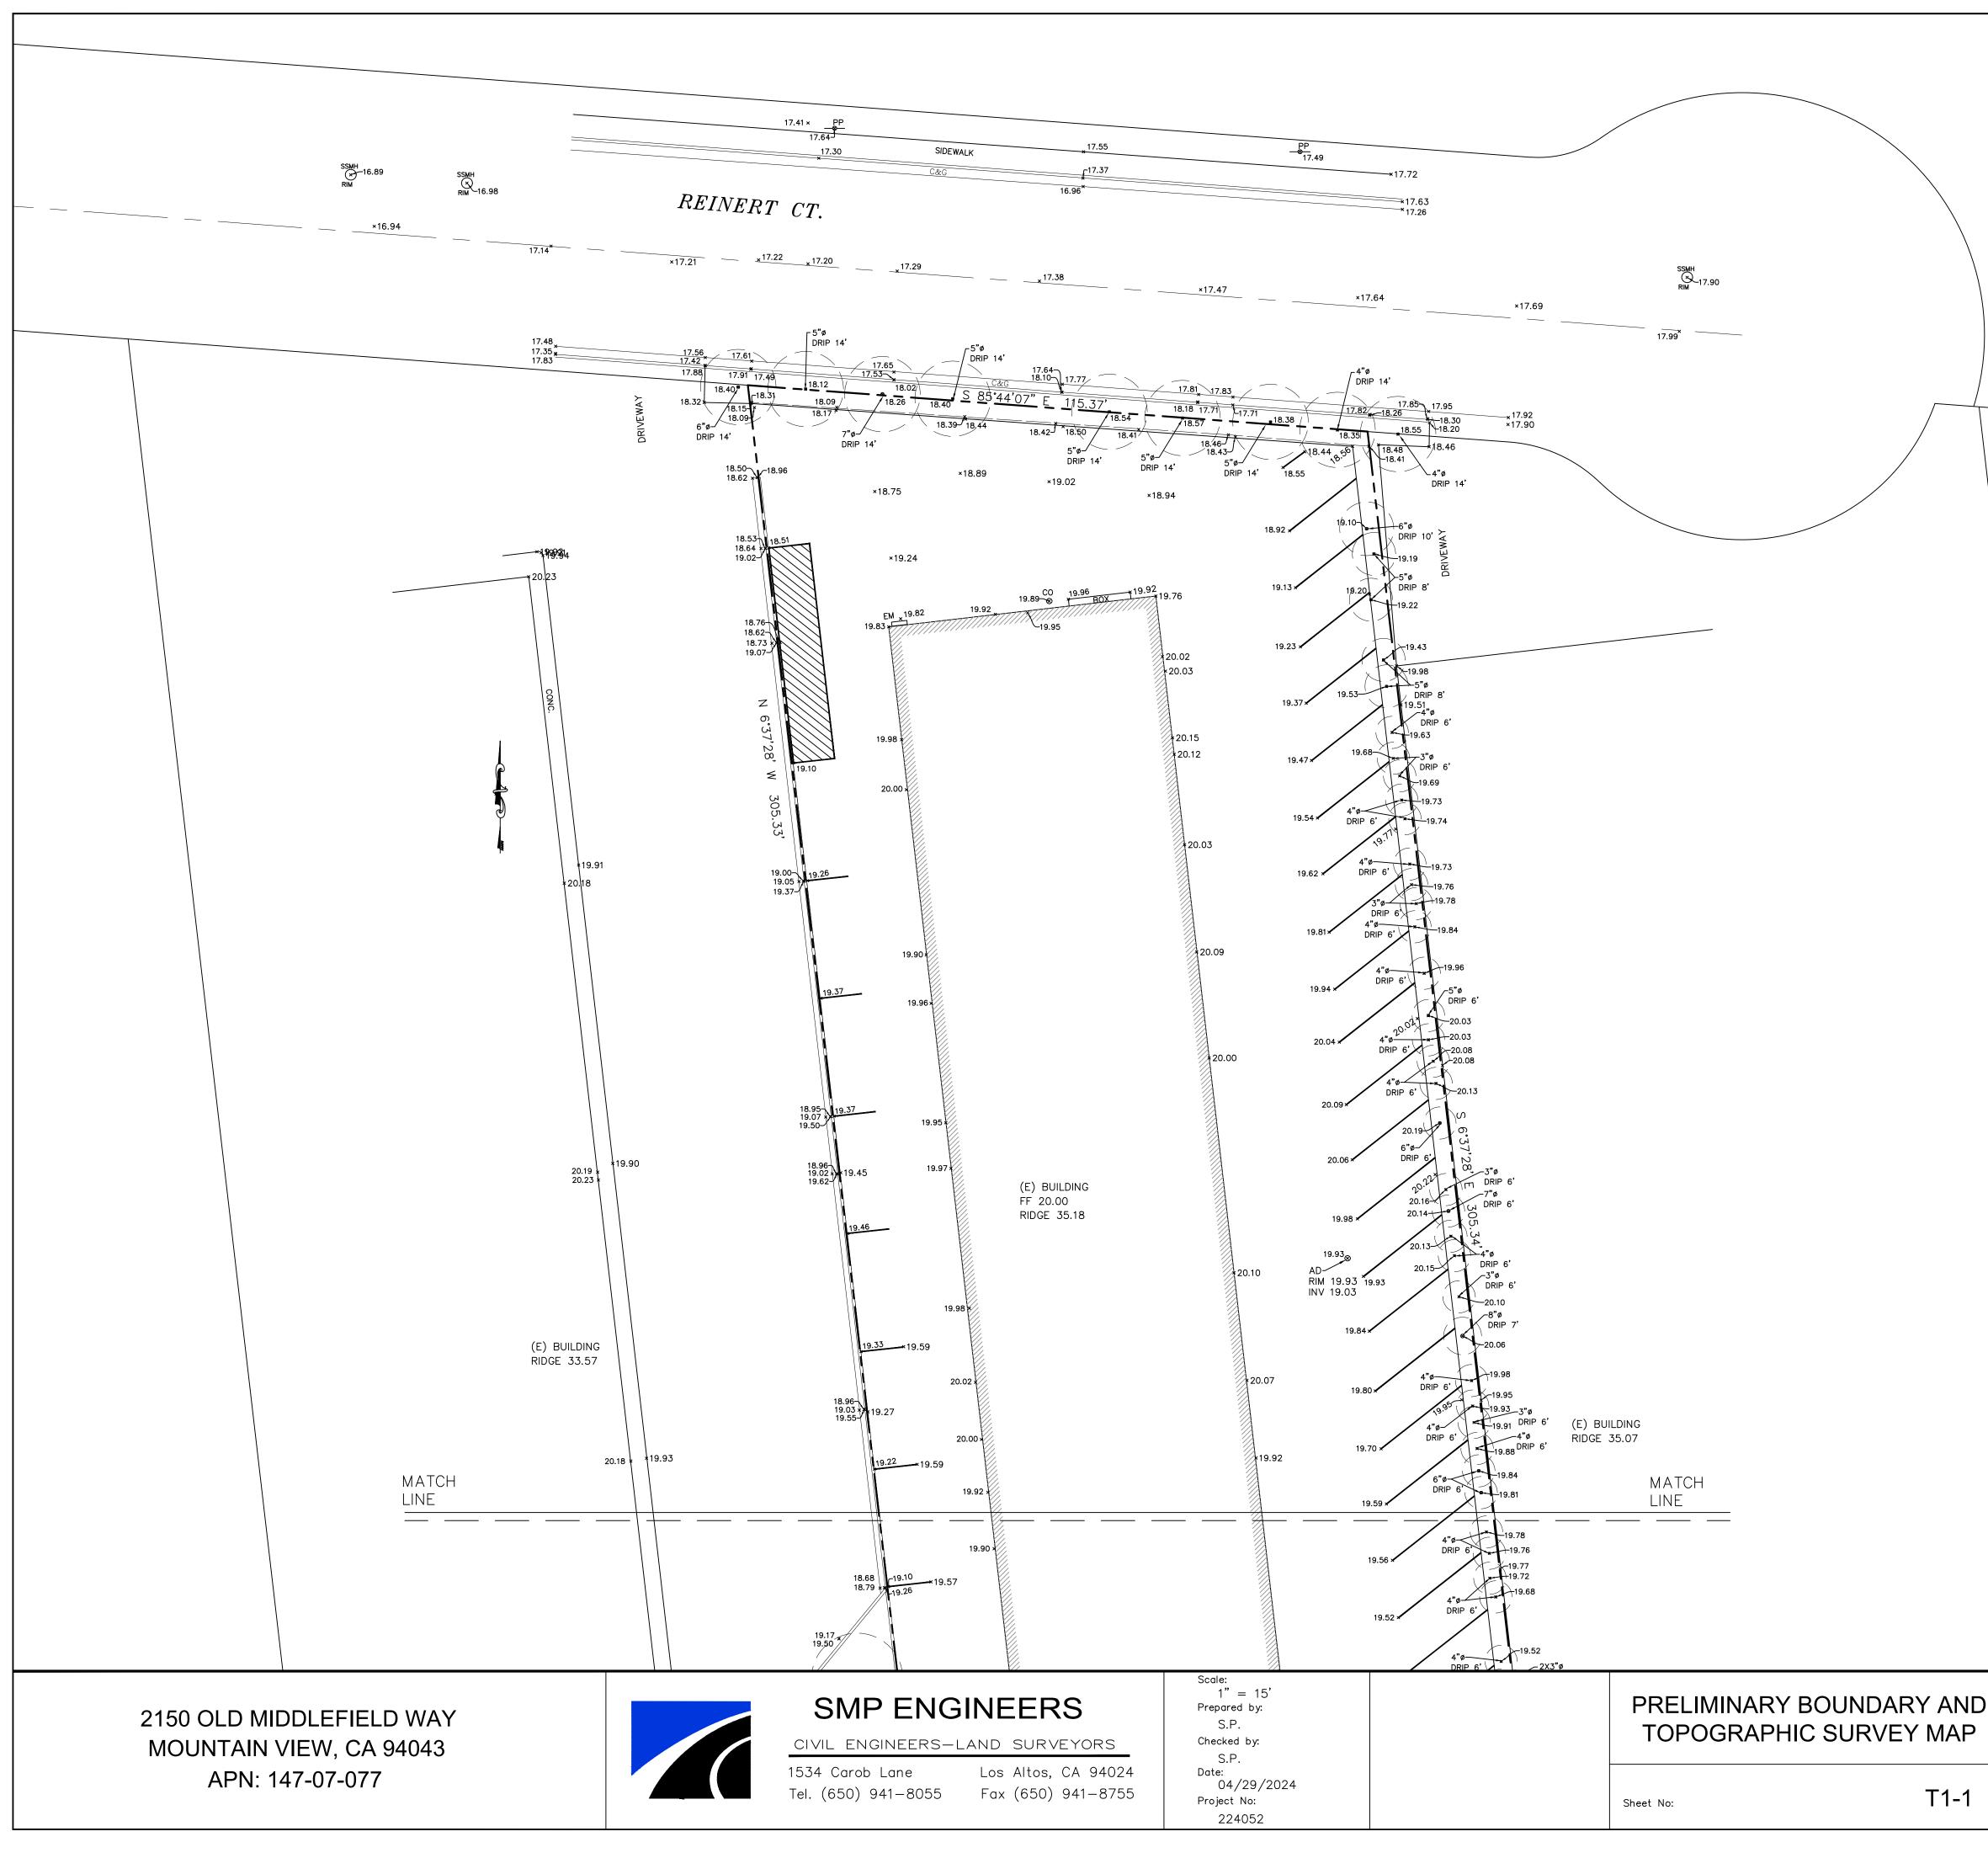

<u>LEGEND</u>

	STREET CENTERLINE
	PROPERTY LINE
	WOOD FENCE
WM	WATER METER
GM	GAS METER
EM	ELECTRIC METER
AD	AD
PP	POWER POLE
CO	SANITARY SEWER CLEANOU
SSMH	SANITARY SEWER MANHOLE
SDMH	STORM DRAINAGE MANHOLE
FH	FIRE HYDRANT
C&G	CURB & GUTTER
\bowtie WV	WATER VALVE

DISCLAIMER:

SMP ENGINEERS OR ITS OFFICERS OR AGENTS SHALL NOT BE RESPONSIBLE FOR THE ACCURACY OR COMPLETENESS OF ELECTRONIC COPIES OF THIS PLAN.

NOTE:

THIS MAP REPRESENTS TOPOGRAPHY OF THE SURFACE FEATURES ONLY. UNLESS SPECIFIED ON THIS MAP, LOCATIONS OF THE UNDERGROUND UTILITIES ARE NEITHER INTENDED NOR IMPLIED. FOR THE LOCATIONS OF UNDERGROUND UTILITIES CALL "USA" (1-800-642-2444). SURFACE FEATURES ARE LOCATED BY MEANS OF A STATION AND OFFSET FROM THE CONTROL LINE.

BASIS OF BEARINGS:

THE BEARING N 85°44'00" W OF THE CENTERLINE OF OLD MIDDLEFIELD WAY, AS SHOWN UPON CERTAIN RECORD OF SURVEY MAP, FILED FOR RECORD IN BOOK 454 OF MAPS, AT PAGE 29, SANTA CLARA COUNTY RECORDS, WAS USED AS THE BASIS OF BEARINGS SHOWN ON THIS MAP


PROJECT BENCHMARK:

REFERENCED CITY OF MOUNTAIN VIEW BM: BM# III-33 EL: 16.152' (NAVD88)


NOTES:

- 1. ALL DIMENSIONS ARE GIVEN IN FEET AND DECIMALS THEREOF.
- 2. THE GROSS AREA OF LAND OF RECORD IS 34,592 SQ. FT. \pm .
- 3. THE MAP WAS BASED ON A GRANT DEED DOC.# 25549973 BY FIRST AMERICAN TITLE CO. DATED 10-26-2023, RECORDED IN SANTA CLARA COUNTY.
- 4. ALL EXISTING BUILDINGS ARE WOOD.
- 5. FOR PRECISE SPECIES OF TREES A CERTIFIED ARBORIST SHALL BE CONSULTED.
- 6. DUE TO THE ABSENCE OF A TITLE REPORT, ANY EASEMENT OF RECORD IS UNDETERMINABLE AND NOT SHOWN AND THE OWNER IS REQUIRED TO PROVIDE THE TITLE REPORT.
- 7. THIS IS A TOPOGRAPHIC MAP, NOT A BOUNDARY SURVEY. LINES SHOWN ARE DERIVED FROM RECORD DATA AND MAY VARY SOMEWHAT FROM ABSOLUTE BOUNDARY LOCATION.

SCALE 1"= 15'

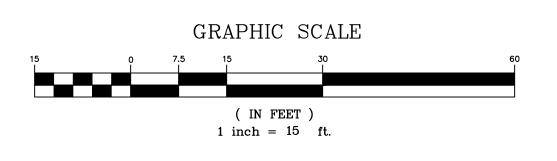

	OUNTAIN VIEW	CITY OF MC				
REVISIONS DESIGN DESIGN CITY APPR. DATE			CITY APPR.	DESIGN BY	REVISIONS	\Diamond

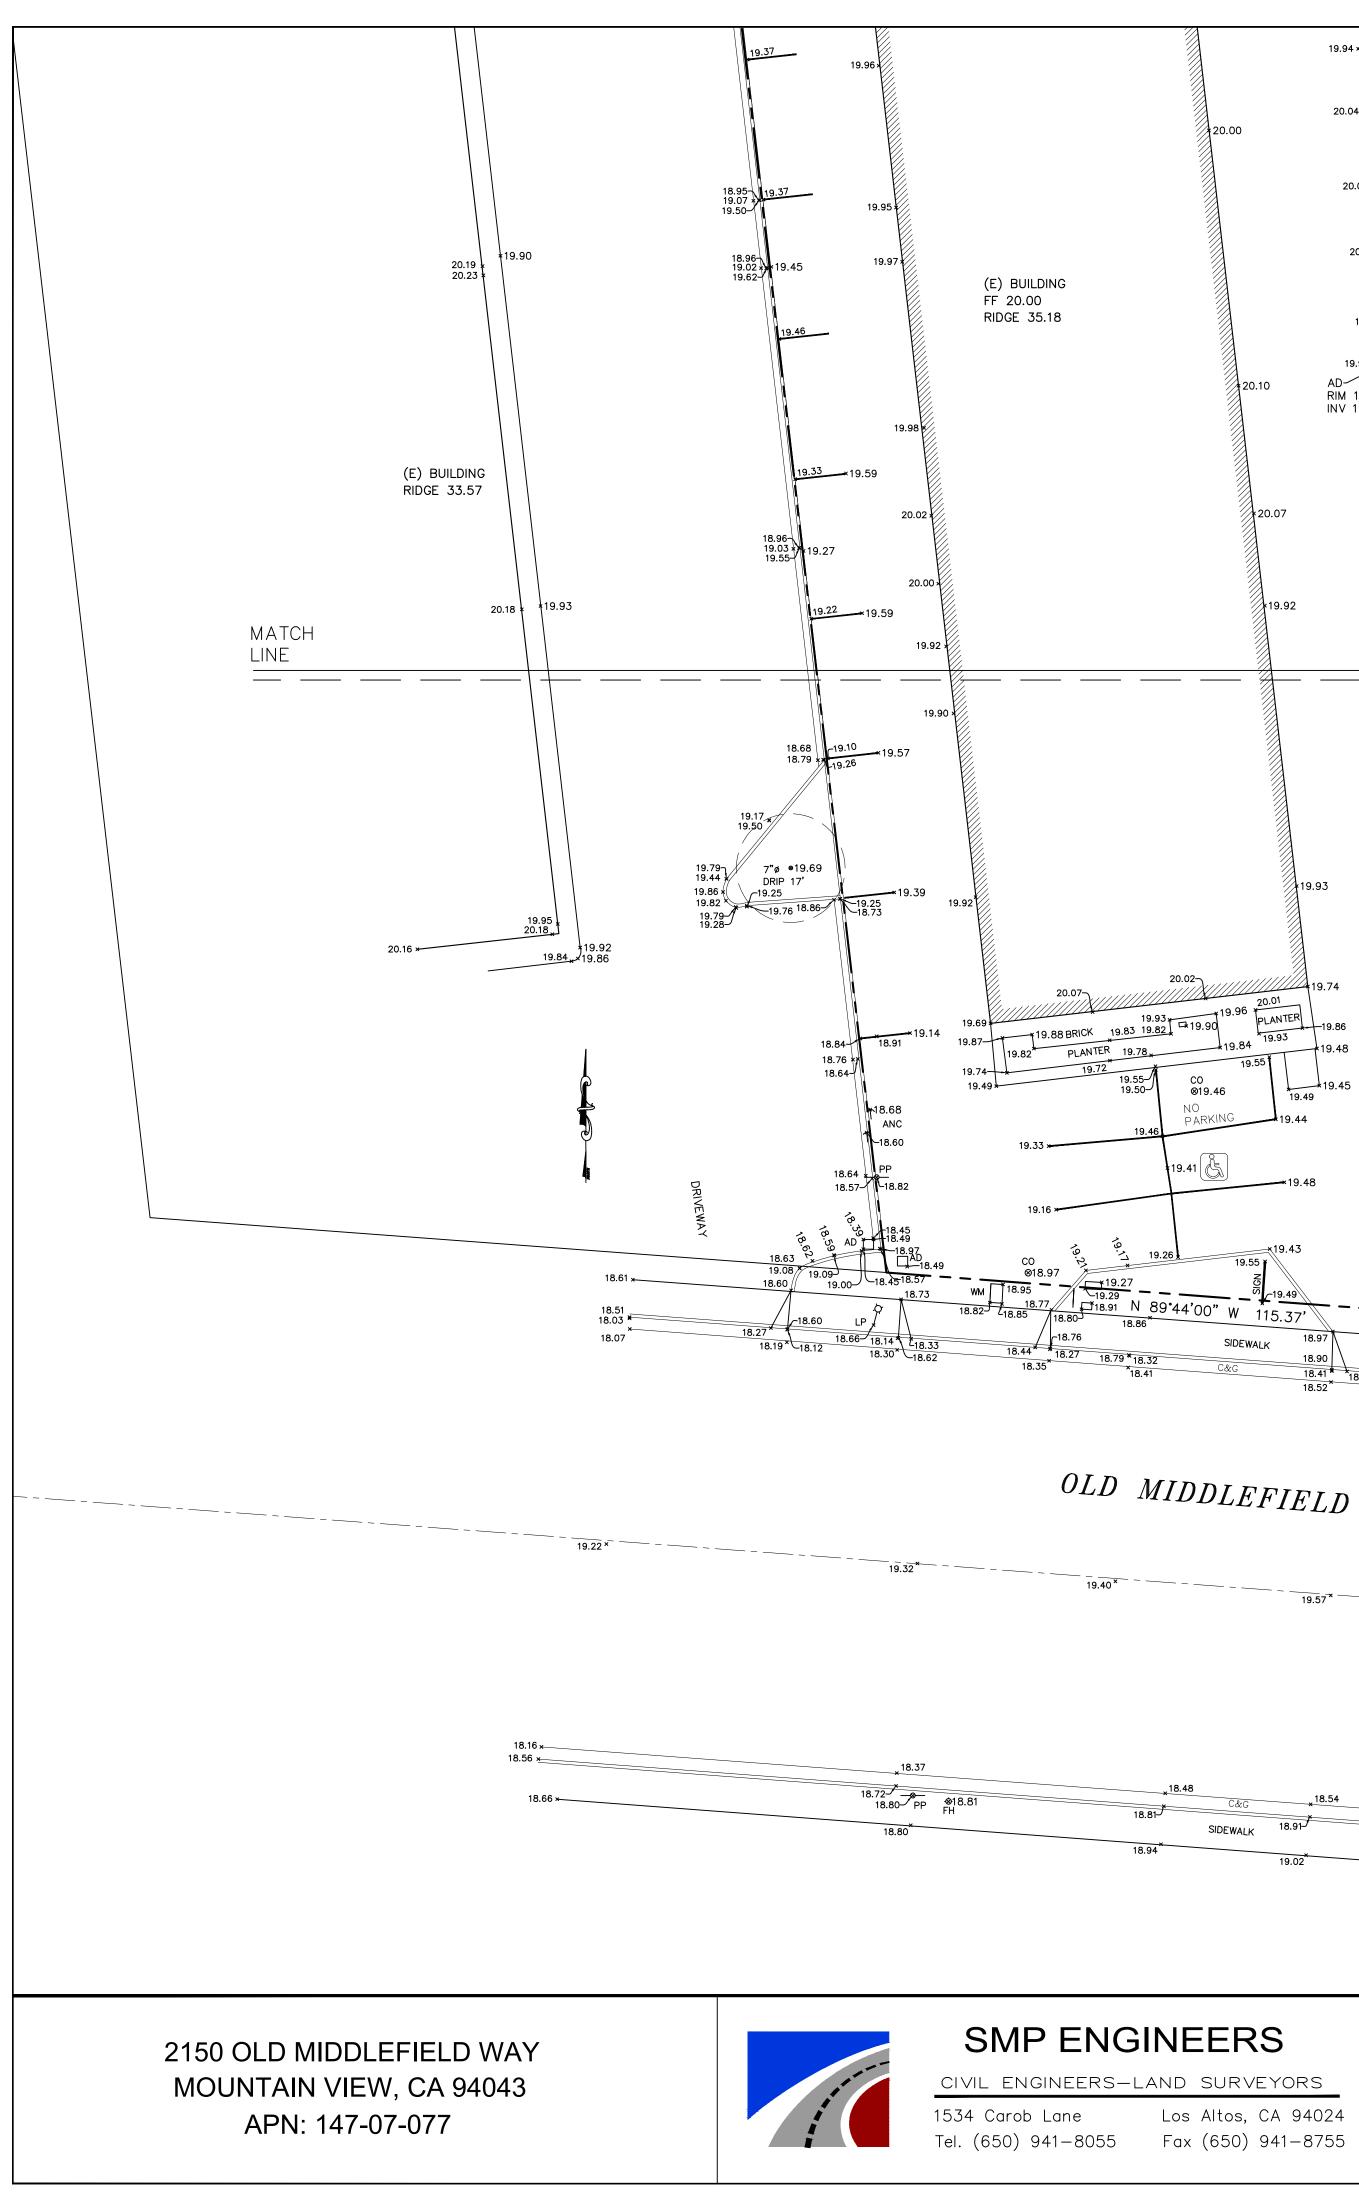

20.00 19.94 20.04 20.04 20.04 20.05 20.09 20.19 20.10 19.88 20.10 00P 6' 19.85 19.95 1	
20.00 19.76 19.56 19.76 19.56 19.76 19.77 19.76 19.78 19.77 19.77 19.77 19.77 19.77 19.78 19.78 19.79 19.74 19.79 19.52 19.79 19.55 19.74 19.48 19.74 19.48 19.74 19.48 19.49 19.45 19.40 19.46 19.43 19.46 19.44 19.47 19.45 19.48 19.46 19.47 19.48 19.48 19.44 19.44 19.45 19.45 19.46 19.47 19.47 19.48 19.48 19.49 19.49 19.47 19.48 19.48 19.49 19.49 19.49 19.49 19.40 19.47 19.43 <th>19.36 19.40 19.25 *18.83</th>	19.36 19.40 19.25 *18.83
MIDDLEFIELD WAY (90' R/W)	
Scale: 1" = 15' 1" = 15' Prepared by: S.P. S.P. Los Altos, CA 94024 Date:	PRELIMINARY BOUNDARY AN TOPOGRAPHIC SURVEY MAP
Fax (650) 941-8755 04/29/2024 Project No: 224052	Sheet No: T1-2

