GENERAL NOTES

- 1. ALL CONSTRUCTION WORK AND ITS FINISHED PRODUCT SHALL CONFORM TO THE LATEST EDITION OF CODES ADOPTED BY LOCAL GOVERNING AGENCIES. THESE SHALL INCLUDE (BUT NOT LIMITED TO) THE APPLICABLE CODES, LAWS, AND REGULATIONS LISTED UNDER 'CODE INFORMATION' ON THIS SHEET, AS WELL AS ALL HEALTH AND SAFETY CODES AND ORDINANCES ADOPTED BY THE LOCAL GOVERNING AGENCIES.
- 2. THE ISSUANCE OF A BUILDING PERMIT SHALL NOT NOT BE CONSTRUED AS A GUARANTEE THAT ALL CODE REQUIREMENTS ARE REFLECTED IN THE DOCUMENTS. NO GUARANTEE OF CONSTRUCTION QUALITY IS IMPLIED OR INTENDED BY THIS ARCHITECTURAL DOCUMENTS. THE GENERAL CONTRACTOR SHALL BE ULTIMATELY RESPONSIBLE FOR ALL CONSTRUCTION PROCESS.
- B. BUILDER SET DEFINITION: THESE PLANS ARE A "BUILDER SET", IT CONTAINS INFORMATION FOR BUILDING PERMIT AND GENERAL CONSTRUCTION PURPOSES ONLY. THEY ARE NOT EXHAUSTIVELY DETAILED NOR ARE FULLY SPECIFIED. THIS HAVE BEEN PRODUCED FOR THE USE OF A KNOWLEDGEABLE AND EXPERIENCED CONTRACTOR, IT IS THE RESPONSIBILITY OF THE CONTRACTOR TO VERIFY, SELECT, SOLVE, AND INSTALL ALL MATERIALS & EQUIPMENT
- 4. BY EXECUTING CONTRACTS, PRIOR TO COMMENCING ANY WORK OR ORDERING ANY MATERIAL, CONTRACTOR REPRESENT THAT THEY HAVE:
- 4.1. VERIFIED EXISTING JOB SITE CONDITIONS AND SURROUNDINGS. LOCATIONS OF ALL UTILITY LINES, CONDUITS, SURFACE OR SUBSURFACE STRUCTURES, ETC. AND OF ANY NATURE THAT MAY BE AFFECTED BY THE WORK AND MADE DUE ALLOWANCES FOR DIFFICULTIES.
- 4.2. CONTRACTOR TO VERIFY ALL MEASUREMENTS SHOWN ON THESE DRAWINGS WHICH SUPERCEDES SCALE OF DRAWINGS.
- 5. THE CONTRACTOR SHALL IMMEDIATELY NOTIFY THE ARCHITECT, ENGINEER OR OWNER OF ANY DISCREPANCIES THEY DISCOVER WITHIN THE DRAWINGS AND EXISTING FIELD CONDITION PRIOR TO CONTINUE THE WORK. IF CONTRACTOR CHOOSE TO CONTINUE WITHOUT ARCHITECT/ENGINEER CLARIFICATION/ INSTRUCTION, THE CONTRACTOR SHALL BE SOLELY RESPONSIBLE FOR THE
- . THE CONTRACTOR SHALL HOLD HARMLESS, INDEMNIFY AND DEFEND THE ARCHITECT AND HIS/HER CONSULTANTS FROM ANY ACTION INITIATED BY THE OWNER OR ANY SUBSEQUENT OWNERS FOR CONSTRUCTION DEFICIENCIES, MODIFICATIONS OR SUCH CONDITIONS WHICH MAY BE BEYOND THE CONTROL OF THE ARCHITECT AND ITS ASSOCIATES CONSULTANT.
- . CONTRACTOR SHALL ACCEPT AND MAINTAIN THE EXISTING SITE SURROUNDING, CONDITION. AND PROTECT NEW AND EXISTING WORK, EQUIPMENT, MATERIALS. DAMAGES CAUSED BY CONTRACTOR NEGLECTNESS, SHALL BE REPAIRED, REPLACE AS GOOD CONDITON AS BEFORE, AT THE
- EXPENSE OF THE CONTRACTOR. . THE ARCHITECT SHALL NOT BE OBSERVING THE CONSTRUCTION OF THIS PROJECT. THE CONTRACTOR IS RESPONSIBLE FOR SAFETY, SECURITY, QIALITY CONTROL AND CONSTRUCTION STANDARDS FOR THIS PROJECT.
- DEMOLITION SHALL BE DONE IN A SAFE, ORDERLY MANNER WITHOUT DAMAGING TO OTHER PARTS OF THE PREMISES OR ADJACENT PROPERTIES. ALL DEMOLISHED/REMOVED ITEMS SHALL BE DISPOSED OFF BY THE CONTRACTOR PER CITY/ COUNTY CONSTRUCTION & DEMOLITION WASTE MANAGEMENT ORDINANCE, AND VERIFY WITH THE OWNER ON ITEMS TO BE SAVED AND STORED. ALL REMOVED ITEMS TO BE SAVED FOR REUSE SHALL BE

PROJECT DATA

A.P.N. NO 158-30-047 ZONING R-1 OCCUPANCY GROUP R3-U TYPE OF CONSTRUCTION V-B 5,000 S.F. LOT AREA

LOT COVERAGE (908 + 640 + 54 + 178) / 5,000 SF x 100%

F.A.R. (MAX) 45% x 5,000 S.F. = 2,250 S.F

1,722 / 5,000 x 100% = 34.44 %

A. HABITABLE AREA: (E) HABITABLE AREA TO REMAIN : 1,125 S.F. (N) UPPER FL. AREA 415 S.F. (N) LOWER FL. AREA 708 S.F. : 2,248 S.F. TOTAL AREA

F.A.R. (PROPOSED)

B. NON HABITABLE AREA: 54 S.F. (E) PORCH (E) DETACHED GARAGE 182 S.F.

FIRE SPRINKLER NOT INSTALLED

SCOPE OF WORK:

NEW ADDITION TO THE (E) 1 STORY HOUSE. CREATE NEW BASEMENT AND UPPER FLOOR AREA TO ADD NEW BEDROOMS AND BATHROOMS. TOTAL WILL BE 5 BEDROOMS AND 3 BATHROOMS AFTER THE ADDITION AND REMODEL.

APPLIED CODES

2022 CALIFORNIA BUILDING CODE

HANDLED WITH CARE.

2022 CALIFORNIA RESIDENTIAL CODE (CRC)

2022 CALIFORNIA ELECTRICAL CODE 2022 CALIFORNIA MECHANICAL CODE

2022 CALIFORNIA PLUMBING CODE 2022 CALIFORNIA ENERGY CODE

2022 CALIFORNIA GREEN BUILDING STANDARDS CODE

2022 CALIFORNIA FIRE CODE

ALONG WITH ANY OTHER APPLICABLE LOCAL AND STATE LAWS AND REGULATIONS, CITY OF MOUNTAIN VIEW ORDINANCE AND STANDARDS

ALL CONSTRUCTION ACTIVITIES SHALL BE LIMITED TO THE MON - FRI

: 7.00 AM - 5.30 PM


9.00 AM - 3.00 PM SUNDAYS & HOLIDAYS: NO CONSTRUCTION ACTIVITIES ALLOWED

> ALL CONTRACTORS, SUBCONTRACTORS, AND VENDORS SHALL BE LICENSED TO DO BUSINESS IN THE CITY OF MOUNTAIN VIEW

SHEET INDEX

- A 1 COVER SHEET, SITE PLAN + NOTES
- A 1-1 2022 CALGREEN CHECKLIST A 1-2 2022 CALGREEN CHECKLIST
- A 1-3 CLEAN BAY BLUEPRINT
- A 2 EXISTING FLOOR & ROOF PLANS A 3-1 PROPOSED UPPER FLOOR PLAN
- A 3-2 PROPOSED LOWER FLOOR PLAN
- A 4 PROPOSED ROOF PLAN + SECTION
- A 5 ELEVATIONS A 6 ELEVATIONS
- A 7 ELEVATIONS A 8 PROPOSED RCP + ME PLANS
- A 9 ARCHITECTURAL STANDARD DETAILS
- EN 1 TITLE 24 REPORTS
- EN 2 TITLE 24 REPORTS
- T 1 BOUNDARY SURVEY C 1 GRADING & DRAINAGE PLAN
- S 1 GENERAL NOTES S 2 FOUNDATION + FLOOR FRAMING PLAN
- S 3 ROOF FRAMING PLAN
- S 4 STRUCTURAL DETAILS S 5 STRUCTURAL DETAILS
- S 6 STRUCTURAL DETAILS

VICINITY MAP

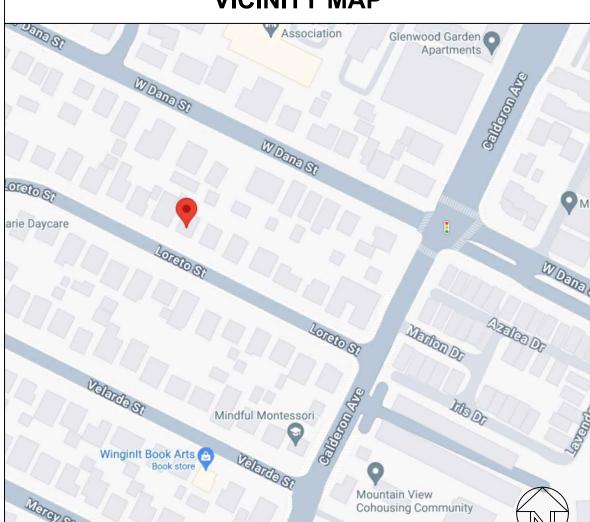

PROJECT TEAM

- ALEXANDER ANGKAWIJAYA AA HOME DESIGN & BUILD LLC 372 PARAISO DR., DANVILLE, CA 94526
- 408-431-2952 AA.HOMEDESIGNBUILD@GMAIL.COM

STRUCTURE ENGINEER:

- DAN L. CHEN S.E. 47849 MASTERS CT, FREMONT CA 94539 510-579-8230
- DAN_CHEN@COMCAST.NET
- TITLE 24/ MECHANICAL DESIGN: CARSTAIRS ENERGY P.O. BOX 4736
- SAN LUIS OBISPO, CA 93403 805-904-9048


TITLE24@YAHOO.COM

ANY ALTERATIONS, ADDITIONS OR IMPROVEMENT SHALL REQUIRE ALL NON-COMPLIANT PLUMBING FIXTURES TO BE REPLACED WITH WATER-CONSERVING PLUMBING FIXTURES. NON-COMPLIANT FIXTURES SHALL BE REPLACED PRIOR TO FINAL PERMIT APPROVAL OR ISSUANCE OF CERTIFICATE OF OCCUPANCY BY THE CITY (SB 407)

SINGLE FAMILY RESIDENCE

302 LORETO ST.

MOUNTAIN VIEW, CA 94041

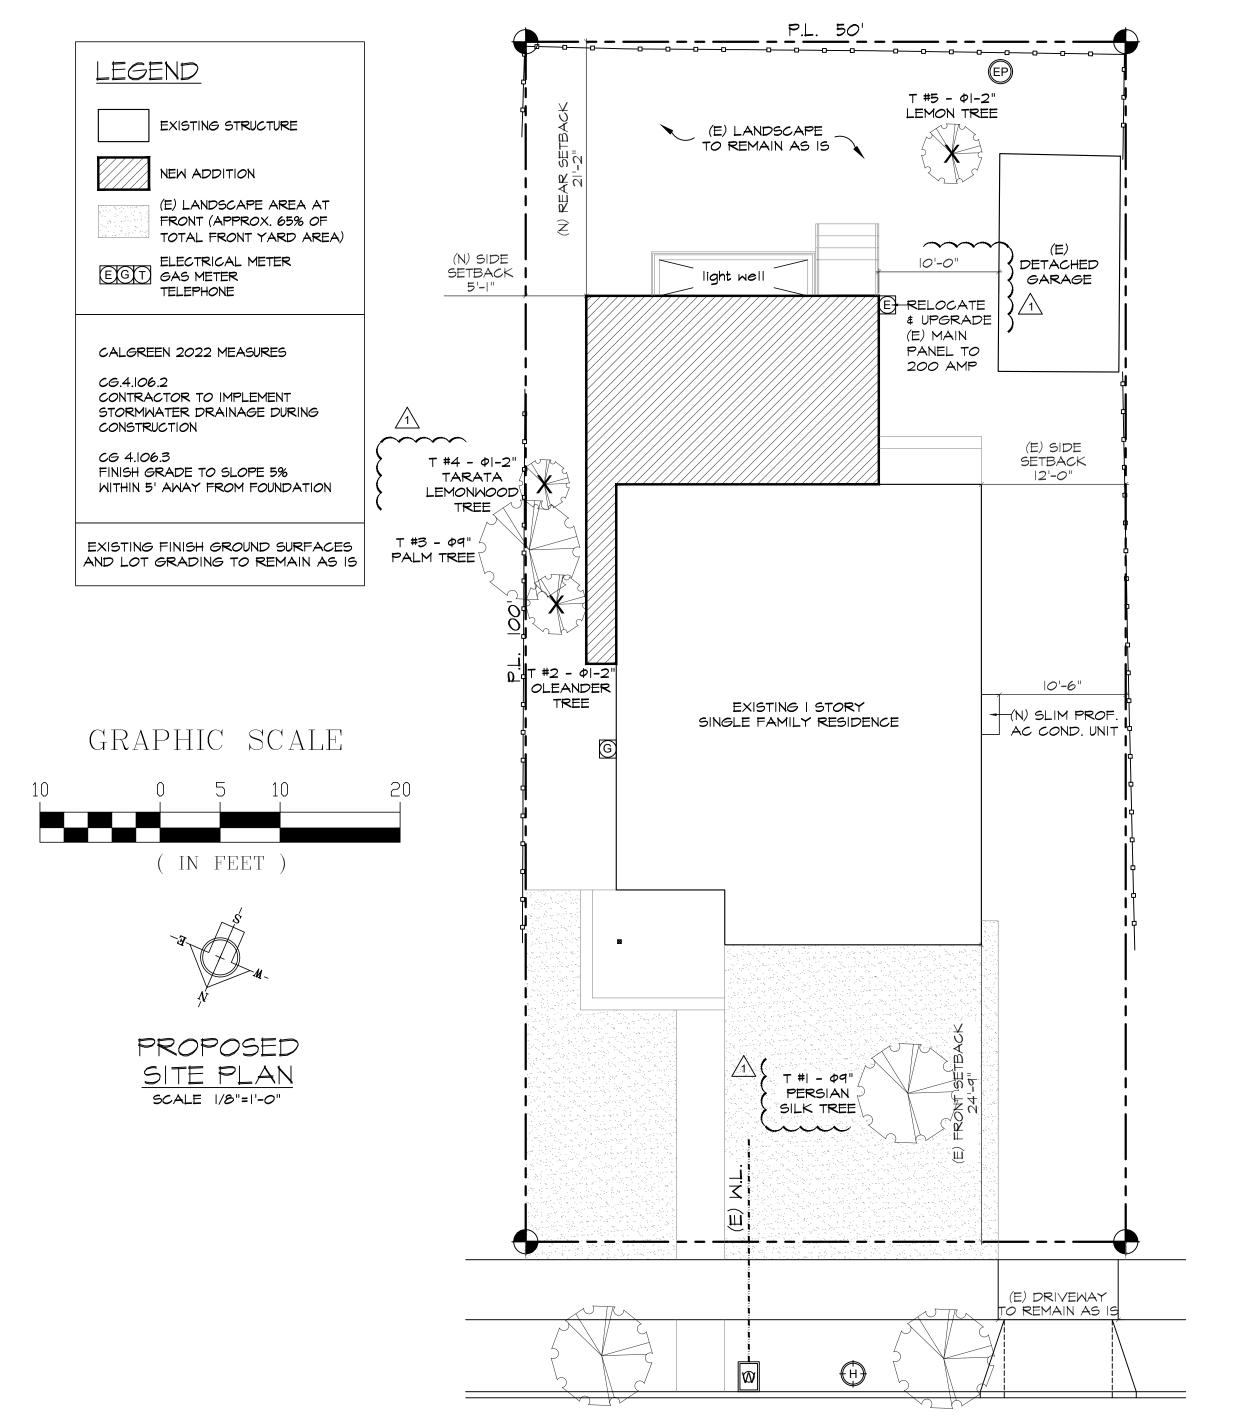

LORETO ST.

CALIFORNIA

Explore damage prevention information, local contacts and rules for safe digging in California.



USA North 811 811 or 800-642-2444 Visit Website



Visit Website

Underground Service Alert Of Southern California 811 or 800-422-4133

Andreas & Cherylle

SINGLE **FAMILY** HOUSE

302 LORETO ST., MOUNTAIN VIEW, CA PROJECT

> ADDITION/ REMODEL




COVER SHEET, SITE PLAN + NOTES

1 1C PC COM RES - 02.02.25

03.24.24

AS SHOWN SCALE SHEET

owner
Andreas &
Cherylle

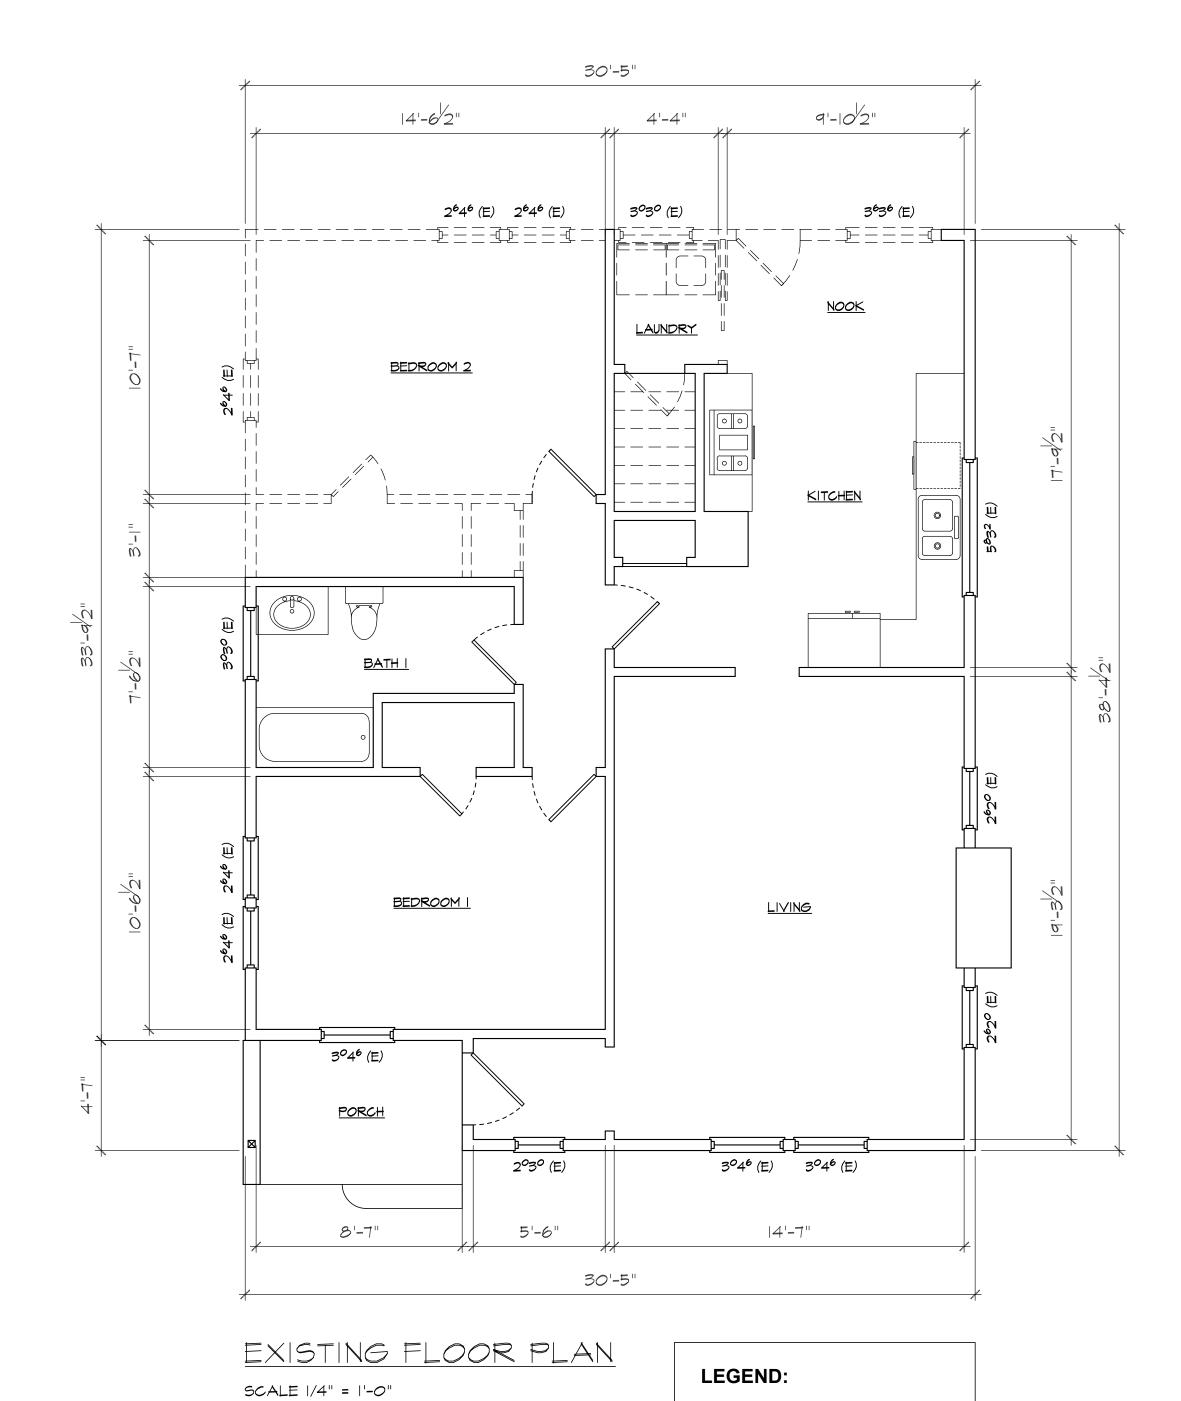


(E) WALL & WINDOW TO REMAIN

———— (E) WALL & WINDOW
———— TO TO BE REMOVED

-Z - - 5/2"



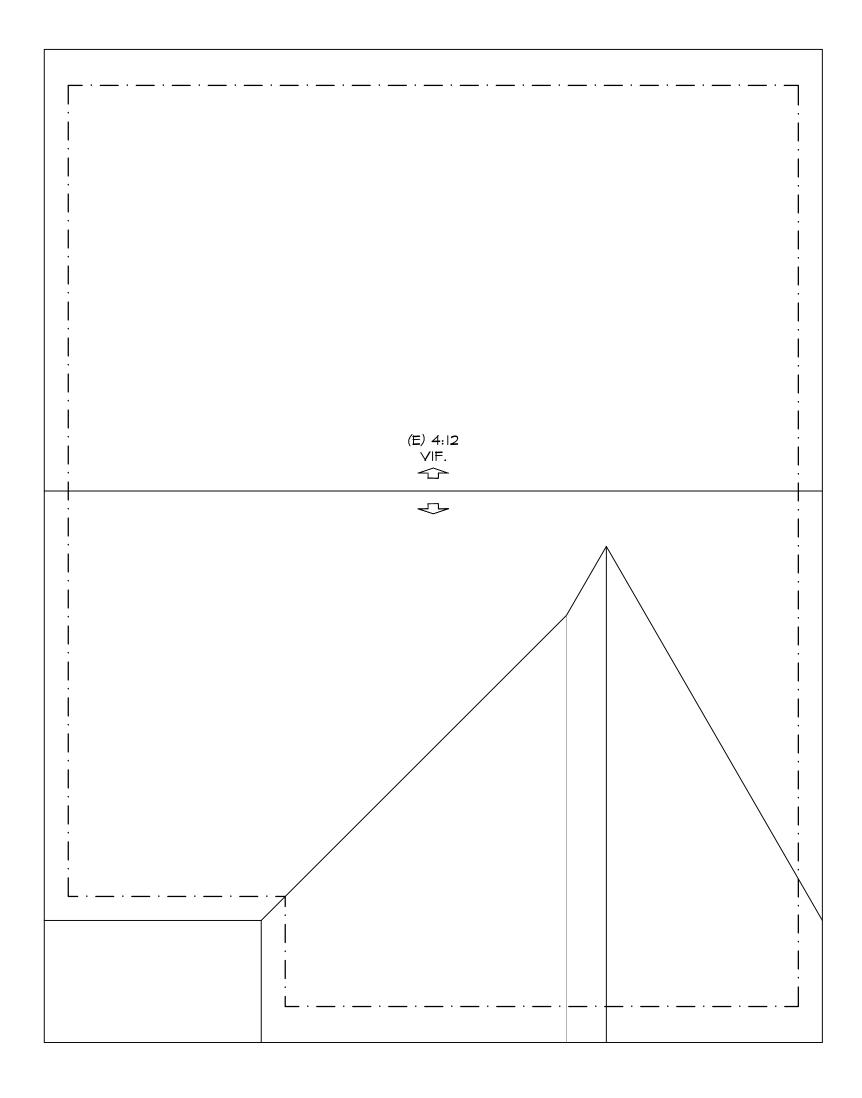

EXISTING ROOF PLAN

SCALE 1/4" = 1'-0"

SINGLE FAMILY HOUSE

302 LORETO ST.,
MOUNTAIN VIEW, CA
94041
PROJECT

ADDITION/

REMODEL

BETTER BUILT BUILDERS

SHEET TITLE

EXISTING FLOOR & ROOF PLANS


REVISION

1C PC COM RES - 02.02.25


DATE 03.24.24 DRAWN

SCALE AS SHOWN
SHEET

A-2
OF 16 SHEETS

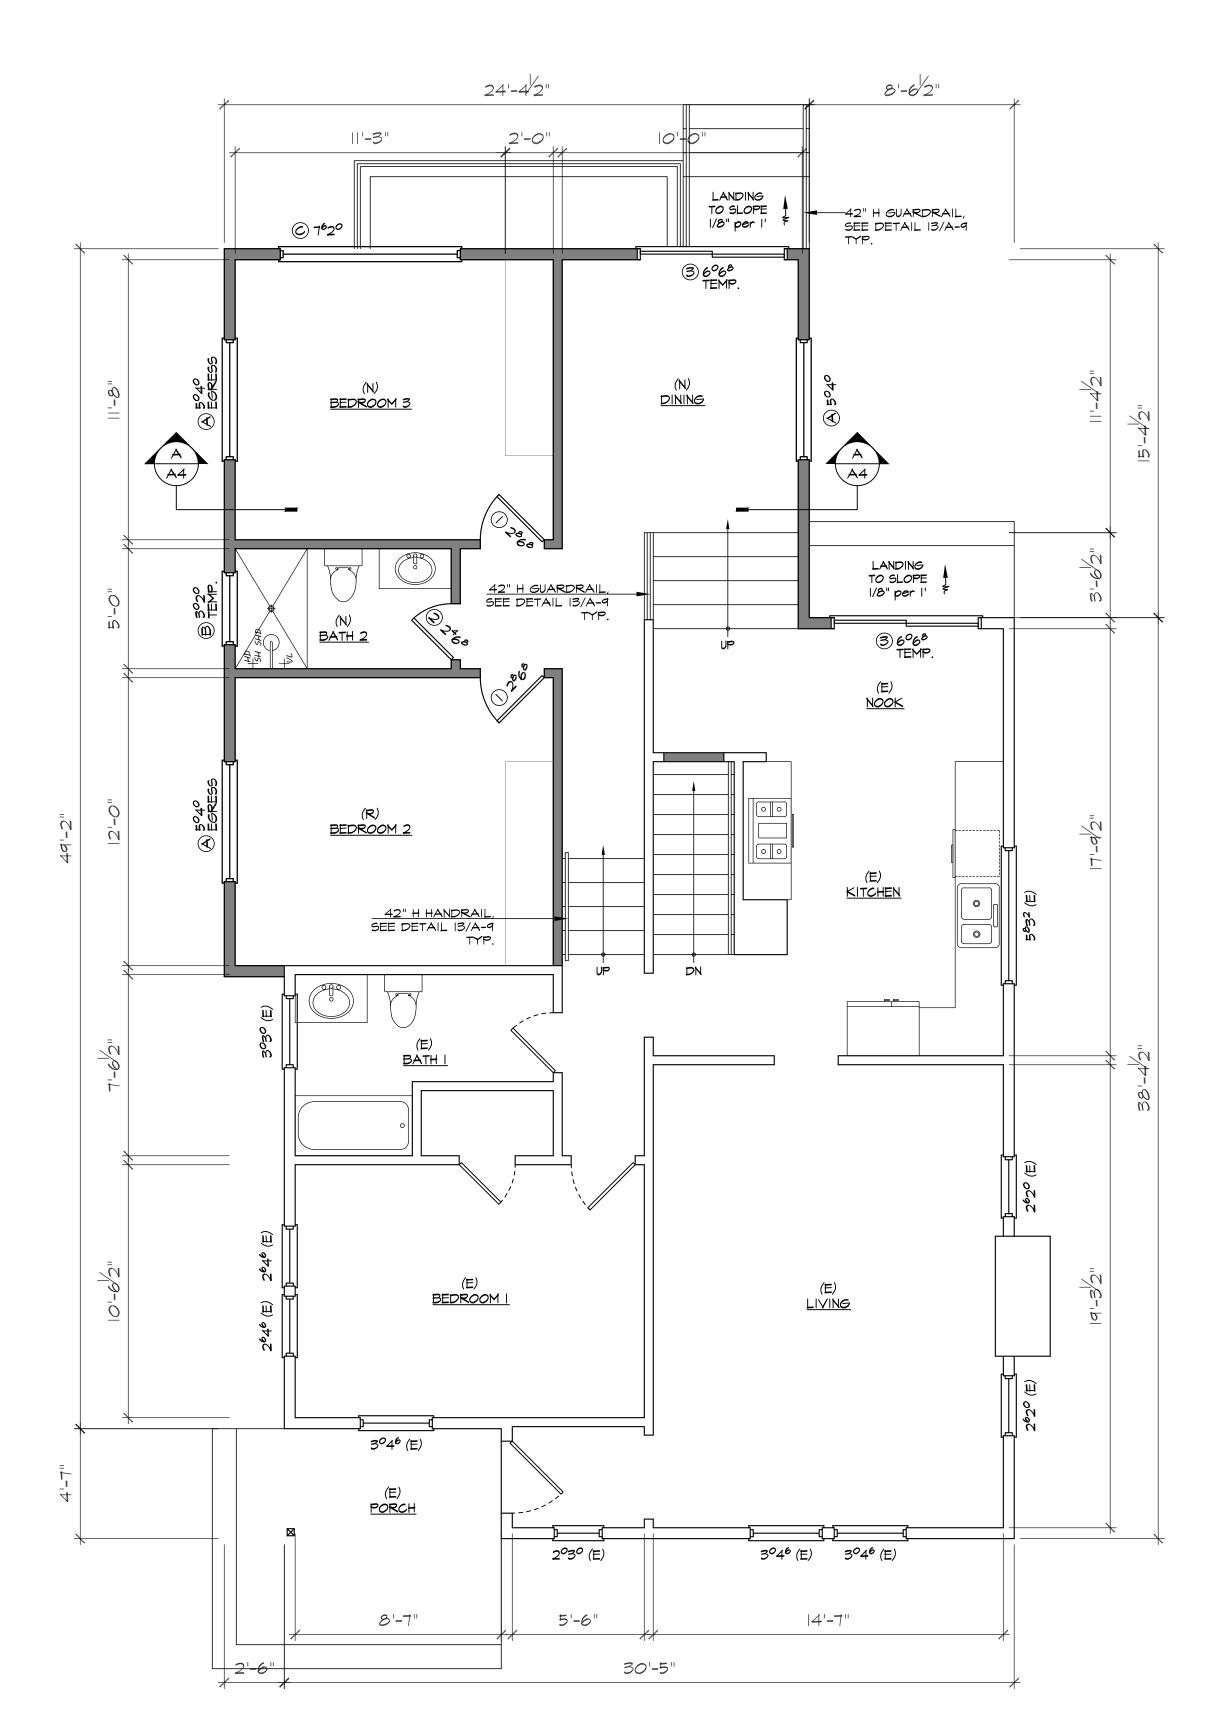

PROPOSED UPPER FLOOR PLAN SCALE 1/4" = 1'-0"

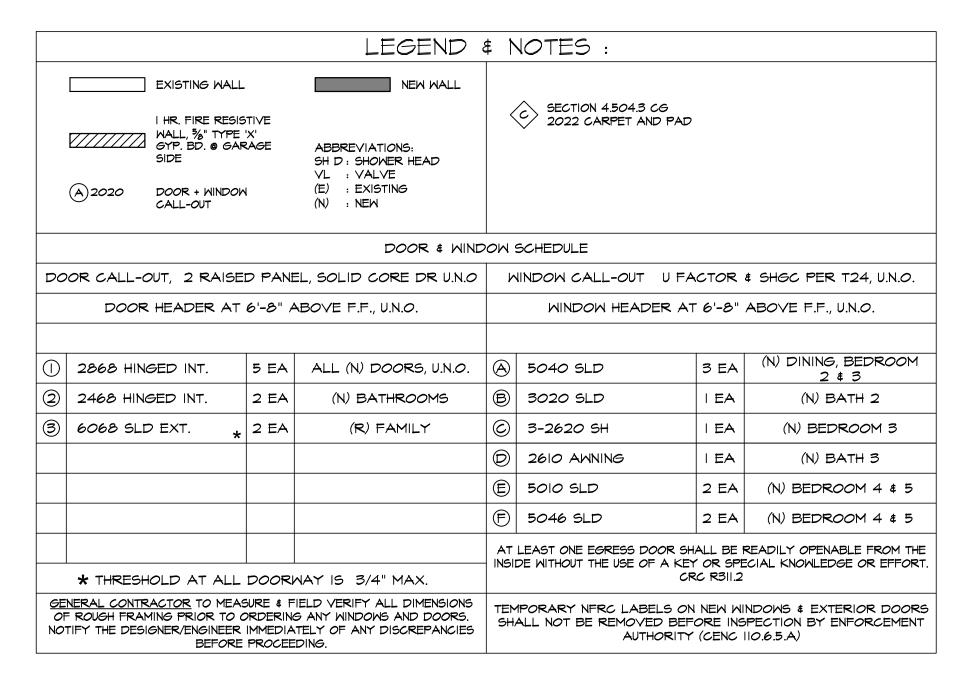

CAL GREEN 2022 MANDATORY MEASURES

4.303. INDOOR WATER USE SHALL BE REDUCED BY AT LEAST 20 PERCENT USING WATER SAVING FIXTURES OR FLOW RESTRICTORS.

4.303.2 WHEN USING CALCULATION METHOD SPECIFIED IN SECTION 4.303.1, MULTIPLE SHOWER HEADS SHALL COMPLY WITH SPECIFIED PERFORMANCE REQUIREMENT

4.303.3 PLUMBING FIXTURES (WATER CLOSETS AND URINALS) AND FITTINGS (FAUCETS AND SHOWERHEADS) SHALL COMPLY WITH SPECIFIED PERFORMANCE REQUIREMENTS. 4.505.3 MOISTURE CONTENT OF BUILDING MATERIALS USED IN WALL AND FLOOR FRAMING IS CHECKED BEFORE ENCLOSURE. CITY

WILL VERIFY MOISTURE CONTENT, MAX 19%. 4.406.1 JOINTS AND OPENINGS. ANNULAR SPACES AROUND PIPES, ELECTRIC, CABLES, CONDUITS OR OTHER OPENINGS IN PLATES AT EXTERIOR WALLS SHALL BE PROTECTED AGAINST THE PASSAGE OF RODENTS BY CLOSING SUCH OPENINGS WITH

CEMENT MORTAR, CONCRETE MASONRY OR SIMILAR METHOD ACCEPTABLE TO THE ENFORCING AGENCY

PLAN NOTES

- ALL BEDROOM WINDOWS SHALL HAVE A MAXIMUM SILL HEIGHT OF 44" ABOVE FINISH FLOOR 2. ALL WINDOWS AND DOORS GLASS SHALL BE DOUBLE GLAZED
- 3. I HOUR FIRE RATED ASSEMBLY SHALL BE PROVIDED ALONG WALL/CEILING BETWEEN GARAGE AND HABITABLE
- 4. SHOWER & SHOWER TUB UNITS TO BE PROVIDED WITH INDIVIDUAL CONTROL VALVES OF THE PRESSURE BALANCE OR THE THERMOSTATIC MIXING VALVE TYPE. PROVIDE I.8 GAL/MIN SHOWER HEADS AND I.2 GAL/MIN FAUCETS 5. ALL SHOWER ENCLOSURE & DOOR SHALL BE TEMPERED GLASS. DOOR OPENING SHALL HAVE A MIN 22" NET
- OPENING AND TO SWING OUT. 6. FIBERGLASS TUB SHOWER WALLS SHALL BE INSTALLED OVER A MOISTURE RESISTANT UNDERLAYMENT TO A
- HEIGHT OF 72 INCHES ABOVE THE DRAIN INLET 7. SAFETY GLAZING IS REQUIRED ON WINDOWS WITHIN TUB OR SHOWER AREA WHEN THE BOTTOM EDGE OF THE
- GLAZING IS LESS THAN 60" ABOVE A STANDING SURFACE AND DRAIN INLET (CBC 2406.4) 8. SHOWER COMPARTMENT MUST HAVE A FINISHED INTERIOR NO LESS THAN 1024 SQUARE INCHES AND CAPABLE OF
- ENCOMPASSING A 30 INCHES CIRCLE (CPC 411.7) 9. PROVIDE 'DUROCK' OR WONDERBOARD FROM FLOOR TO CEILING ON ALL SHOWER AND TUB AREAS. NO GYPSUM
- PRODUCTS BEHIND TILE ASSEMBLIES IN WET ENVIRONMENTS PER CRC R702.3.8.1
- 10. ALL PLUMBING FIXTURES FOR BATHROOMS AND KITCHEN SHALL BE 1.A.P.M.O. APPROVED. II. ALL WATER CLOSETS SHALL BE ULTRA FLUSH TOILET. TANKS SHALL HAVE A MAXIMUM CAPACITY OF 1.28 GALLON
- PER FLUSH (ASSEMBLY BILL #2355) 12. TOILET CLEARANCE MIN 24" IN FRONT OF TOILET AND 15" MINIMUM CENTER OF TOILET TO EACH SIDE (CBC 2904)
- 13. SOLDER USED IN POTABLE PIPING SHALL NOT CONTAIN MORE THAN 2/10 % LEAD.
- 14. HOSE BIBS AND FAUCETS SHALL BE EQUIPPED WITH NON REMOVABLE BACKFLOW PREVENTION DEVICE. 15. PROVIDE 18" PLATFORM FOR WATER HEATER AND FURNACE LOCATED IN THE GARAGE. WATER HEATER SHALL BE SECURED IN PLACE WITH 2 SEISMIC STRAPS. STRAPS SHALL BE ANCHORED AT POINTS WITHIN THE UPPER AND LOWER ONE-THIRD OF ITS VERTICAL DIMENSION. THE LOWER ANCHOR STRAP LOCATED TO MAINTAIN A MINIMUM DISTANCE OF 4" ABOVE CONTROLS.
- 16. PROVIDE WATER HEATER PRESSURE AND TEMPERATURE RELIEF VALVE TERMINATION TO OUTSIDE OF BUILDING (CPC 608.5)
- 17. NO GAS WATER HEATER OR GAS FURNACE SHALL BE INSTALLED IN BEDROOM, BATHROOM, OR CLOTHES CLOSET (CPC 504.1)
- 18. PROVIDE CLOTHES DRYER VENT TO OUTSIDE WITH A MAX. LENGTH OF 14' EQUIPPED WITH A BACK-DRAFT
- DAMPER INCLUDING TWO 90E ELBOWS AND A MINIMUM DIAMETER OF 4" (CMC 504.3) 19. SKYLIGHTS - OPENABLE SKYLIGHTS NEED TO BE 10 FT FROM PLUMBING VENTS OR 3 FT BELOW THE VENT TERMINATION
- 20. VENTILATION REQUIRED IN THE BATHROOM AND LAUNDRY ROOM. PROVIDE OPENABLE WINDOW AREA W/ 5% OF FLOOR AREA (1.5 SF MIN) OR MECHANICAL VENTILATION (5 AIR CHANGES PER HOUR). THE POINT OF DISCHARGE OF EX.AIR SHALL BE AT LEAST 3FT FROM ANY OPENING INTO THE BUILDING. THE EXHAUST FAN SHALL BE EQUIPPED BACKDRAFT DAMPER TO COMPLY W/ ENERGY REGULATIONS
- 21. A SECURITY AUTOMATIC SHUT OFF VALVE SHALL BE INSTALLED BETWEEN THE GAS METER AND THE DWELLING
- 22.A 304 VERTICAL CLEARANCE IS REQUIRED FROM THE TOP OF A COOKING APPLIANCE TO COMBUSTIBLE MATERIALS OR METAL CABINETS. THE MINIMUM HORIZONTAL OR SIDE CLEARANCES SHALL BE SPECIFIED BY A PERMANENT MARKING ON THE COOKING APPLIANCE
- 23. RESIDENTIAL BUILDINGS UNDERGOING PERMITTED ALTERATIONS, ADDITIONS OR IMPROVEMENTS SHALL REPLACE NONCOMPLIANT PLUMBING FIXTURES WITH WATER-CONSERVING PLUMBING FIXTURES. PLUMBING FIXTURE REPLACEMENT IS REQUIRED PRIOR TO ISSUANCE OF CERTIFICATE OF FINAL COMPLETION, CERTIFICATE OF OCCUPANCY OR FINAL PERMIT APPROVAL.

PROVIDE 2x6 STUDS IN PLUMBING WALL AT WATER CLOSET TO PREVENT EXCESSIVE NOTCHING OR BORING OF STUDS. (CRC 602.6)

BATHROOM VENT TO TERMINATE AT LEAST 3-FEET ABOVE THE HIGHEST POINT WHERE IT PASS THROUGH A ROOF, AND AT LEAST 2-FEET HIGHER THAN ANY PORTION OF THE BUILDING WITHIN A HORIZONTAL DISTANCE OF 10-FEET (CPC 509.5.4).

A LANDING OR FLOOR IS REQUIRED ON EACH SIDE OF EACH EXTERIOR DOOR. THE WIDTH OF THE LANDING SHALL NOT BE LESS THAN THE DOOR WIDTH AND 36" MINIMUM IN DEPTH. LANDINGS AT REQUIRED EGRESS DOORS SHALL NOT BE MORE THAN 1-1/2" LOWER THAN THE TOP OF THE THRESHOLD.

EXCEPTION: A DOOR MAY OPEN AT A LANDING THAT IS NOT MORE THAN 7-3/4" LOWER THAN THE FLOOR LEVEL IF THE DOOR DOES NOT SWING OVER THE LANDING. (CRC R311.3.1 & R311.3.2)


APPLIANCES INSTALLED IN GARAGES SHALL BE GUARDED AGAINST DAMAGE BY BEING INSTALLED BEHIND PROTECTIVE BARRIERS, BY BEING ELEVATED, OR BY BEING LOCATED OUT OF THE NORMAL PATH OF VEHICLES. (CPC 507.13.1)

PAN FLASHING INSTALLATION

- INSTALL FLEXIBLE PAN FLASHING TO COVER THE SLOPED SILL/THRESHOLD, 3-INCHES OF FACE OF WALL, AND 3-INCHES OF
- EACH JAMB.
- 2. INSTALL CORNER FLASHINGS 3. INSTALL WINDOW/DOOR UNIT
- 4. INSTALL FLASHING COVERING FLANGE AND WALL ALONG EACH JAMB AND 3-INCHES ABOVE THE HEAD AND BELOW THE SILL/THRESHOLD
- 5. INSTALL FLASHING COVERING A MINIMUM OF 3-INCHES OF THE WALL
- FACE AT THE HEAD AND JAMBS.
- 6. FOLD AND ADHERE SILL/THRESHOLD PAN LEG ONTO INTERIOR FACE OF FRAME, NOT SHOWN. PROTECT LEG FROM DAMAGE UNTIL THE INTERIOR TRIM OR FINISH IS INSTALLED.

NOTE: SURFACES RECEIVING FLASHING SHALL BE FREE OF

IRREFULARITIES. APPLY SEALANT/ADHESIVE TO CLEAN AND DRY SURFACES RECEIVING FLASHING. LIQUID ADJESIVE SHALL BE COMPATIBLE WITH SUBSTRATE AND MEET CALGREEN VOC REQUIREMENTS.

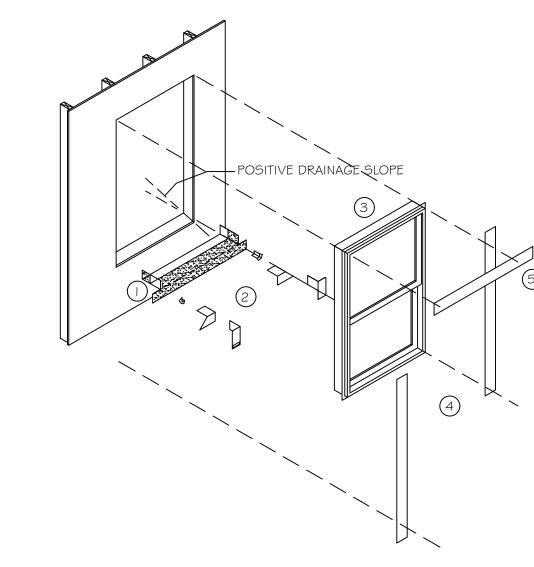

SINGLE FAMILY HOUSE

Andreas &


Cherylle

302 LORETO ST., MOUNTAIN VIEW, CA

PROJECT

ADDITION/ REMODEL

BETTER BUILT BUILDERS

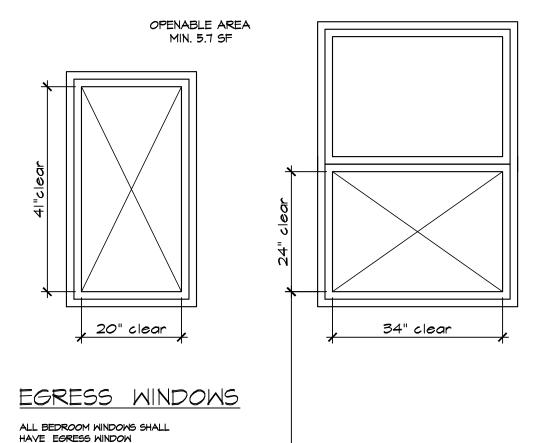

SHEET TITLE

PROPOSED UPPER FLOOR PLAN

REVISION

1 1C PC COM RES - 02.02.25

DATE 03.24.24 DRAWN

SCALE AS SHOWN SHEET

EMERGENCY ESCAPE AND RESCUE OPENING SHALL MEET THE CALIFORNIA FIRE CODE CHAPTER 10 SECTION 1030; EMERGENCY ESCAPE AND RESCUE OPENINGS SHALL OPEN DIRECTLY INTO A PUBLIC WAY; OR TO A YARD OR COURT THAT OPENS TO A PUBLIC WAY. MINIMUM SIZE IS 5.7 SQUARE FEET OF NET CLEAR OPENING WITH A MINIMUM DIMENSION OF 24 INCHES IN HEIGHT AND 20 INCHES IN WIDTH. THE NET CLEAR OPENING DIMENSION SHALL BE THE RESULT OF NORMAL OPERATION OF THE OPENING. THE BOTTOM OF THE CLEAR OPENING


SHALL NOT BE GREATER THAN 44 INCHES MEASURED FROM THE FLOOR.

· HAVE A MAXIMUM OPNEING HEIGHT OF

• 5.7 SQ.FT. MINIMUM OPENABLE AREA.

20" W x 41" H OR 34" W x 24" H

• WINDOW CLEAR OPENING MIN.

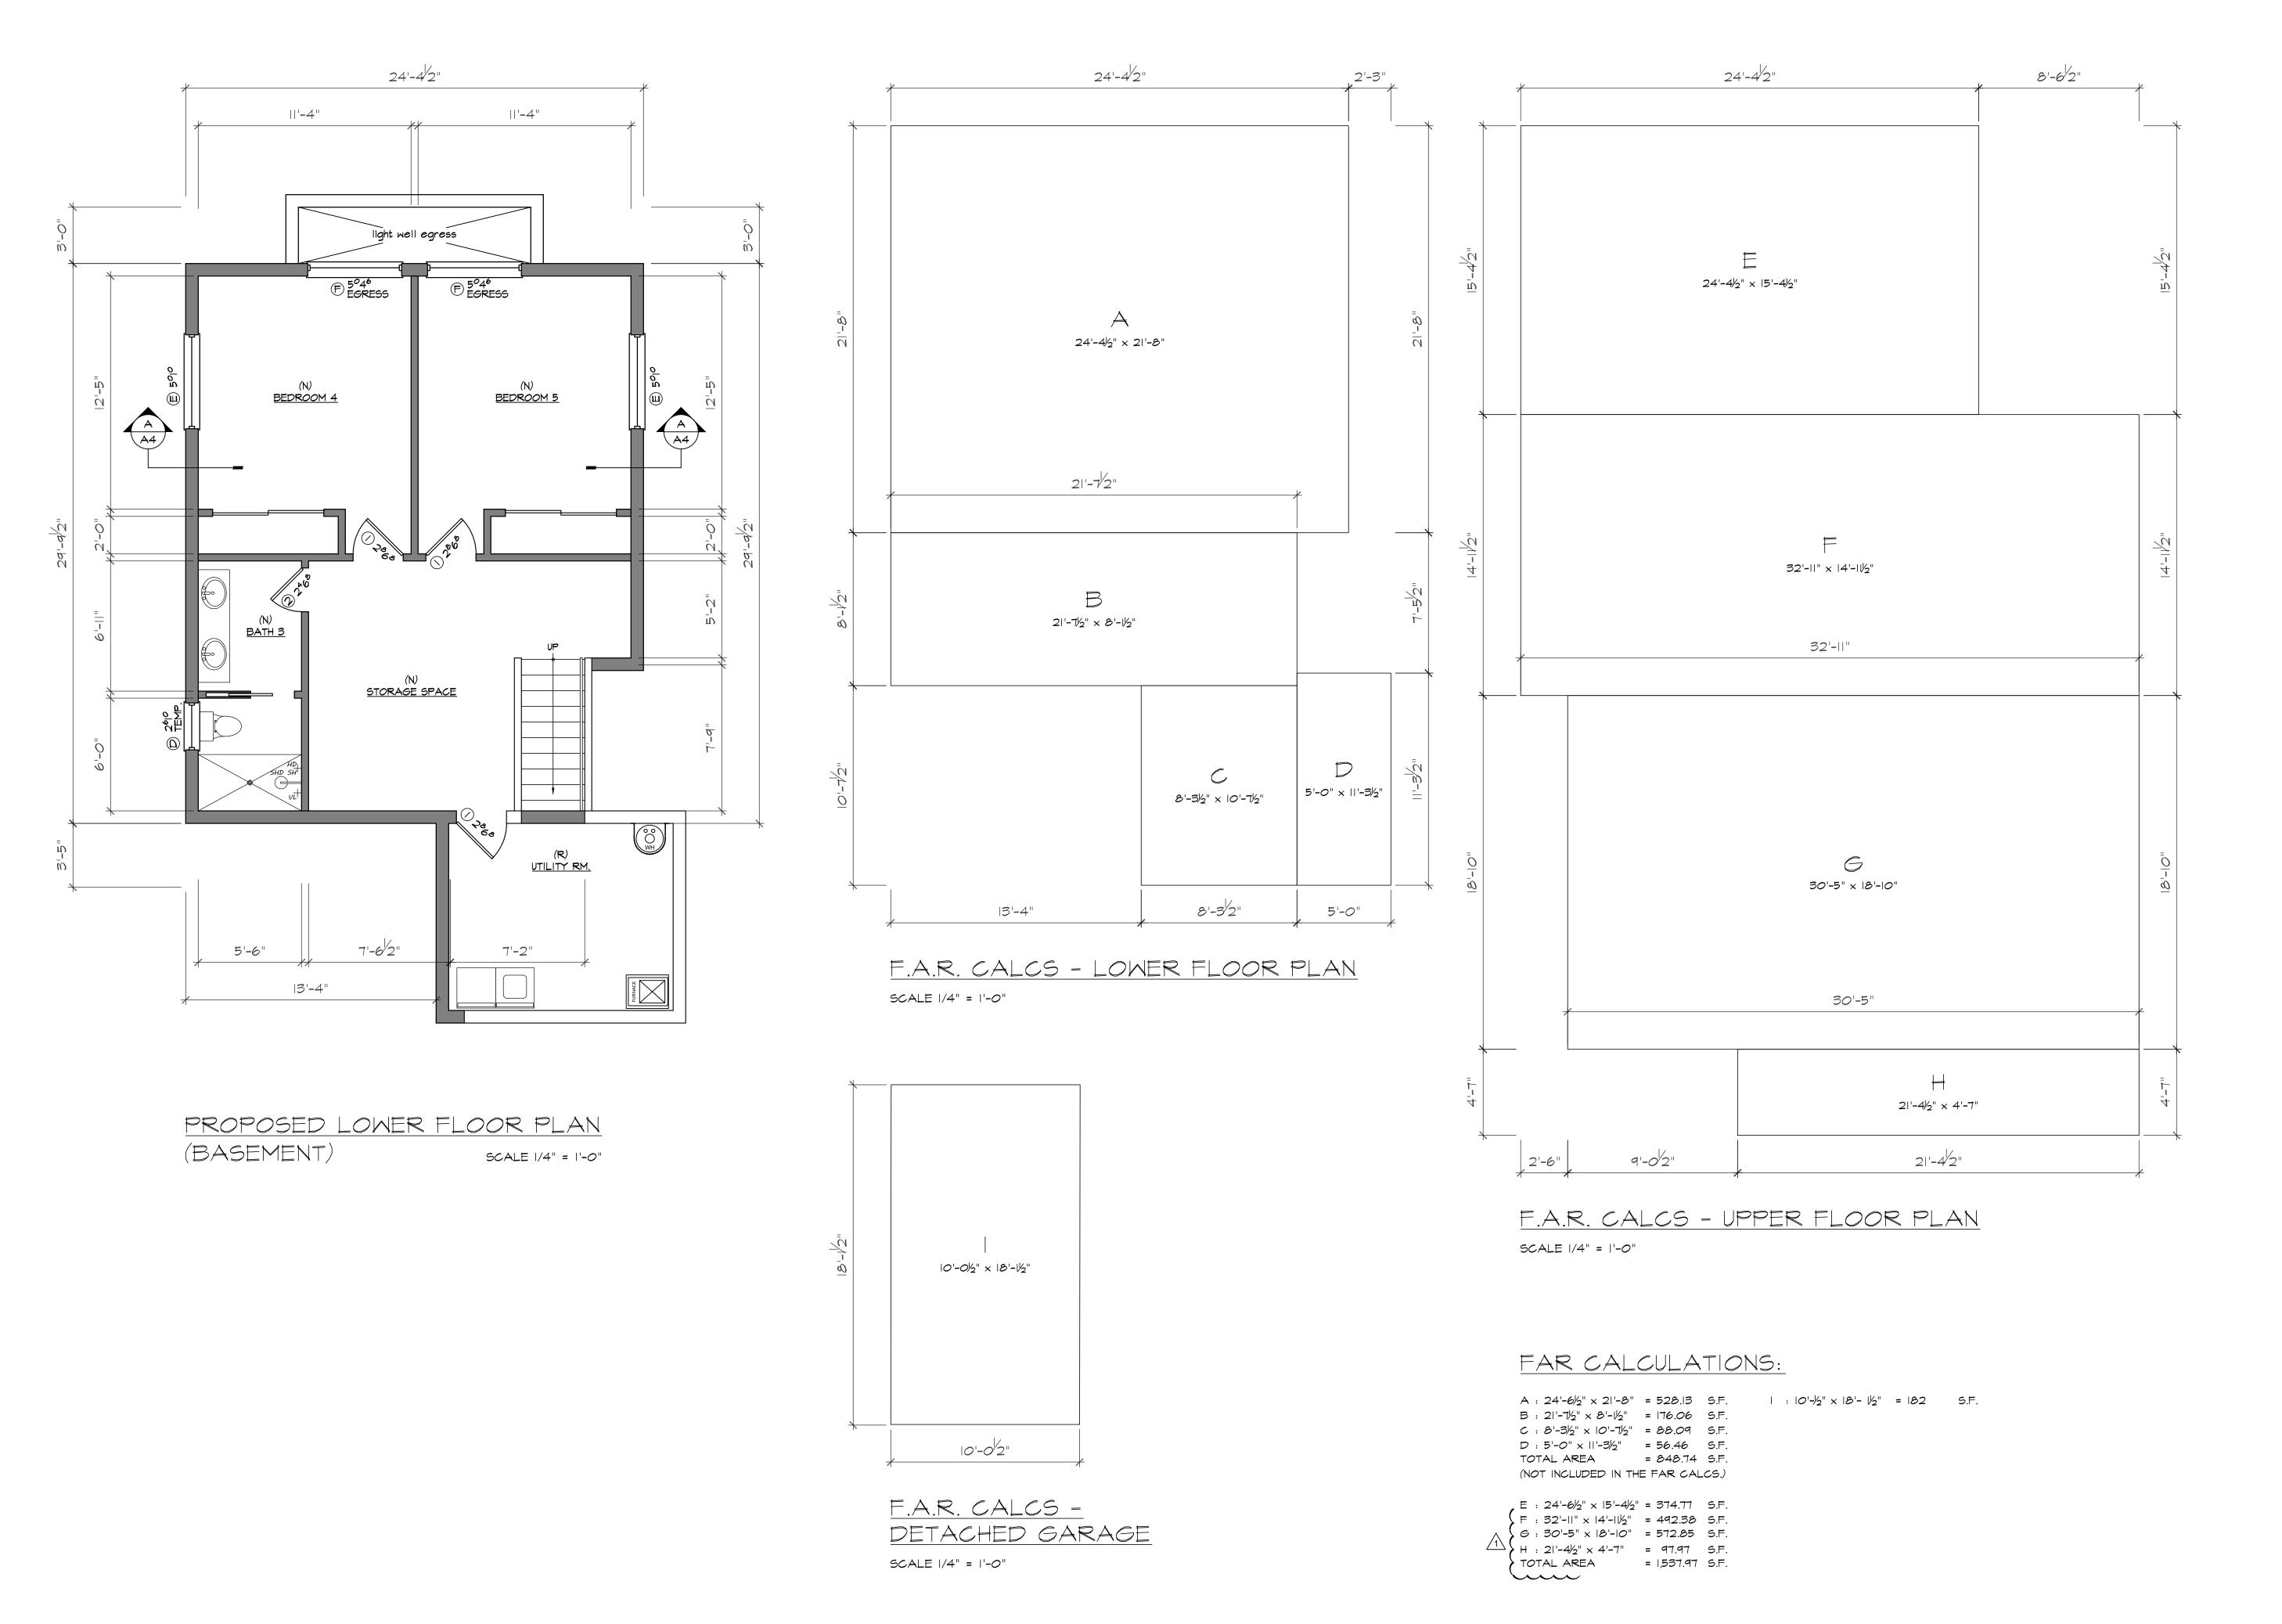

owner Andreas & Cherylle

SINGLE FAMILY HOUSE

302 LORETO ST., MOUNTAIN VIEW, CA 94041

> ADDITION/ REMODEL



SHEET TITLE

PROPOSED LOWER FLOOR PLAN

REVISION

1C PC COM RES - 02.02.25

2


3

DATE 03.24.24


DRAWN

SCALE AS SHOWN

A-3-2

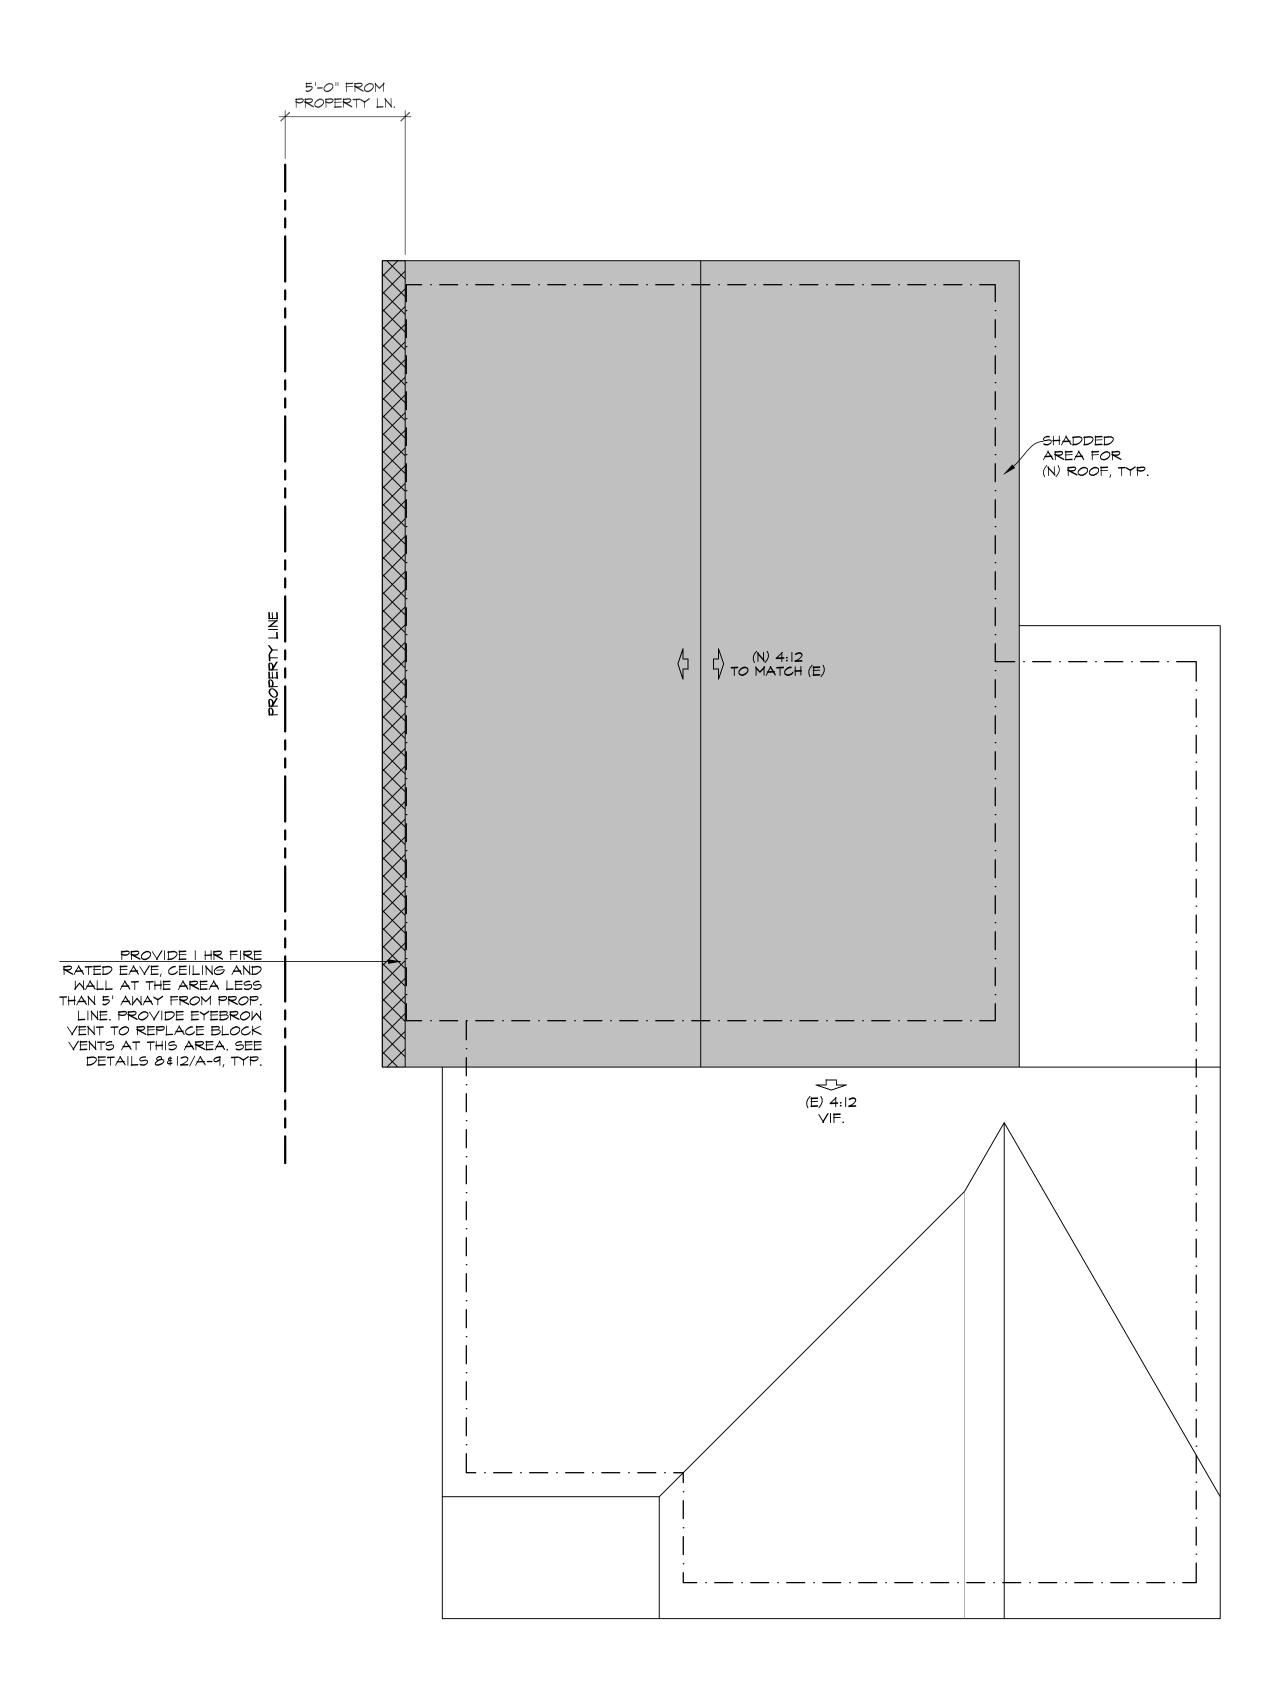

PROPOSED ROOF PLAN SCALE 1/4" = 1'-0"

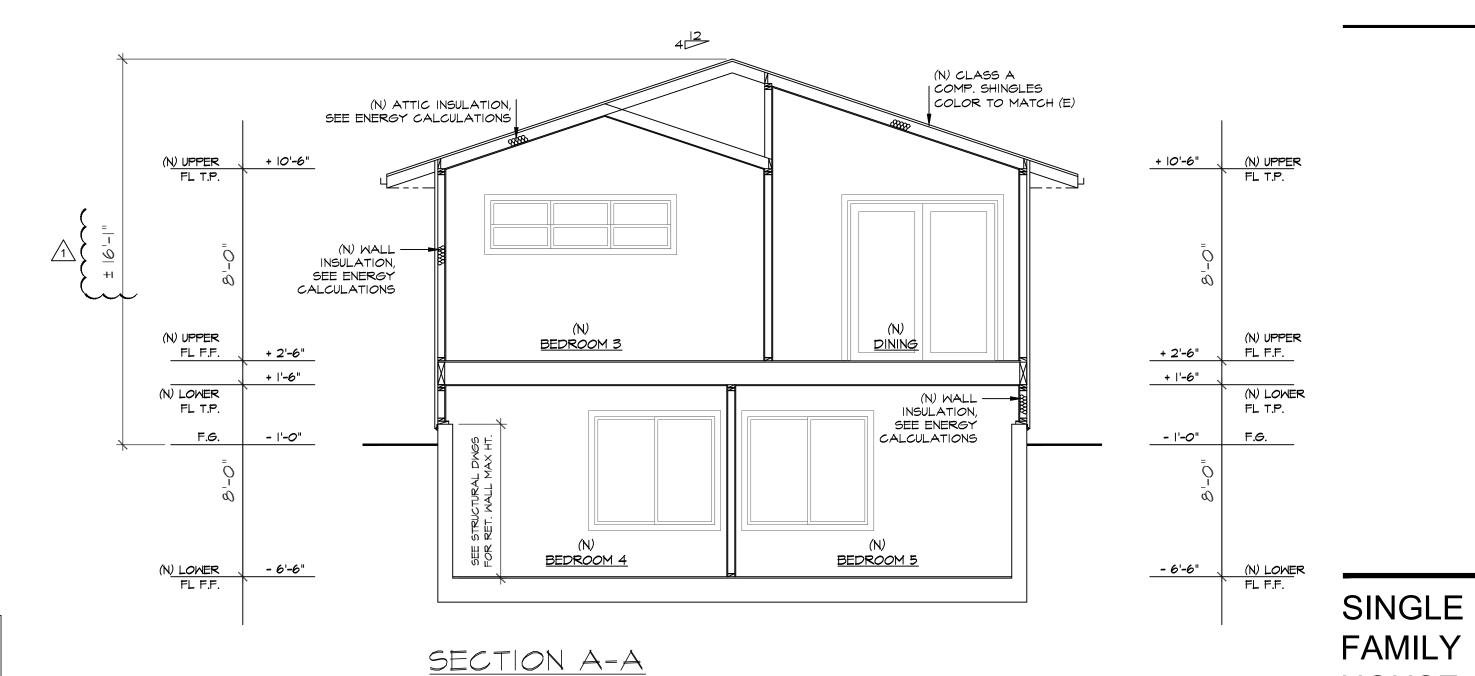

A CRICKET OR SADDLE SHALL BE INSTALLED AT THE JUNCTION OF ROOFS AND WALLS, TYPICAL. CRICKET OR SADDLE COVERINGS SHALL BE CORROSION-RESISTIVE SHEET METAL OR OF THE SAME MATERIAL AS THE ROOF COVERING. (CRC R903.2.2)

EXISTING AND NEW ROOF WILL BE CLASS A COMPOSITION SHINGLES

FOR ROOF SLOPES FROM 2:12 TO 4:12, DOUBLE UNDERLAYMENT APPLICATION IS REQUIRED. CRC R905.2.2

ALL DOWN SPOUT TO BE CONNECTED TO UNDERGROUND PERFORATED PIPE TO BUBBLE UP ON THE LANDSCAPE AREA.

LEGEND & NOTES :

D.S. Œ: DOWN SPOUT

SPLASH BLOCK & COBBLESTONES TYP. FOR ALL DOWN SPOUTS TO REDUCE VELOCITY OF ROOF WATERS TO PREVENT EROSION LANDSCAPE AREAS.

> RAINWATER LEADERS FROM ROOF GUTTERS SHALL NOT BE PIPED DIRECTLY TO THE STORM DRAIN. THEY SHALL BE CONNECTED TO AN EARTHEN SWALES AND AREA DRAIN(S) CONNECTED TO THE STORM DRAIN SYSTEM, OR A COMPARABLE METHOD TO EFFECTIVELY REDUCE THE ENTRY OF POLLUTANTS INTO STORM WATER RUNOFF

VENTING NOTES:

USE 4 - 2-1/2" DRILLED SCREEDED VENT HOLES AT EACH EAVE BLOCK TO PROVIDE LOW VENTING.

BAFFLE BATT INSULATION TO ALLOW FREE FLOW OF AIR.

ROOF NOTES:

FRAMING : CONVENTIONAL ROOF FRAMING ROOF PITCH : 4/12 VIF.

ROOFING : CLASS A COMP. SHINGLES

DECKING : OSB ROOF SHEETING (SEE SHEAR SCHEDULE) FASCIA : 2x8 WOOD FASCIA BOARD TYP AT EAVES, PAINTED GUTTER & DS: ALUMINUM

SOFFITS : CLOSED WOOD SOFFIT W/ GALV. METAL SCREENED

CAL GREEN 2022 REQUIREMENTS - MATERIAL FINISH

MDF, PARTICLE BOARD, MDF AND (F) HARDWOOD PLYWOOD SEE TABLE 4.504.5 CG 2022.

PAINTS, STAINS AND OTHER PAINTS, STAINS AND OTHER COATINGS PER SECTION 4.504.2.2 and 4.504.2.3 CG 2022.

ADHESIVES, SEALANTS AND CAULKS PER SECTION 4.504.2.1 CG 2022. THERMAL INSULATION SHALL BE IN COMPLIANCE WITH VOC LIMITS

VENT CALCULATIONS NEW ATTIC VENT (N) ATTIC AREA (CATHEDRAL): 529 SF 529 : 150 = 3.53 REQUIREMENT | SF/ 150 SF | ATTIC VENT 3" x 22" = 19.6 SQ IN I EYEBROW VENT = 66 SQ IN MIN NET 3.53 : 136 = 25.93 -> USE MIN. 26 BLOCK VENTS

FREE OPENING AREA. (N) ATTIC AREA (FLAT CEILING): 2,122 SF 2,122 : 150 = 14.15 USE MIN. 106 BLOCK VENTS


OPTIONAL: USE 3" WIDE CEILING VENT ALONG OVERHANG PERIMETER

VENT NOTES:

SCALE 1/4" = 1'-0"

CONTRACTOR TO INSTALL ADDITIONAL VENTS TO COMPENSATE FOR ANY EXISTING VENTS OBSTRUCTED BY THE NEW WORK. VENT PLACEMENTS SHALL BE EVENLY DISTRIBUTED TO ENCOURAGE CROSS VENTILATION

VENTS OPENING SHALL BE BASED ON NET FREE VENTILATION AREA (NFVA) OF THE OPENING AND NOT ON THE ROUGH FRAMING OPENING PER CBC 107.2.

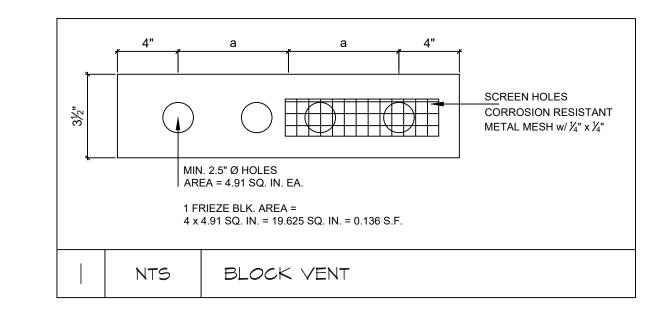

302 LORETO ST.,

HOUSE

94041 PROJECT

> ADDITION/ REMODEL

MOUNTAIN VIEW, CA



SHEET TITLE

PROPOSED **ROOF PLAN** + SECTION


REVISION

1C PC COM RES - 02.02.25

SHEET

DATE 03.24.24 DRAWN SCALE AS SHOWN

OF 16 SHEETS

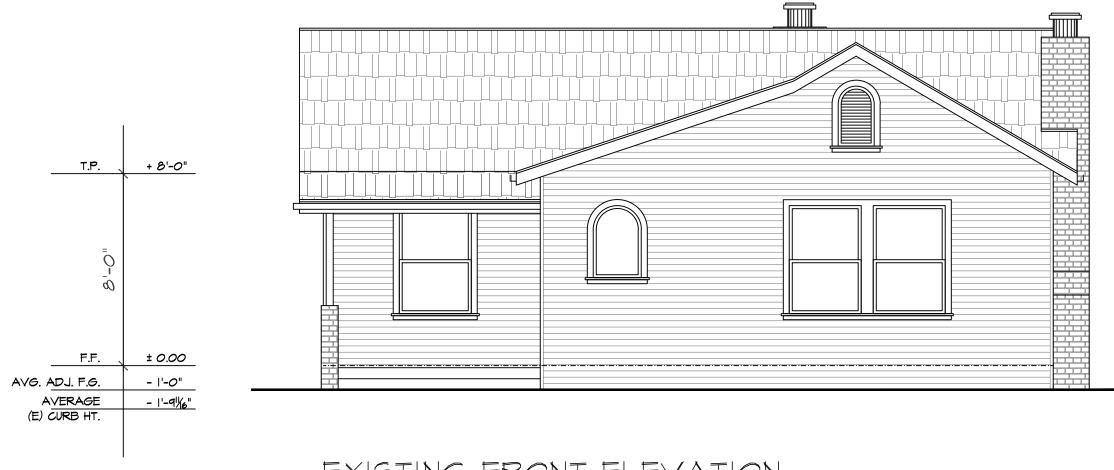



+ 8'-0" ± 0.00 AVG. ADJ. F.G. - 1'-0" - 1'-91/6" AVERAGE (E) CURB HT.

EXISTING FRONT ELEVATION

SCALE 1/4" = 1'-0"

EXISTING REAR ELEVATION

SCALE 1/4" = 1'-0"





PROPOSED REAR ELEVATION

SCALE 1/4" = 1'-0"

NOTES :

SCALE 1/4" = 1'-0"

- IF NOT EXISTING, CONTRACTOR MUST INSTALL ADDRESS NUMBERS MEETING THE FOLLOWING STANDARDS:
 - ADDRESS NUMBERS SHALL BE INTERNALLY OR EXTERNALLY LIT DURING NON DAYLIGHT HOURS. LIGHTING MUST BE ON ALL THE TIME (TYPICAL OF LOW VOLTAGE UNITS) OR IF LIT ONLY DURING NON DAYLIGHT HOURS, SWITCHING SHALL BE
 - CONTROLLED BY A TIME CLOCK OR A PHOTO SENSOR. BATTERY OR PHOTO CELL POWERED UNITS CANNOT BE USED FOR REQUIRED ADDRESSING.
 - ADDRESS NUMBERS SHALL BE AT LEAST FOUR INCHES HIGH AND INSTALLED ON A CONTRASTING BACKGROUND.
 - ADDRESS NUMBERS SHALL READ FROM LEFT TO RIGHT. VERTICALLY POSITIONED NUMBERS CANNOT BE USED.
 - ADDRESS NUMBERS SHALL BE PLACED IN SUCH A LOCATION THAT EMERGENCY CREWS CAN READ THE ADDRESS FROM THE STREET FRONTING THE DWELLING.

EXTERIOR ELEVATION AND SITE NOTES

- I. EXTERIOR WALL: WOOD LAP SIDING O/ 2 LAYERS TYPE D' PAPER O/ PLYWOOD SHEATHING (COLOR & SIZE TO MATCH EXISTING)
- 2. ROOFING: CLASS A COMP. SHINGLES (NATURAL COLOR) 3. WINDOWS: MILGARD VINYL DUAL PANE WHITE OR SIM. (SEE
- SCHEDULE)
- 4. WINDOW TRIM: 2x WOOD-SMOOTH (COLOR TO MATCH EXISTING)
- 5. GUTTER: ALUMINUM FASCIA (COLOR TO MATCH EXISTING)
- 6. FASCIA BOARD: PAINTED (COLOR TO MATCH EXISTING)
- 7. WALL TO ROOF FLASHING: GALV. METAL PAINTED TO MATCH EXISTING

SINGLE **FAMILY** HOUSE

302 LORETO ST., MOUNTAIN VIEW, CA

ADDITION/ REMODEL



SHEET TITLE

ELEVATIONS

REVISION


1C PC COM RES - 02.02.25

DATE 03.24.24 DRAWN

SCALE AS SHOWN SHEET

OF 16 SHEETS


SCALE 1/4" = 1'-0"

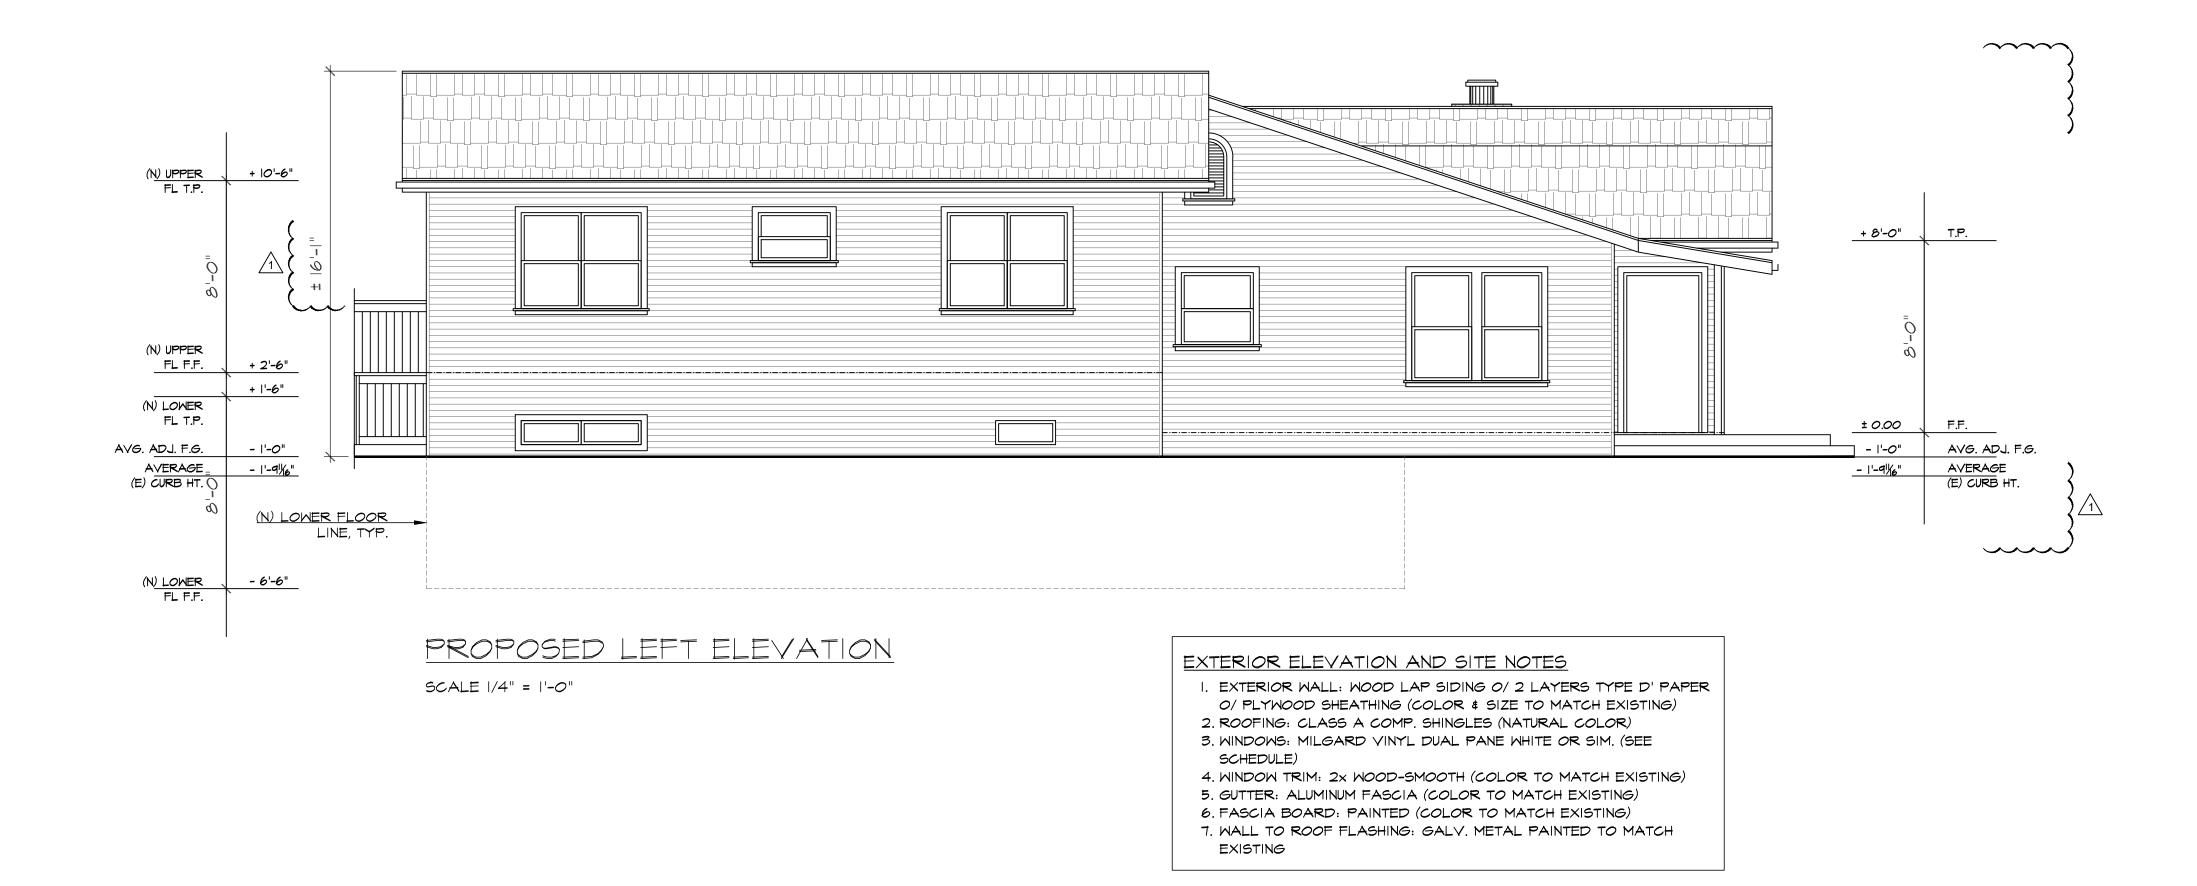


BATHROOMS

Bathroom Electrical:

- All installed lighting shall be high efficacy [CNC 150.0(k)1A].
- At least one light shall be controlled by a vacancy sensor (a manual-on, automatic-off occupancy sensor) [CNC 150.0(k)2AJ].
- Exhaust fans must be switched separate from lighting, with the exception that lighting integral to an exhaust fan can be on the same switch if fan is controlled by a humidistat that continues its operation after light is off.
- All receptacle outlets in bathrooms shall be GFCI protected [CEC 210.8(A)(1)].
- All receptacle outlets in bathrooms shall be tamper resistant [CEC 406.12(A)].
- When a bathtub or shower stall is in an area not technically considered a bathroom (by the definitions in the electrical code), receptacles within 6 ft. of the tub/shower stall must be GFCI- protected [CEC210.8(A)(9)].
- A receptacle outlet is required within 3 feet of each wash basin location. It may be on the wall, or an adjacent
- partition, or on the face or side of the cabinet not more than 12 inches below the top of the basin [CEC 210.52(D)].
 Receptacles cannot be face-up in a vanity surface; listed pop-up receptacles are allowed [CEC 406.5(E) & 210.52(D)].
- A minimum of one 120-volt, 20-amp circuit is required for the receptacle outlet(s) within 3 ft of the outside edge of
 the sink basin in the bathroom(s). This circuit can share multiple bathroom receptacles within 3 ft of edge of sink
 basin or countertops and similar work surfaces but can have no other outlets, including lights [CEC 210.11(C)(3),
 210.52(D)]. However, if a 20-amp circuit serves only one
- Bathroom, lights and fans can be on the same circuit with the receptacles in that bathroom [CEC 210.11(C)(3) exception]
- Hydro-massage tubs require an individual (dedicated) branch circuit and readily accessible GFCI protection [CEC 680.71]. An access door is required and must be large enough to remove the motor and pump. Cord-connected equipment must have the receptacle facing the opening and be no more than one foot behind the access hatch [CEC 680.73].

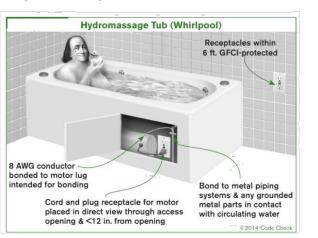

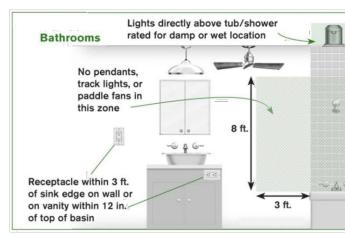

- Recessed light fixtures in shower enclosures must be listed for a damp or wet location [CEC 410.10(A)].
- Pendant light fixtures, track lights, and paddle fans shall not be installed lower than 8 feet above the flood-level rim of a tub, including the area 3 feet past the edge of the tub [CEC 410.10(D)].
- Electrical panels shall not be installed in bathrooms [CEC 240.24(E)].
- All 125-volt through 250-volt receptacles installed in bathrooms, within 6 ft of bathtub or shower enclosure, within 6 ft of any sink, and indoor damp locations shall have ground-fault circuit-interrupter protection for personnel [CEC210.8(A)].
- Switches and receptacles are not allowed in bathtub or shower spaces. Receptacles shall not be installed within a
 zone measured 3 ft horizontally and 8 ft vertically from the top of the bathtub rim or shower stall threshold. This
 zone includes the space directly over the tub or shower stall [CEC 404.4(C) & 406.9(C)].

BATHROOMS (Continued)

Bathroom Plumbing, General:

- All hot water pipes require insulation thickness to be at least equal to pipe diameter [CPC 609.12, 609.12.2].
 Newly installed plumbing fixtures shall be water-conserving in compliance with the California Plumbing Code and
 - een Building Standards.
 - Water closets shall not exceed 1.28 gallons per flush [CPC 411.2, CGBSC 4.303.1.1].
 - Showerheads shall not exceed 1.8 GPM at 80 PSI [CPC 408.2.1, CGBSC 4.303.1.3].
 Lavatory faucets shall not exceed 1.2 GPM at 60 PSI [CPC 407.2.2].
 - All existing plumbing fixtures not included in the scope of new work shall be replaced if necessary, to comply with SB407 Plumbing Fixtures Replacement requirements – See Water Conservation Certification Form.

Bathroom Plumbing, Shower:

- Shower stalls require a minimum of 1024 sq. inches and a 30" circle must fit from the back of the finished shower wall to middle of the dam. Shower doors must swing out and must be at least 22" wide [CPC 408.5, 408.6]. The curb may encroach on these size requirements. All surfaces shall be waterproof up to 72 inches above the drain inlet [CRC R307.2].
- Safety glass (tempered or laminated) is required for all glass shower doors and partitions and for windows in walls facing the tub or shower and located less than 60 inches above the standing surface of the tub/shower and within 60 inches horizontally [CRC R308.4.(1)&(5)].
- Showers require a minimum 2-inch drain and trap [CPC Table 702.1].

Bathroom Plumbing, Toilets & Bidets:

- Toilets and bidets require a minimum 15 inches of clearance from the center line of the bowl to each side, and 24
- inches of clearance from the front edge of the bowl [CPC 402.5].
 Lavatory sinks require a minimum of 24 inches front clearance [CPC 402.5].
- The maximum water temperature to a shower or tub/shower combination is 120°F. The water heater thermostat
- cannot be used as the control for this temperature. Valves shall provide scald and thermal shock protection, and be pressure-balanced, thermostatic, or combination pressure-balanced/thermostatic mixing in accordance with ASSE 1016 or ASME A112.18.1/CSA B125.1 [CPC 408.3.2].

Bathroom Mechanical:

- Mechanical ventilation is required in all bathrooms with tubs or showers. Operable window is not an accepted way
 of providing bathroom exhaust for humidity control [CMC 405.3, CGBSC 4.506.1, CRC 303.3.1]. The fan must
 move aminimum 50 CFM of air and be separately switched from the lighting. Fans that operate continuously can
 be 20 CFM [CMC 405.3, 405.3.1]. The duct must terminate on the exterior not less than 3 feet from openings into
 the building, 3 ft from a property line or 10 ft from a forced air inlet [CMC 502.2.1].
- Bathrooms with no tub or shower (half baths) do not require mechanical ventilation if they are provided with a window at least 3 sq. ft. half of which is openable [CRC R303.3].

Bathroom, Tile & Backing:

- Water-resistant gypsum board (purple board) can be used as a tile backer board in areas that are not subject to
 direct exposure to water or high humidity [CRC R702.3.7.1]. Examples would be a wall behind a toilet or above a
 vanity countertop. Purple board cannot be used in a shower for direct application of tile. It can be used in showers
 behind a water-resistive membrane with mortar bed and lath. Other acceptable materials for application of tile in
 showers include cement board, fiber-cement or glass mat gypsum backers [CRC R702.4.2].
- Bathtub and shower floors and walls above bathtubs with installed shower heads and in shower compartments shall be finished with a nonabsorbent surface. Such wall surfaces shall extend to a height of not less than 6 feet above the floor [CRC R307.2].
- See CPC 408.7 for information on lining for shower and receptors.

Andreas & Cherylle

SINGLE FAMILY HOUSE

302 LORETO ST., MOUNTAIN VIEW, CA 94041

PROJECT

ADDITION/ REMODEL



SHEET TITLE

ELEVATIONS

REVISION

1C PC COM RES - 02.02.25

2

3

DATE 03.24.24

DRAWN

SCALE AS SHOWN
SHEET

OF 16 SHEETS

302 LORETO ST., MOUNTAIN VIEW, CA 94041

SINGLE

FAMILY

HOUSE

PROJECT

ADDITION/ REMODEL



SHEET TITLE

ELEVATIONS

REVISION

1C PC COM RES - 02.02.25

2

3


DATE 03.24.24

DRAWN

SCALE AS SHOWN
SHEET

\-7OF 16 SHEETS



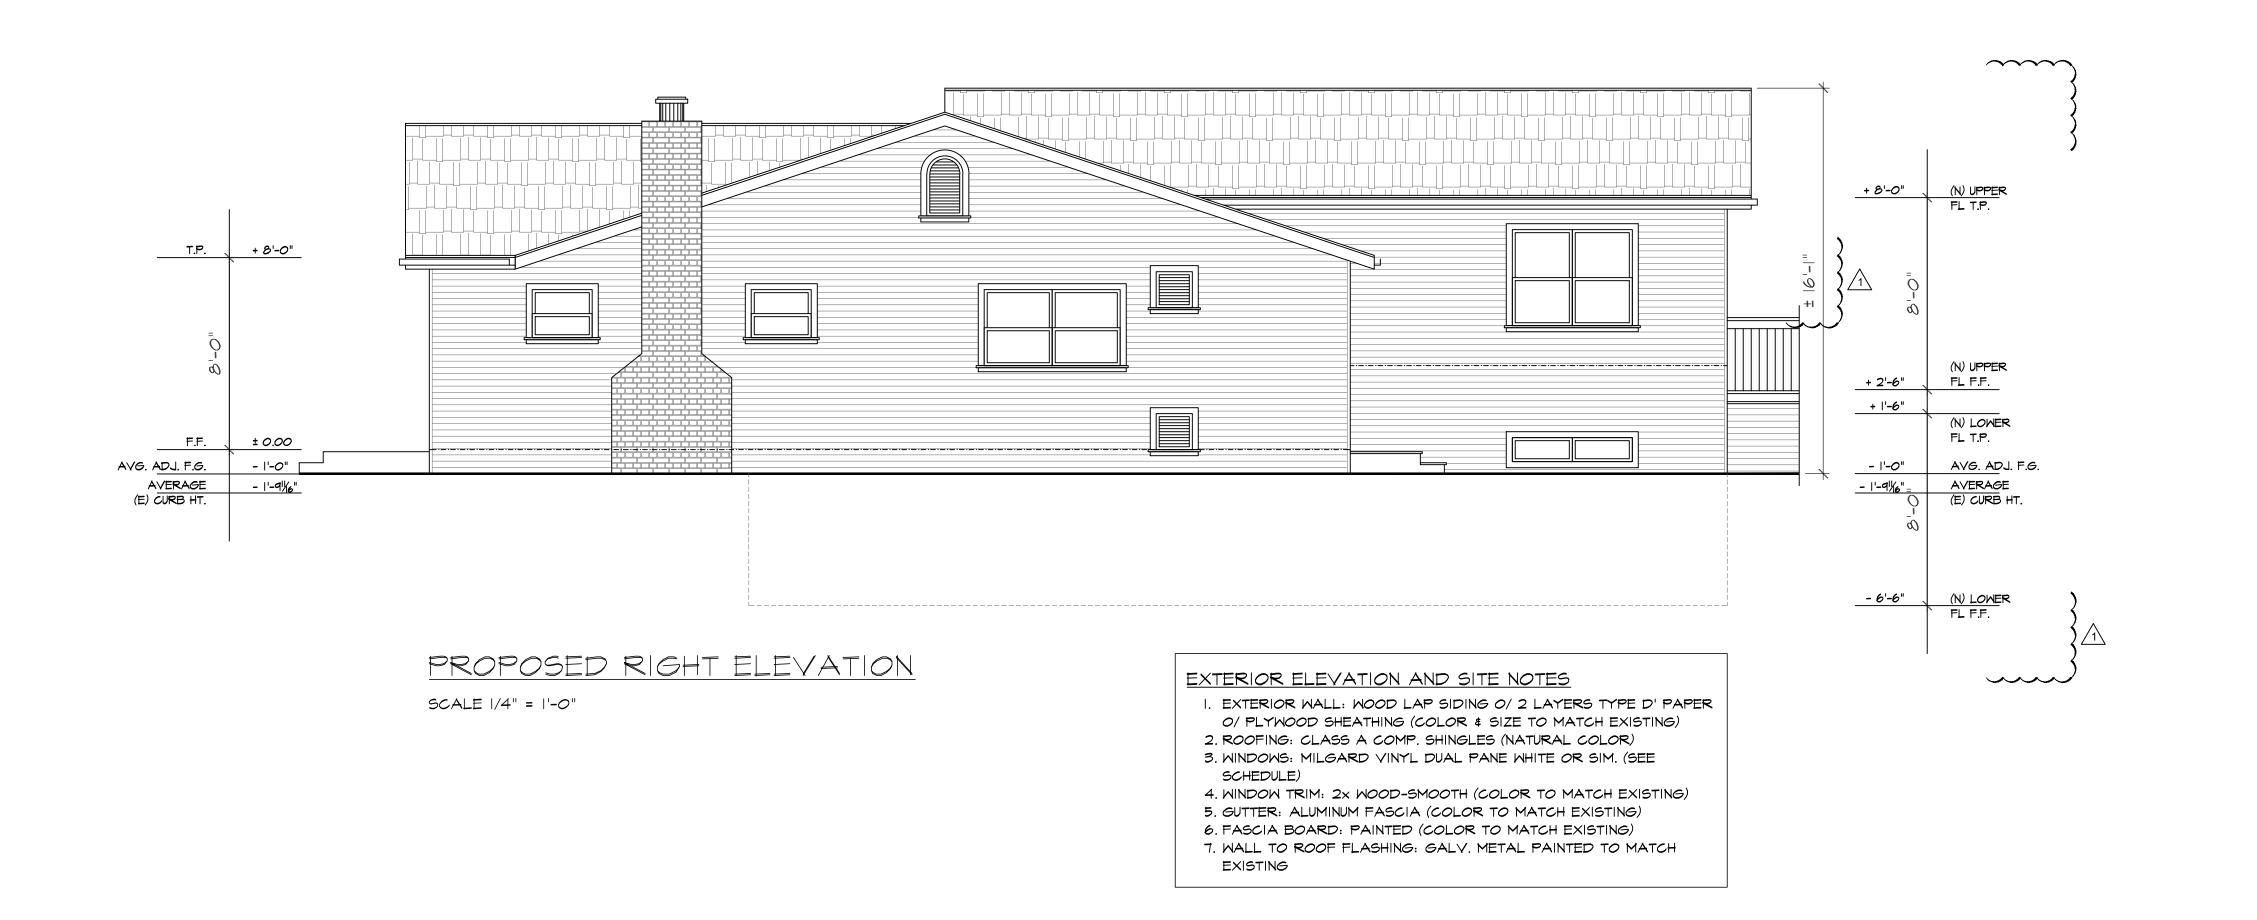

Laundry Rooms Laundry Electrical: All new or altered lighting shall be high efficacy [CNC 150.0(k)1A]. • At least one light shall be controlled by a vacancy sensor (a manual-on, automatic-off occupancy sensor) [CNC 150.0(k)2AJ]. All 125-volt through 250-volt receptacles in laundry areas require GFCI protection, including but not limited to the clothes washer and dryer receptacle [CEC 210.8(A)(10)]. All non-locking type 125-volt, 15- and 20-ampere receptacle outlets shall be listed tamper-resistant, except those
within dedicated space for an appliance not easily moved from one place to another (behind clothes washer) A separate 20-amp circuit is required for the laundry equipment. The lights and other receptacles in the room
cannot be on that circuit [CEC 210(C)(2)]. All circuits supplying outlets or devices in the laundry area (including laundry areas in garages)must be AFCI protected [CEC210.12(A)]. Laundry Plumbing: Clothes washer standpipes must be 2-inchdiameter. Laundry Standpipe The weir of the trap must be roughed in 6 – 18 Laundry Standpipe inches above the floor; the standpipe must be a minimum of 18 and a maximum of 30 inches above the trap [CPC 804.1]. Laundry Mechanical: 18 – 30 in. Clothes dryers in closets require a minimum of 100 sq. in. of opening for makeup air,which can be supplied by louvers or undercutting the door [CMC 504.4.1]. Dryer ducts must be smooth-walled rigid metal at least 4-inch diameter and not more than 14 feet in length. Two 90° bends are allowed within the 14 ft. For 90° bend in excess of two, deduct 2 ft from allowed 14 ft length for each The Consumer Product Safety Commission additional bend [CMC 504.4.2.1]. (CPSC) estimates that up to 16,000 home Ducts may not pass through plenums or fires a year originate at clothes dryers. Exhaust Common causes of these fires are lint buildup be shared with other systems or vents. from improperly installed or maintained exhaust They cannot be connected with screws Ducts ducts. Ducts must be rigid metal. Screws that penetratethe duct interior [CMC should not penetrate the duct as they accumulate lint which leads to blockage. Join Dryer ducts must terminate on the ducts with the male end in thedirection of air building exterior in a backdraft damper. Screens or louvers cannot be installed [CMC 504.4]. Length 14 ft. maximum with up to 2 90° Flexible transition ducts (connectors) bends. Deduct 2 ft. for each additional 90°. between the dryer and metal duct are allowed in lengths up to 6 feet and cannot be concealed within construction [CMC **Backdraft Damper** 504.4.2.2 exception]. They must be UL

listed and labeled (L&L) as dryer

transition ducts, and, cannot be plastic.

Transition ducts

End outside & no screens

metal, listed &

labeled, & not

| | 10 0 10 20 (IN FEET) 1 inch = 10 ft. GRAPHIC SCALE |
|---|--|
| | |
| <u>LEGEND</u> | 0.14' O 1 |
| BOUNDARY — — — — — — — — — | |
| CENTERLINE — — — — — — — — | 0.26 PALMITA PARK 89.547 60D 0.15 "S"-MAPS-6 |
| EASEMENT — — — — — — — — — — — — — | 7.73' 11.97' 1 |
| SETBACK — — — — — — — — — — — — — — — — — — — | 75.00,000,000,000,000,000,000,000,000,000 |
| BASIS OF BEARINGS: THE BEARING NORTH 26°00'00" EAST, OF THE CENTERLINE OF CALDERON AVENUE, AS SHOWN ON THAT RECORD OF SURVEY FILED IN BOOK 935 AT PAGE 28, SANTA CLARA COUNTY RECORDS, WAS USED AS THE BASIS OF BEARINGS FOR THIS SURVEY. | LOT 32 LOT 33 LOT 35 107.96 107.96 107.96 107.96 107.96 107.97 107.97 107.97 107.97 107.97 107.97 107.97 107.97 107.97 108 109 107.97 108 107.97 108 108 107.97 108 108 107.35 107.36 108 107.36 108 107.36 |
| BENCHMARK: AN ELEVATION OF 97.020', OF A BRONZE DISK STAMPED "IV-29" SET IN THE TOP OF CURB AT THE NORTHWEST RETURN OF CALDERON AVENUE AND MERCY STREET WAS USED AS THE BENCHMARK FOR THIS SURVEY. NGVD88 DATUM | 0.27' 107.56 12.12' 0.77' 12.12' 12.1 |
| | LORETO STREET |

UNAUTHORIZED CHANGES & USES: The engineer preparing these plans will not be responsible for, or liable for, unauthorized changes to or uses of these plans. All changes to the plans must be in writing and must be approved by the preparer of these plans.


BOUNDARY MAN CONTRACTOR BLANCHESTER BLA

SHEET

JOB NO. 2927

GRADING NOTES


- 1. ALL WORK SHALL BE DONE IN ACCORDANCE WITH THE CITY STANDARD & SPECIFICATIONS AND THE SOILS REPORT FOR THIS SITE.
- 2. CONTRACTOR SHALL BE RESPONSIBLE FOR DETERMINING ACTUAL QUANTITIES TO HIS SATISFACTION.
- 3. CONTRACTOR SHALL CONFIRM THE GROUND ELEVATIONS AND OVERALL TOGRAPHY OF THE SITE PRIOR TO START OF WORK.
- 4. CONTRACTOR SHALL HOLD HARMLESS, INDEMNIFY AND DEFEND THE OWNER, THE ARCHITECT, THE ENGINEER AND HIS CONSULTANTS FROM ANY AND ALL LIABILITY CLAIMS, LOSSES OR DAMAGES ARISING OR ALLEGED TO ARISE FROM THE PERFORMANCE OF THE WORK DESCRIBED HEREIN.
- 5. ALL RAINWATER LEADERS SHALL BE DIRECTED TO SPASH BLOCK.
- 6. ALL DRAINAGE SHALL BE DIRECTED TO LANDSCAPE AREA.
- 7. ALL CONSTRUCTION ACTIVITIES SHALL ADHERE TO NEW DEVELOPMENT AND CONSTRUCTION BEST MANAGEMENT PRACTICES AS ADOPTED BY THE CITY FOR THE PURPOSES OF PREVENTING STORM WATER POLLUTION.
- STORM WATER MANAGMENT NOTES
- ALL DOWNSPOUTS SHALL BE DIRECTED TO LANDSCAPE AREAS.
- ALL CONSTRUCTION SHALL COMPLY WITH CITY'S URBAN RUNOFF POLLUTION PREVENTION PROGRAM.

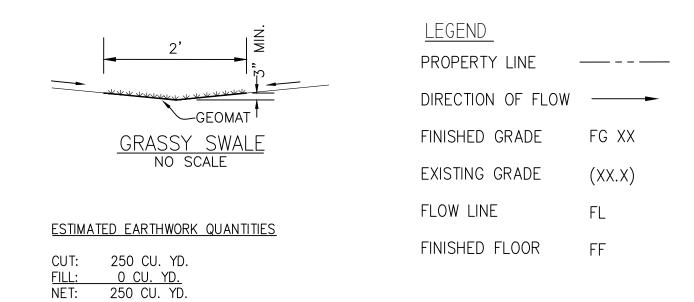

STREET CLEANING NOTE
THE PRIME CONTRACTOR OR DEVELOPER IS TO HIRE A STREET CLEANING CONTRACTOR TO CLEAN UP DIRT AND DEBRIS FROM CITY STREETS THAT ARE ATTRIBUTABLE TO THE DEVELOPMENT'S CONSTRUCTION ACTIVITIES. THE STREET CLEANING CONTRACTOR IS TO HAVE THE CAPABILITY OF SWEEPING THE STREETS WITH BOTH A BROOM-TYPE SWEEPER AND A REGENERATIVE AIR VACUUM SWEEPER, AS DIRECTED BY THE PUBLIC WORKS DIRECTOR OR DESIGNATED REPRESENTATIVE.

OCCUPANCY RELEASE NOTE

NO RESIDENTIAL UNITS WILL BE RELEASED FOR OCCUPANCY UNLESS THE IMPROVEMENTS TO BE CONSTRUCTED TO CITY STANDARDS AND/OR TO BE ACCEPTED FOR MAINTENANCE BY THE CITY, INCLUDING WATER METERS AND SANITARY SEWER CLEANOUTS AS WELL AS TRASH ROOMS AND/OR ENCLOSURES, ARE SUBSTANTIALLY COMPLETE PER THE CITY OF MOUNTAIN VIEW STANDARD PROVISIONS FOR PUBLIC WORKS CONSTRUCTION. THE PUBLIC WORKS DIRECTOR SHALL MAKE THE DETERMINATION OF WHAT PUBLIC IMPROVEMENTS ARE SUBSTANTIALLY COMPLETE.

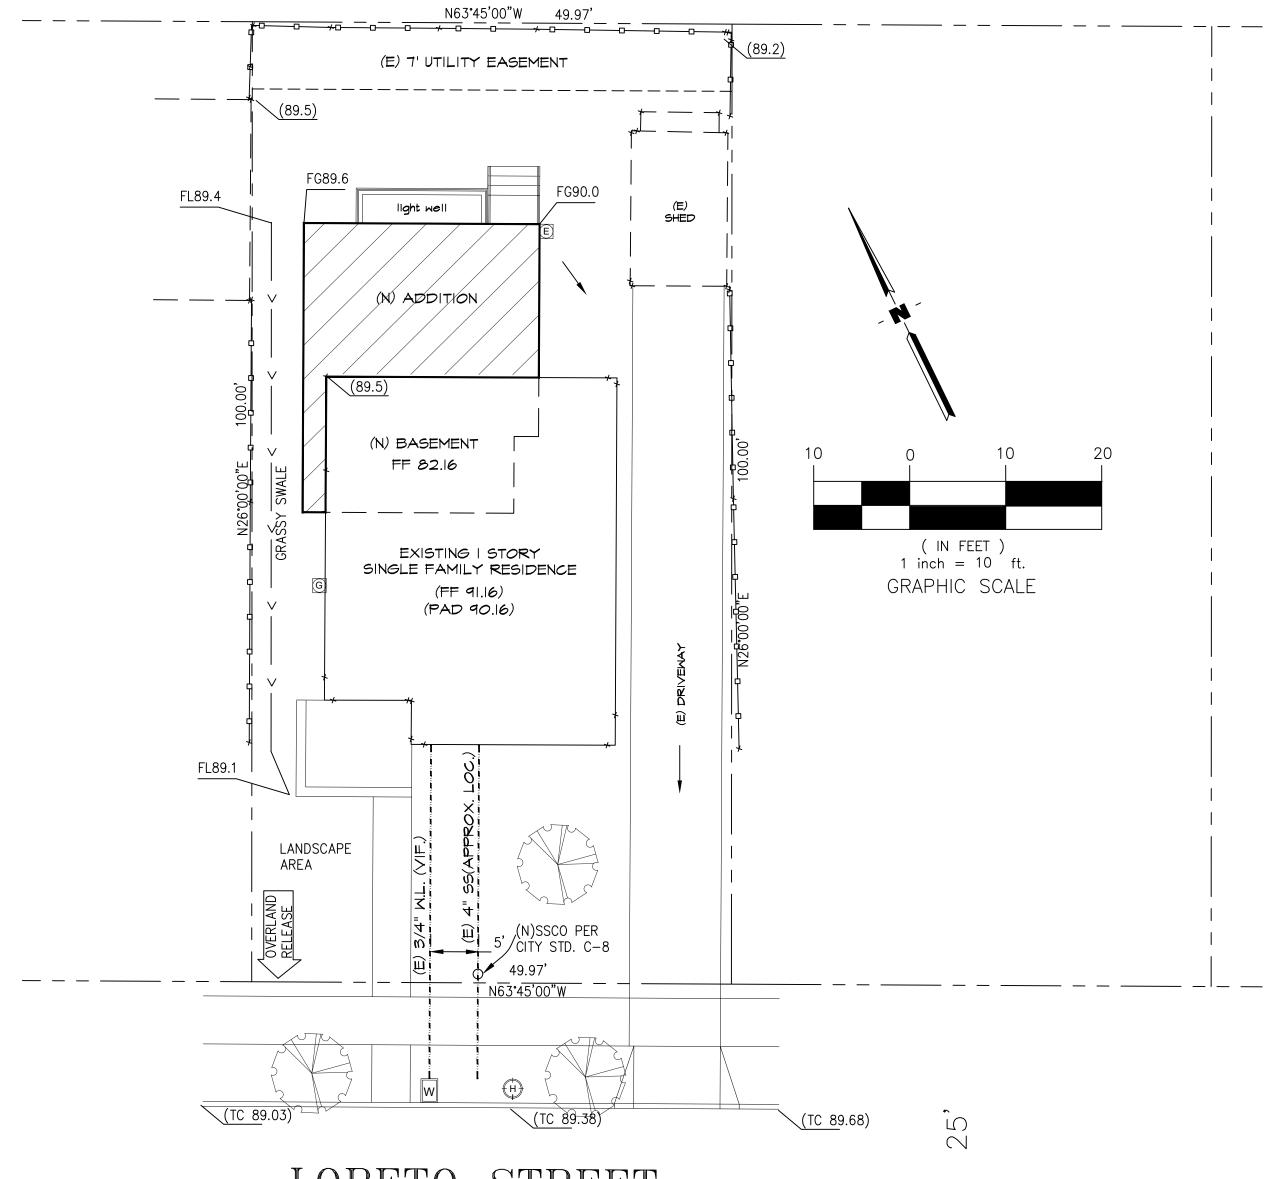

LORETO STREET

BENCHMARK:

AN ELEVATION OF 247.32', OF AN X SCRIBED IN THE SIDEWALK ALONG THE EASTERN ENTRANCE OF THE PROPERTY WAS USED AS THE BENCHMARK FOR THIS SURVEY. NGVD88 DATUM

SINGLE HOUSE

302 LORETO STREET MOUNTAIN VIEW, CA 94041

PROJECT

REMODEL/ **ADDITION**

AA HOME DESIGN & BUILD LLC

> DESIGN SERVICES

T: 408.431.2952 AA.HomeDesignBuild @gmail.com

SHEET TITLE

GRADING & DRAINAGE PLAN