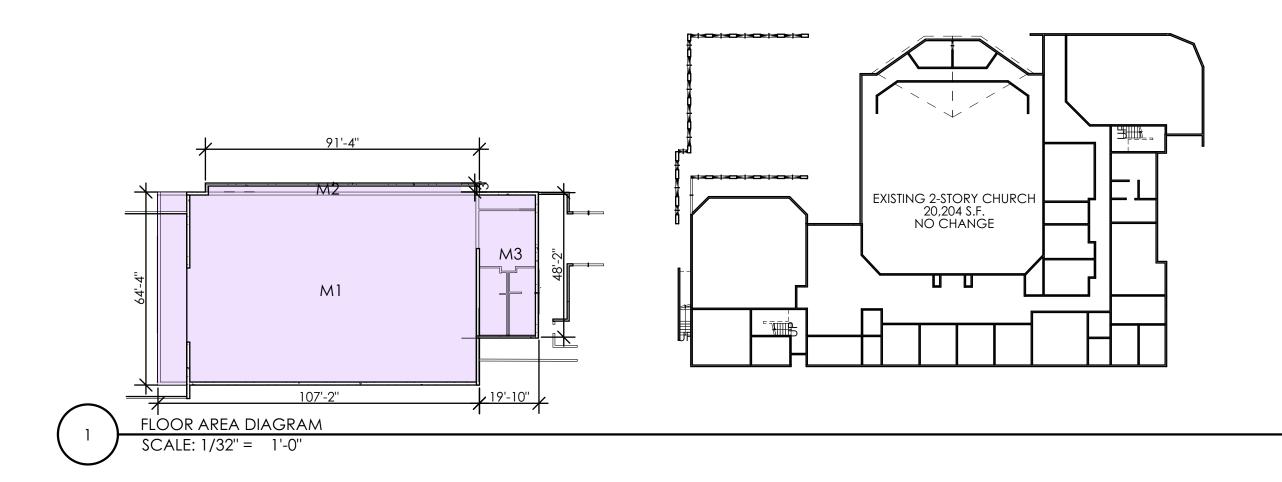
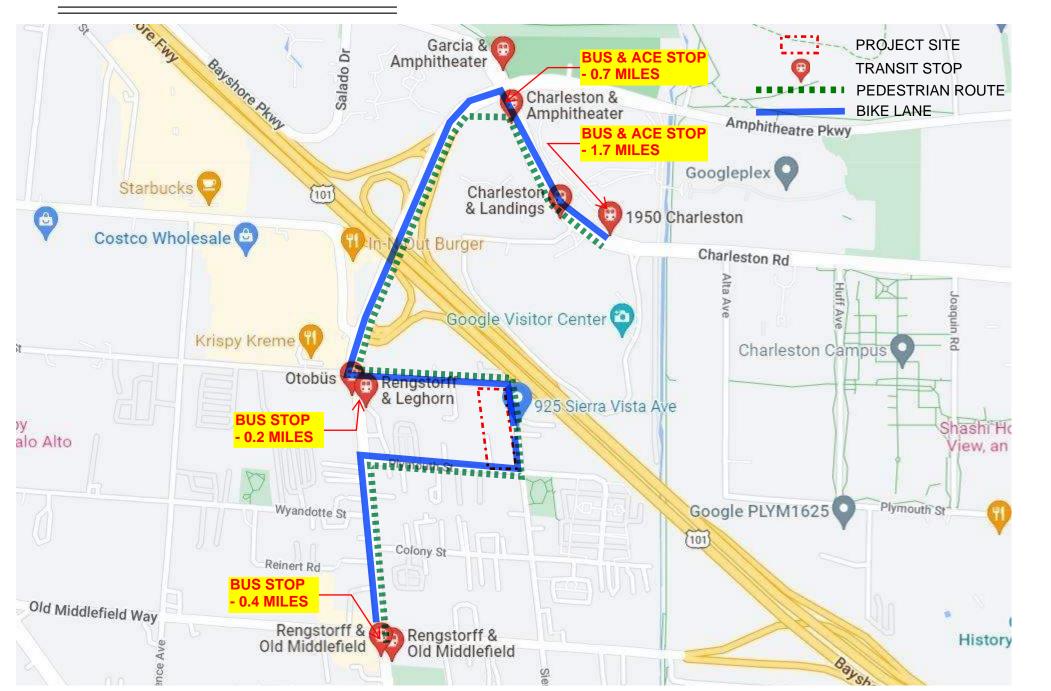
CHINESE CHURCH IN CHRIST MULTIPURPOSE GYM

920 Sierra Vista Avenue Mountain View, CA 94043

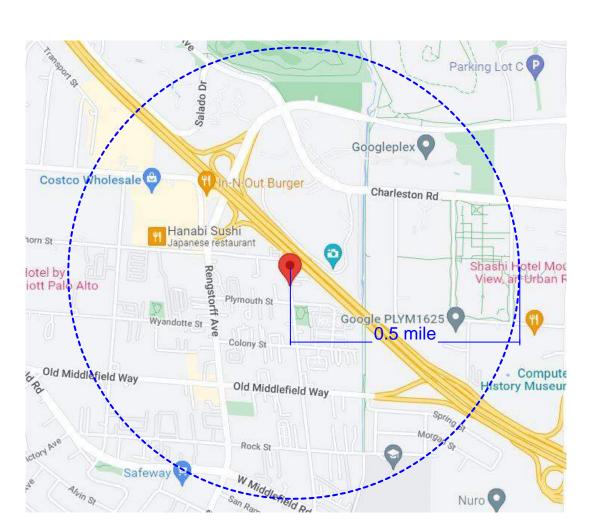
Element ID	Zone Name	Area
Detached Multi-Purpose Building	M1	6,894.43
Detached Multi-Purpose Building	M2	256.00
Detached Multi-Purpose Building	М3	955.52
	TOTAL FLOOR AREA:	8,105.96 S.F.



TRANSIT LINK TO STOPS



VICINITY MAP



GENERAL NOTES

- 1. ALL WORK SHALL BE PERFORMED TO COMPLY WITH ALL APPLICABLE CODES, ORDINANCES, REGULATIONS OR ORDERS OF PROPERLY CONSTITUTED AUTHORITIES HAVING JURISDICTION OVER THE WORK OF THIS PROJECT. THE CONTRACTOR SHALL EXAMINE THE CONTRACT DOCUMENTS FOR CONFORMANCE WITH THESE CODES AND REGULATIONS, AND SHALL PROMPTLY NOTIFY THE ARCHITECT OF ANY DISCREPANCIES.
- WRITTEN DIMENSIONS SHALL TAKE PRECEDENCE; DRAWINGS ARE NOT TO BE SCALED. ALL DIMENSIONS AND EXISTING SITE CONDITIONS TO BE VERIFIED IN THE FIELD AND ANY DISCREPANCIES SHALL BE BROUGHT TO THE ATTENTION OF THE ARCHITECT PRIOR TO THE COMMENCEMENT OF ANY WORK.
- 3. CONTRACTOR SHALL VERIFY THE LOCATION OF ALL UTILITIES PRIOR TO START OF CONSTRUCTION. UTILITIES AFFECTED BY CONSTRUCTION SHALL BE PROTECTED OR CAPPED OFF IN ACCORDANCE WITH APPLICABLE CODES AND UTILITY COMPANIES.

PLUMBING FIXTURE CALCULATION

USE PERMIT RESTRICTS NUMBER OF PEOPLE ON SITE TO 350.

REQUESTING CONSIDERATION UNDER TABLE 422.1, NOTE 6 UP TO 400 OCCUPANTS TOTAL 200 MALE/200 FEMALE

2022 CPC TABLE 422.1, A-3 OCCUPANCY: MALE: 2 WC, 2 URINALS, 1 LAVS FEMALE: 4 WC, 2 LAVS

PROPOSED:

MALE: 2 WC, 2 URINALS, 2 LAVS FEMALE: 4 WC, 2 LAVS

PROJECT TEAM

ARCHITECT:

4633 OLD IRONSIDES DR. SUITE 130 SANTA CLARA, CA 95054 CYNTHIA MUNOZ 650.965.3500 CYNTHIA@STOECKERANDNORTHWAY.COM

LANDSCAPE ARCHITECT/ARBORIST: HMH

1570 OAKLAND ROAD SAN JOSE, CA 95131 CALANDRA MONASTERIO CMONASTERIO@HMHCA.COM

CIVIL ENGINEER: **BKF ENGINEERS**

255 SHORELINE DRIVE, SUITE 200 REDWOOD CITY, CA 94065 MIKE O'CONNELL MOCONNELL@BKF.COM

TRAFFIC CONSULTANT: HEXAGON TRANSPORTATION CONSULTANTS 100 CENTURY CENTER COURT, SUITE 501 SAN JOSE, CA 95112 GARY BLACK GBLACK@HEXTRANS.COM

BUILDING CODE ANALYSIS

- 1. PER 2022 CBC CHAPTER 5 TABLE 504.3: ALLOWABLE BUILDING HEIGHT IN TYPE V-B CONSTRUCTION: - OCCUPANCY A SPRINKLER = 60' -> PROPOSED HEIGHT: 39'-11 1/2" MAX FROM LOWEST ADJACENT CURB
- 2. PER 2022 CBC CHAPTER 5 TABLE 504.4: ALLOWABLE NUMBER OF STORIES ABOVE GRADE IN TYPE V-B CONSTRUCTION: - OCCUPANCY A SPRINKLER W/O AREA INCREASE = 2 STORIES -> PROPOSED: 1 STORY
- 3. PER 2022 CBC CHAPTER 5 TABLE 506.2: ALLOWABLE AREA FOR TYPE V-B CONSTRUCTION: - OCCUPANCY A-3 SPRINKLERED BUILDING
- S1= 24,000 S.F
- SM without height increase = 18,000 S.F. -> PROPOSED FIRST FLOOR: 13,540 S.F. EXISTING CHURCH 8,106 S.F. NEW BUILDING TOTAL FIRST FLOOR: 21,646 S.F.
- 4. PER 2022 CBC CHAPTER 7 TABLE 705.5: REQUIRED FIRE-RESISTANCE RATING FOR EXTERIOR WALLS BASED ON FIRE SEPARATION DISTANCE 10'<X<30' IS 0 HOUR FOR VB CONSTRUCTION, A OCCUPANCIES 5'<X<10' IS 1 HOUR RATED FOR VB CONSTRUCTION, A OCCUPANCIES -> PROPOSED MINIMUM SETBACK: 8'-11'
- 5. PER 2022 CBC CHAPTER 7 TABLE 705.8: MAXIMUM AREA OF EXTERIOR WALL OPENINGS BASED ON FIRE SEPARATION DISTANCE AND DEGREE OF OPENING PROTECTION: 5 TO LESS THAN 10 FEET: 25% ALLOWABLE,UNPROTECTED/SPRINKLERED 30 OR GREATER FEET: UNLIMITED

SHEET INDEX

A0	COVER SHEET
Al	AERIAL PHOTO PLAN
A2	STREETSCAPES
SU-1	SITE SURVEY
A3	SITE DEMO PLAN
A4	PROPOSED SITE PLAN
A5	RENDERINGS
A6	RENDERINGS
A7	PROPOSED FIRST FLOOR PLAN
A8	BASEMENT PARKING LEVEL
A9	PROPOSED ROOF PLAN
A10	FIRST FLOOR OCCUPANT/EXIT ANALYSIS
A11	BASEMENT OCCUPANT/EXIT ANALYSIS
A12	PROPOSED ELEVATIONS
A13	PROPOSED ELEVATIONS
A14	SECTIONS
A15	SITE SECTION & ACCESSORY STRUCTURE
A16	LANDSCAPE, PAVEMENT & OPEN SPACE CALCULATIONS
A17	MATERIALS PALETTE
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GB-1	GREEN BUILDING POINT CHECKLIST
LE1	LIGHTING PLAN
C1.00	CIVIL TITLE SHEET
C1.01	GENERAL NOTES
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C1.02	GENERAL NOTES
C2.00	EXISTING CONDITIONS & DEMOLITION PLAN
C3.00	GRADING PLAN
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C4.00	UTILITY PLAN
C4.01	UTILITY PLAN
C5.00	STORMWATER MANAGEMENT PLAN
C5.01	STORMWATER DETAILS
C6.00	FIRE TRUCK TURNING PLAN
C6.01	TRASH TRUCK TRUNING PLAN
C7.00	CONSTRUCTION DETAILS
LO	LANDSCAPE TITLE SHEET
L1	TREE PROTECTION & MITIGATION PLAN
L2	TREE PROTECTION DETAIL
L3	LANDSCAPE PLAN
L4	CONCEPT DETAILS
L5	IRRIGATION/HYDROZONE PLAN
L6	IRRIGATION DETAILS
L7	PLANTING PLAN
_, L8	PLANTING PALETTE
L9	PLANTING DETAILS
L10	EXISTING TREE CANOPY PLAN
	-

STOECKER AND NORTHWAY ARCHITECTS, INC.

TOTAL SECOND FLOOR (EXISTING CHURCH): 6,664 S.F.

PROJECT DATA	
PROJECT DESCRIPTION: CONSTRUCTION OF A NEW 8,106 PURPOSE/GYMNASIUM BUILDING, INCLUDING A BASEMEN BUILDING.	
PROPOSED BUILDING AREA - 8,106 S.F. BASEMENT PARKING LEVEL - 7,294 S.F.* *MORE THAN 1/2 HEIGHT BELOW GRADE, NOT COUNTED A	S FAR PER SEC. 36.08.35
ZONE: 920 SIERRA VISTA AVE: R3-2sd / MM-40 1960 PLYMOUTH ST: R3-2sd	

FLOOD ZONE: AO(1) & AO(2) GENERAL PLAN DESIGNATION: 920 SIERRA VISTA AVE: MEDIUM-DENSITY RESIDENTIAL (13-25 DU/AC) & GENERAL INDUSTRIAL 1960 PLYMOUTH ST: MEDIUM-DENSITY RESIDENTIAL (13-25 DU/AC) ASSESSOR'S PARCEL NUMBERS: 920 SIERRA VISTA AVE: 153-02-038 1960 PLYMOUTH ST: 153-02-006 CONSTRUCTION TYPE: V-B WITH SPRINKLER SYSTEM 2 OCCURANCY GROUPS: A-3 ASSEMBLY (GYMNASIUM/PLACES OF WORSHIP) STORIES: ONE WITH BASEMENT

920 SIERRA VISTA AVE: 66,355 S.F. (SPLIT ZONING: R3-2sd/MM-40) (R3-2sd PORTION = 32,545 S.F. ; MM-40 PORTION= 33,810 S.F.) 1960 PLYMOUTH ST: 17,550 S.F. (R3-2sd) TOTAL LOT AREA COMBINED: 66,355 + 17,550 = 83,905 S.F. = 1.92 ACRE DATA FOR R3-2sd ZONE: (LOT AREA: 32,545 + 17,550 = 50,095 S.F.)

ALLOWABLE FAR FOR R3-2sd 50,095 S.F. x 1.05 = 52,600 S.F EXISTING FLOOR AREA: 13,540 S.F. FIRST FLOOR + 6,664 S.F. SECOND FLOOR TOTAL EXISTING: 20,204 S.F. ROPOSED FAR FOR R3-2sd: XISTING CHURCH FLOOR AREA: 20,204 S.F. <u>35 S.F. (overlap of new bldg onto R3-2sd)</u> 20.239 S.F. (0.40 FAR) NEW FLOOR AREA:

ALLOWABLE LOT COVERAGE FOR R3-2sd: 50,095 S.F. x 0.35 = 17,533 S.F. EXISTING LOT COVERAGE: 13,870.9 S.F. PROPOSED LOT COVERAGE FOR R3-2sd: see sheet A14 EXISTING TRASH ENCLOSURE TO BE REMOVED: 210.4 S.F EXISTING STRUCTURES TO REMAIN: 13,660.5 S. 1.3 660 5 S F

PROPOSED ADDITION: 35 S.F. (overlap of new bldg onto NEW TRASH ENCLOSI <u>261.8 S.F.</u> 13,957.3 S.F. = 27.8% REAR: 15'

HEIGHT LIMIT : 45' MAX. & 36' MAX. TO TOP OF PLATE PROPOSED HEIGHT: 39' 11-1/2" FROM LOWEST ADJACENT CURB 33'-5 1/2" TO TOP OF PLATE FROM LOWEST ADJACENT CURB DATA FOR MM-40: (LOT AREA: 33,810 S.F.)

ALOWABLE FAR FOR MM-40: 33,810 S.F. x 0.35 = 11,833.5 S.F. EXISTING FLOOR AREA: 0 S.F. ROPOSED FLOOR AREA:

*7,294 S.F. BASEMENT PARKING LEVEL NOT COUNTED AS FAR, MORE THAN 1/2 HEIGHT BELOW GRADE ALLOWABLE LOT COVERAGE FOR MM-40 33,810 S.F. x 0.35 = 11,834 S. EXISTING LOT COVERAGE: 0 S.F

8,106 S.F. - 35 S.F. (PORTION THAT OVERLAPS ONTO R3-2sd)

REQUIRED SETBACKS: FRONT: 25' SIDE: 0' REAR:0' HEIGHT LIMIT : MAX. 50 FT.

PROPOSED HEIGHT: 39' 11-1/2" FROM LOWEST ADJACENT CURB

<u>2LICABLE CODES:</u> 22 CRC/CBC, 2022 CFC, 2022 CPC, 2022 CMC, 2022 CEC PART 3, 2022 CENC PART 6 & 2022 CGBSC AS AMENDED BY LOCAL JURISDICTION. PER CITY OF MOUNTAIN VIEW REACH CODE, NO GAS APPLIANCES WILL BE INSTALLED IN THE PROPOSED BUILDING.

8,106 S.F

PARKING ANALYSIS: EXISTING PARKING: 102 SPACES, PARKING REDUCTION ALLOWED PER 200-04-UPA $^{>}$ Parking required for existing church without parking reduction: 20,204 s.f./170 = $^{<}$ ≻119 SPACES

PROPOSED MULTI-PURPOSE/GYM BUILDING: 8,106 S.F. PARKING REQUIRED: 48 SPACES

≻* PARKING REDUCTION REQUESTED BASED ON SHARED PARKING REDUCTION ARRANGEMENT. SEE OPERATIONAL SUMMARY AND PARKING REDUCTION REQUEST LETTER FOR PROPOSED STAGGER OF BUILDING USES.

TOTAL PARKING SPACES PROPOSED: 119 UNASSIGNED ≻95 SURFACE SPACES + 24 BELOW GRADE SPACES

INCLUDES 5 ACCESSIBLE & EV STALLS

EV PARKING: 19 EVCS STALLS AND 57 EV CAPABLE STALLS PER MV CITY CODE TABLE A5.106.5.3.2 -INCLUDING 1 LEVEL 3/DC FAST CHARGE, 1 EVCS @ VAN ACCESSIBLE PARKING SPACE & 1 EVCS @ STANDARD ACCESSIBLE PARKING SPACE PER 2022 CBC TABLE 11B-228.3.2.1 REQUIRED BICYCLE PARKING: 167 X 5% = 9 SPACES

> 9 x 20% FOR I CLASS (EMPLOYEES) = 1.8 -> 2 > 9 x 80% FOR II/III CLASS (VISTORS) = 7.2 -> 8

PROVIDED BIKE PARKING: BIKE STORAGE FOR I CLASS = 1 LOCKER FOR 2 BIKES >BIKE RACH FOR II/III CLASS = 4 RACKS FOR 8 BIKES

REVISIONS ese plans are copyrighted and are subject to copyrig protection as an "architectural work" under sec. 102 of the Copyright Act, 17 U.S.O. as amended December 1990 and known as Architectural Works Copyright Protection Act o 1990. The protection includes but is not limited to the verall form as well as the arrangement and compo of spaces and elements of the design. Under such protection, unguthorized use or alteration of these r work or project represented, can legally result in the cessation of construction or buildings being seized and/ onetary compensation to Stoecker and North Architects Inc. toecker + northwe architects 465 Fairchild Drive, Ste.121 Mountain View, CA 94043 650.965.3500 www.stoeckerandnorthway.com Z

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SHEET TITLE COVER SHEET

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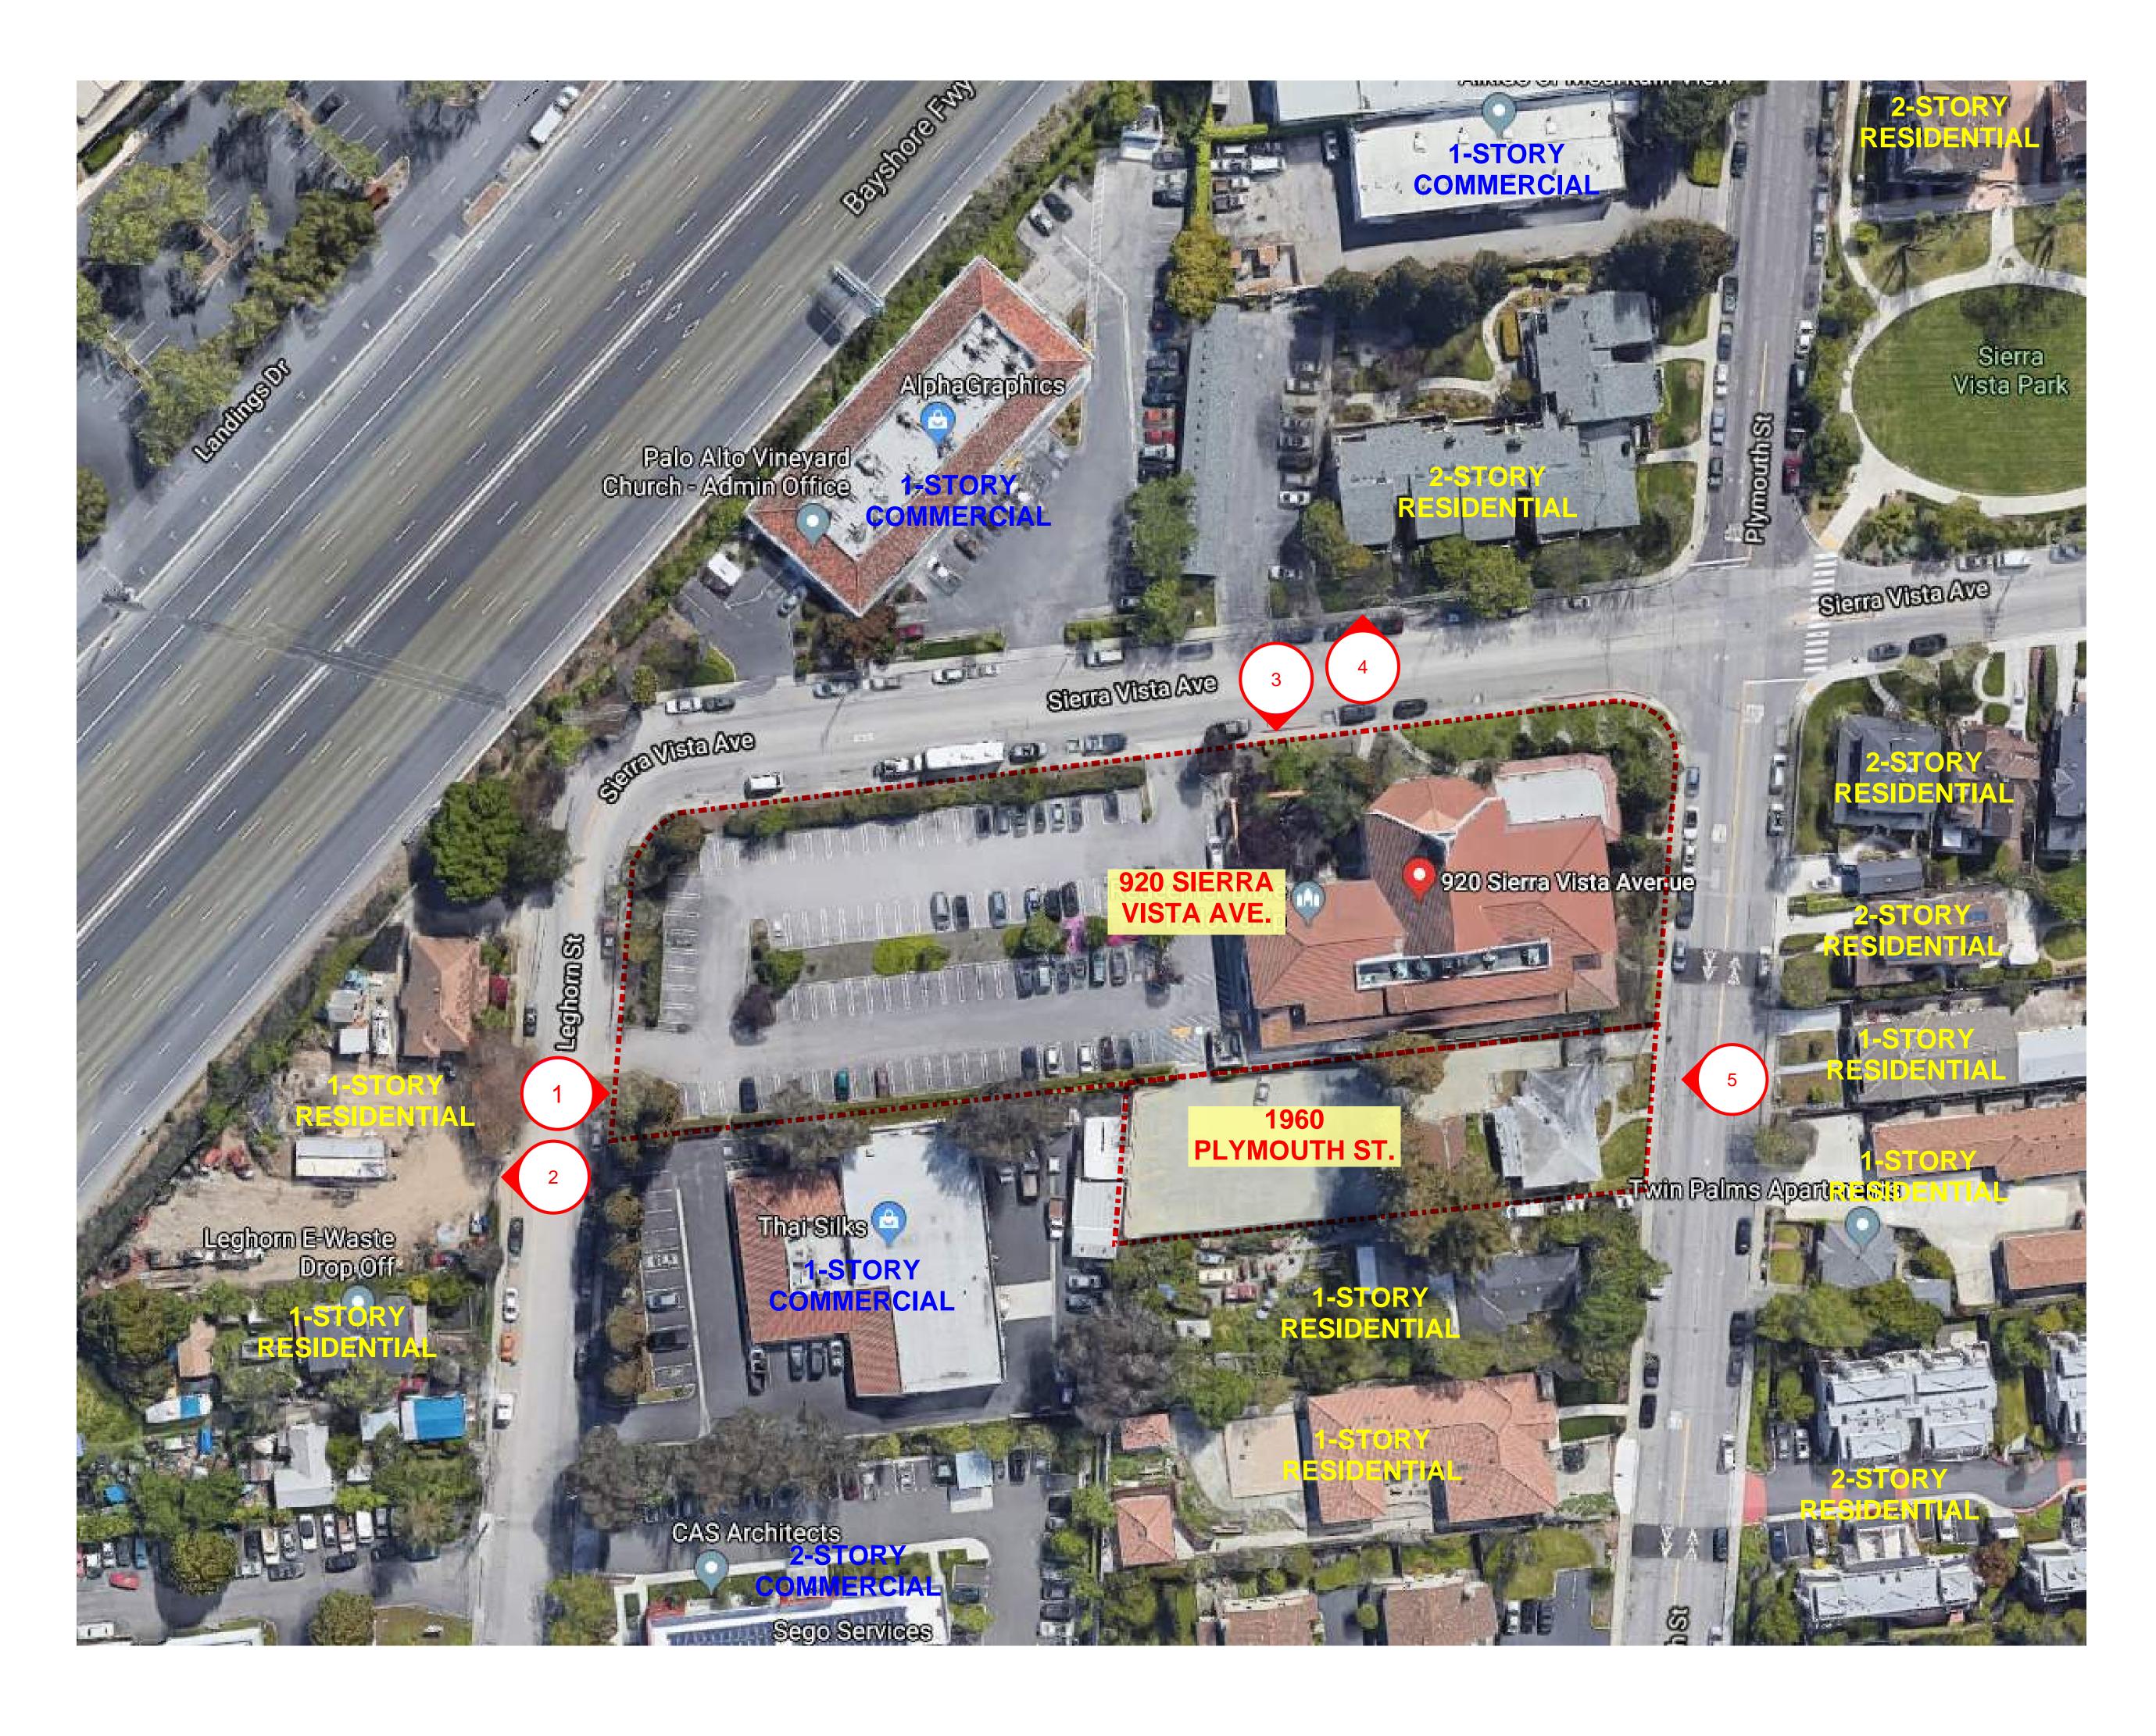
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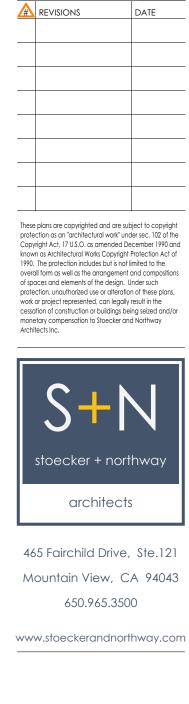
BLDG AREA THAT OVERLAPS ONTO R3-2sd TOTAL PROPOSED: <u>35 S.F.</u> 8,071 S.F. (0.24)

PROPOSED LOT COVERAGE FOR MM-40: TOTAL: 8,071 S.F. = 24%

33'-5 1/2" TO TOP OF PLATE FROM LOWEST ADJACENT CURB







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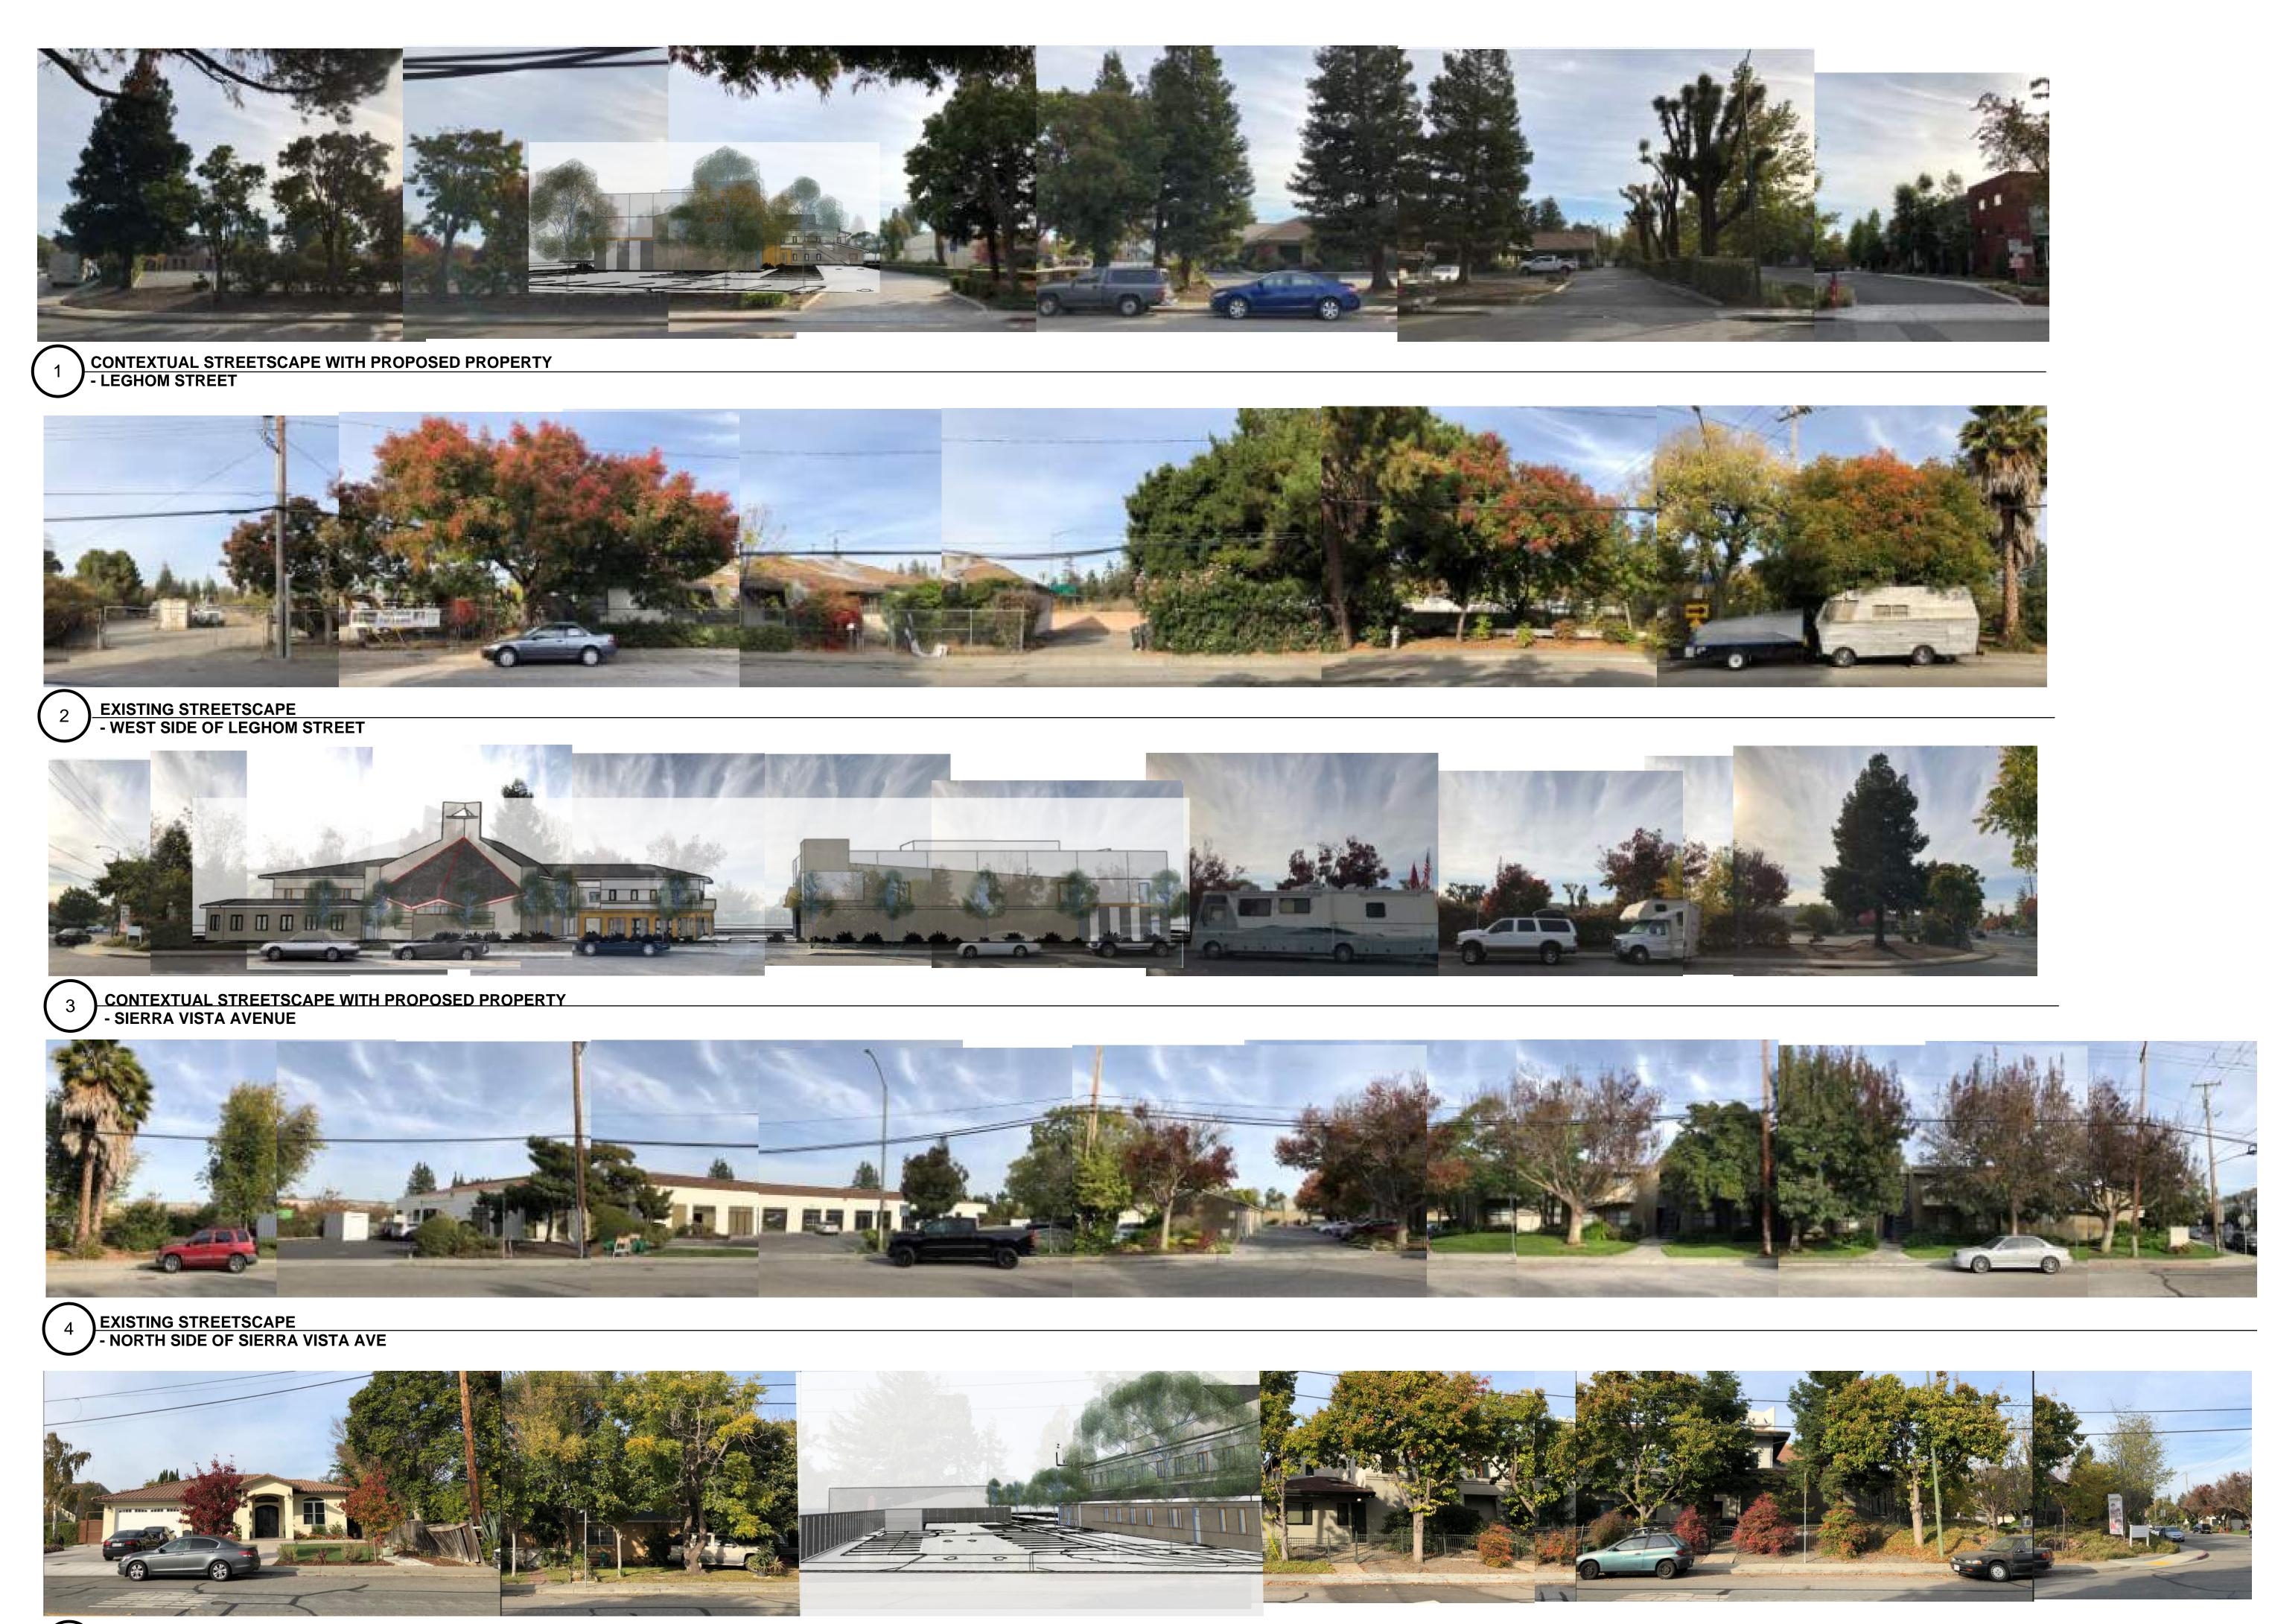
SHEET TITLE AERIAL PHOTO PLAN

SCALE

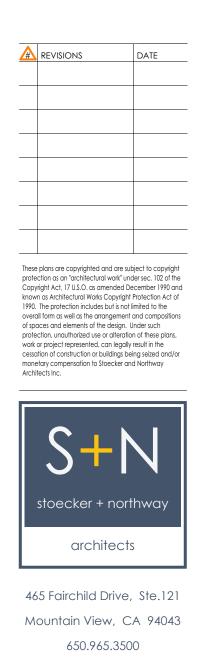
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EXISTING STREETSCAPE WITH PROPOSED PROPERTY - NORTH SIDE OF PLYMOUTH STREET 5



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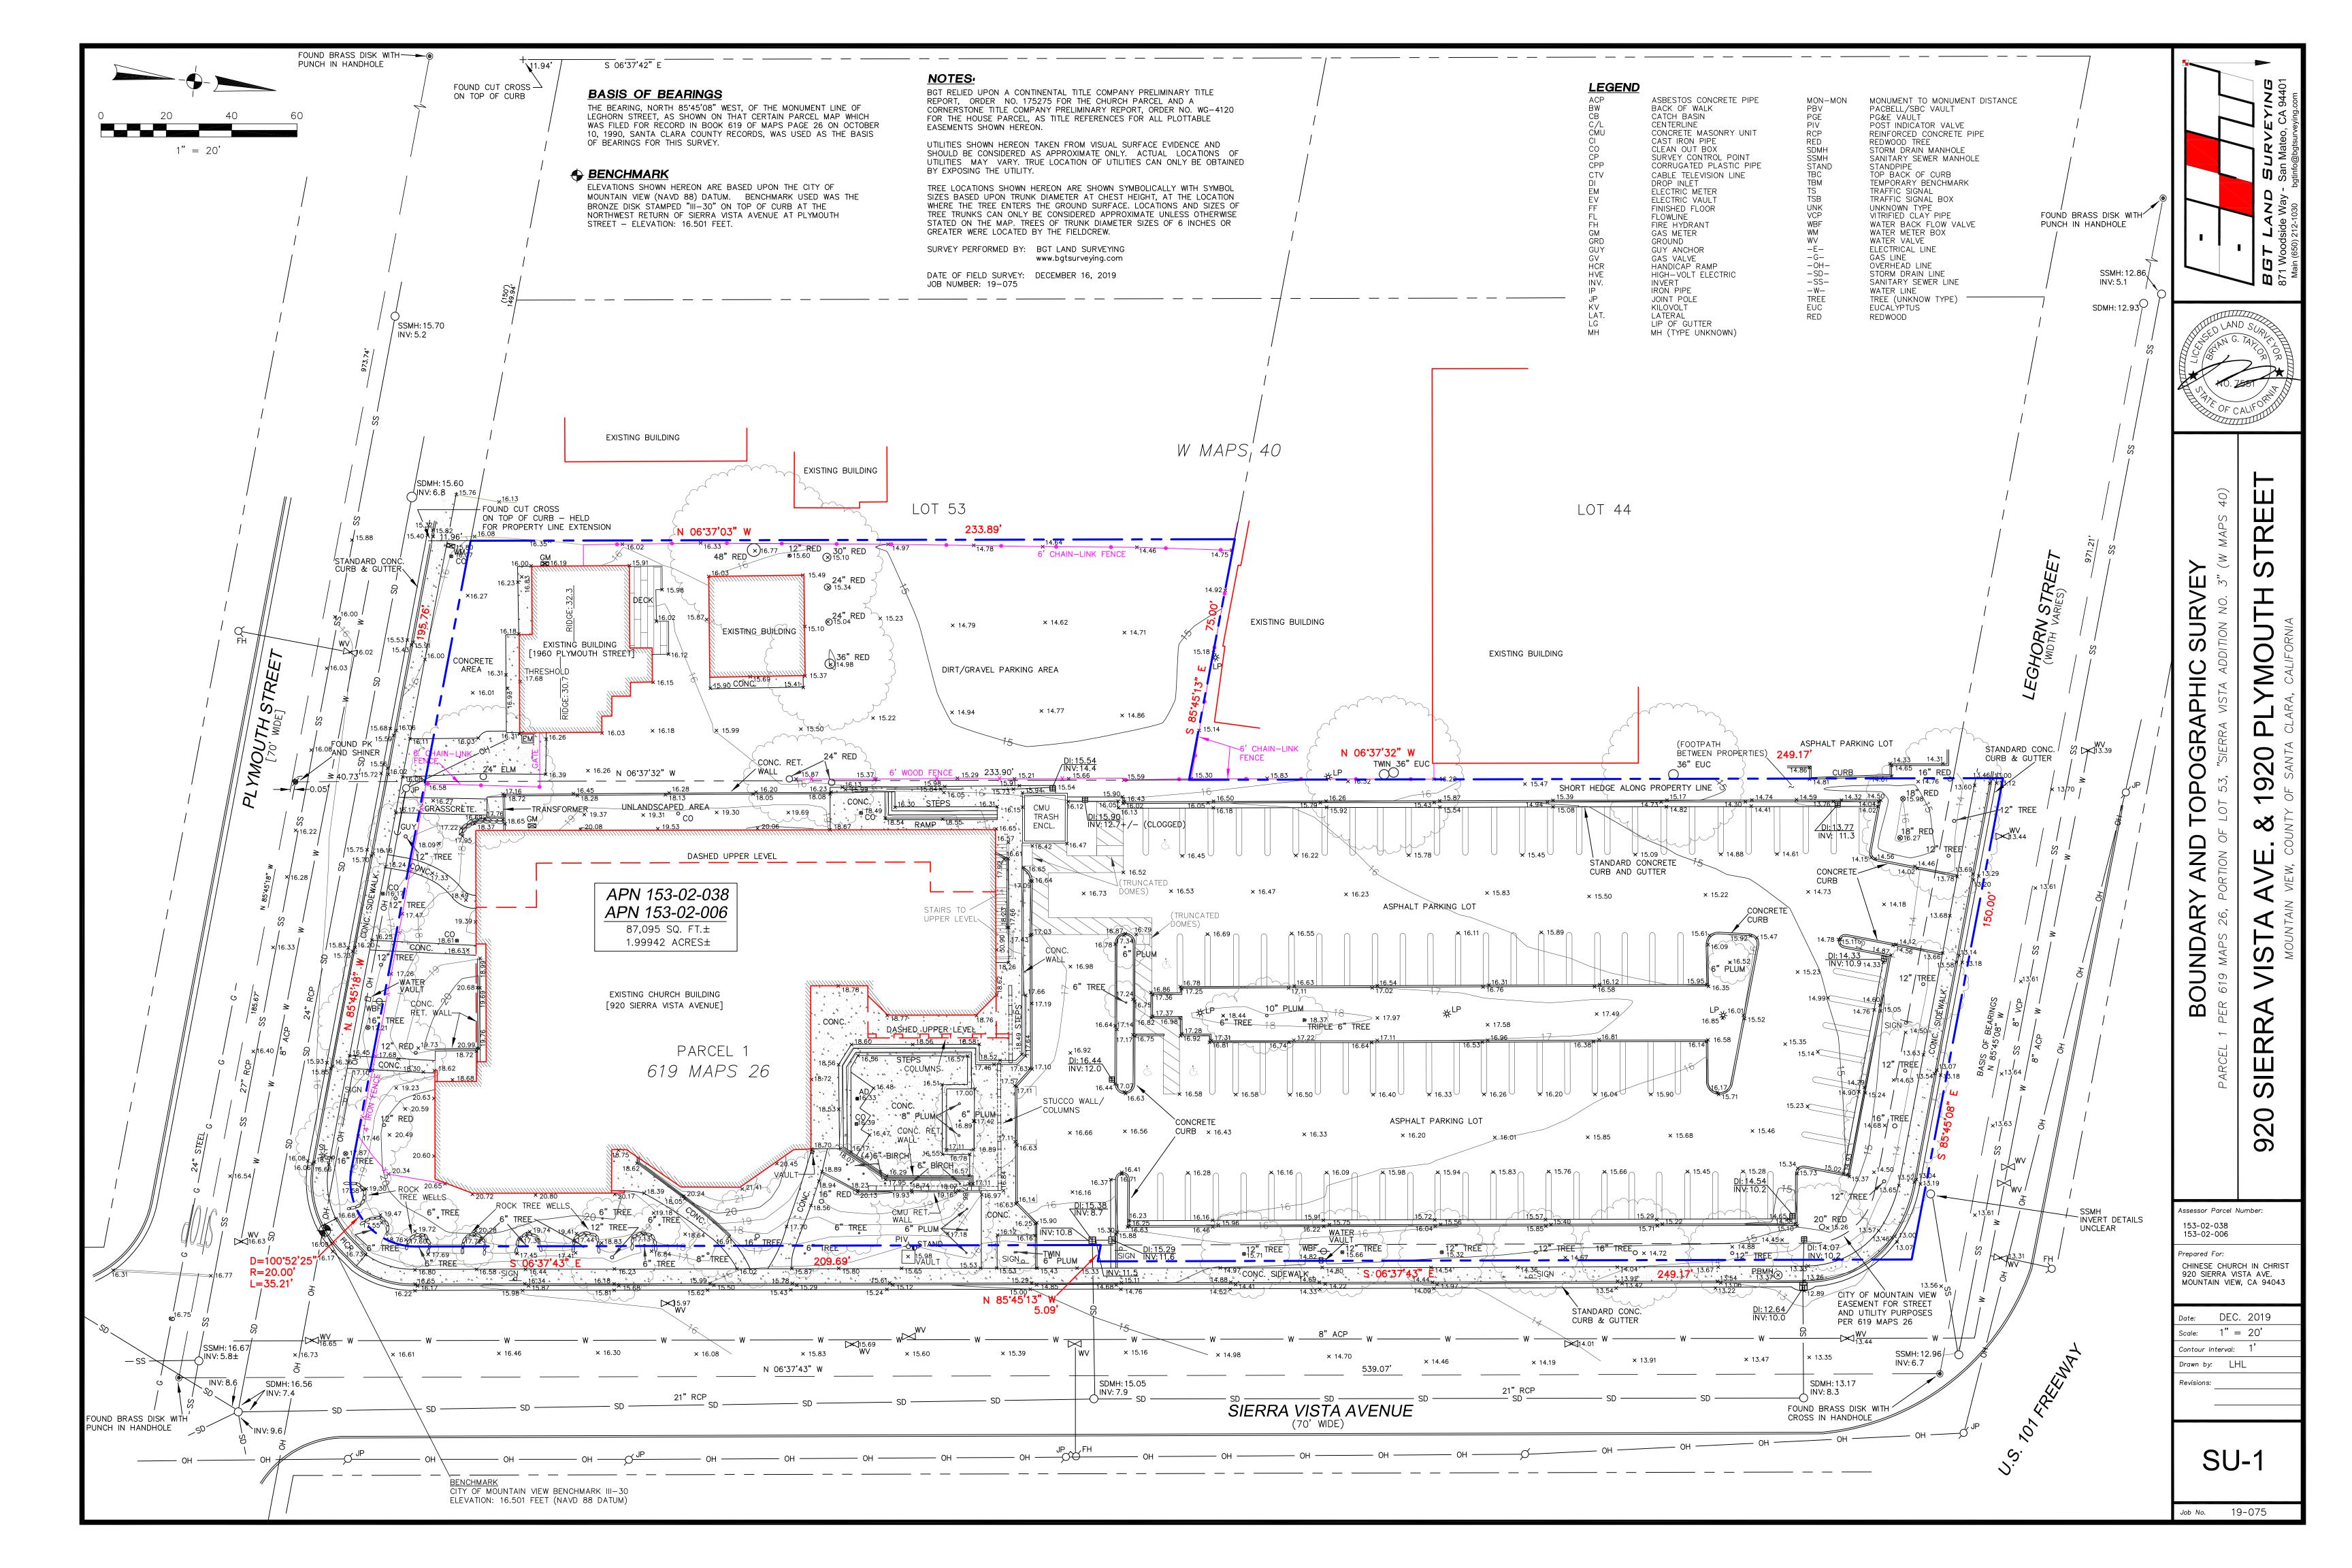
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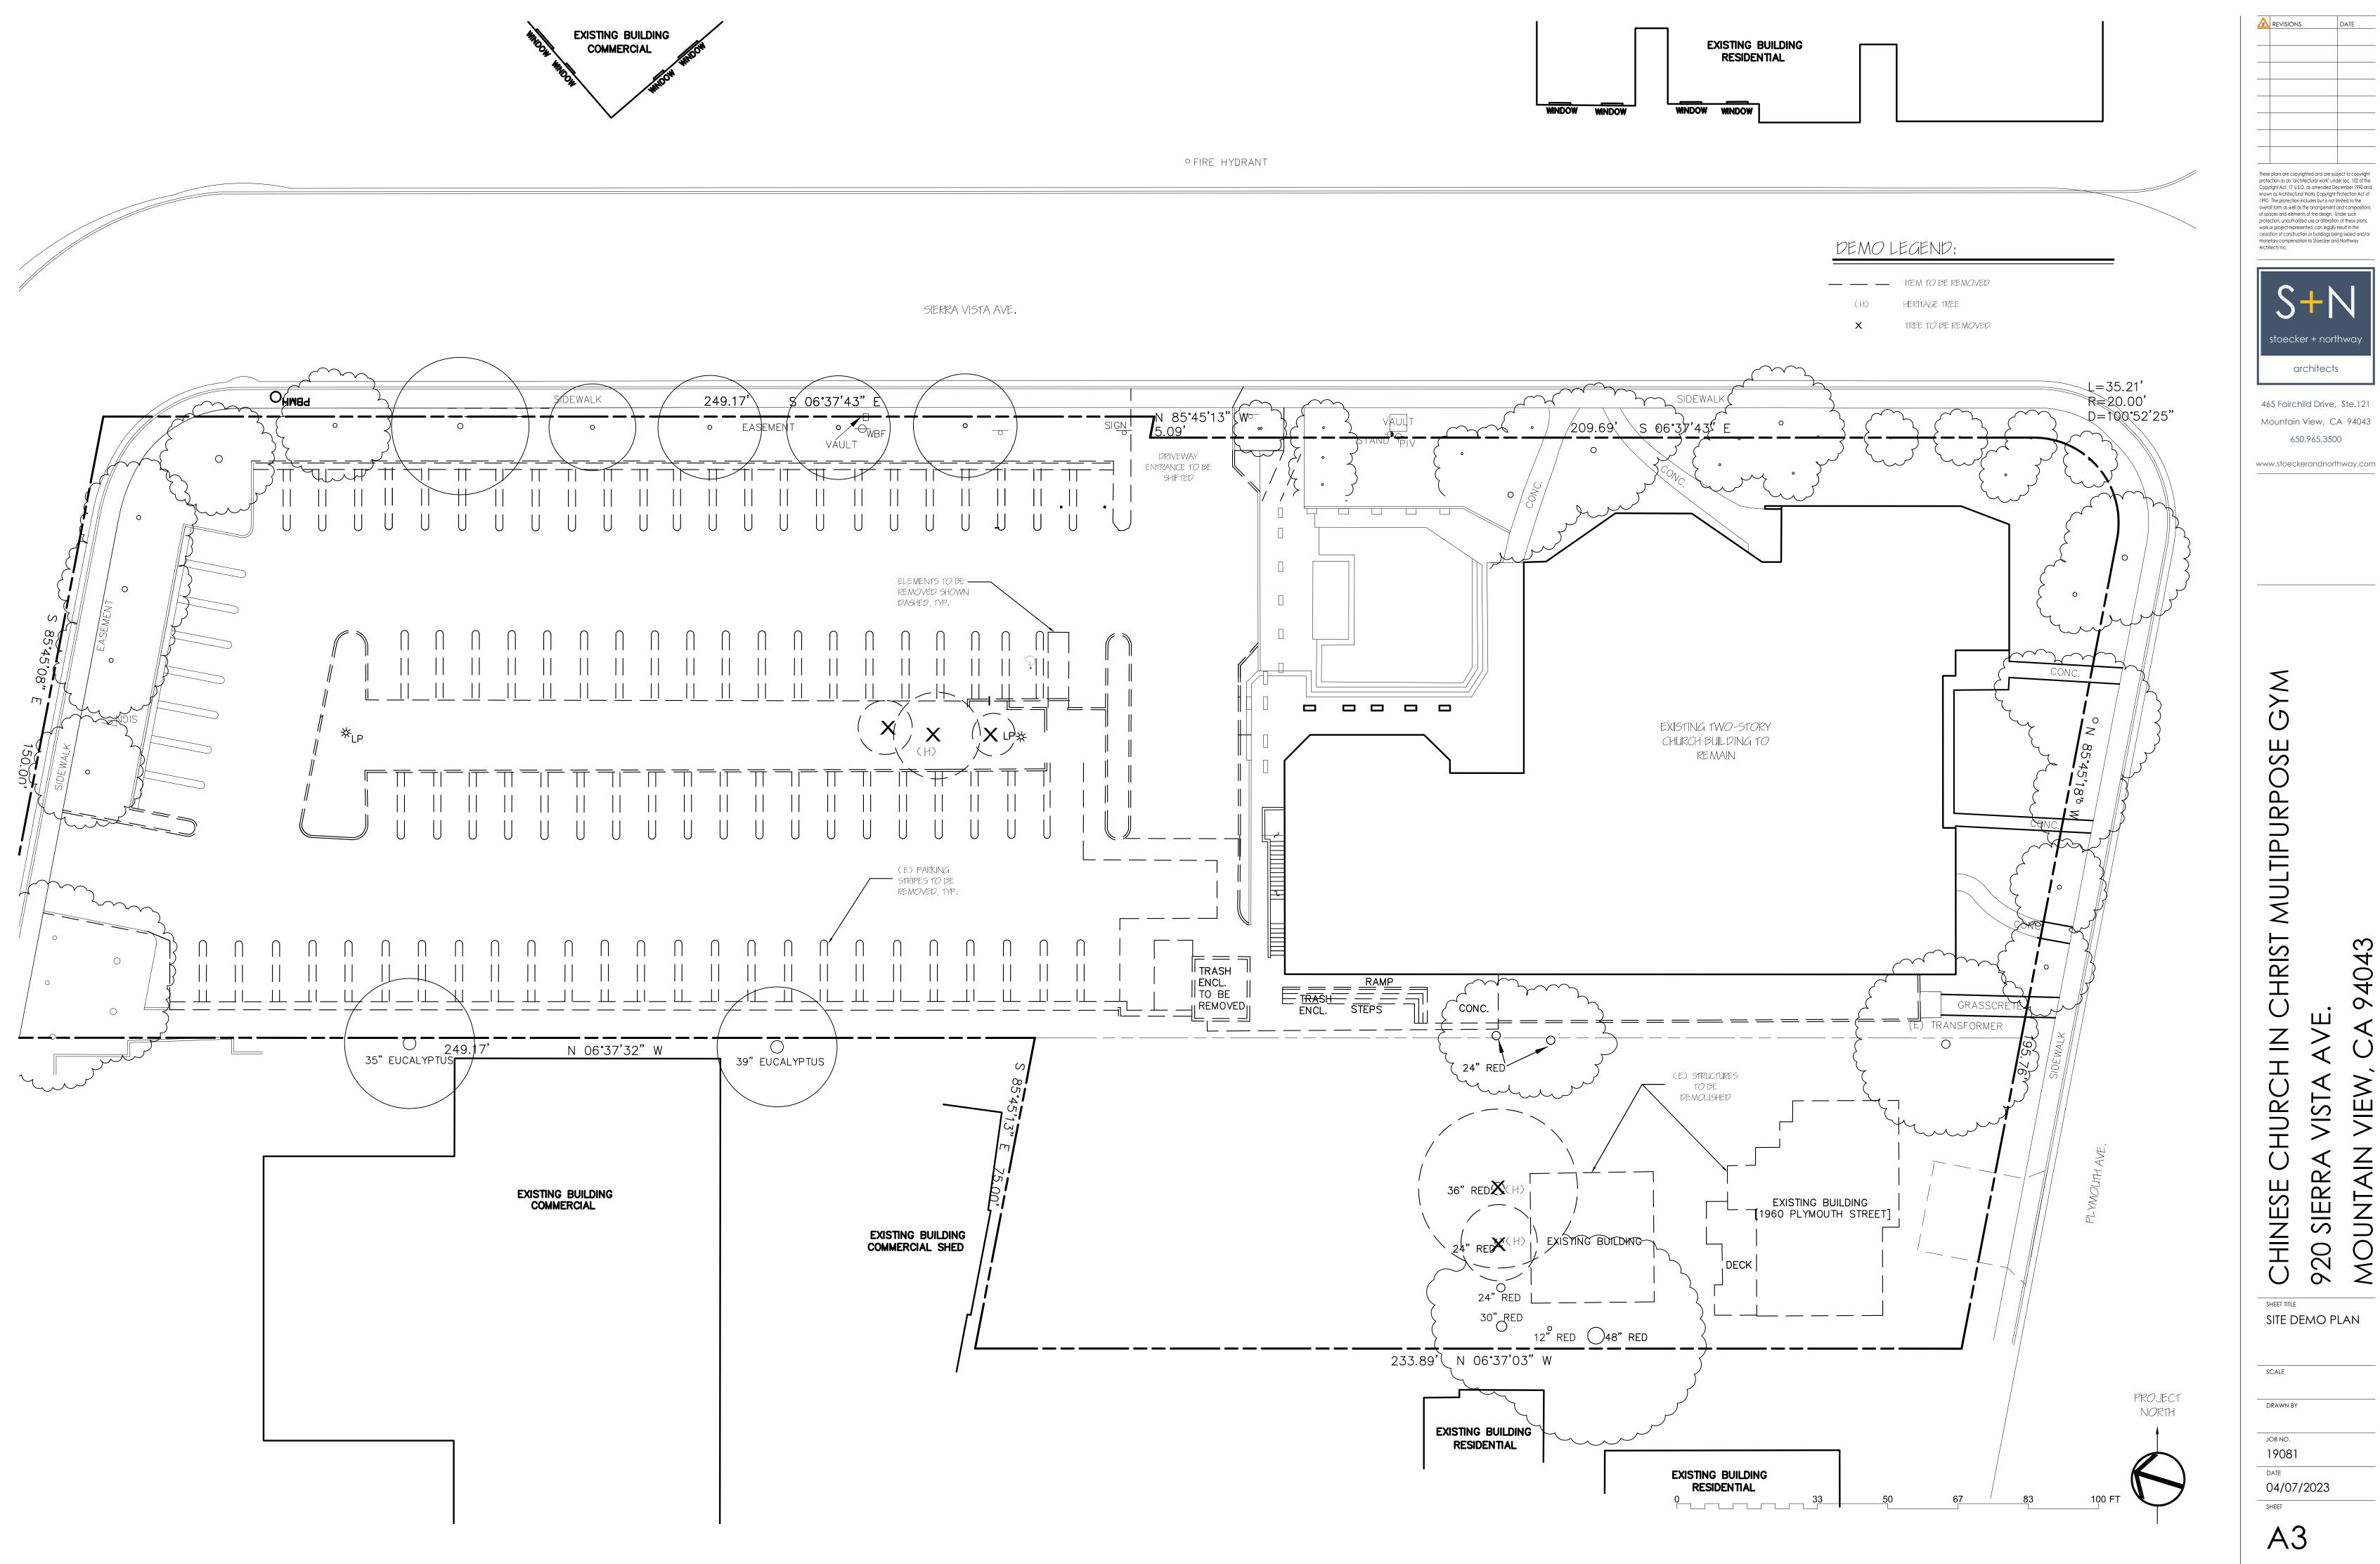
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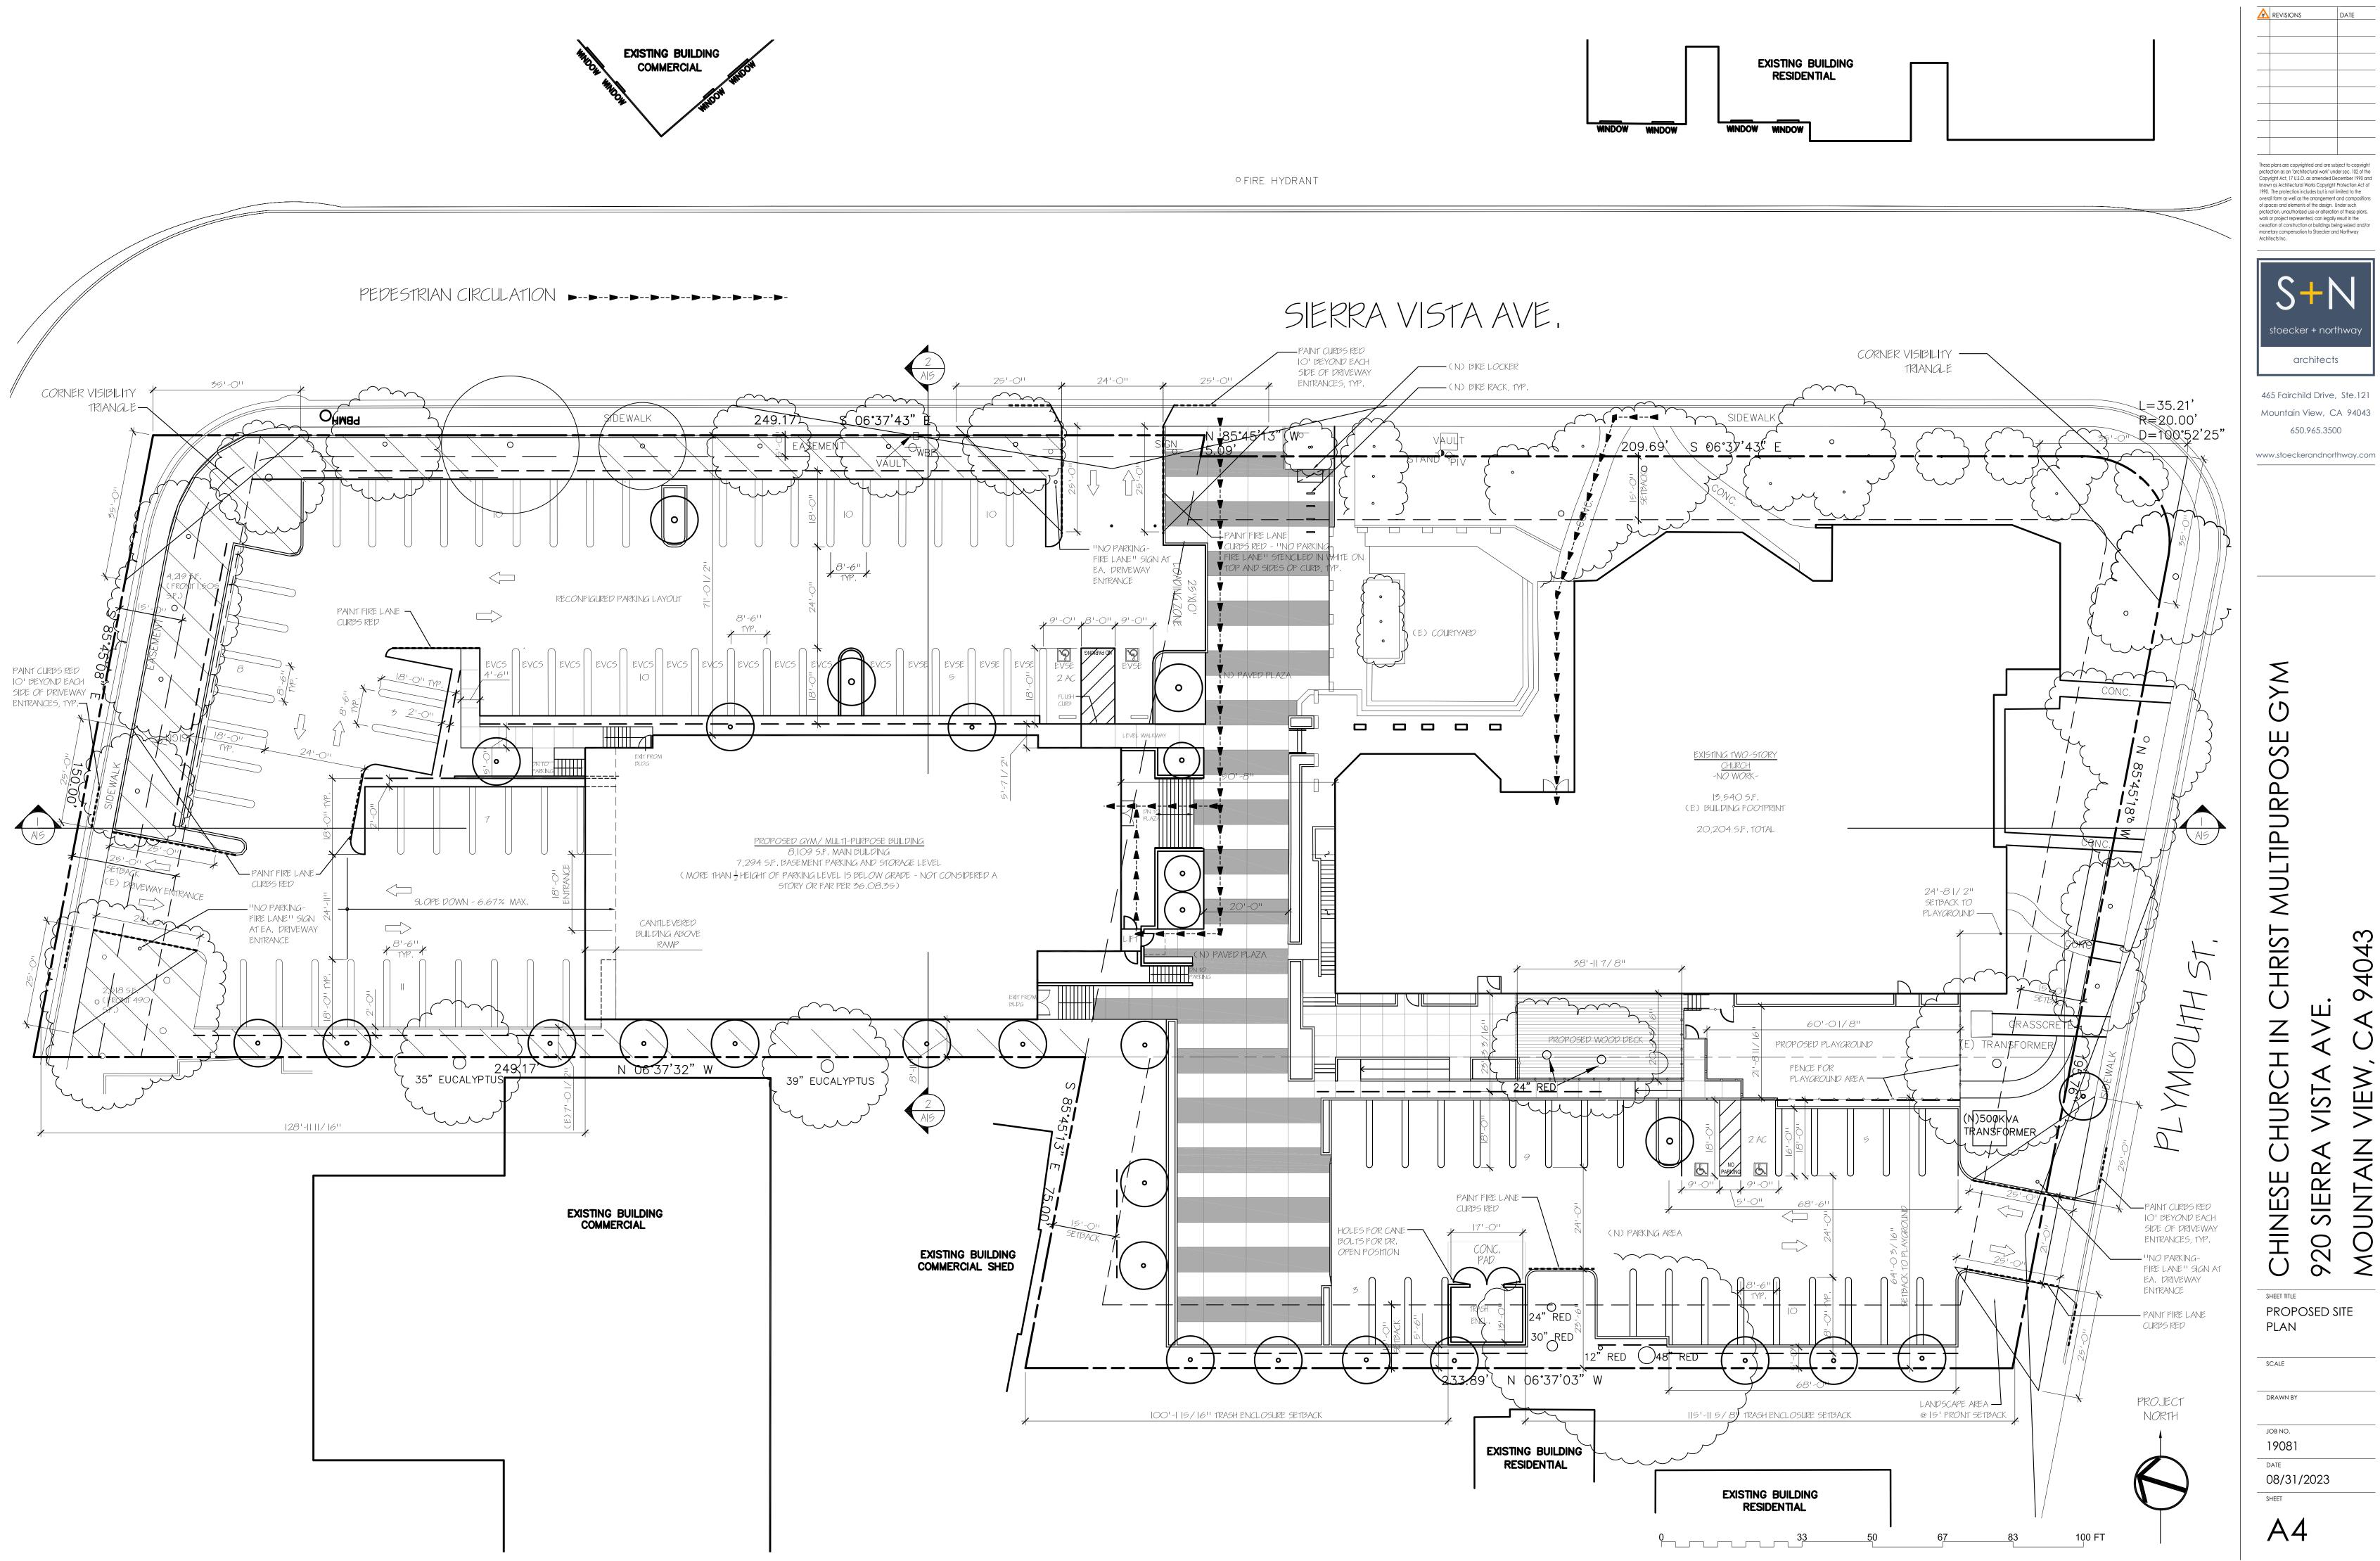
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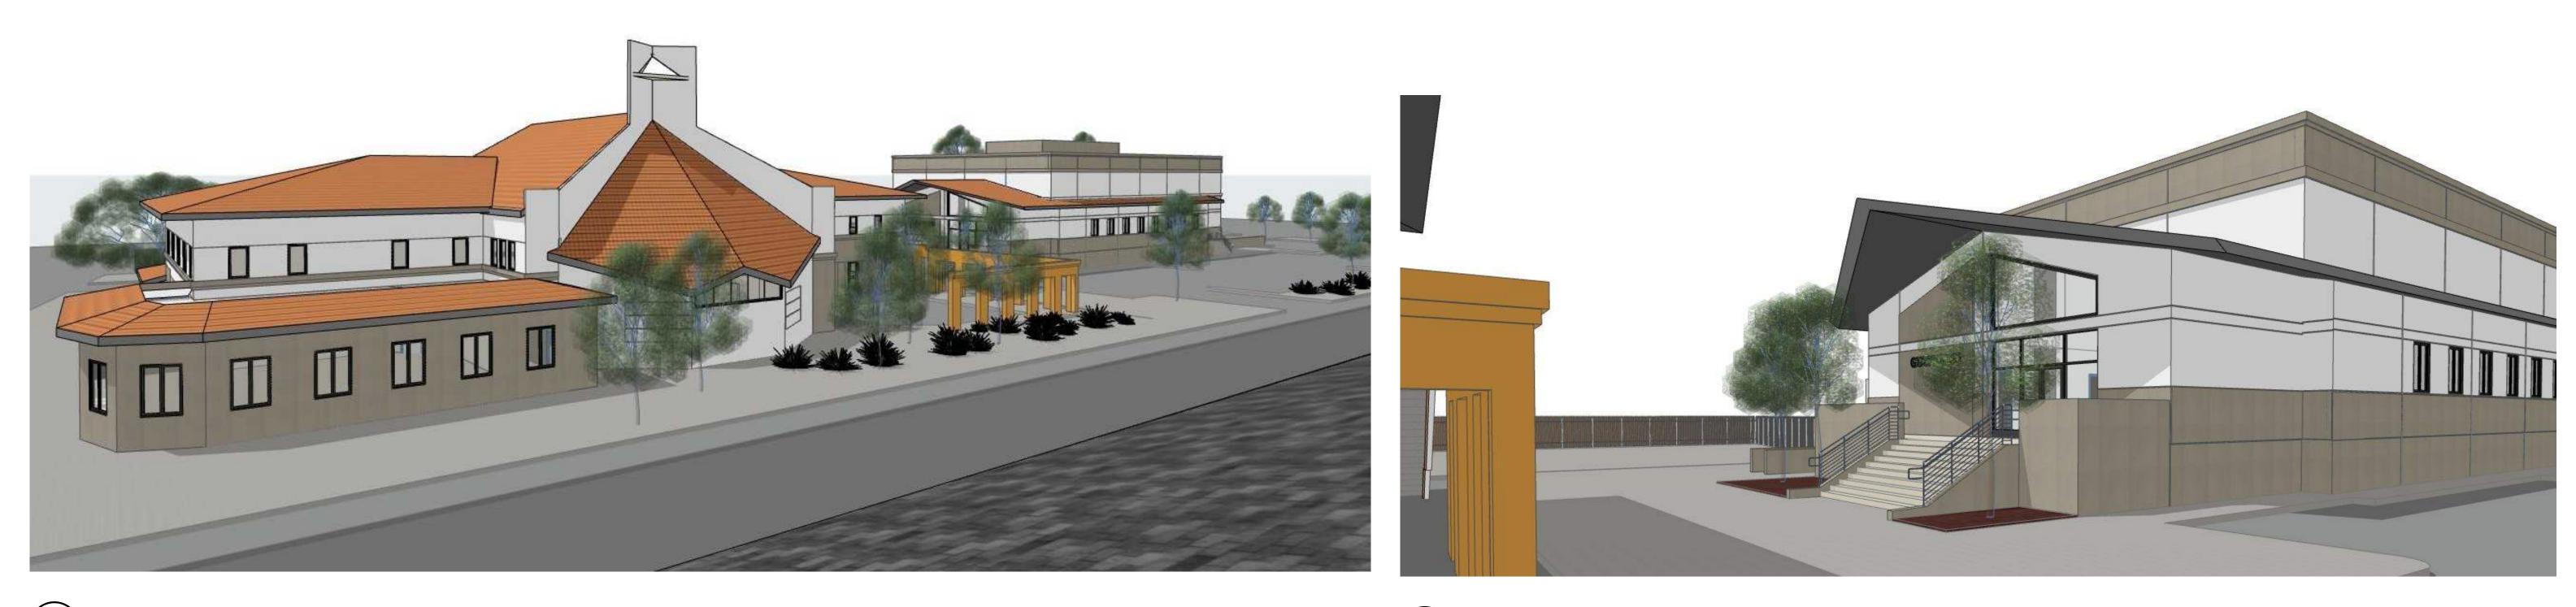












VIEW ALONG SIERRA VISTA



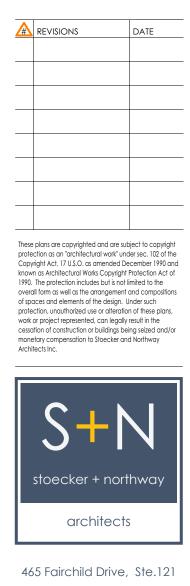
NEW BUILDING VIEW NEAR SIERRA VISTA SITE ENTRANCE



4



NEW BUILDING ENTRY VIEW



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VISTA 920 SIERRA

CHINESE SHEET TITLE Renderings

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NEW BUILDING FROM COURTYARD



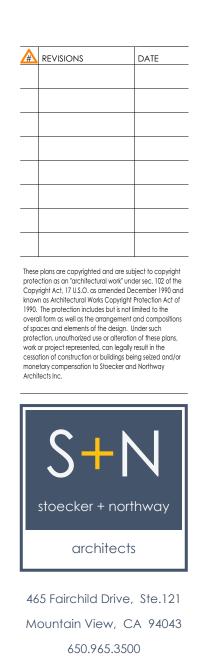
NORTH END - BASEMENT PARKING ENTRANCE

3









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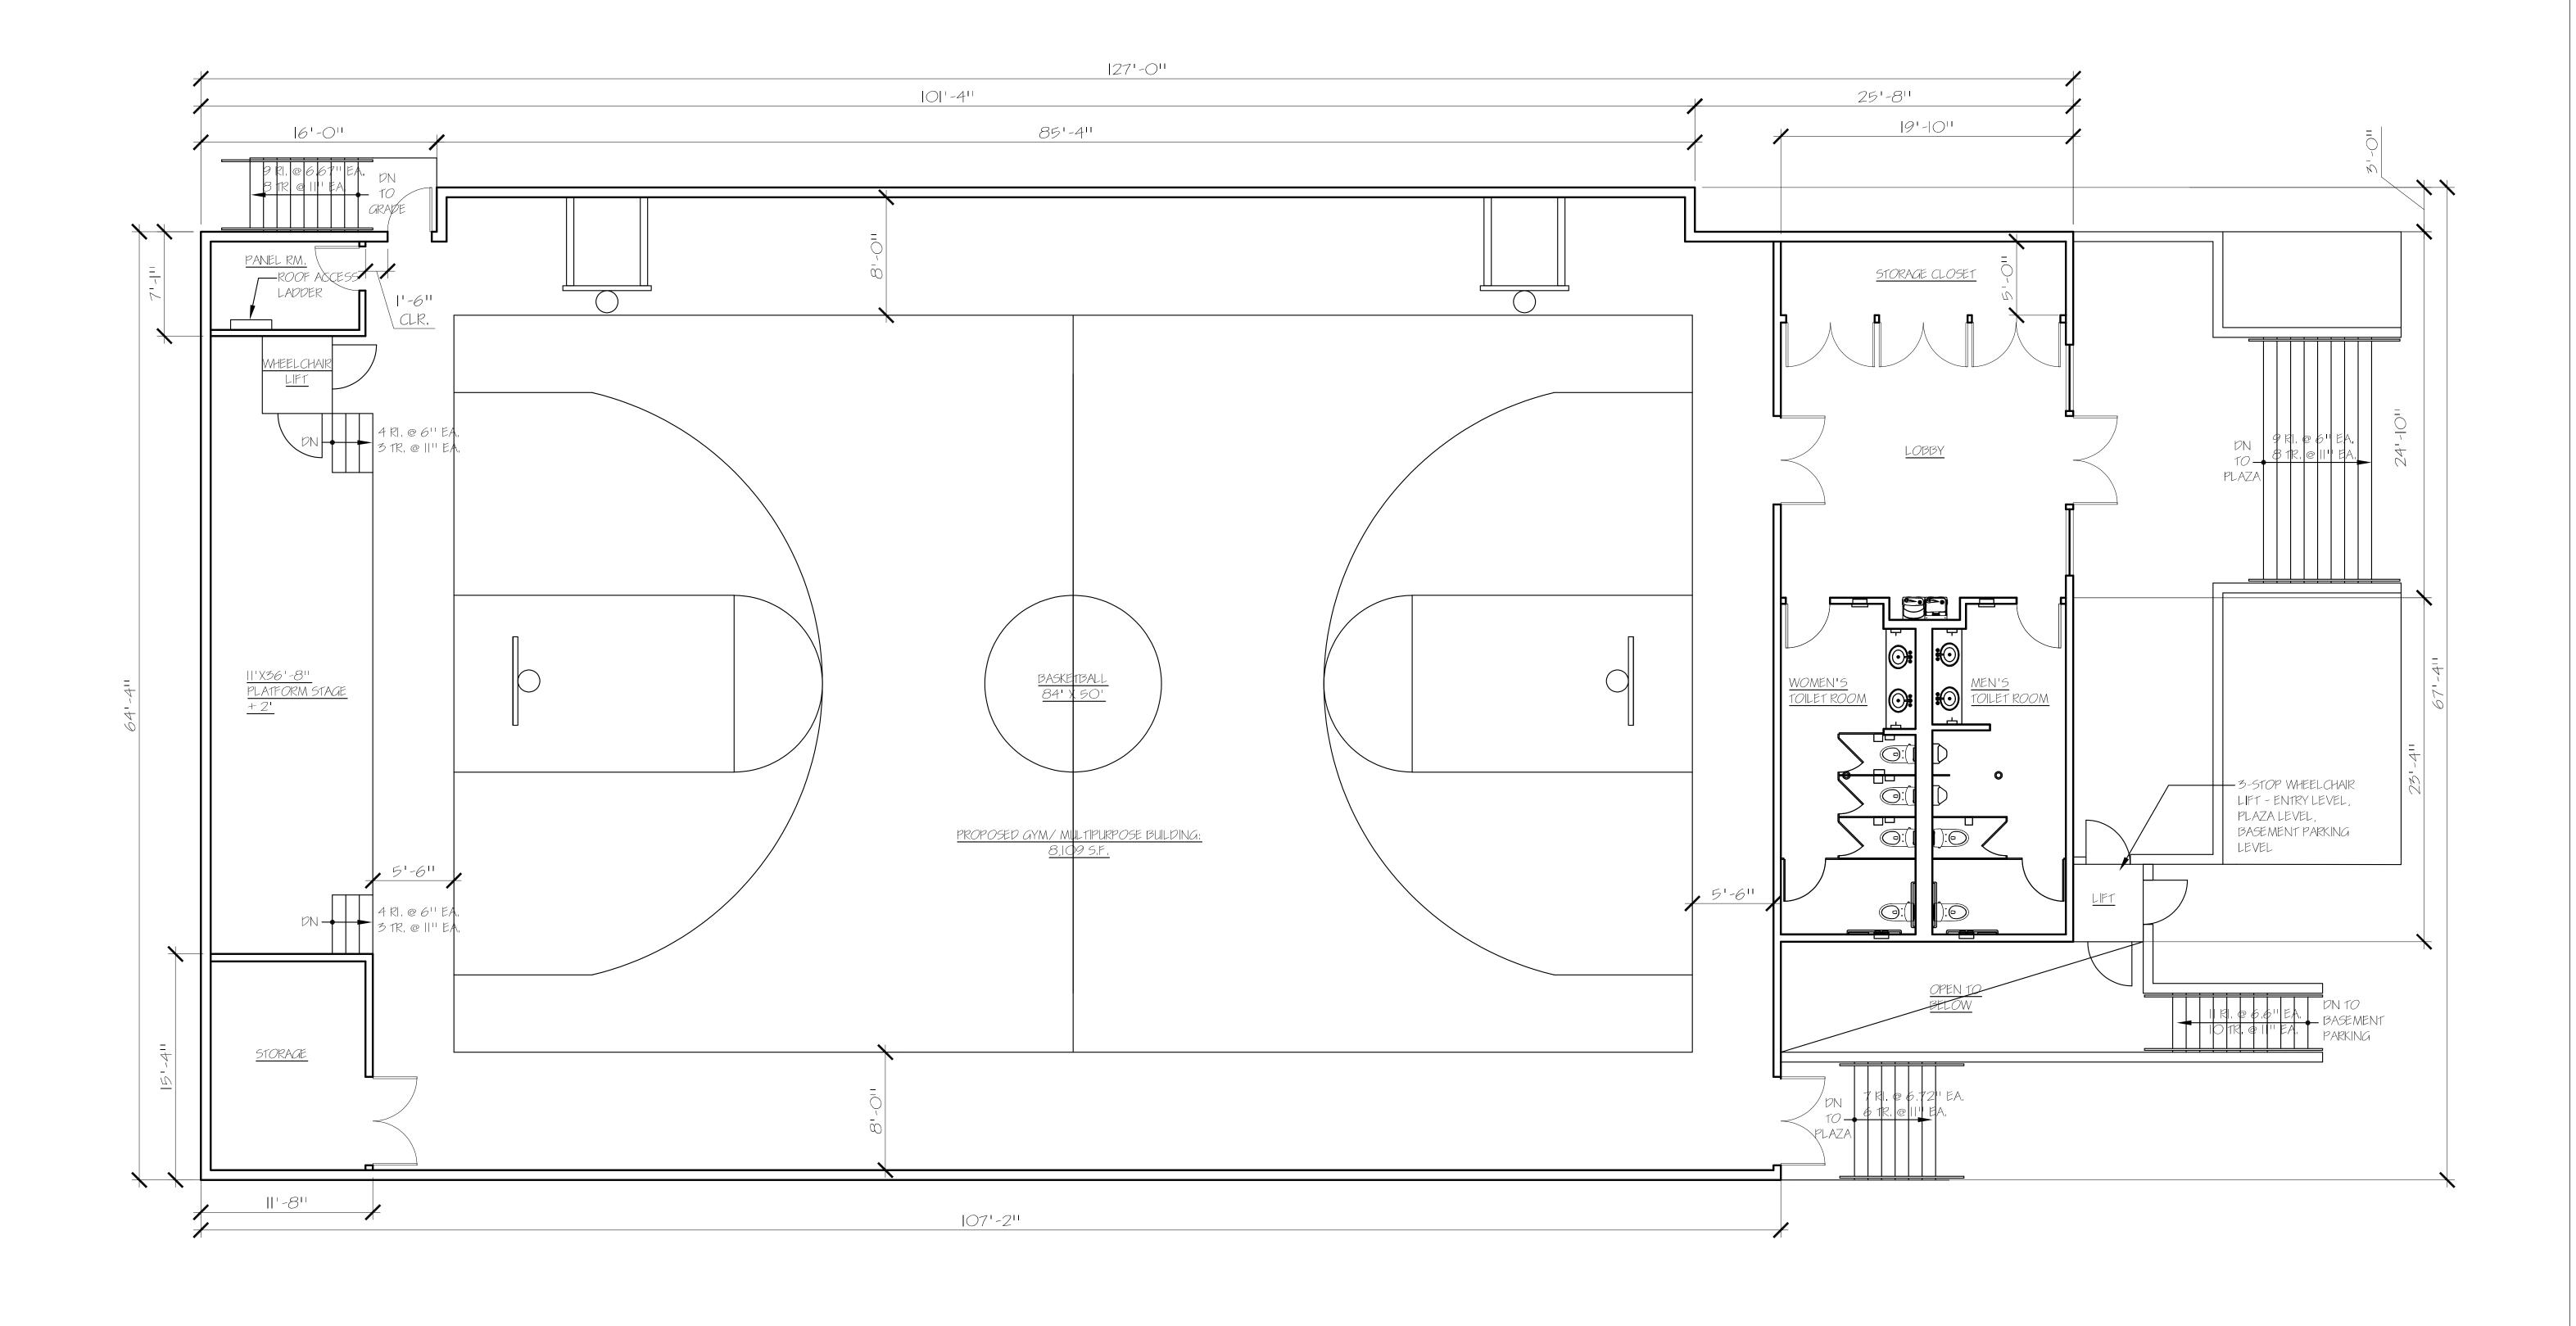
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PROJECT NORTH

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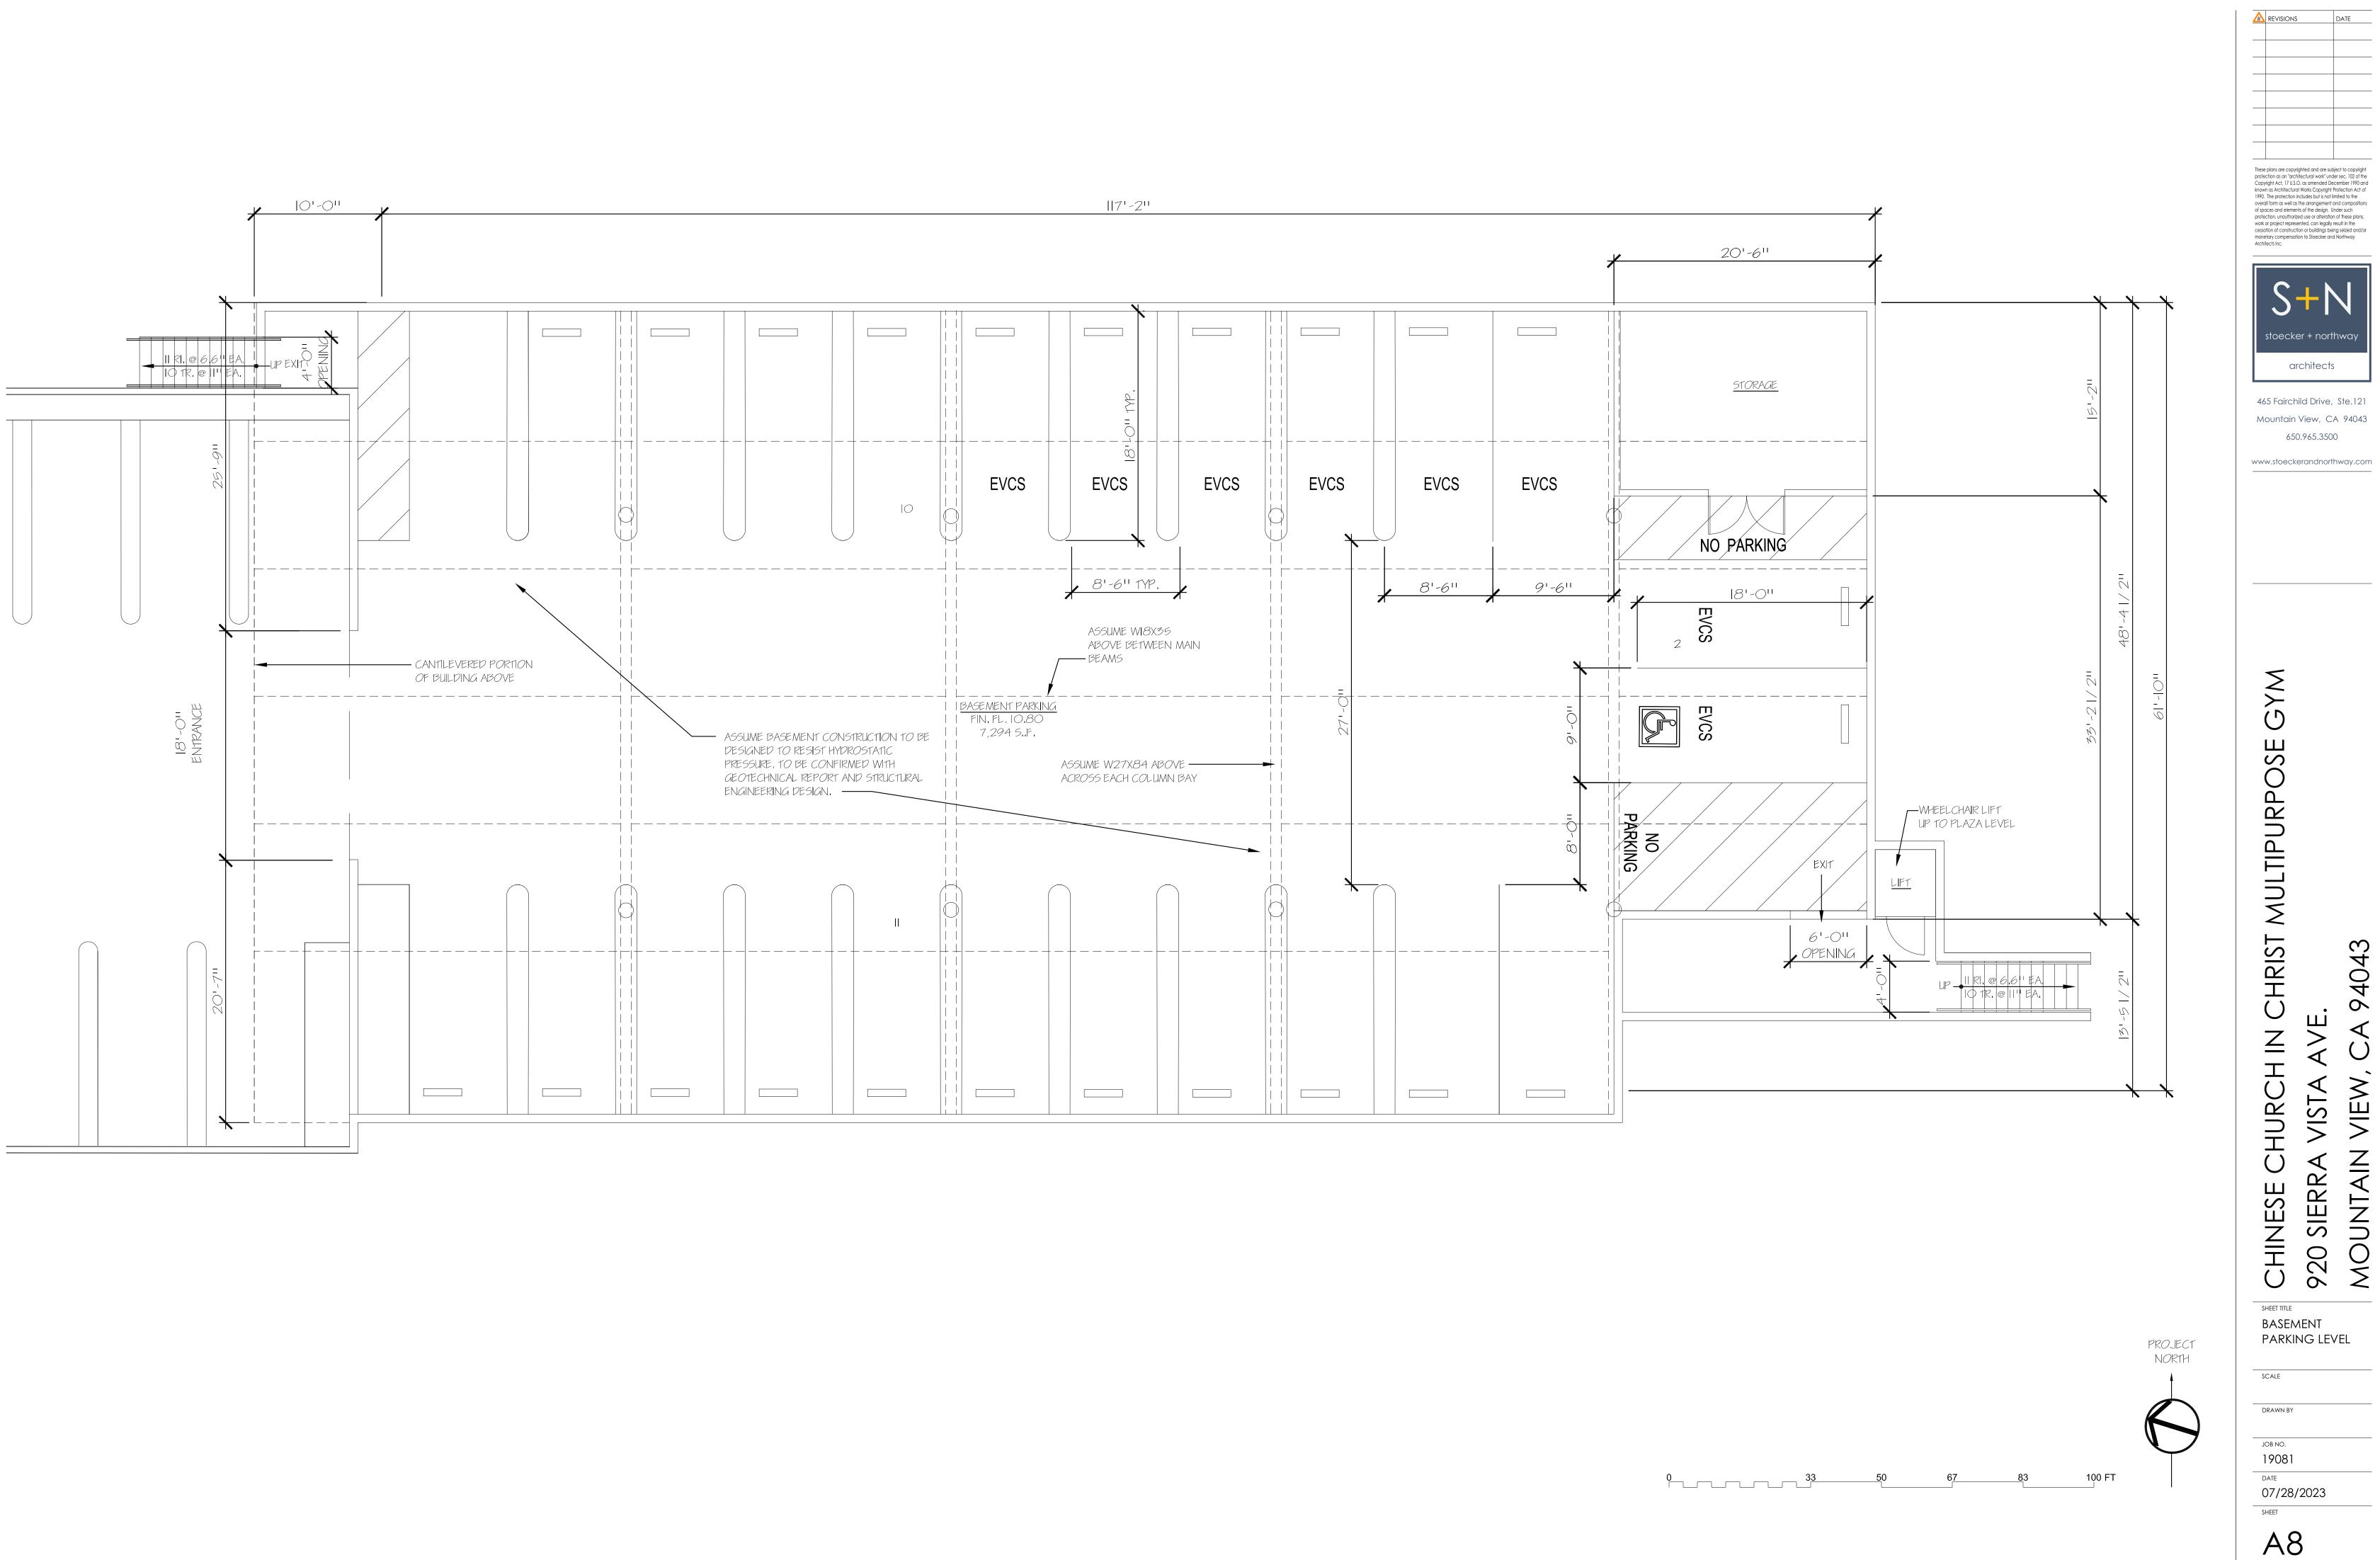
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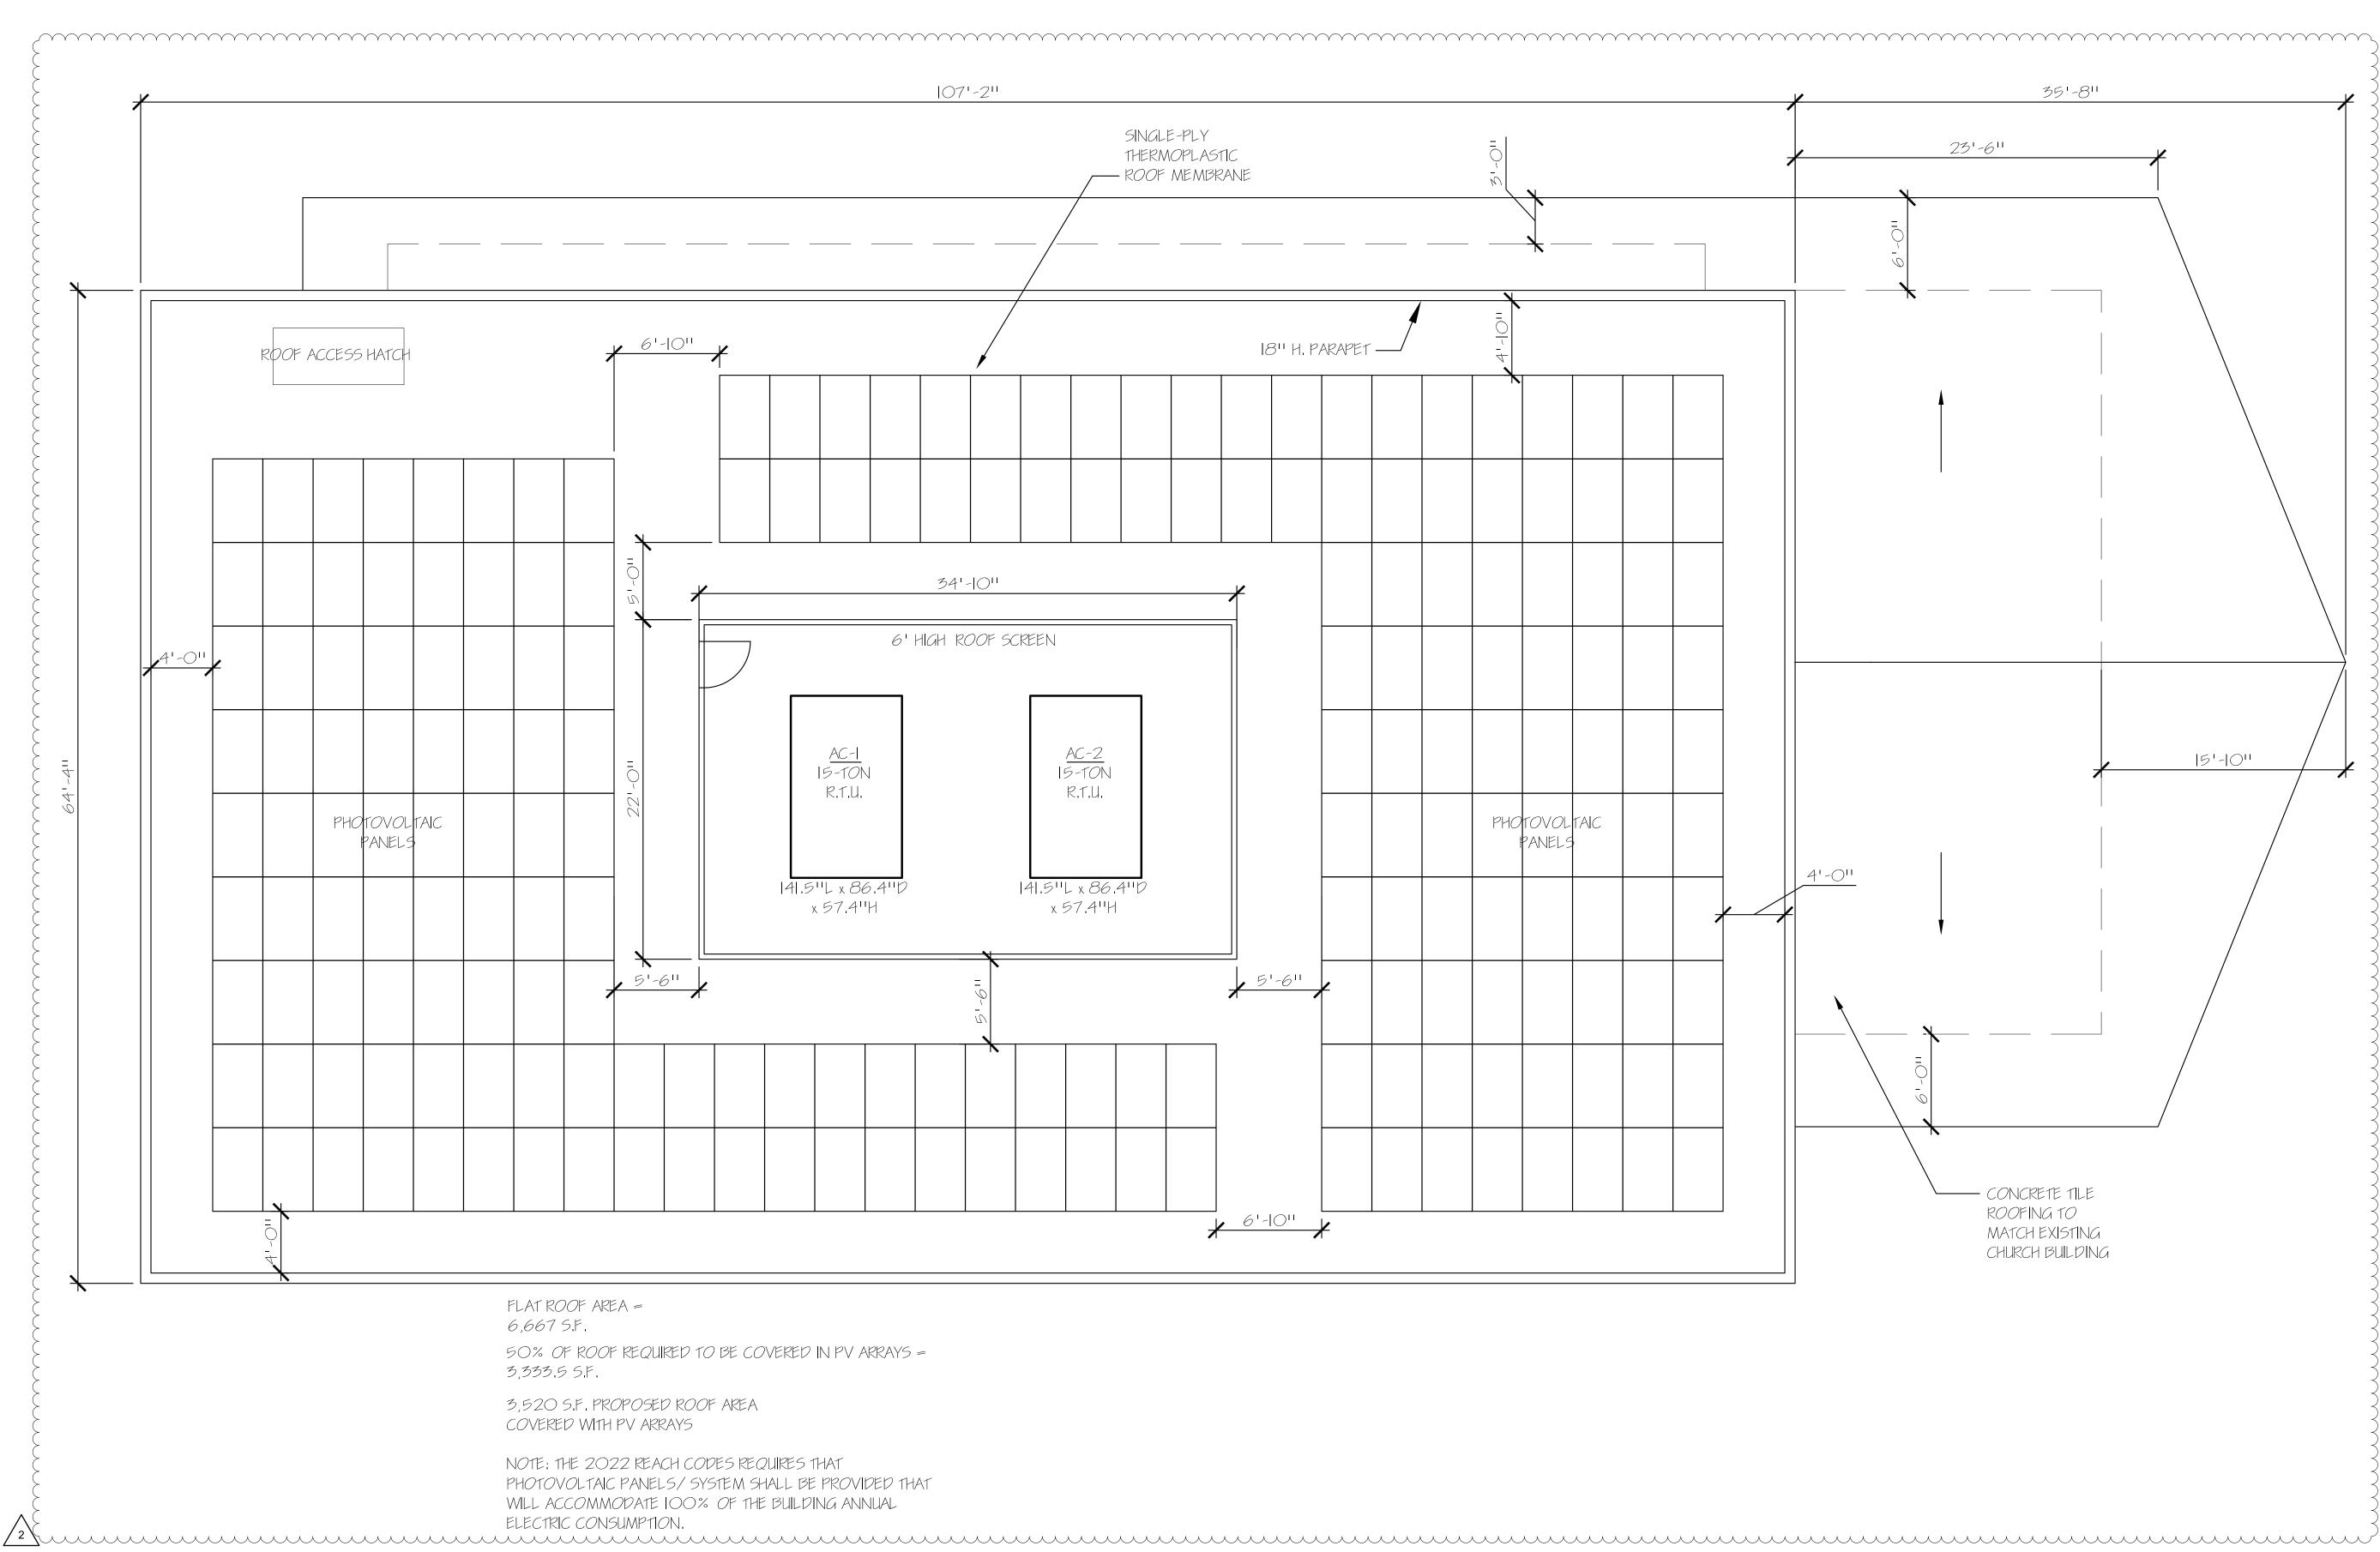
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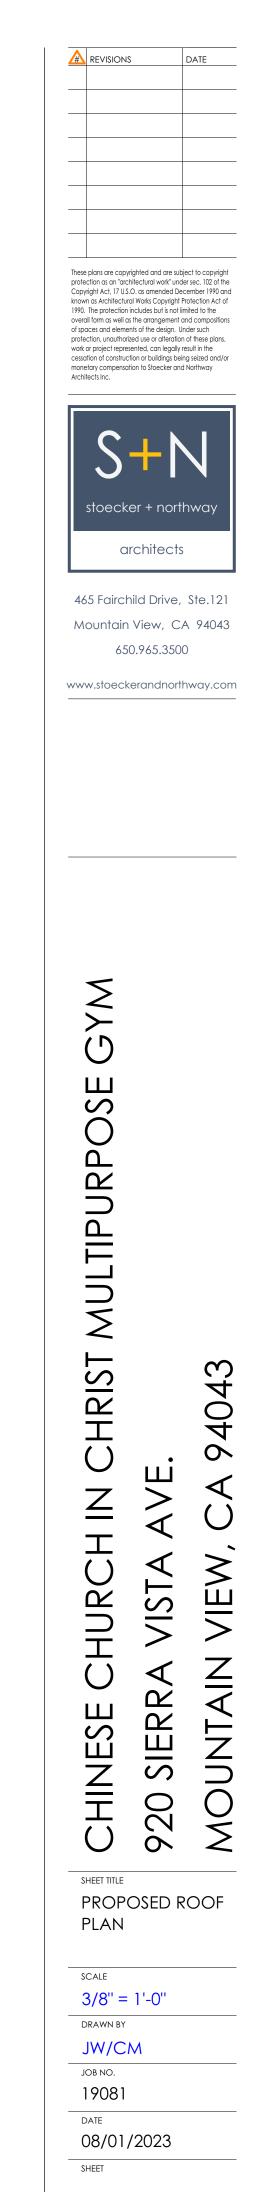
SHEET TITLE PROPOSED FIRST FLOOR PLAN

SCALE 3/8" = 1'-0" DRAWN BY JW/CM JOB NO. 19081 date 08/01/2023 SHEET

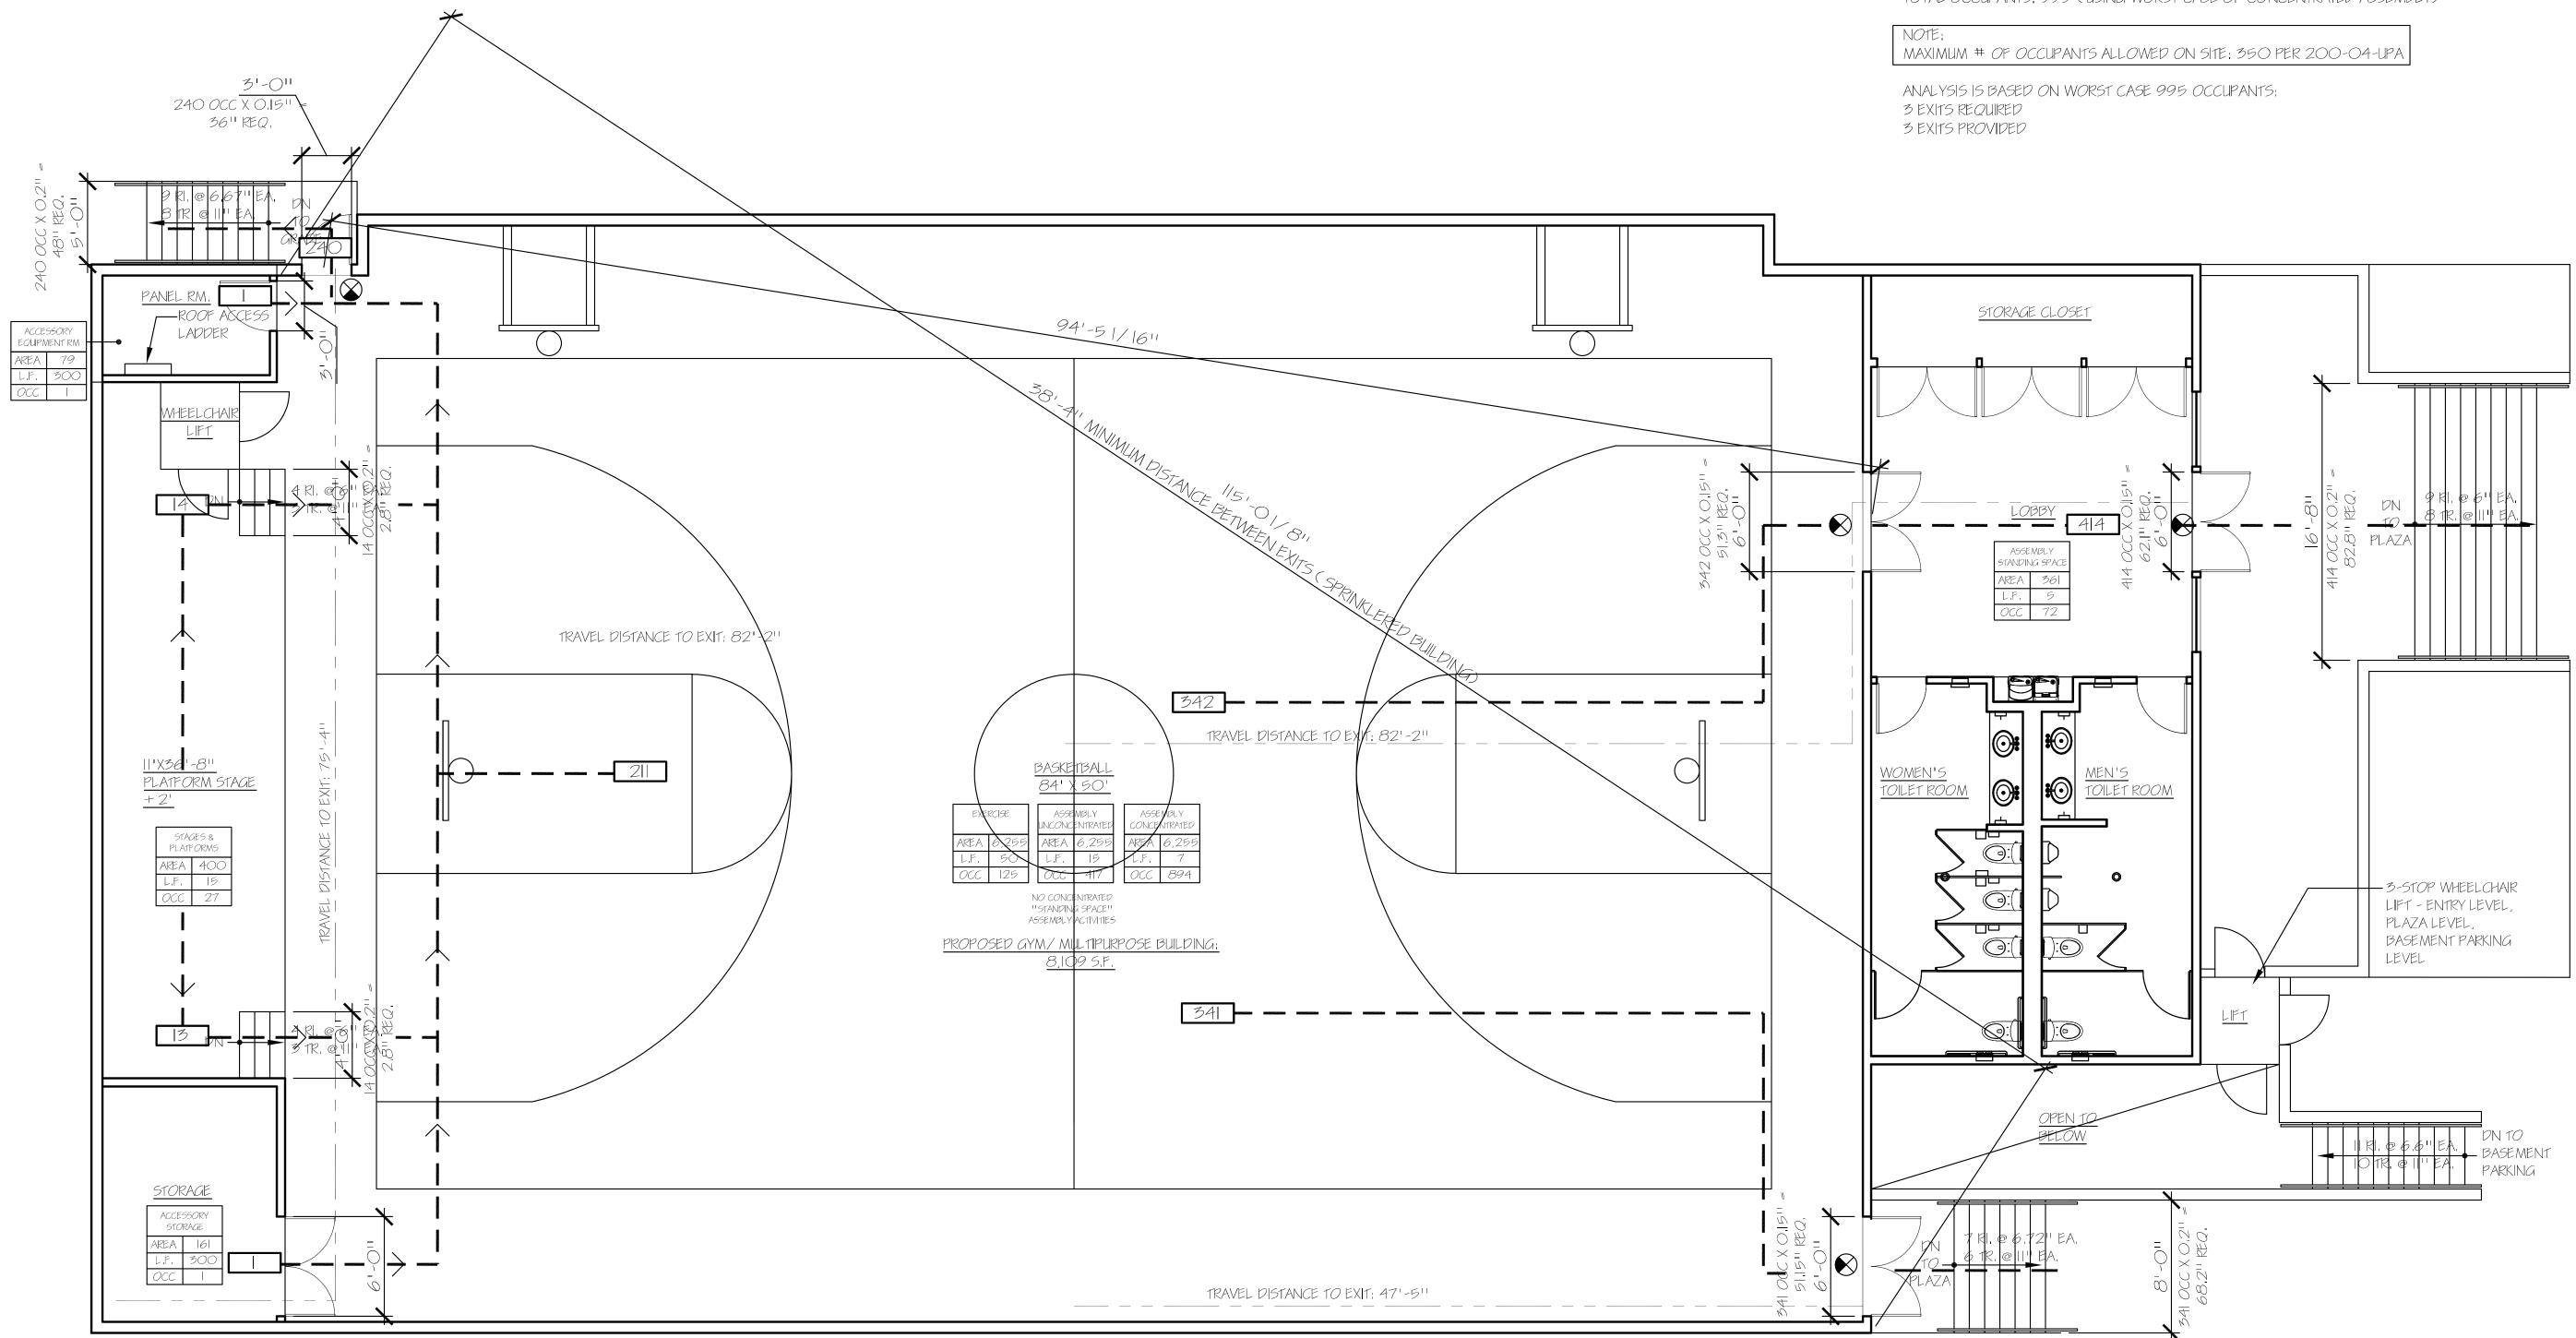












LEGEND

	OCCUPANT LOAD & DIRECTION ILLUMINATED EXIT SIGNAGE
TOTAL OC	CUPANTS: 995 (USING WORST
NOTE: MAXIMUM	# OF OCCUPANTS ALLOWED C
ANALYSIS	IS BASED ON WORST CASE 99:

IT LOAD & DIRECTION OF TRAVEL TED EXIT SIGNAGE

995 (USING WORST CASE OF CONCENTRATED ASSEMBLY)

PROJECT NORTH



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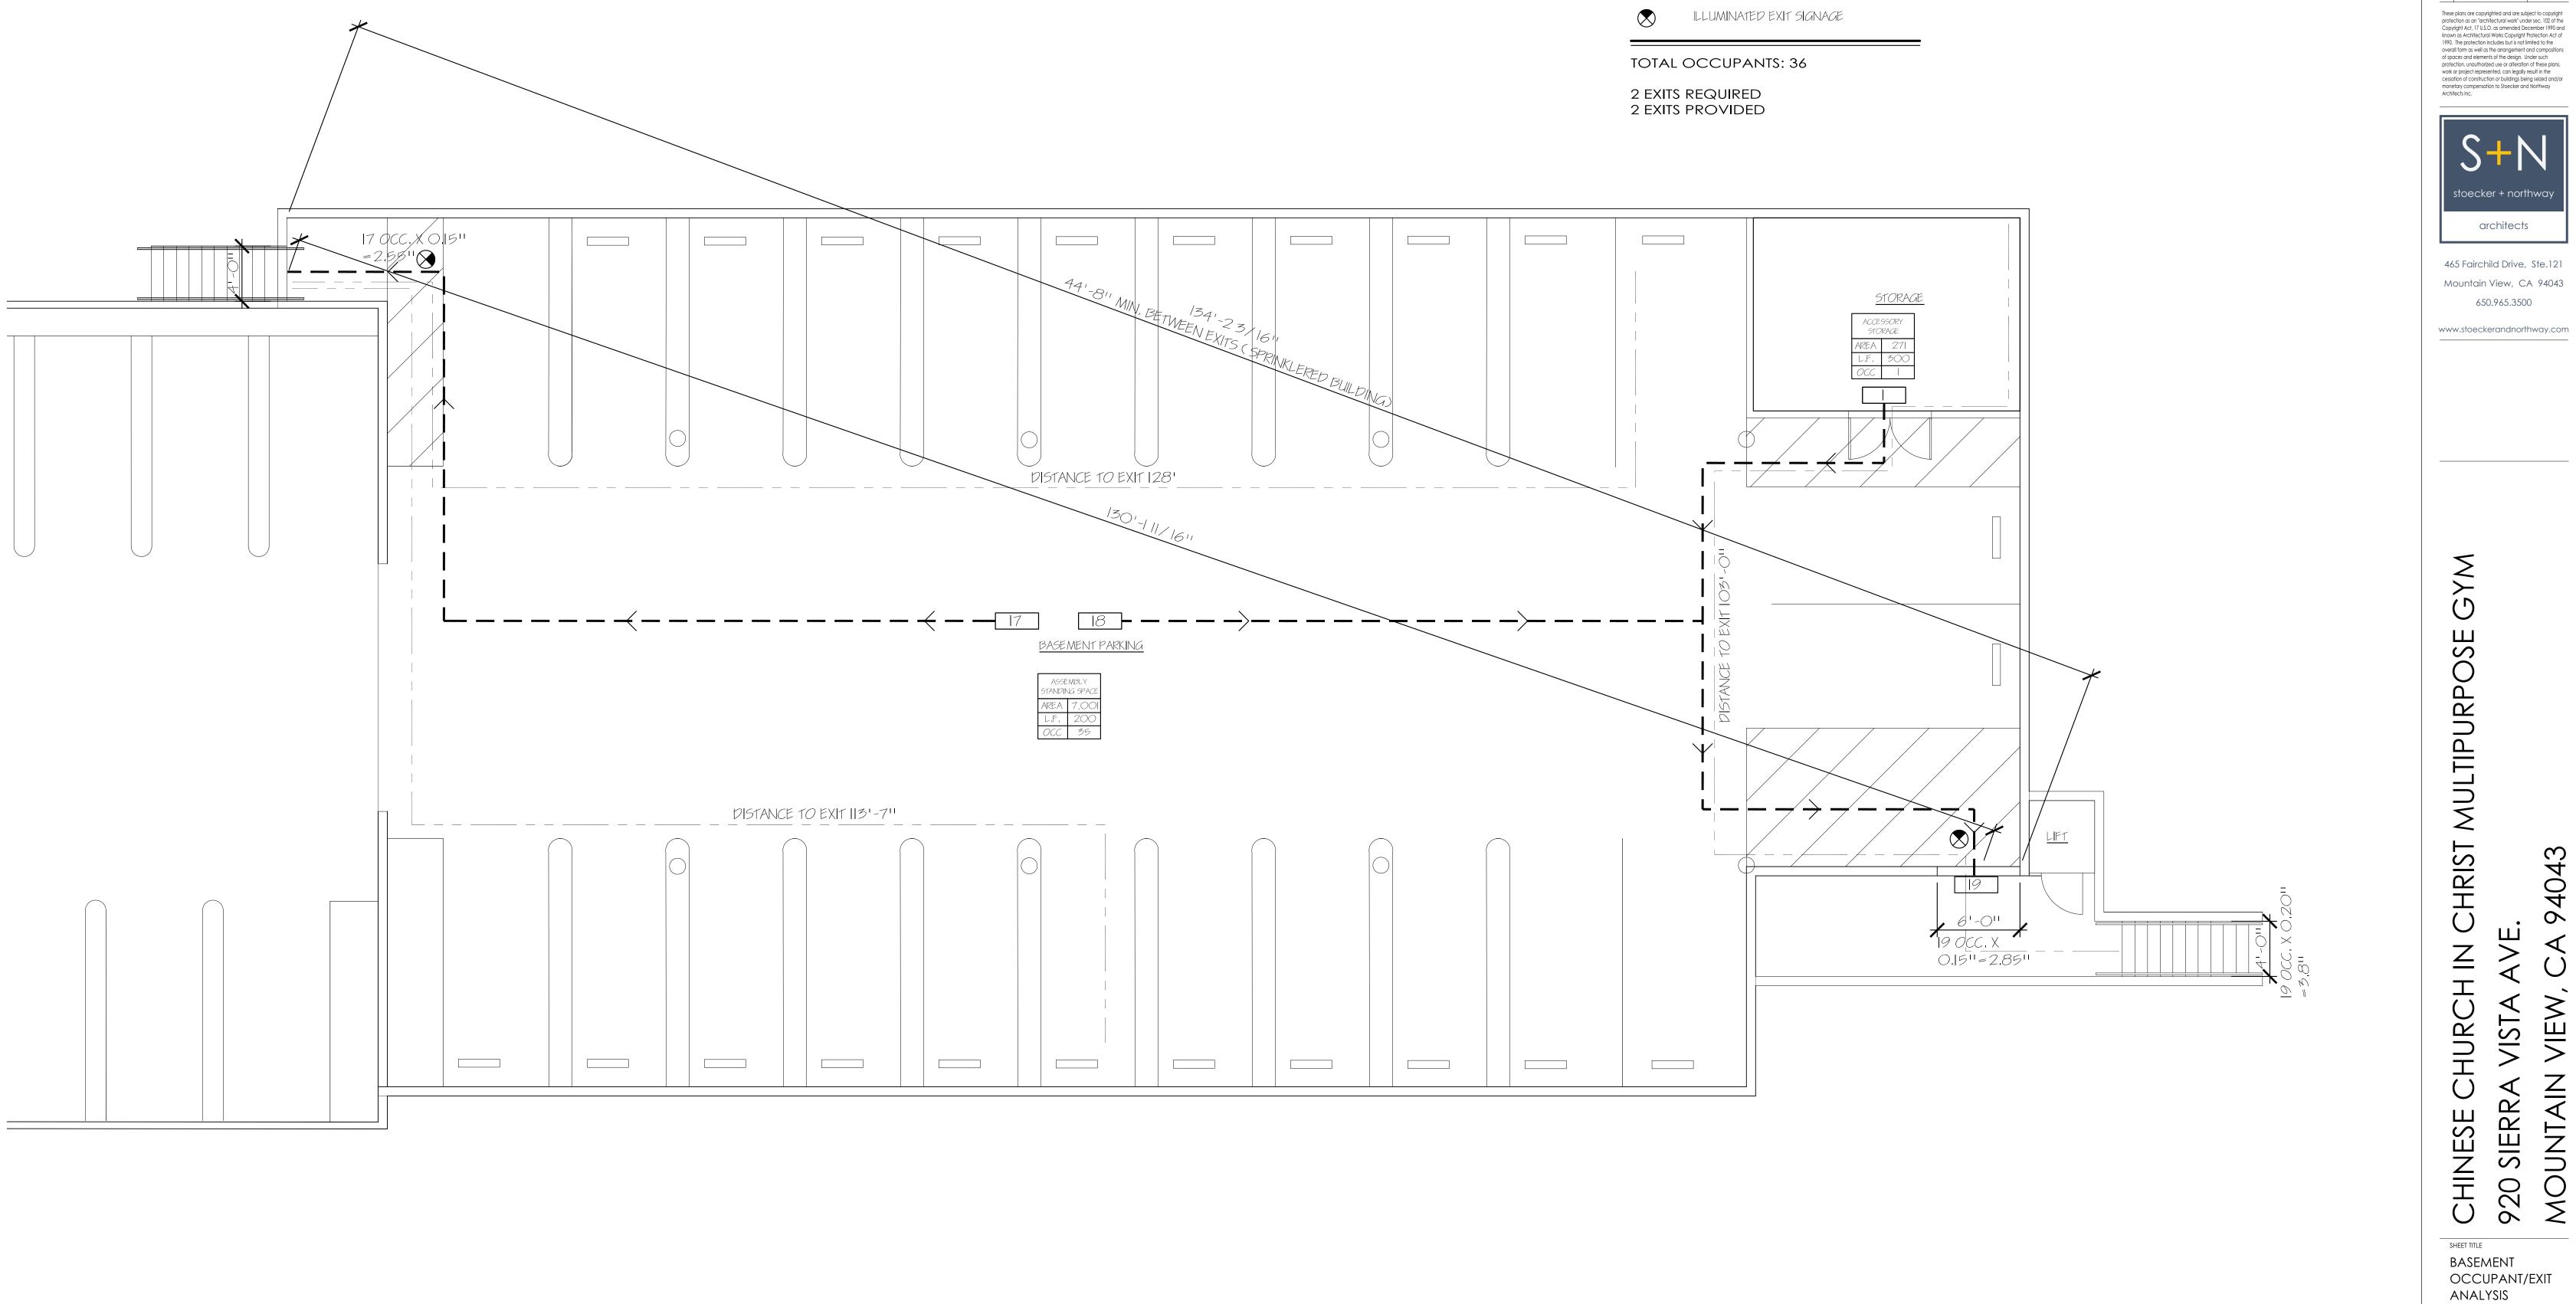
CHINESE

SHEET TITLE FIRST FLOOR OCCUPANT/EXIT analysis SCALE

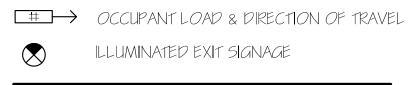
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LEGEND



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PROJECT NORTH

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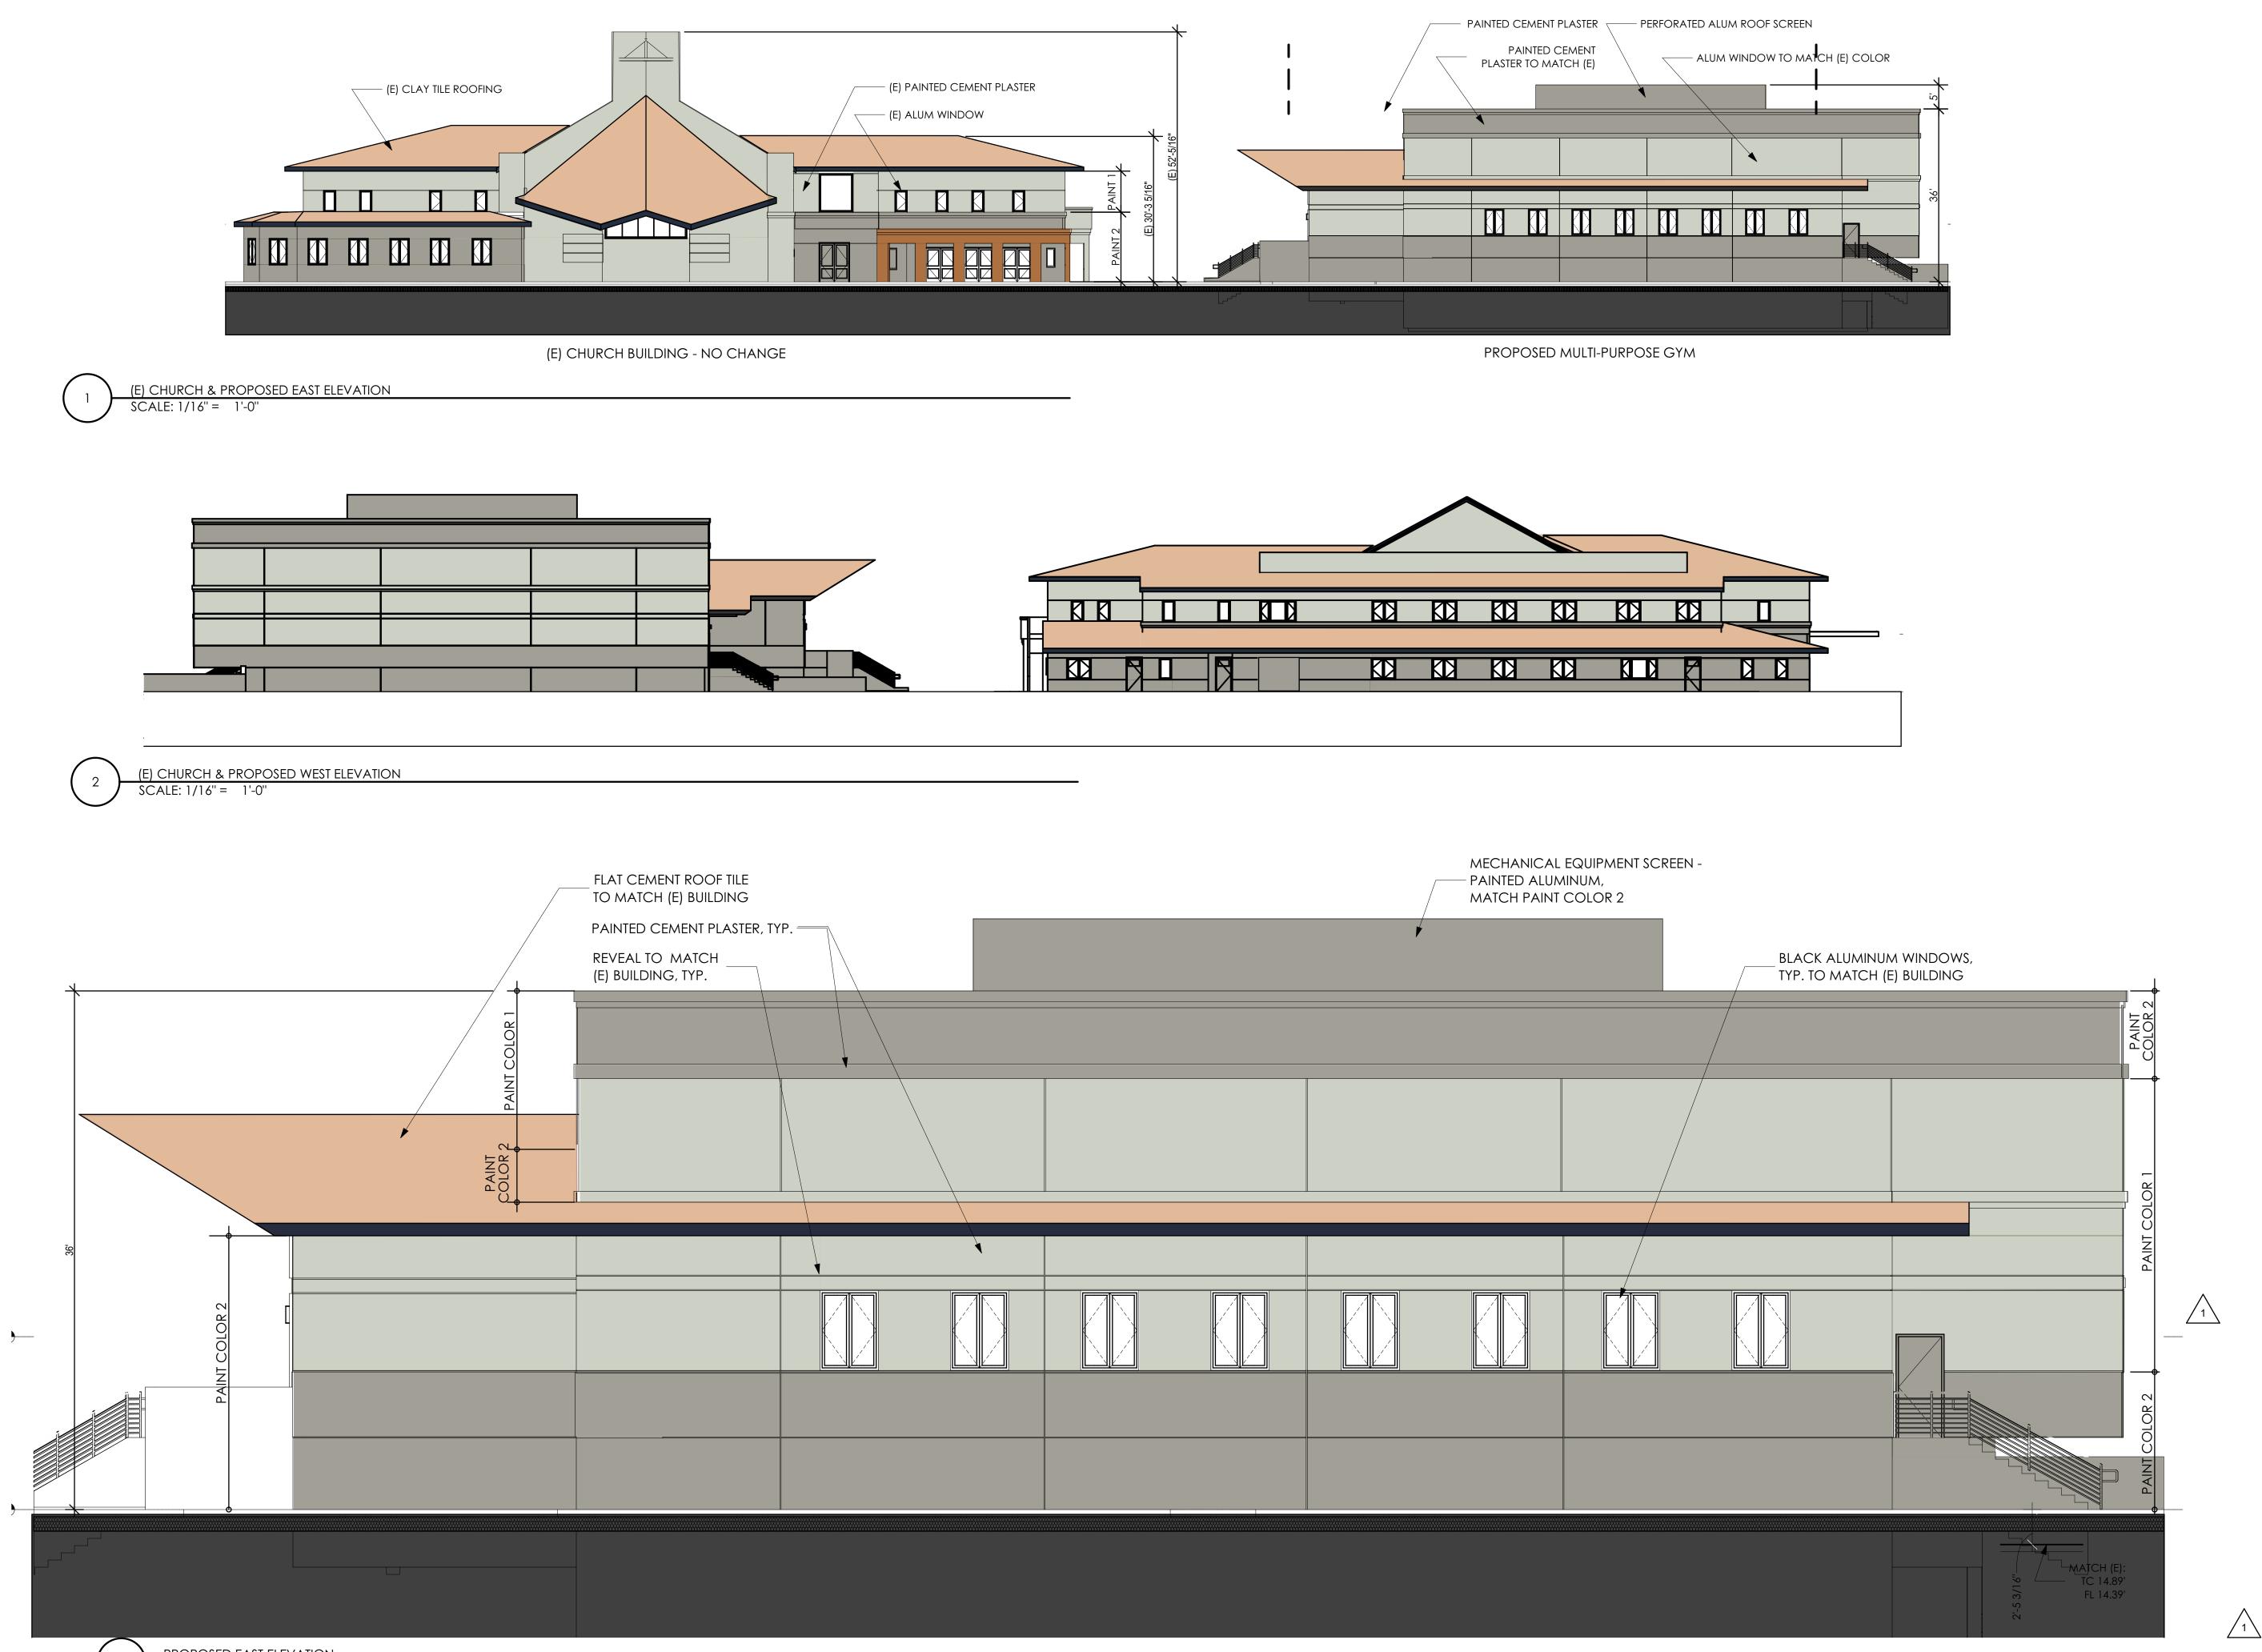
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PROPOSED EAST ELEVATION SCALE: 3/16" = 1'-0"

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SHEET TITLE PROPOSED ELEVATIONS

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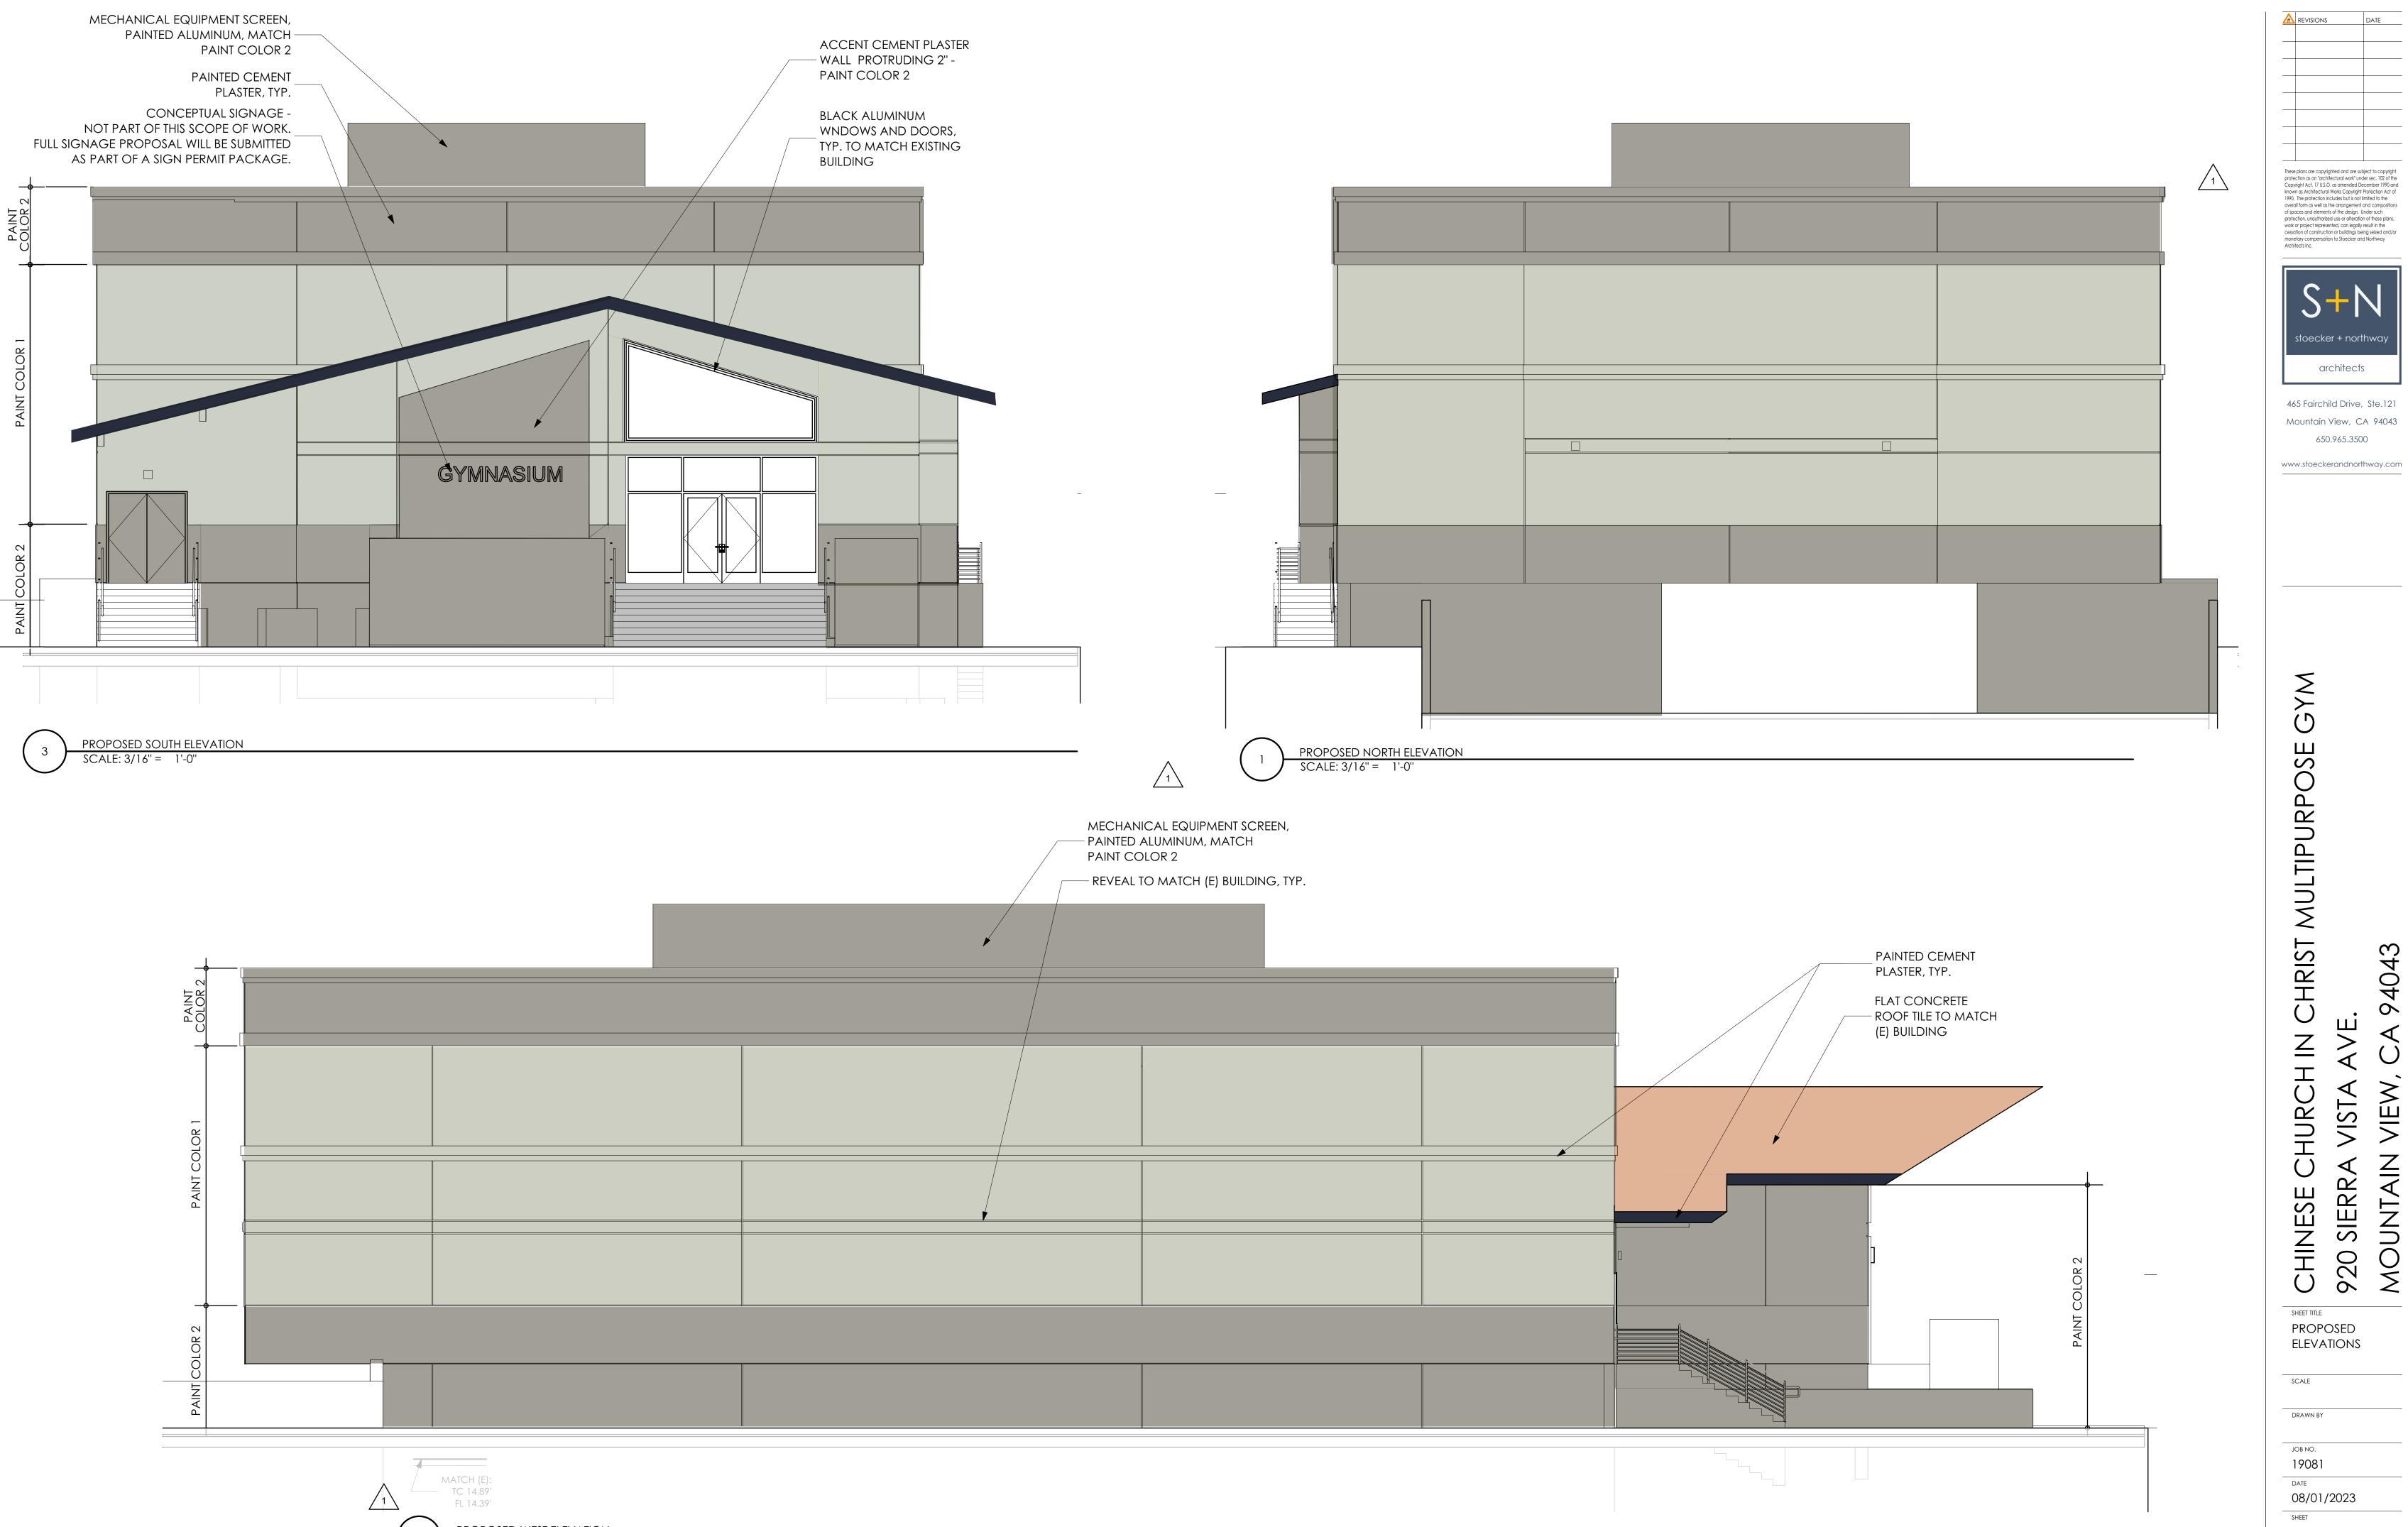
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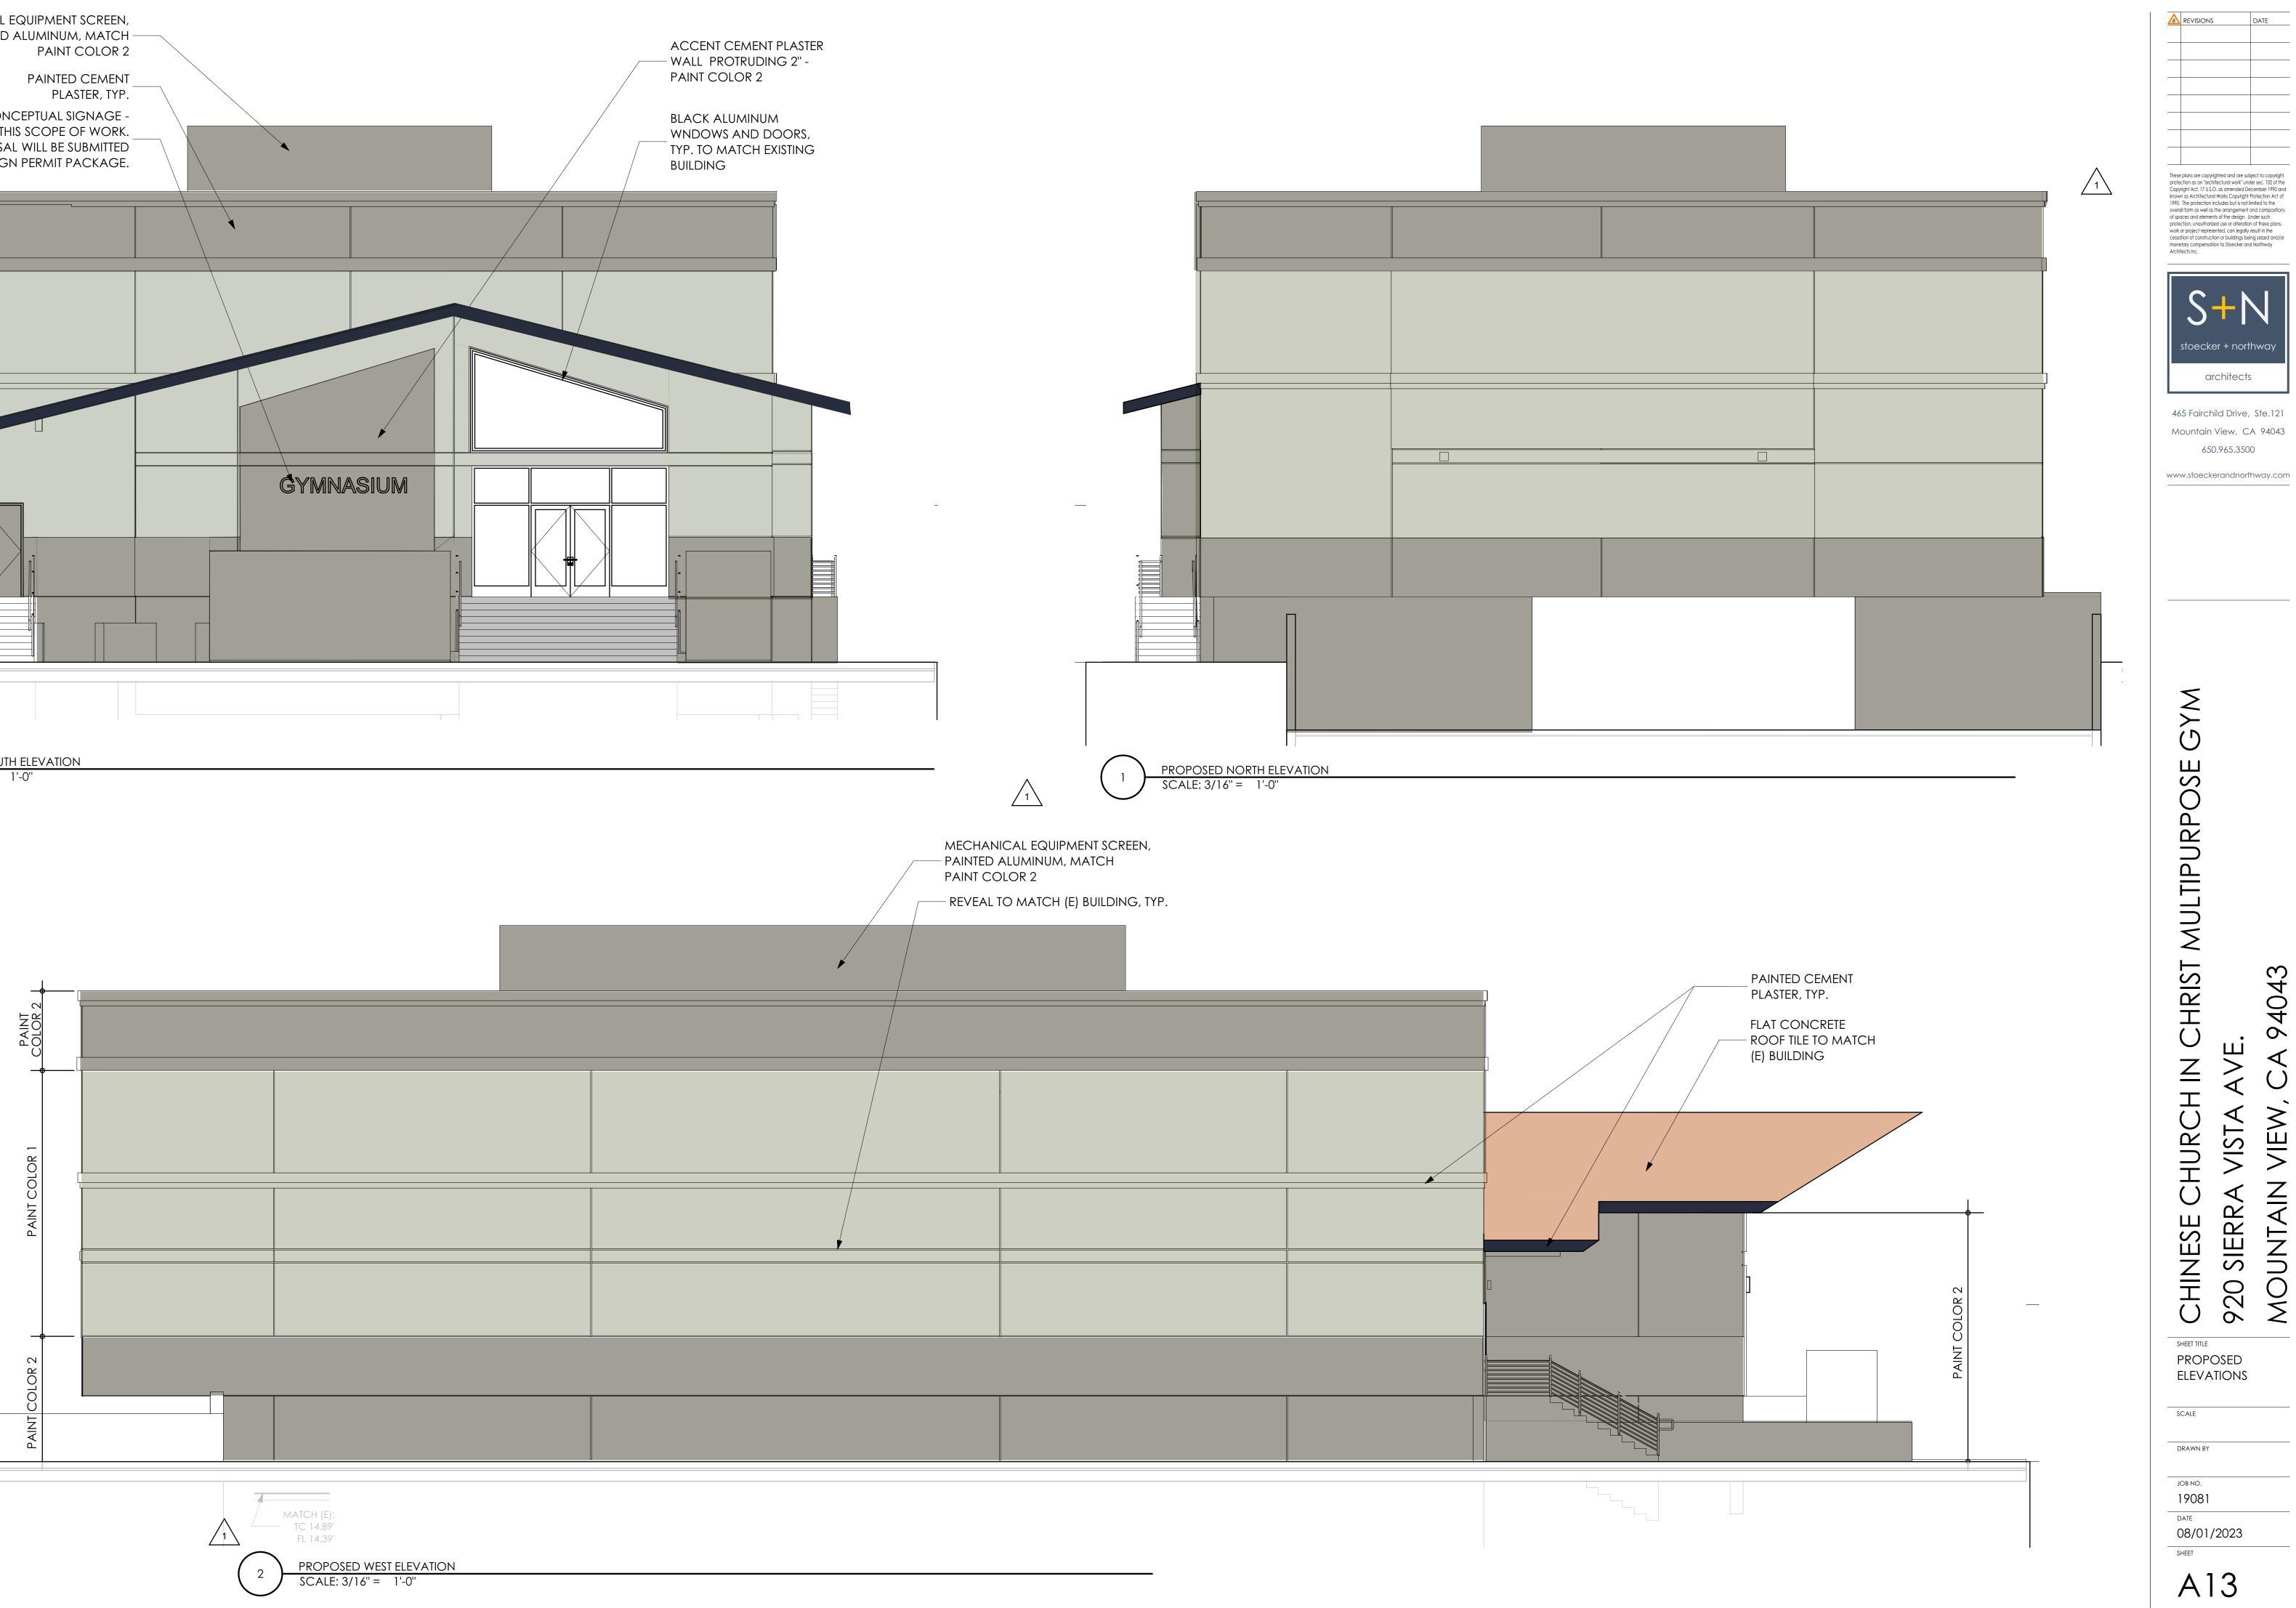
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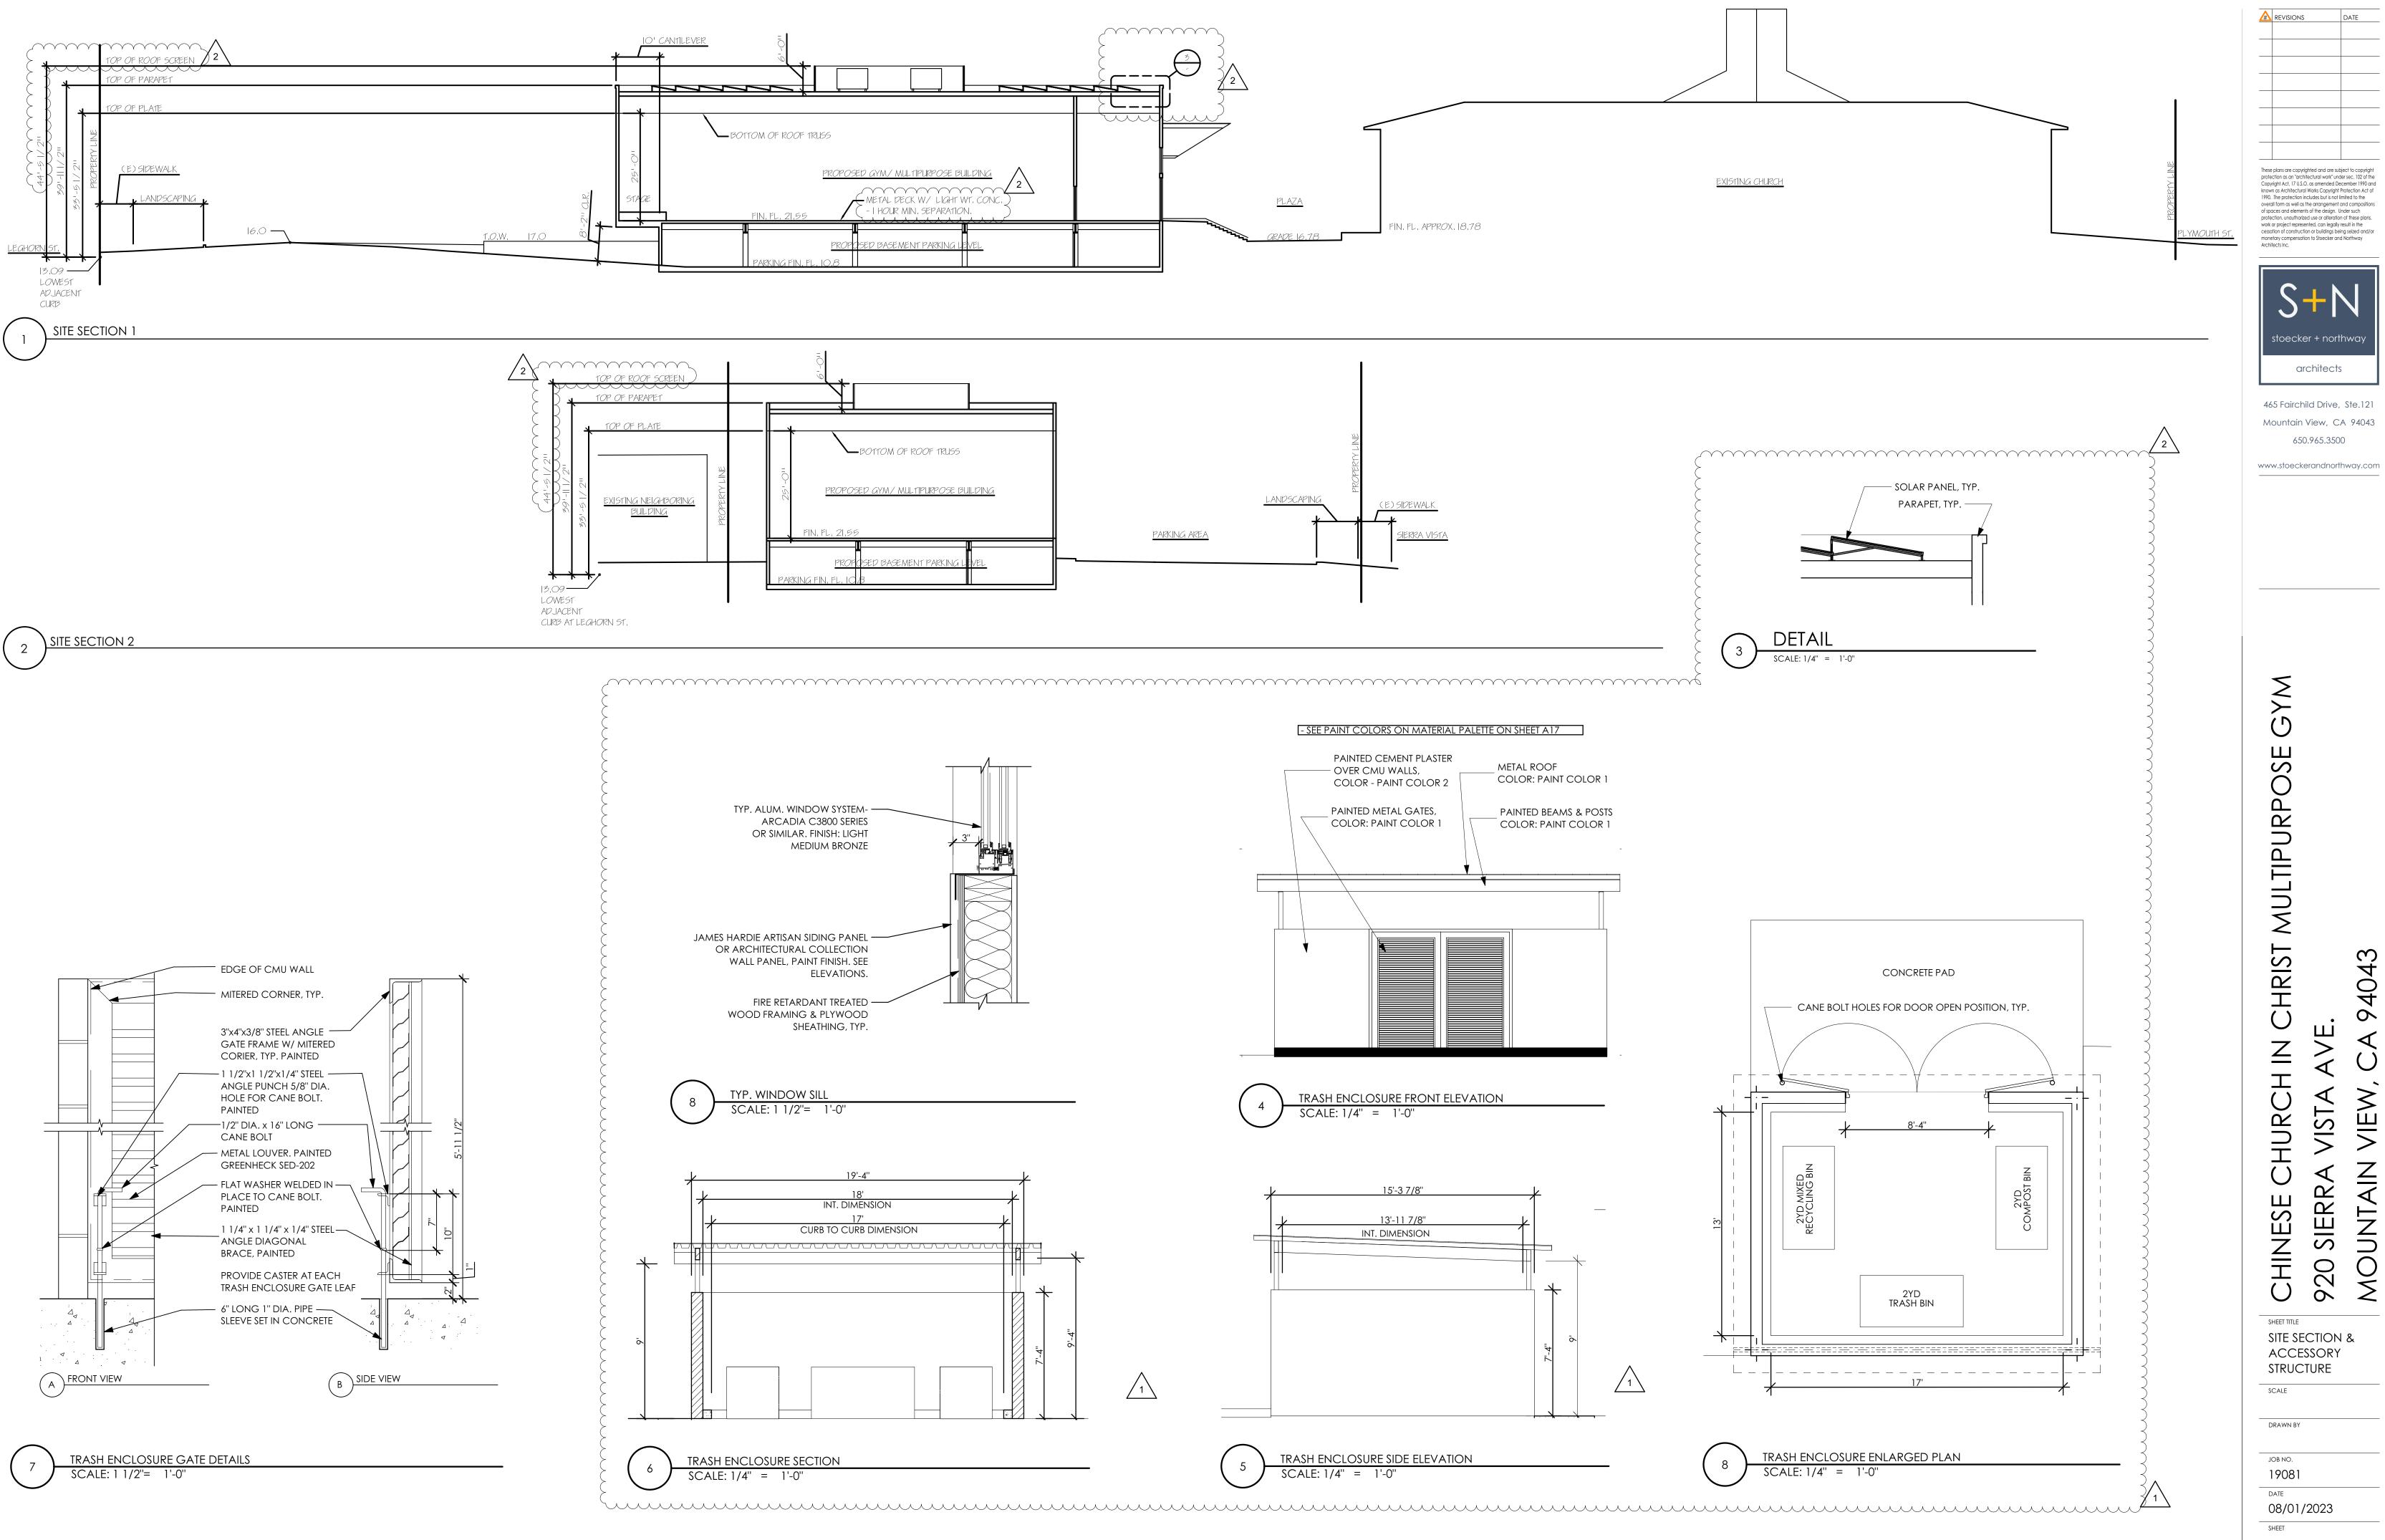
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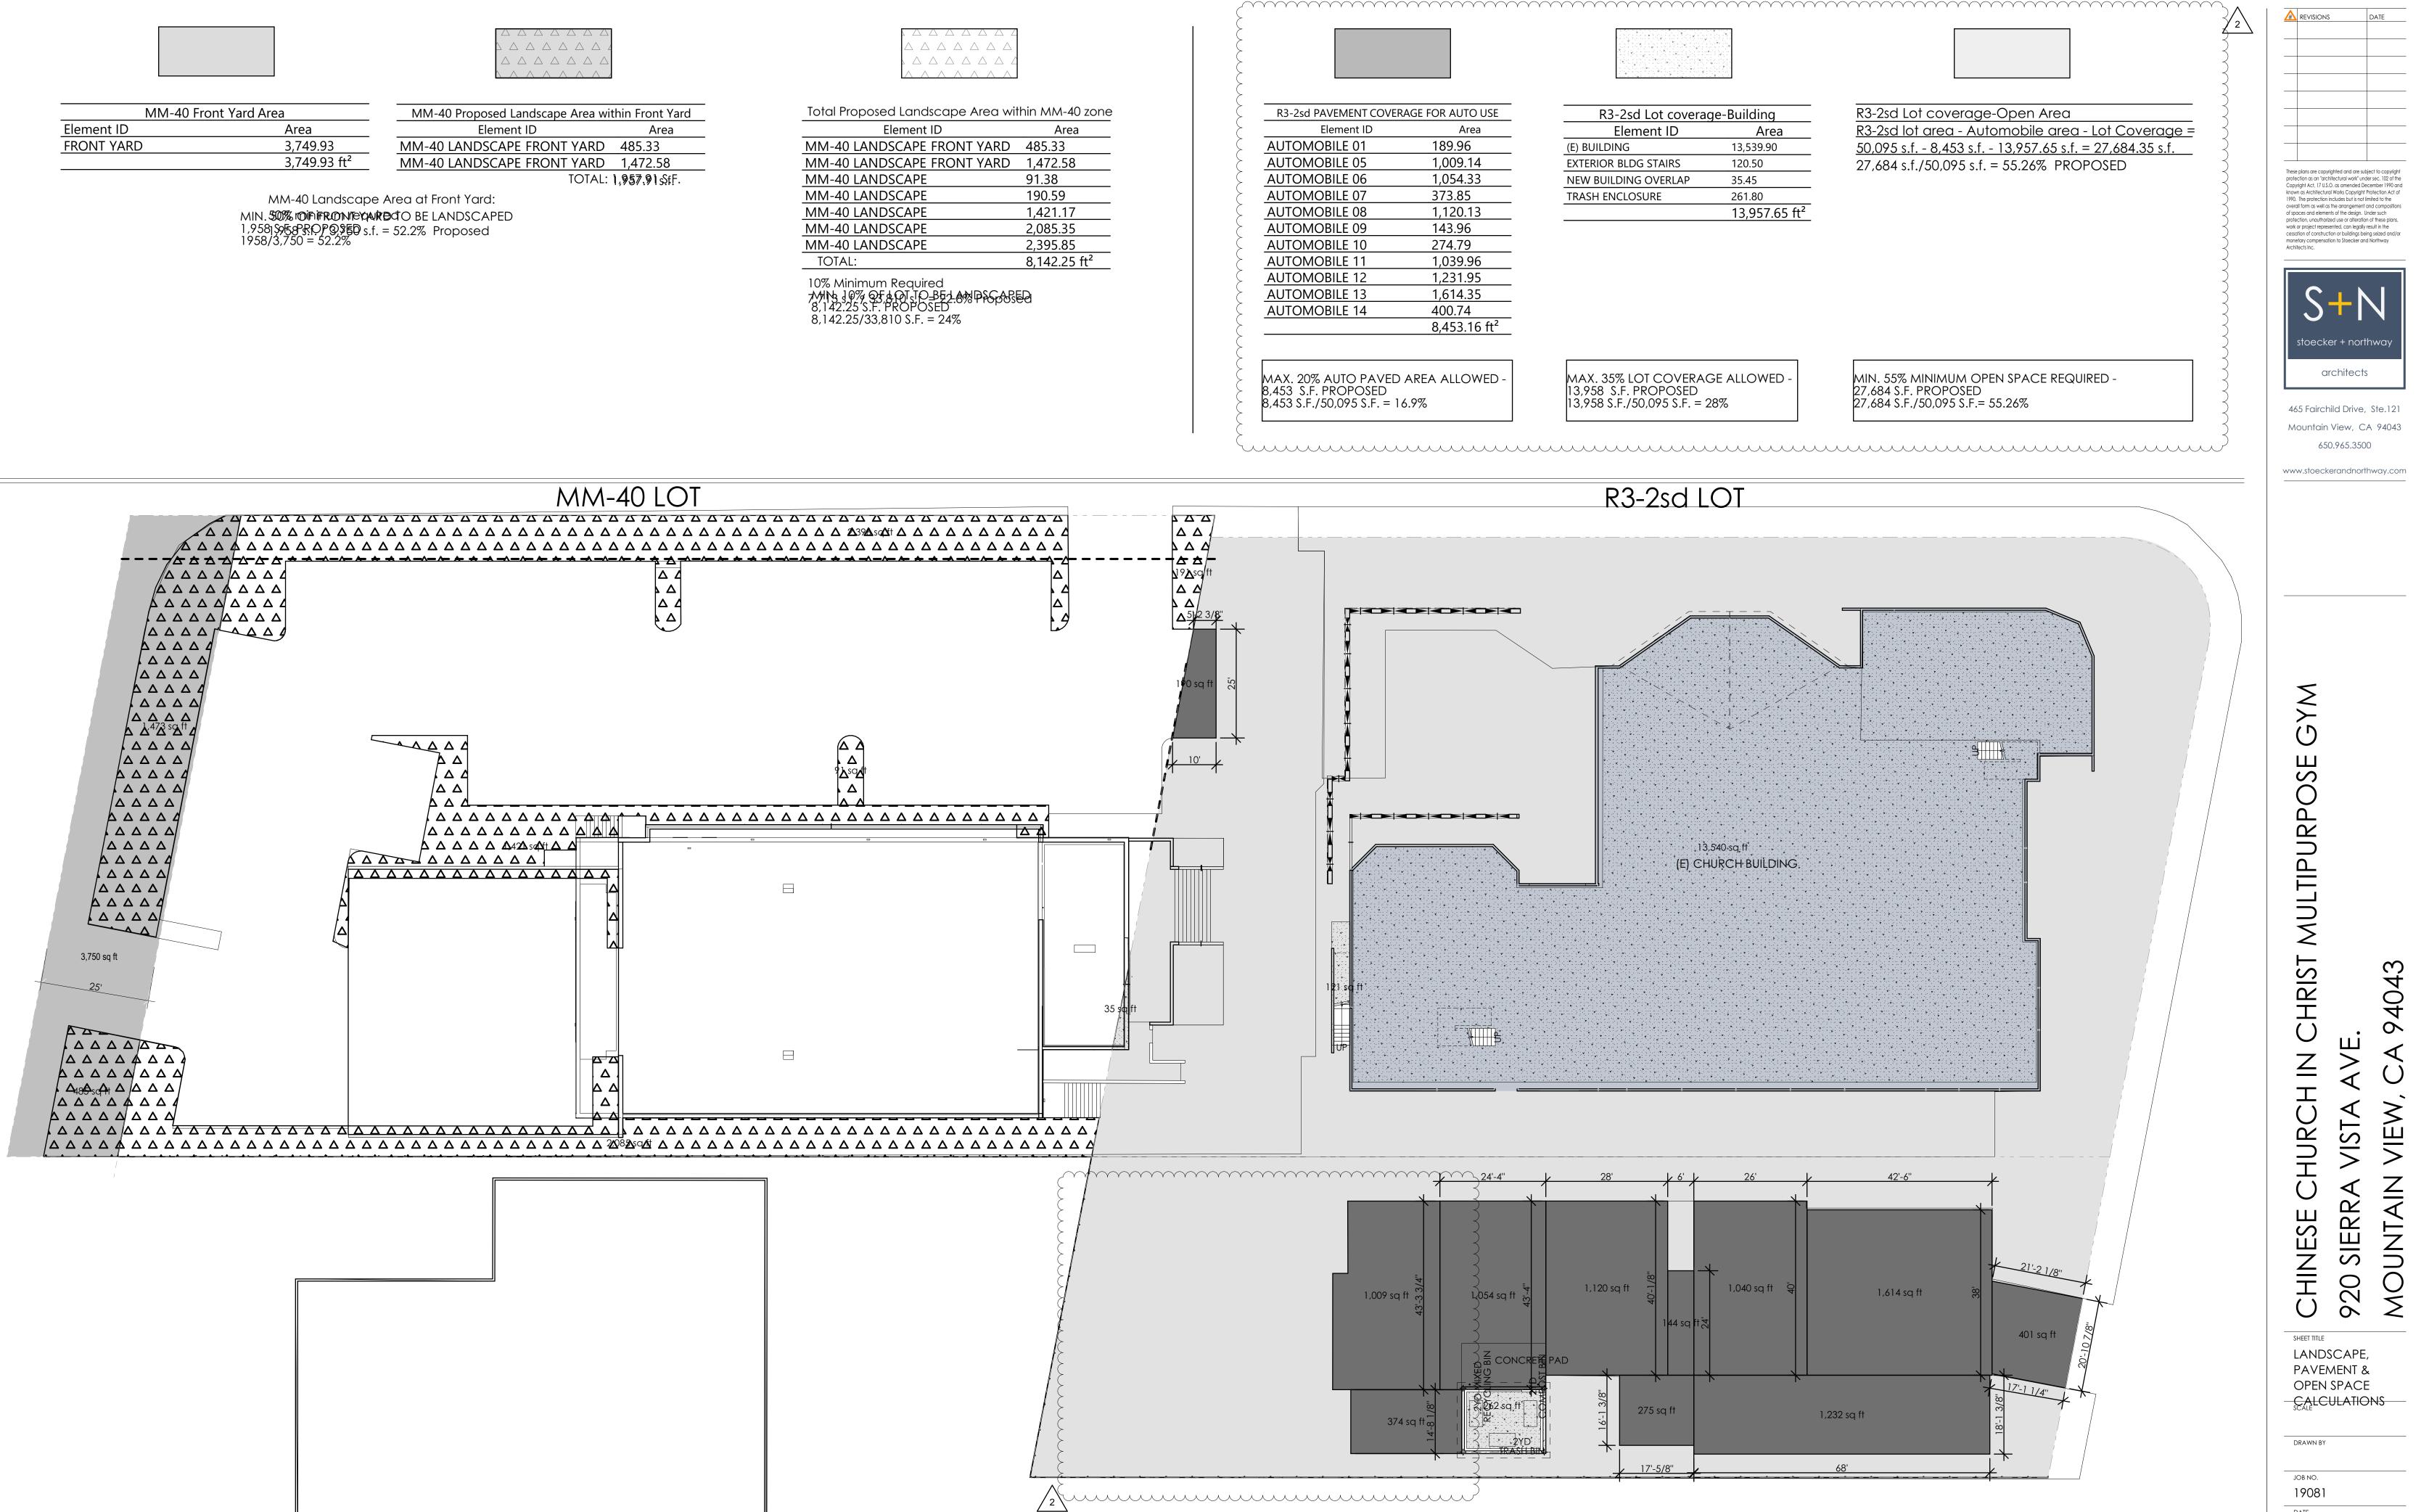
A15





MM-40 Front Yard Area			
Element ID	Area		
FRONT YARD	3,749.93		
	3 749 93 ft ²		

Element ID Area

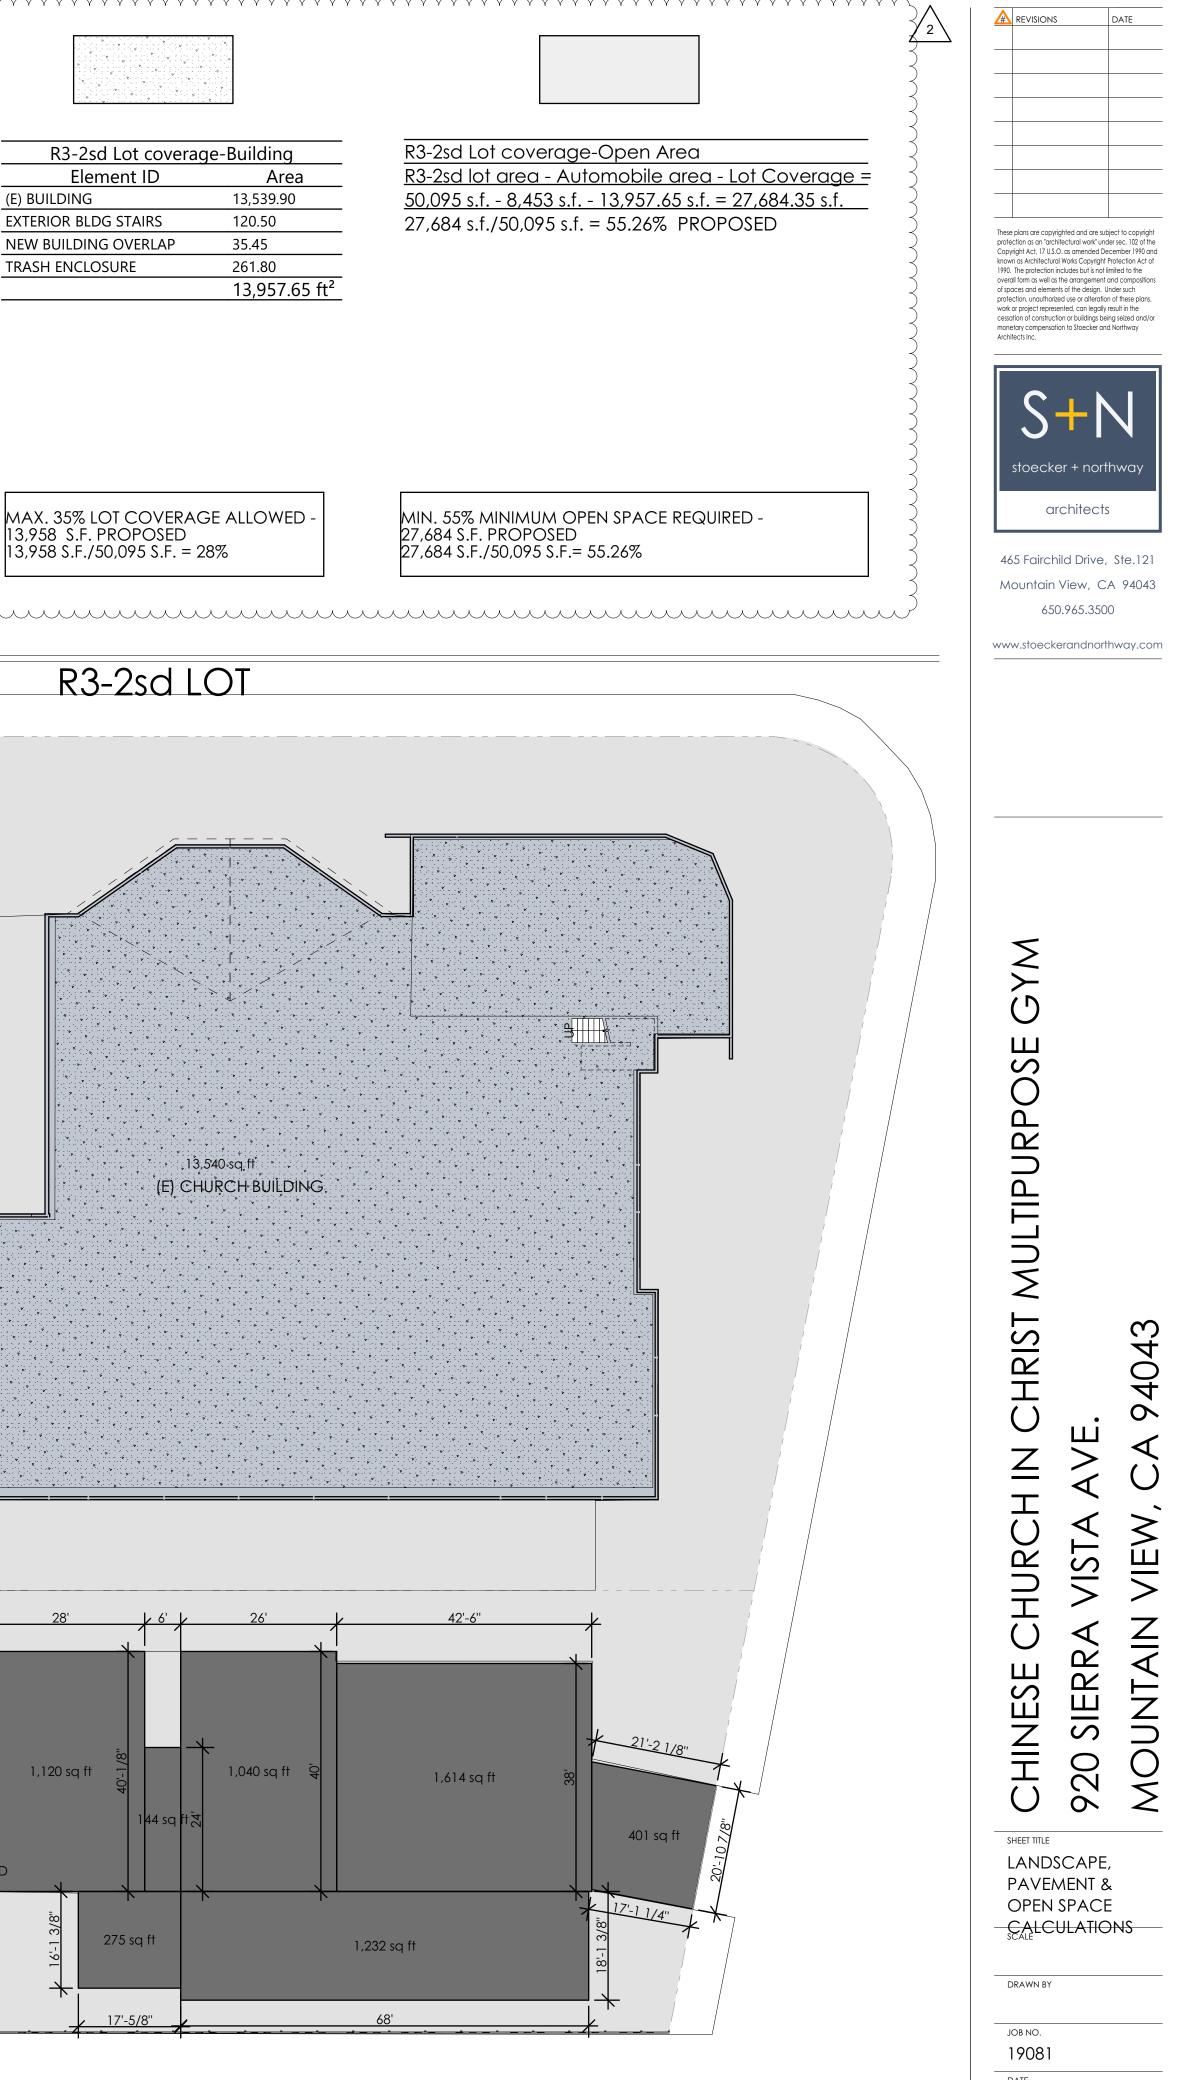


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Element ID	Area
MM-40 LANDSCAPE FRONT YARD	485.33
MM-40 LANDSCAPE FRONT YARD	1,472.58
MM-40 LANDSCAPE	91.38
MM-40 LANDSCAPE	190.59
MM-40 LANDSCAPE	1,421.17
MM-40 LANDSCAPE	2,085.35
MM-40 LANDSCAPE	2,395.85
TOTAL:	8,142.25 ft ²

R3-2sd PAVEMENT COVE	RAGE FOR AUTO USE
Element ID	Area
AUTOMOBILE 01	189.96
AUTOMOBILE 05	1,009.14
AUTOMOBILE 06	1,054.33
AUTOMOBILE 07	373.85
AUTOMOBILE 08	1,120.13
AUTOMOBILE 09	143.96
AUTOMOBILE 10	274.79
AUTOMOBILE 11	1,039.96
AUTOMOBILE 12	1,231.95
AUTOMOBILE 13	1,614.35
AUTOMOBILE 14	400.74
	8,453.16 ft ²

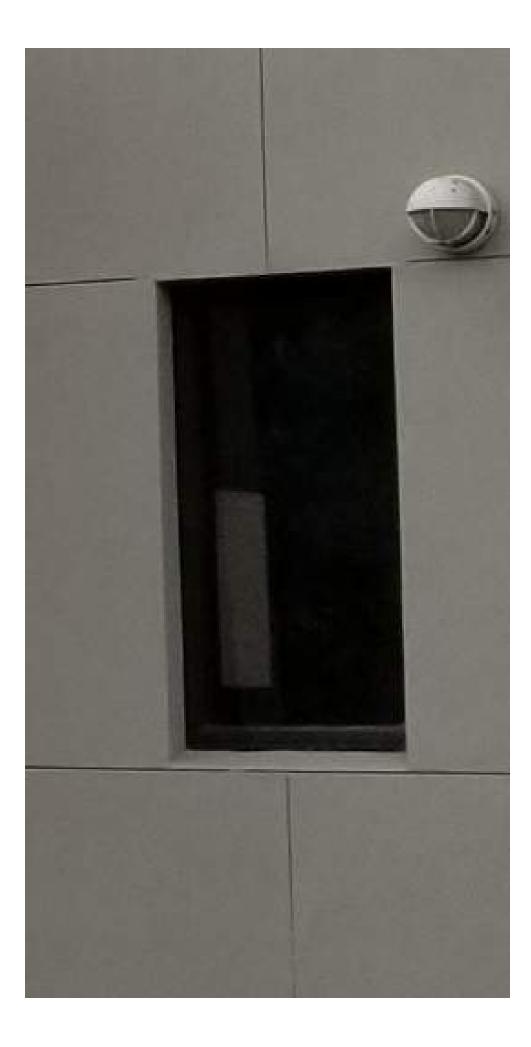
R3-2sd Lot c
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e) building
EXTERIOR BLDG STAIR
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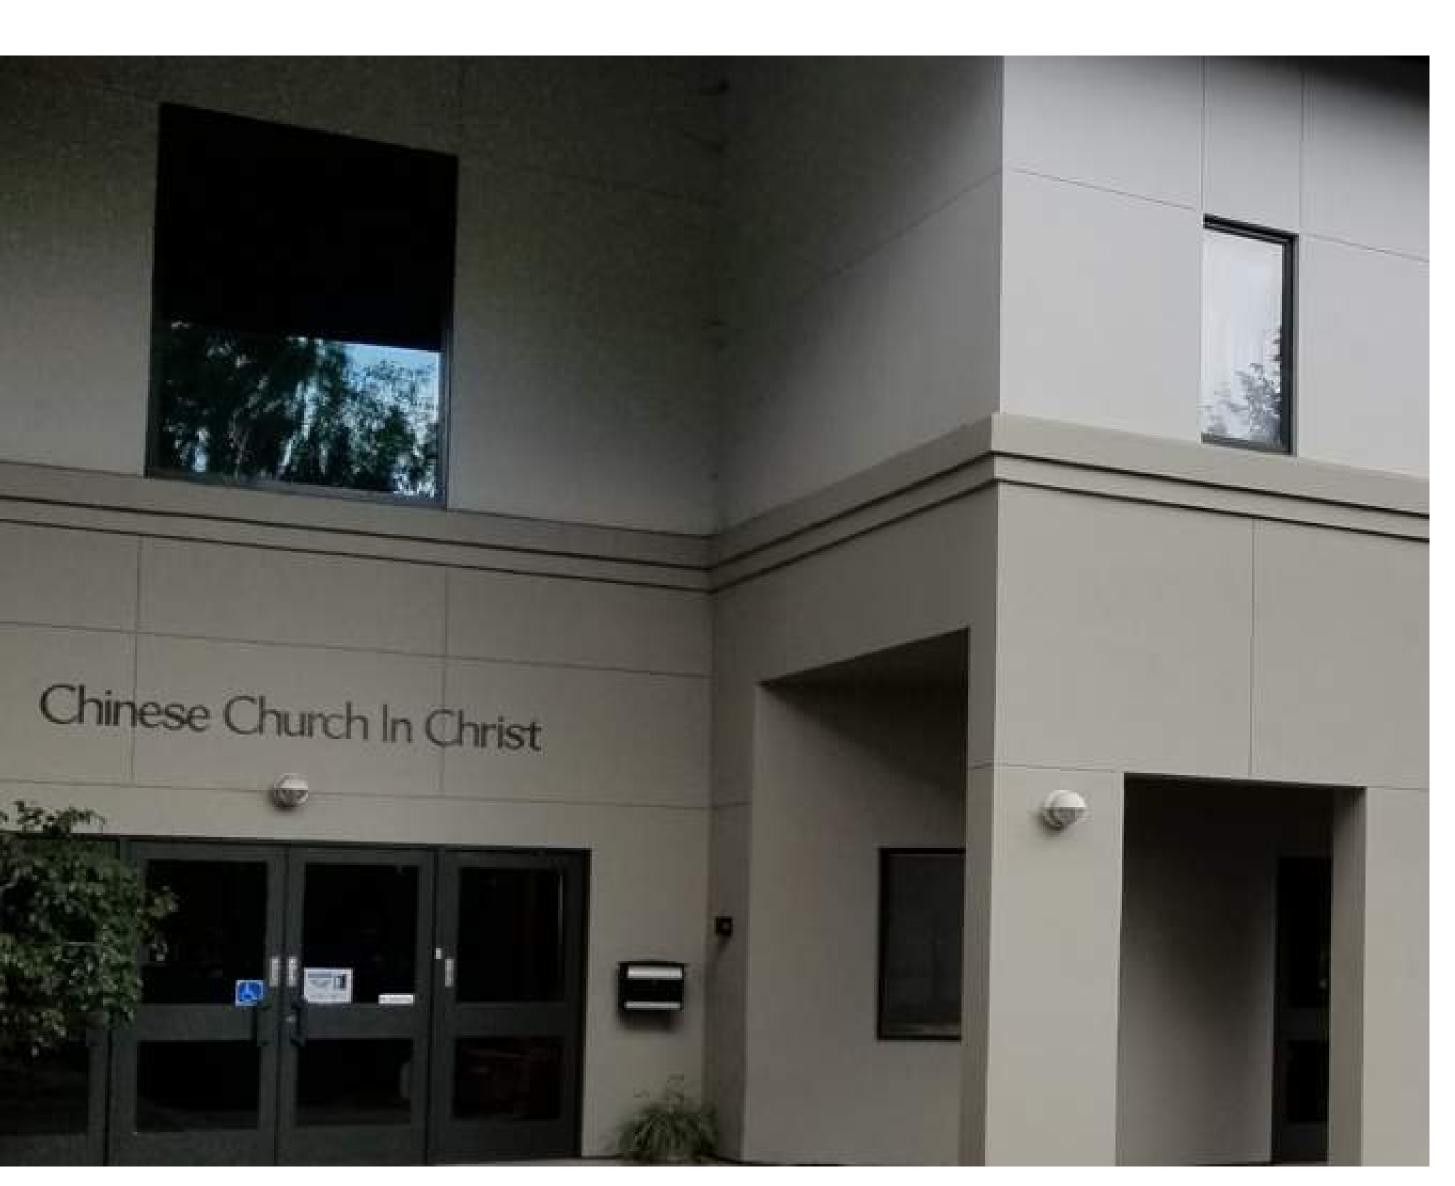




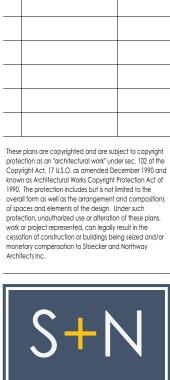


BLACK ALUMINUM WINDOW AND DOOR FRAMES

3.0



FLAT CONCRETE ROOF TILE MATCH ORIGINAL "OXFORD BROWN" COLOR





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PAINT COLOR 1 SHERWIN-WILLIAMS "REPOSE GRAY" SW 7015



PAINT COLOR 2 SHERWIN-WILLIAMS "INTELLECTUAL GRAY" SW 7045

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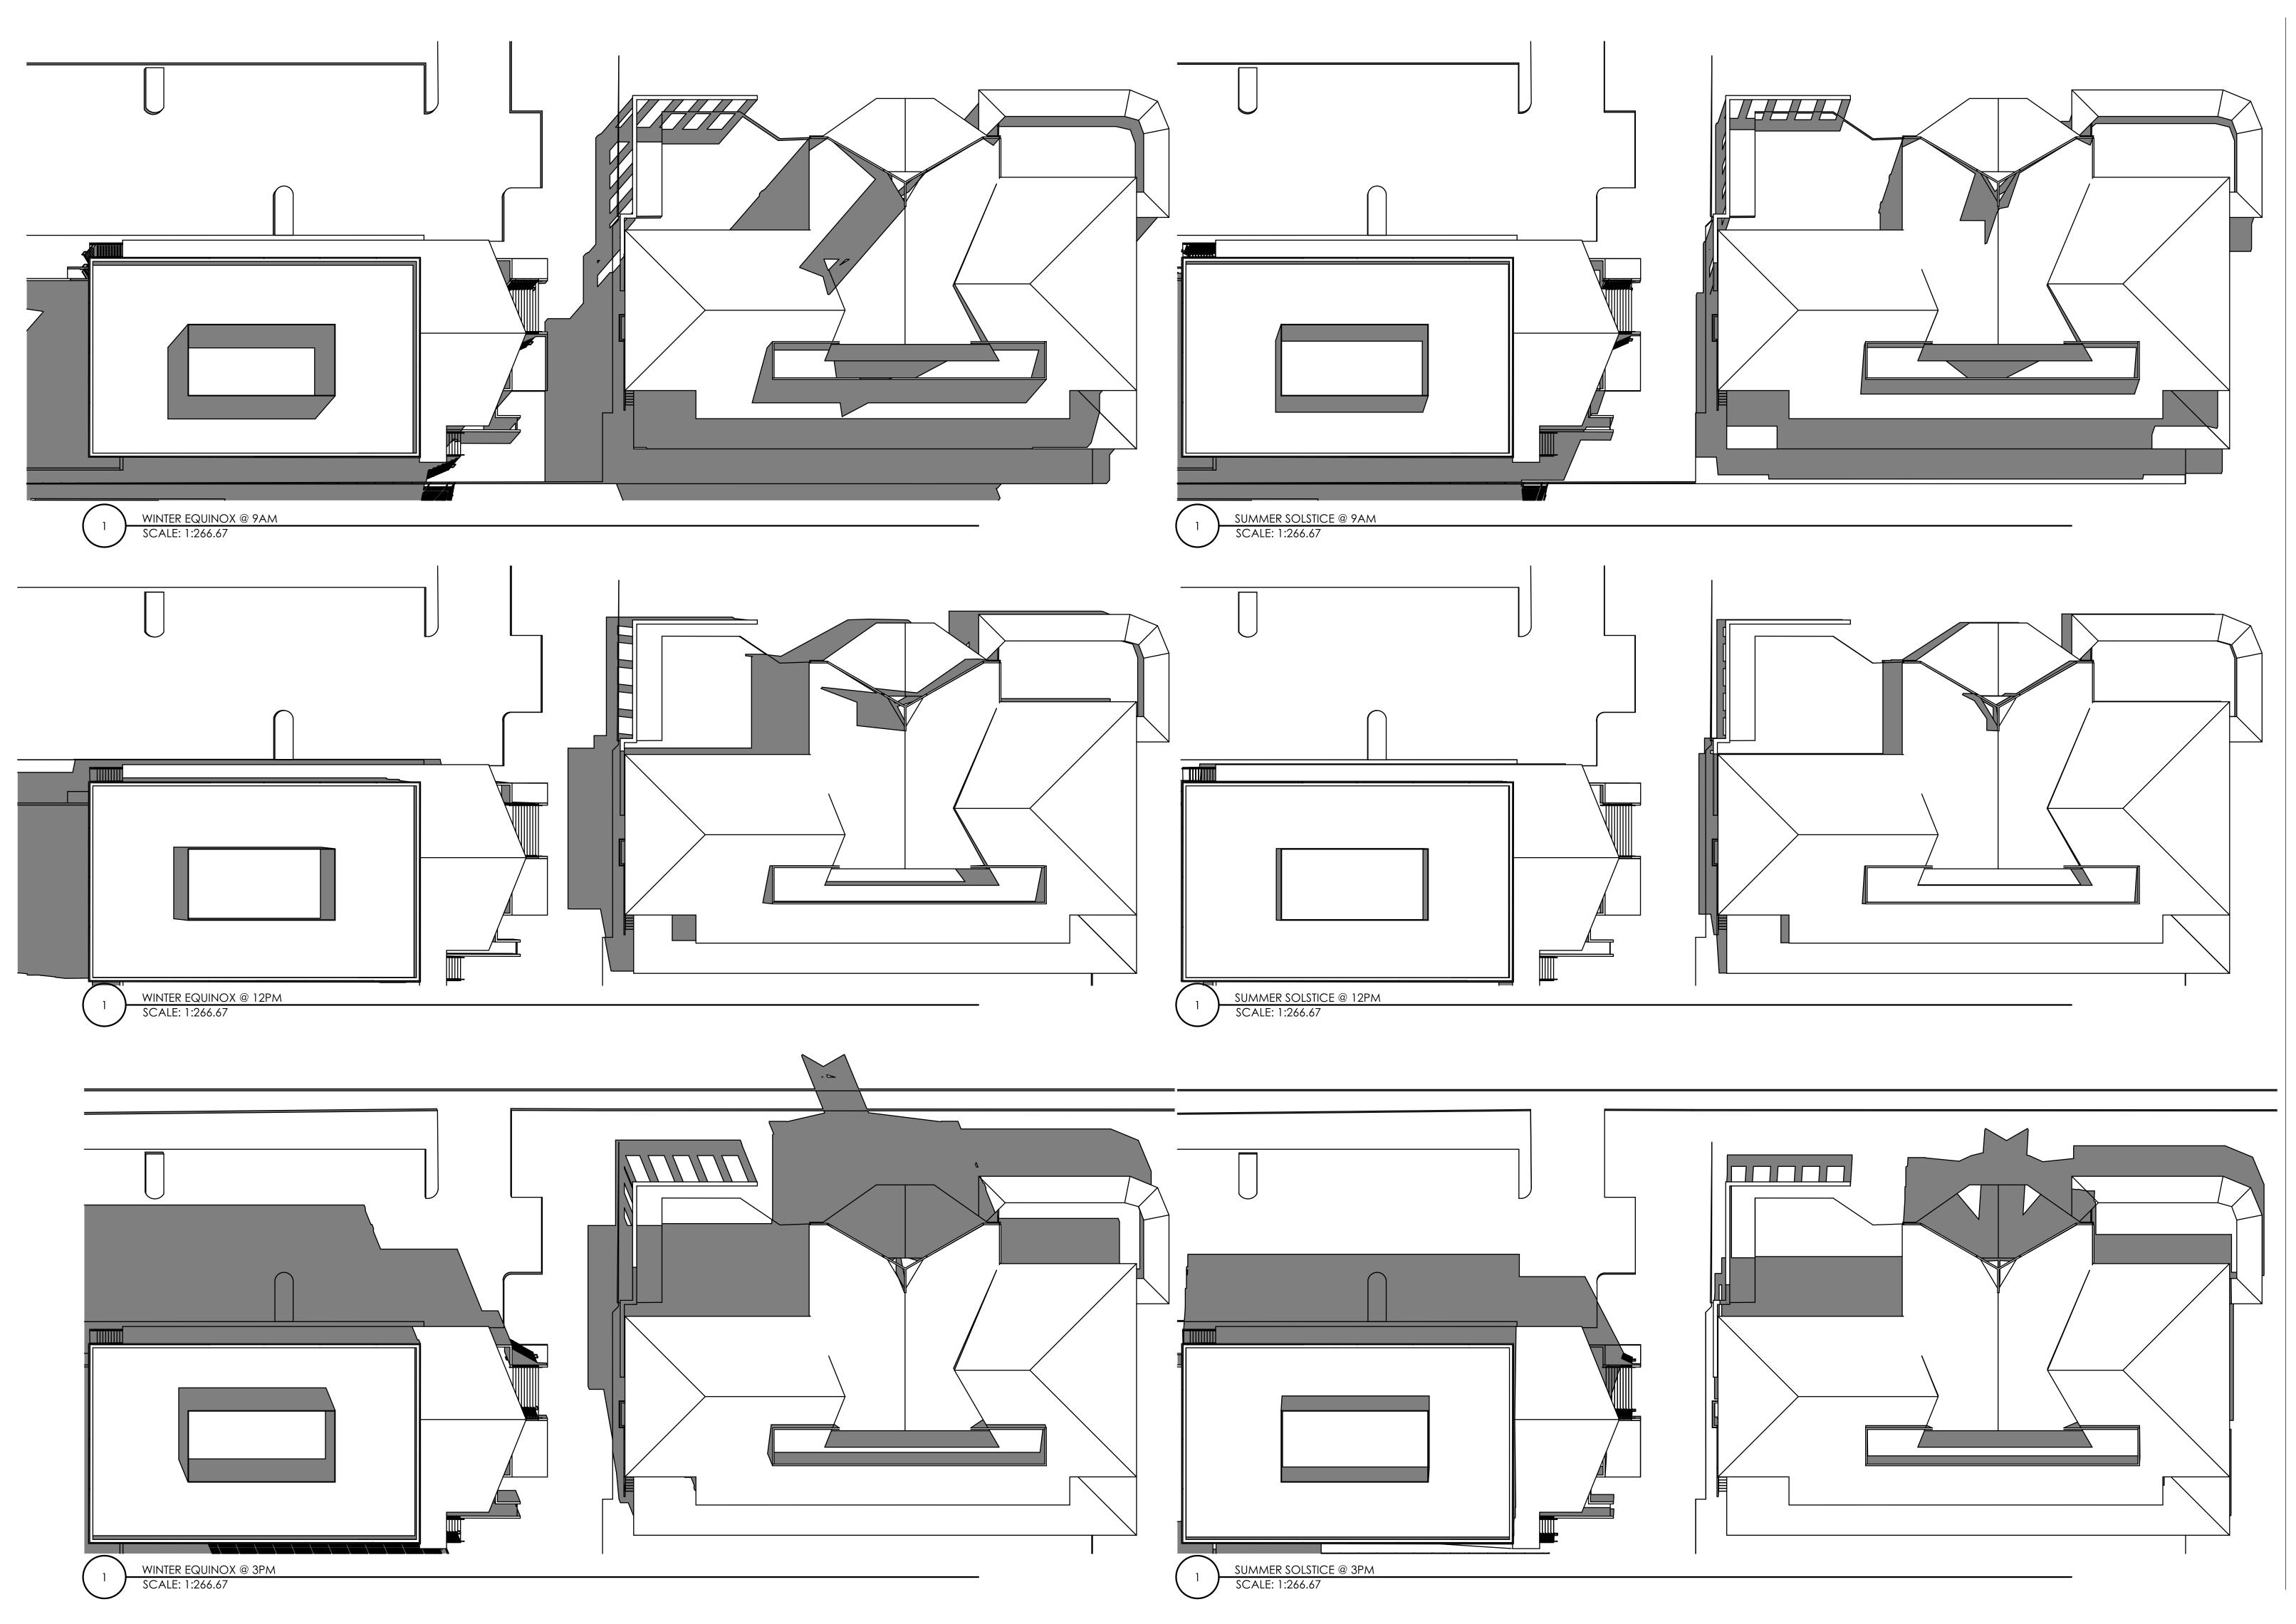
SHEET TITLE MATERIALS PALETTE

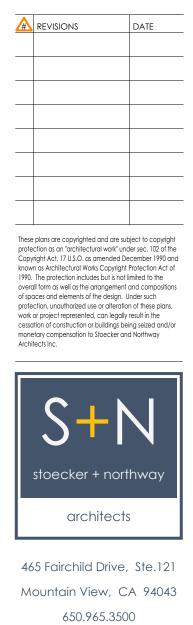
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CHINESE

94043 Ш \triangleleft AV \bigcirc VIEW, VISTA 920 SIERRA V MOUNTAIN

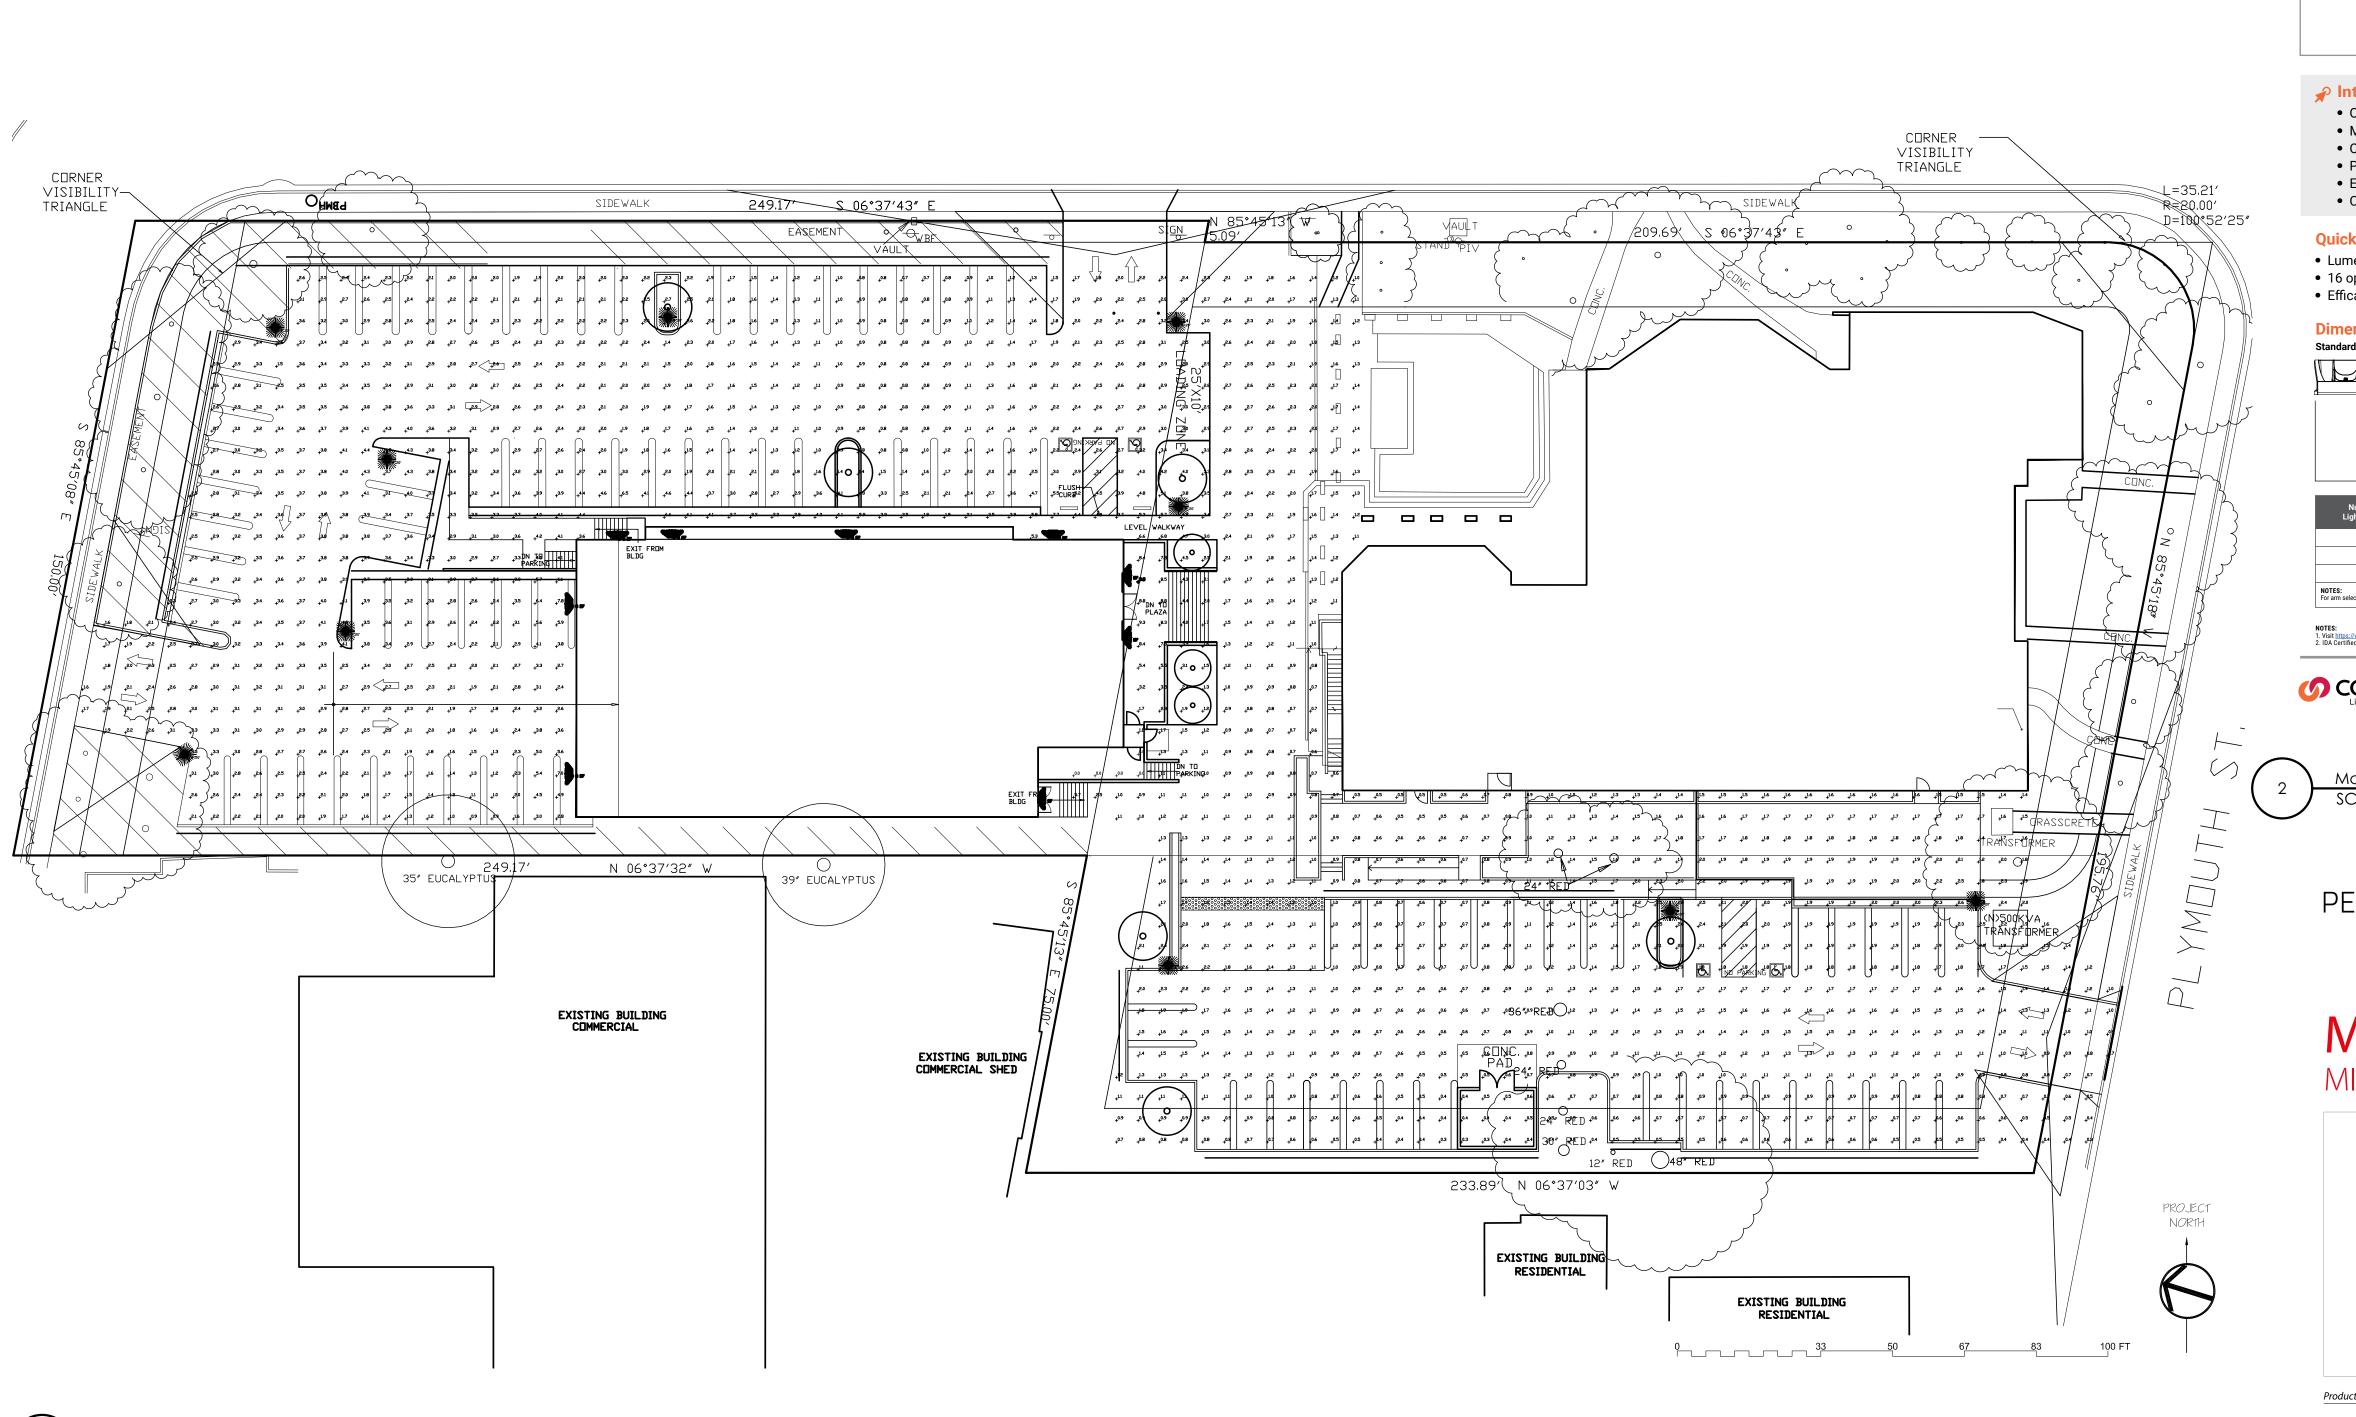
SHEET TITLE sun study

SCALE

DRAWN BY

JOB NO. 19081 DATE 08/01/2023 SHEET

A18



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PHOTOMETRICS

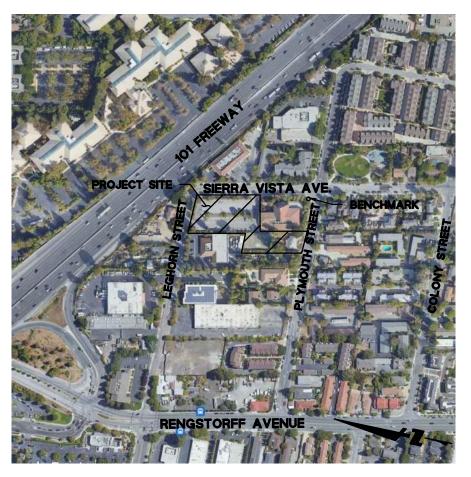
Schedule											
Symbol	Label	Image	Quantity	Manufacturer	Catalog Number	Description	Number Lamps	Lumens PerLamp	Light Loss Factor	Wattage	Plot
	А		10	COOPER LIGHTING SOLUTIONS - McGRAW- EDISON (FORMERLY EATON)	GALN-SA2C-730-U-5WQ	GALLEON AREA AND ROADWAY LUMINARE (2) 70 CR3 30004 (1958m) LIGHTS JUARES WITH 19 LEDS EACH AND TYPE V WIDE OPTICS	32	421	0.95	108	
-	в		9	Performance iN Lighting	071164	MNIK 20 M 20W 730 Type∎0-10V Aluminum metallic	1	2273	0.95	26	. Station in the station of the stat

Statistics						
Description	Symbol	Avg	Max	Min	Max/Min	Avg/Min
Site Lighting	+	2.0 fc	9.8 fc	0.0 fc	N/A	N/A

3

	McGraw-Edison	
	GALN Galleon II Area / Site Luminaire	
	Product Features	These plans are copyrighted and are subject to copyright
	Light ARchitect™	protection as an "architectural work" under sec. 102 of the Copyright Act, 17 U.S.O. as amended December 1990 and known as Architectural Works Copyright Protection Act of 1990. The protection includes but is not limited to the overall form as well as the arrangement and compositions of spaces and elements of the design. Under such
 Interactive Menu Ordering Information page 2 Mounting Details page 3 	Product Certifications	protection, unauthorized use or alteration of these plans, work or project represented, can legally result in the cessation of construction or buildings being seized and/or monetary compensation to Stoecker and Northway Architects Inc.
 Optical Distributions page 5 Product Specifications page 5 Energy and Performance Data page 6 Control Options 		
 Control Options page 10 Quick Facts Lumen packages range from 3,300 - 73,500 (33W - 552W) 16 optical distributions 	 Connected Systems WaveLinx Lite WaveLinx 	stoecker + northway architects
 Efficacy up to 159 lumens per watt Dimensional Details Standard Arm 		465 Fairchild Drive, Ste.121
		Mountain View, CA 94043 650.965.3500 www.stoeckerandnorthway.com
"A" "B" "B" "B" "B" "B"	9-1/2" [241mm] twith Standard or QM Arm or QM Arm	
1-4 16" 22" 5-6 22" 22" 7-9 22" 28-1/8"	29 lb 0.95 39 lb 0.95 48 lb 1.1	
NOTES: For arm selection requirements and additional line art, see Mounting Details section. NOTES: 1. Visit https://www.designlights.org/search/ to confirm qualification. Not all product variations are DLC qualified. 2. IDA Certified for 3000K CCT and warmer only.		
	PS500052EN page 1 January 13, 2022 10:45 AM	
Macrowy Edison Lighting College II Series		N N N
McGraw-Edison Lighting- Galleon II Series SCALE: 1' = 1'-0"	2022 Version	Ŭ
PERFORMANCE	PRODUCT CODE	URPOSE
	PROJECT	-
MIMIK series MIMIK 20		CHRIST MULTIP 94043
		A C A C A C A C A C
Product Family	Optics	L Z Z
MIMIK 20 FLAT	MIMIK 20 FLAT M FLAT B	CHINESE CHURCI 920 SIERRA VISTA MOUNTAIN VIEW
	MIMIK 20 TYPE II MIMIK 20 TYPE III MIMIK 20 TYPE IV MIMIK 20 TYPE IV	SHEET TITLE LIGHTING PLAN SCALE DRAWN BY
MIMIK 20		JOB NO. 19081
	, Georgia 30013 - USA - voice 770.822.2115 - info.usa@pil.lighting rmanceinlighting.com	DATE 04/07/2023 SHEET

LE1



VICINITY MAP

BENCHMARK

ELEVATIONS SHOWN HEREON ARE BASED UPON THE CITY OF MOUNTAIN VIEW (NAVD 88) DATUM. BENCHMARK USED WAS THE BRONZE DISK STAMPED "III-30" ON TOP OF CURB AT THE NORTHWEST RETURN OF SIERRA VISTA AVENUE AT PLYMOUTH STREET

ELEVATION: 16.501 FEET.

BASIS OF BEARING

THE BEARING, NORTH 85'45'08" WEST, OF THE MONUMENT LINE OF LEGHORN STREET. AS SHOWN ON THAT CERTAIN PARCEL MAP WHICH WAS FILED FOR RECORD IN BOOK 619 OF MAPS PAGE 26 ON OCTOBER 10, 1990, SANTA CLARA COUNTY RECORDS, WAS USED AS THE BASIS OF BEARINGS FOR THIS SURVEY.

ELECTRIC, TELEPHONE, GAS AND CATV UTILITY INSTALLATION

THE ELECTRIC, TELEPHONE, GAS AND CABLE TV UTILITIES PLANS ARE PRELIMINARY, THESE UTILITIES SHALL NOT BE INSTALLED UNTIL THE FINAL JOINT UTILITY PLANS HAVE BEEN APPROVED BY THE PUBLIC WORKS DEPARTMENT AND UTILITY COMPANIES. SURFACE MOUNTED TRANSFORMERS AND ABOVE GROUND CABINETS ARE NOT ALLOWED FOR THIS PROJECT. AS-BUILT JOINT UTILITY PLANS SHALL BE INCLUDED WITH THE AS-BUILT OF THESE PLANS.

THE UNDERGROUNDING OF THE NEW AND EXISTING ELECTRIC, GAS, TELEPHONE, AND CABLE TELEVISION SERVICES IS TO BE COMPLETED PRIOR TO ISSUANCE OF AN OCCUPANCY CERTIFICATE FOR ANY NEW BUILDINGS WITHIN THE SITE.

RECOLOGY MOUNTAIN VIEW

RECOLOGY MOUNTAIN VIEW IS THE CITY'S EXCLUSIVE HAULER FOR RECYCLING AND DISPOSAL OF CONSTRUCTION AND DEMOLITION DEBRIS. FOR ALL DEBRIS BOXES, CONTACT RECOLOGY. USING ANOTHER HAULER MAY VIOLATE MOUNTAIN VIEW CITY CODE SECTIONS 16.13 AND 16.17 AND RESULT IN CODE ENFORCEMENT ACTION.

COMMERCIAL OCCUPANCY RELEASE

FOR COMMERCIAL AND OFFICE DEVELOPMENTS, NO BUILDINGS WILL BE RELEASED FOR OCCUPANCY UNTIL THE OFF-SITE IMPROVEMENTS TO BE CONSTRUCTED TO CITY PUBLIC WORKS STANDARDS AND/OR ACCEPTED FOR MAINTENANCE BY THE CITY ARE COMPLETE AND READY FOR ACCEPTANCE.

FIRE SERVICE INSTALLATION NOTES

THE FIRE SERVICES, INCLUDING WATER SERVICES SUPPLYING NFPA 13D FIRE SPRINKLERS, SHOWN ON THESE PLANS ARE PRELIMINARY AND SHALL NOT BE INSTALLED UNTIL AFTER THE FIRE SPRINKLER PLANS HAVE BEEN APPROVED BY THE CITY. IF THE FIRE SPRINKLER PLANS REQUIRE CHANGES TO THE UTILITIES SHOWN ON THESE PLANS, REVISIONS TO THESE PLANS MUST BE APPROVED BY THE PUBLIC WORKS DEPARTMENT PRIOR TO THE INSTALLATION OF THE FIRE UTILITIES.

CONSTRUCTION AND DEMOLITION ORDINANCE

THE PROJECT IS SUBJECT TO THE REQUIREMENTS OF THE MOUNTAIN VIEW GREEN BUILDING CODE. A CONSTRUCTION AND DEMOLITION DEBRIS MANAGEMENT PLAN SHALL BE SUBMITTED WITH THE INITIAL BUILDING PERMIT APPLICATION AND APPROVED BY THE SOLID WASTE AND RECYCLING SECTION PRIOR TO ISSUANCE OF A BUILDING PERMIT. A FINAL CONSTRUCTION WASTE DISPOSITION REPORT SHALL BE SUBMITTED AND APPROVED PRIOR TO FINAL INSPECTION.

STREET CLEANING

THE PRIME CONTRACTOR OR DEVELOPER IS TO HIRE A STREET CLEANING CONTRACTOR TO CLEAN UP DIRT AND DEBRIS FROM CITY STREETS THAT ARE ATTRIBUTABLE TO THE DEVELOPMENT'S CONSTRUCTION ACTIVITIES. THE STREET CLEANING CONTRACTOR IS TO HAVE THE CAPABILITY OF SWEEPING THE STREETS WITH BOTH A BROOM-TYPE SWEEPER AND A REGENERATIVE AIR VACUUM SWEEPER, AS DIRECTED BY THE PUBLIC WORKS DIRECTOR OR HIS/HER DESIGNATED REPRESENTATIVE.



STEVE SUN CHINESE CHURCH IN CHRIST 920 SIERRA VISTA AVENUE MOUNTIAN VIEW, CA 94043

ARCHITECT

(650) 482-6320

ZONE:

CYNTHIA MUNOZ STOECKER & NORTHWAY 4633 OLD IRONSIDES DR SUITE 130, SANTA CLARA, CA 95054 (650) 965-3500

CIVIL ENGINEER MICHAEL O'CONNELL BKF ENGINEERS 255 SHORELINE DRIVE, SUITE 200 REDWOOD CITY, CA 94065

LANDSCAPE ARCHITECT

CALANDRA MONASTERIO HMH LANDSCAPE ARCHITECTURE 1570 OLD OAKLAND RD, SAN JOSE, CA 95131 (408) 487-2200

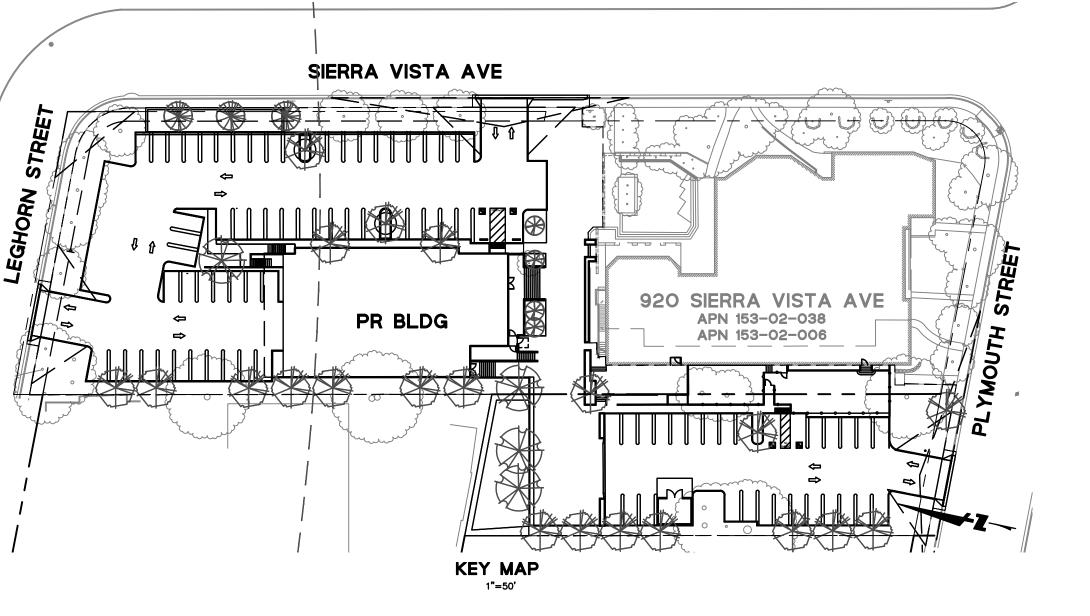
PROJECT SUMMARY

920 SIERRA VISTA AVENUE (R3-2sd/MM-40) 1960 PLYMOUTH STREET (R2-2sd)

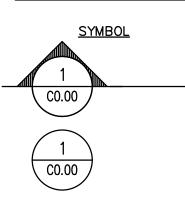
ASSESSOR'S PARCEL NUMBER: 920 SIERRA VISTA AVENUE (153-02-038) 1960 PLYMOUTH STREET (153-02-006)

OCCUPANCY TYPE: A-3 CONSTRUCTION TYPE: V-A WITH SPRINKLER SYSTEM SPECIAL FLOOD HAZARD ZONE: ZONE AO - FLOOD MAP 06085C0037H EFFECTIVE 05/18/2009

920 SIERRA VISTA AVENUE FORMAL REVIEW SUBMITTAL CITY OF MOUNTAIN VIEW, CALIFORNIA



SYMBOL LEGEND



DESCRIPTION

SECTION 1 ON SHEET CO.00

DETAIL 1 ON SHEET CO.00

SHEET INDEX

	CIVIL SHEET INDEX				
SHEET NO.	SHEET TITLE				
C1.00	TITLE SHEET				
C1.01	GENERAL NOTES				
C1.02	GENERAL NOTES				
C1.03	GENERAL NOTES				
C2.00	EXISTING CONDITIONS & DEMOLITION PLAN				
C3.00	GRADING PLAN				
C3.01	GRADING PLAN				
C3.02	CROSS SECTIONS				
C4.00	UTILITY PLAN				
C4.01	UTILITY PLAN				
C5.00	STORMWATER MANAGEMENT PLAN				
C5.01	STORMWATER DETAILS				
C6.00	FIRE TRUCK TURNING PLAN				
C6.01	TRASH TRUCK TURNING PLAN				
C7.00	CONSTRUCTION DETAILS				

THESE IMPROVEMENT PLANS HAVE BEEN PREPARED BY ME OR UNDER MY DIRECTION IN ACCORDANCE WITH STANDARD ENGINEERING PRACTICE.

ENGINEER'S STATEMENT

MICHAEL O'CONNELL RCE NUMBER: 75811 EXPIRES: 6/30/2024

LEGEND

<u>EXISTING</u> _____

_ __ __ __ _____10 _____ — SS — —— GAS —— ____ GAS ____ ——— OH ____ OH _____ _____ \otimes **CO** O SSCO ത WM \bowtie 8 \mathcal{O} \square

PROPOSED

PROPERTY LINE EASEMENT LINE LEASE PARCEL LINE CONTOUR LINE STORM DRAIN SANITARY SEWER DOMESTIC WATER FIRE WATER RECYCLED WATER GAS LINE TELECOM LINE ELECTRIC LINE FIBER OPTICS JOINT TRENCH OVERHEAD ELECTRICAL WIRE POTHOLE SANITARY SEWER CLEANOUT SANITARY SEWER MANHOLE STORM DRAIN AREA DRAIN STORM DRAIN DROP INLET STORM DRAIN MANHOLE BIORETENTION WATER METER WATER VALVE FIRE HYDRANT FDC TRANSFORMER ELECTRICAL BOX

LINEAR FEET

LF

LG

LID

LP

LT

N

OH

PIV

ΡL

PR

RS

SD

SQ

SS

ST

SW

TB

TBD

TC

TCM

TCN

TEL

TP

TS

TS

TYP

VC

w

WB

WM

WV

REVIEWED BY:

DATE

APPROVAL RECOMMENDED BY:

PUBLIC WORKS DEPARTMENT

CITY OF MOUNTAIN VIEW, CALIFORNIA

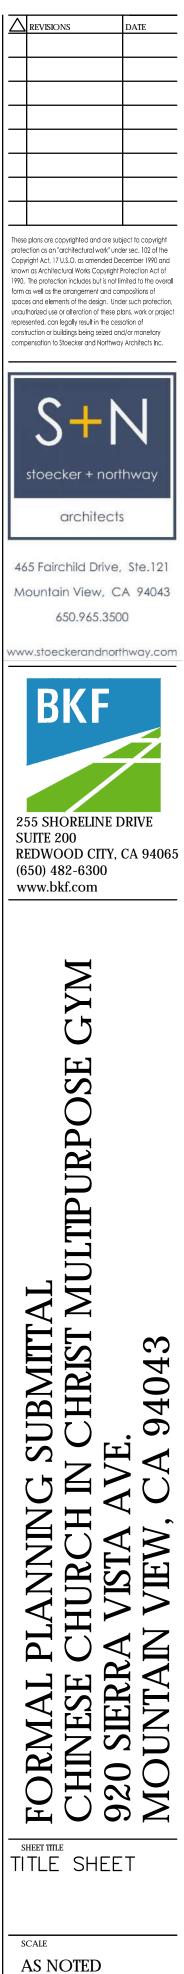
APPROVED BY:

ABBREVIATIONS

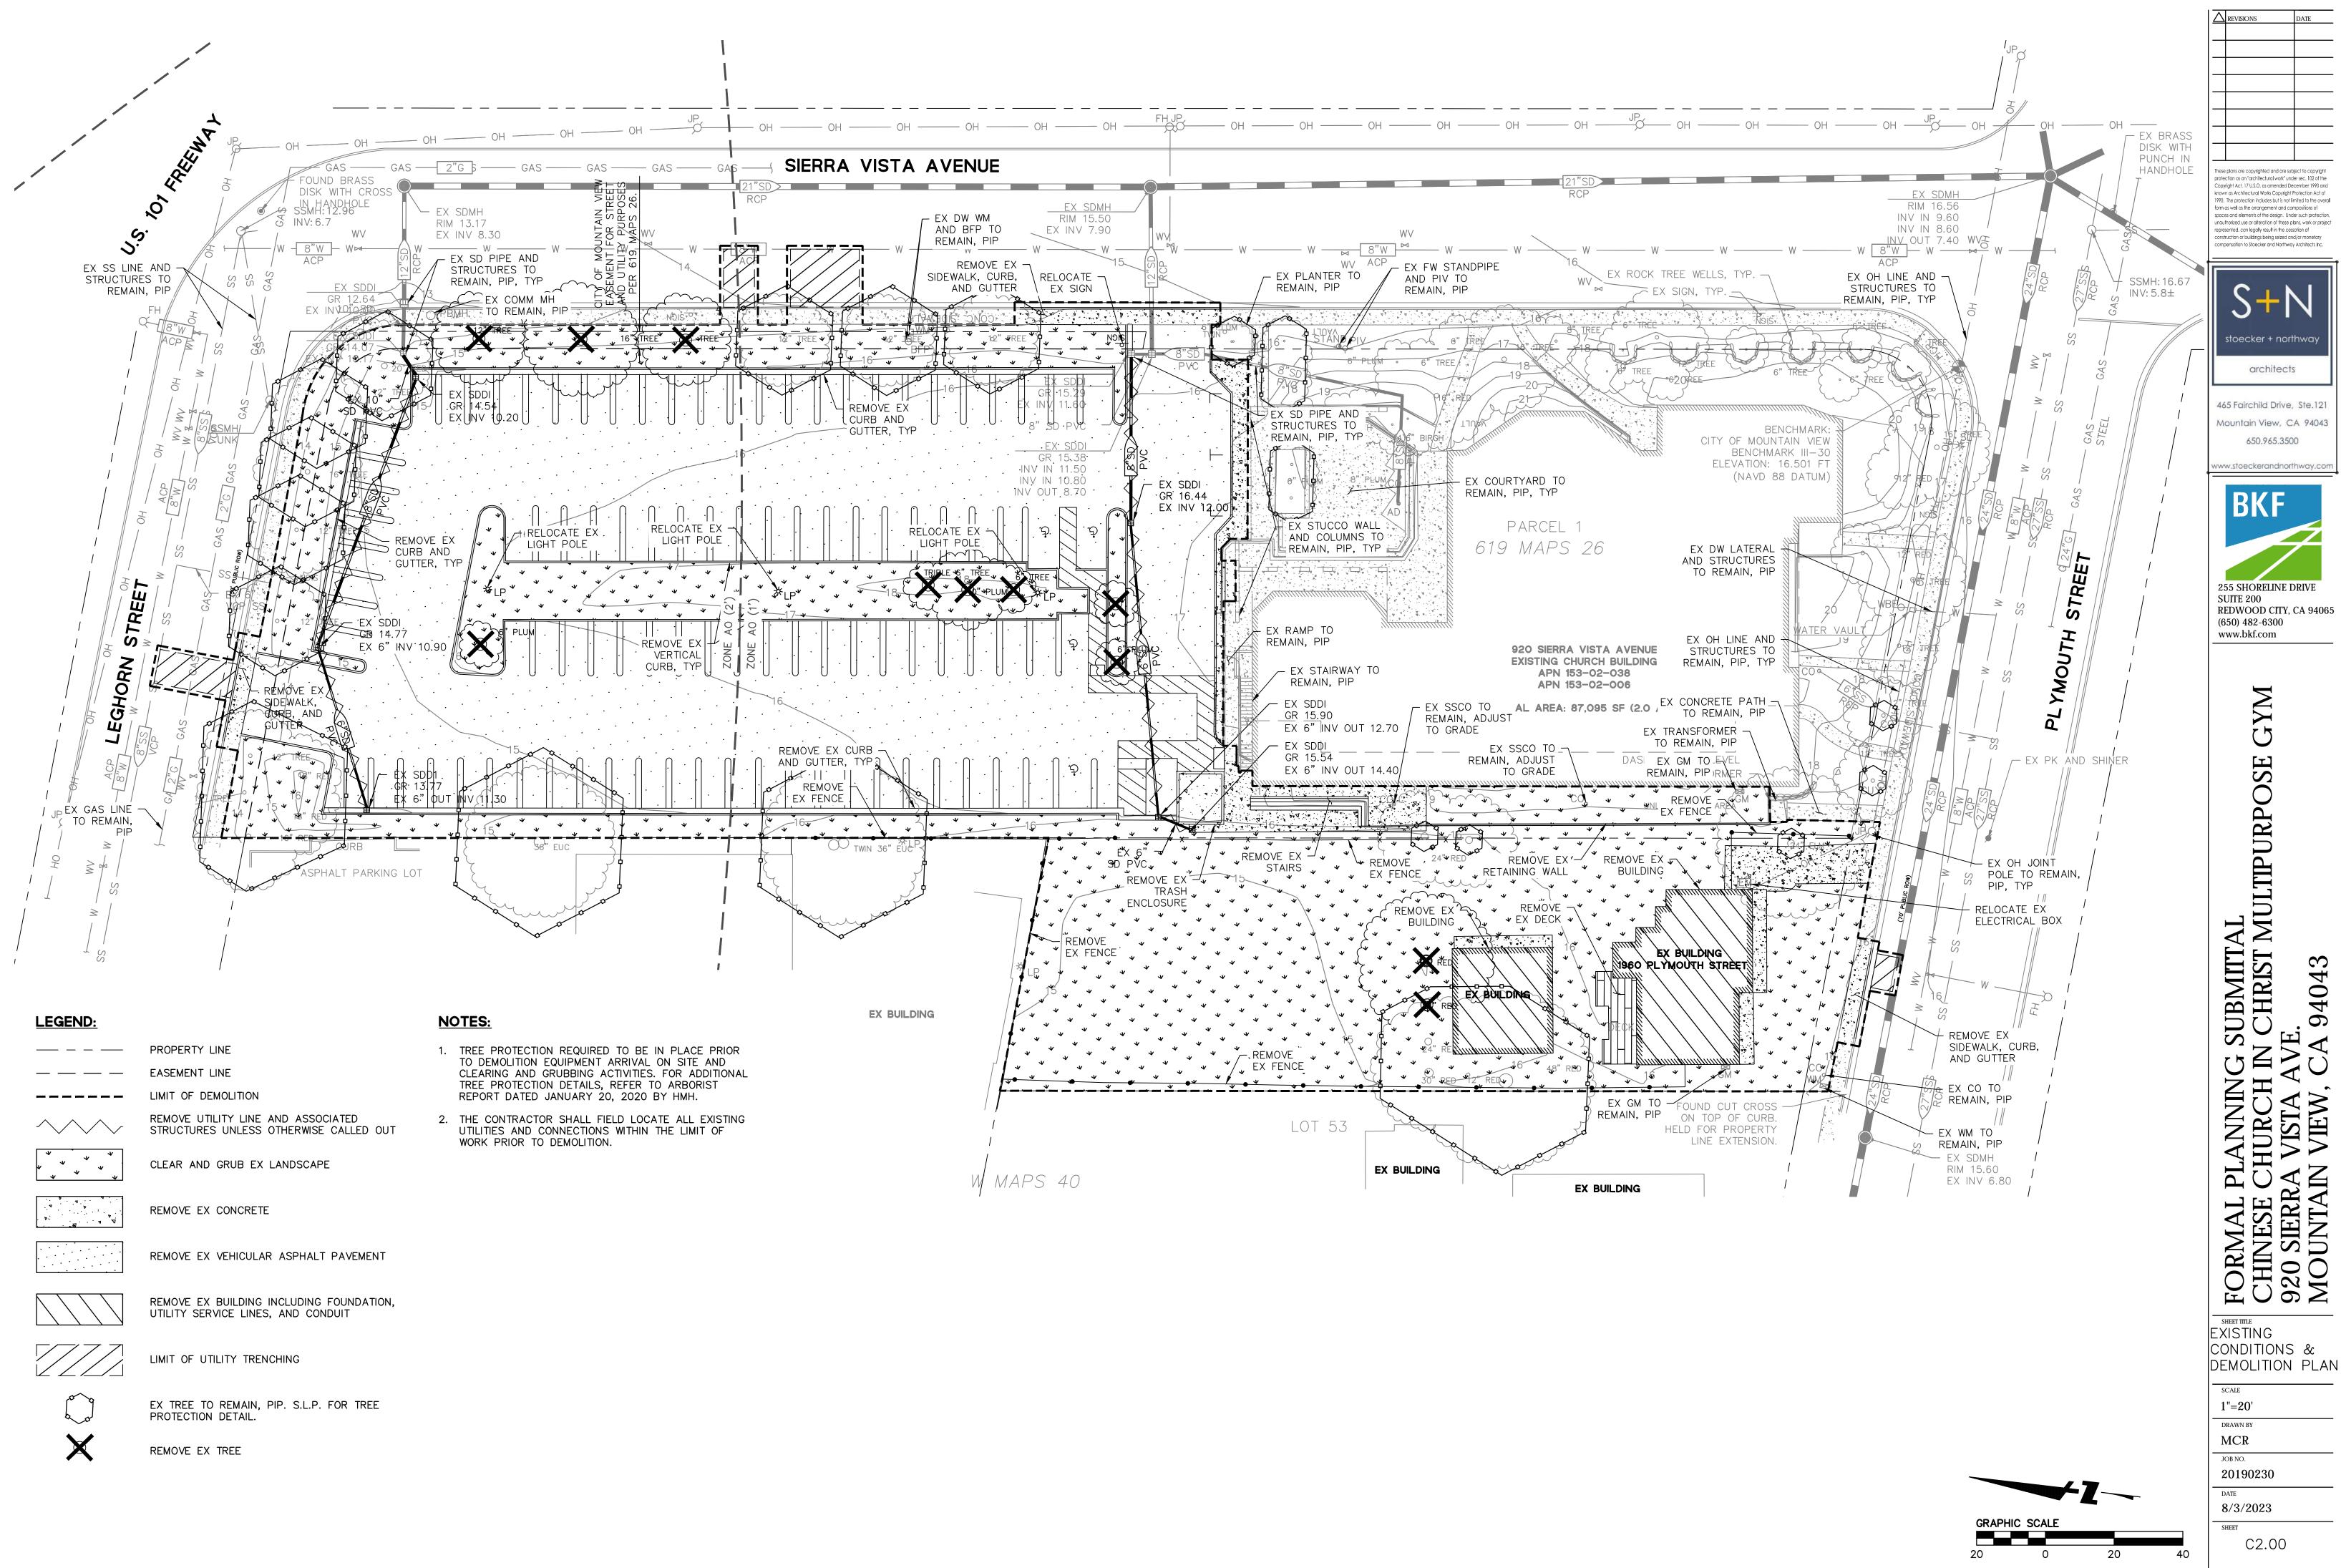
E

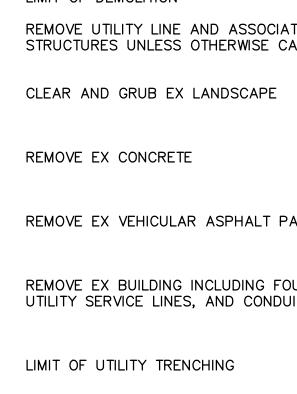
DELTA AGGREGATE BASE AR ASPHALT CONCRET ACP ASBESTOS CONCRETE PIPE LOW AREA DRAIN AD ARCHITECTURA ARCH ADJUST TO GRADE A.T.G. BACK OF WALK BW BFP BACKFLOW PREVENTER BLDG BUILDING PERF BOTTOM OF WALL BOW PG&E BOTTOM OF PAVEMENT BP PKG BOTTOM STEP BS BTM BOTTOM BT BAY TAPER CURB AND GUTTER C&G PVCI CB CATCH BASIN CCP CONCRETE CYLINDER PIPE RCP CL CENTER LINE CO CLEAN OUT CONC CONCRETE s/w CORNER COR S.A.D. CABLE TELEVISION CTV DCDA DOUBLE CHECK DETECTOR ASSEMBLY SDAD DOC DOCUMENT SDCO DWELLING UNITS DU SDDI DOMESTIC WATER DW SDMH DRIVEWAY DWY EAST. ELECTRIC S.L.P. ELECTRIC BOX EB S.M.P. EXISTING GRADE EG ELECTRIC ELEC ELEVATION ELEV SSC0 FP EDGE OF PAVEMENT SSMH ESMT EASEMENT EMERGENCY VEHICLE ACCESS EVA STA EMERGENCY VEHICLE ACCESS EASEMENT EVAE ΕX EXISTING FC FACE OF CURB FIRE DEPARTMENT CONNECTION FDC FF FINISHED FLOOR FG FINISHED GRADE FH FIRE HYDRANT FL FLOWLINE FNC FENCE TOW FT FEET FIRE WATER FW GFF GROUND FINISHED FLOOR GM GAS METER GND GROUND UNK GR GRATE GV GAS VALVE VCP HORZ HORIZONTAL VERT INV INVERT IRRIGATION IRR JOINT POLE JP JOINT TRENCH LENGTH L/C LANDSCAPE

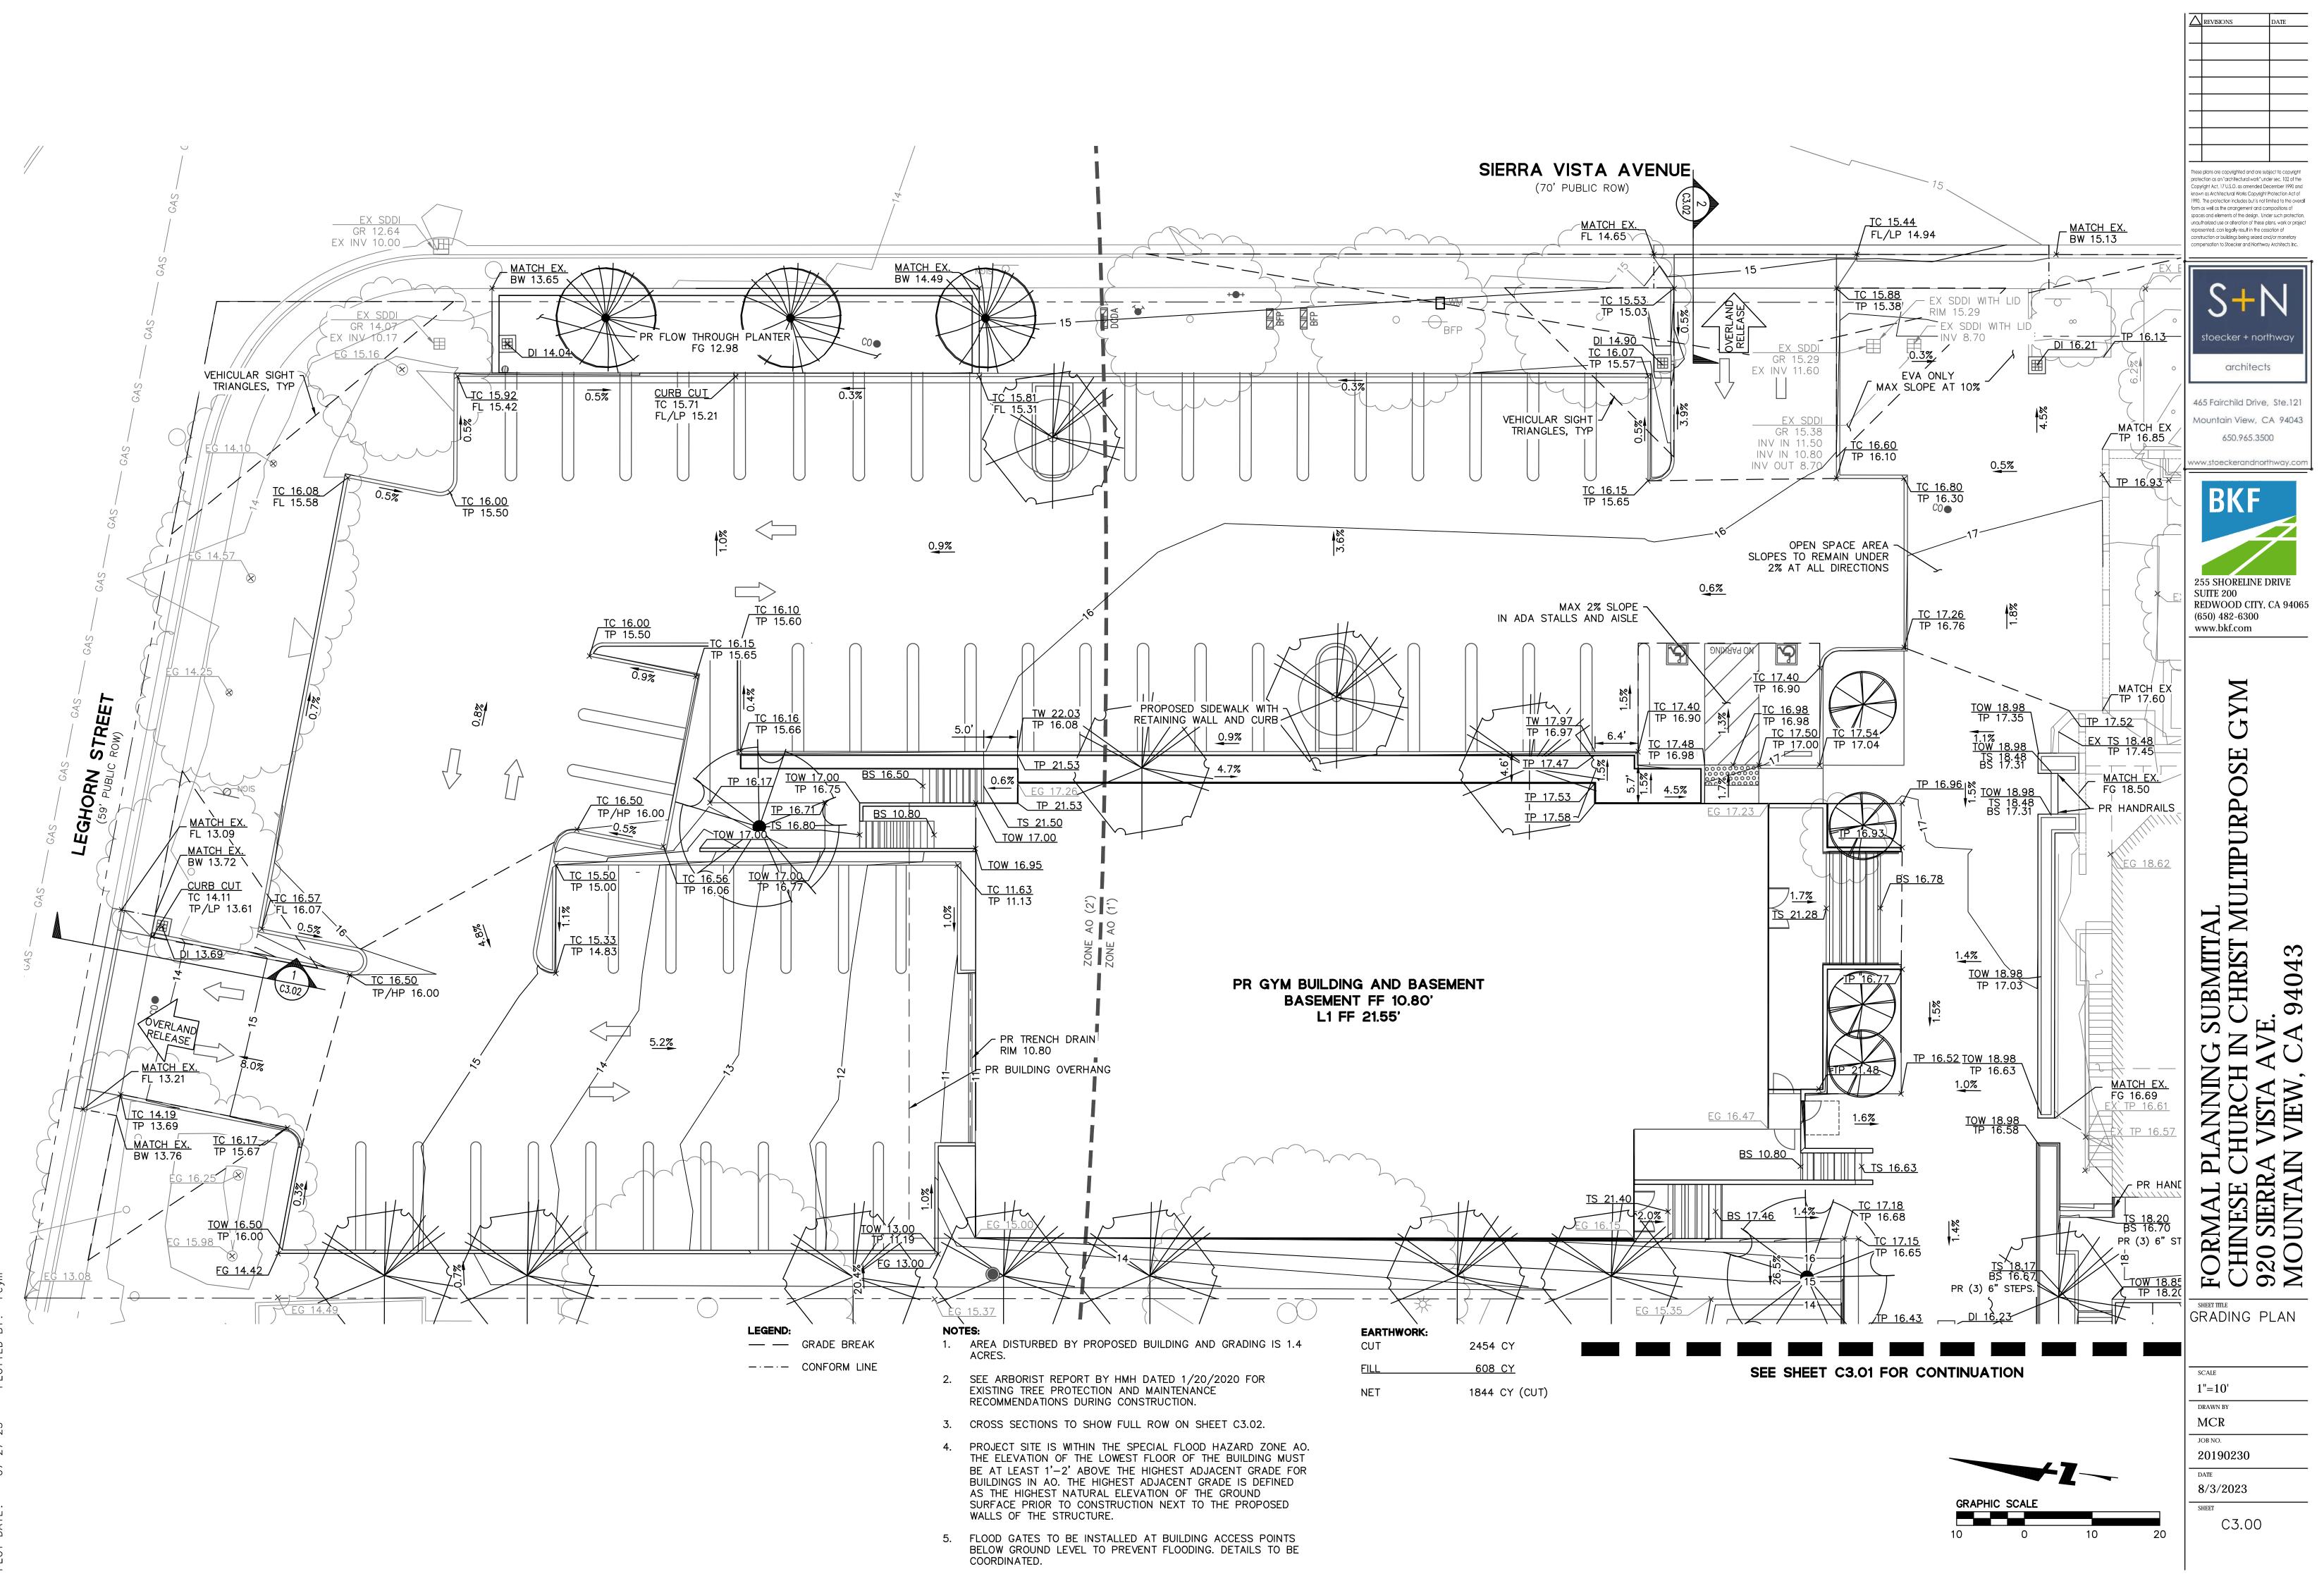
LIP OF GUTTER LOW IMPACT DEVELOPMENT LIMIT OF WORK LIGHT POLE LIGHT NORTH OVERHEAD PAD PERFORATED PACIFIC GAS & ELECTRIC PARKING POST INDICATOR VALVE PROPERTY LINE PROPOSED POLYVINYL CHLORIDE RADIUS REINFORCED CONCRETE PIPE ROAD SIGN SOUTH SIDEWALK SEE ARCHITECTURAL DRAWINGS STORM DRAIN STORM DRAIN AREA DRAIN STORM DRAIN CLEANOUT STORM DRAIN DROP INLET STORM DRAIN MANHOLE STREET LIGHT SEE LANDSCAPE PLANS SEE MECHANICAL PLANS SQUARE SANITARY SEWER SANITARY SEWER CLEANOUT SANITARY SEWER MANHOLE STREET STATION SIDEWALK TOTAL TELECOM BOX TO BE DETERMINED TOP OF CURB TREATMENT CONTROL MEASURE TRASH CAN TELEPHONE TOP OF WALL TOP OF PAVEMENT TRAFFIC SIGNAL TOP STEP TYPICAL UNKNOWN UTILITY STRUCTURE VERTICAL CURVE VITRIFIED CLAY PIPE VERTICAL WEST WATER BOX WATER METER WATER VALVE



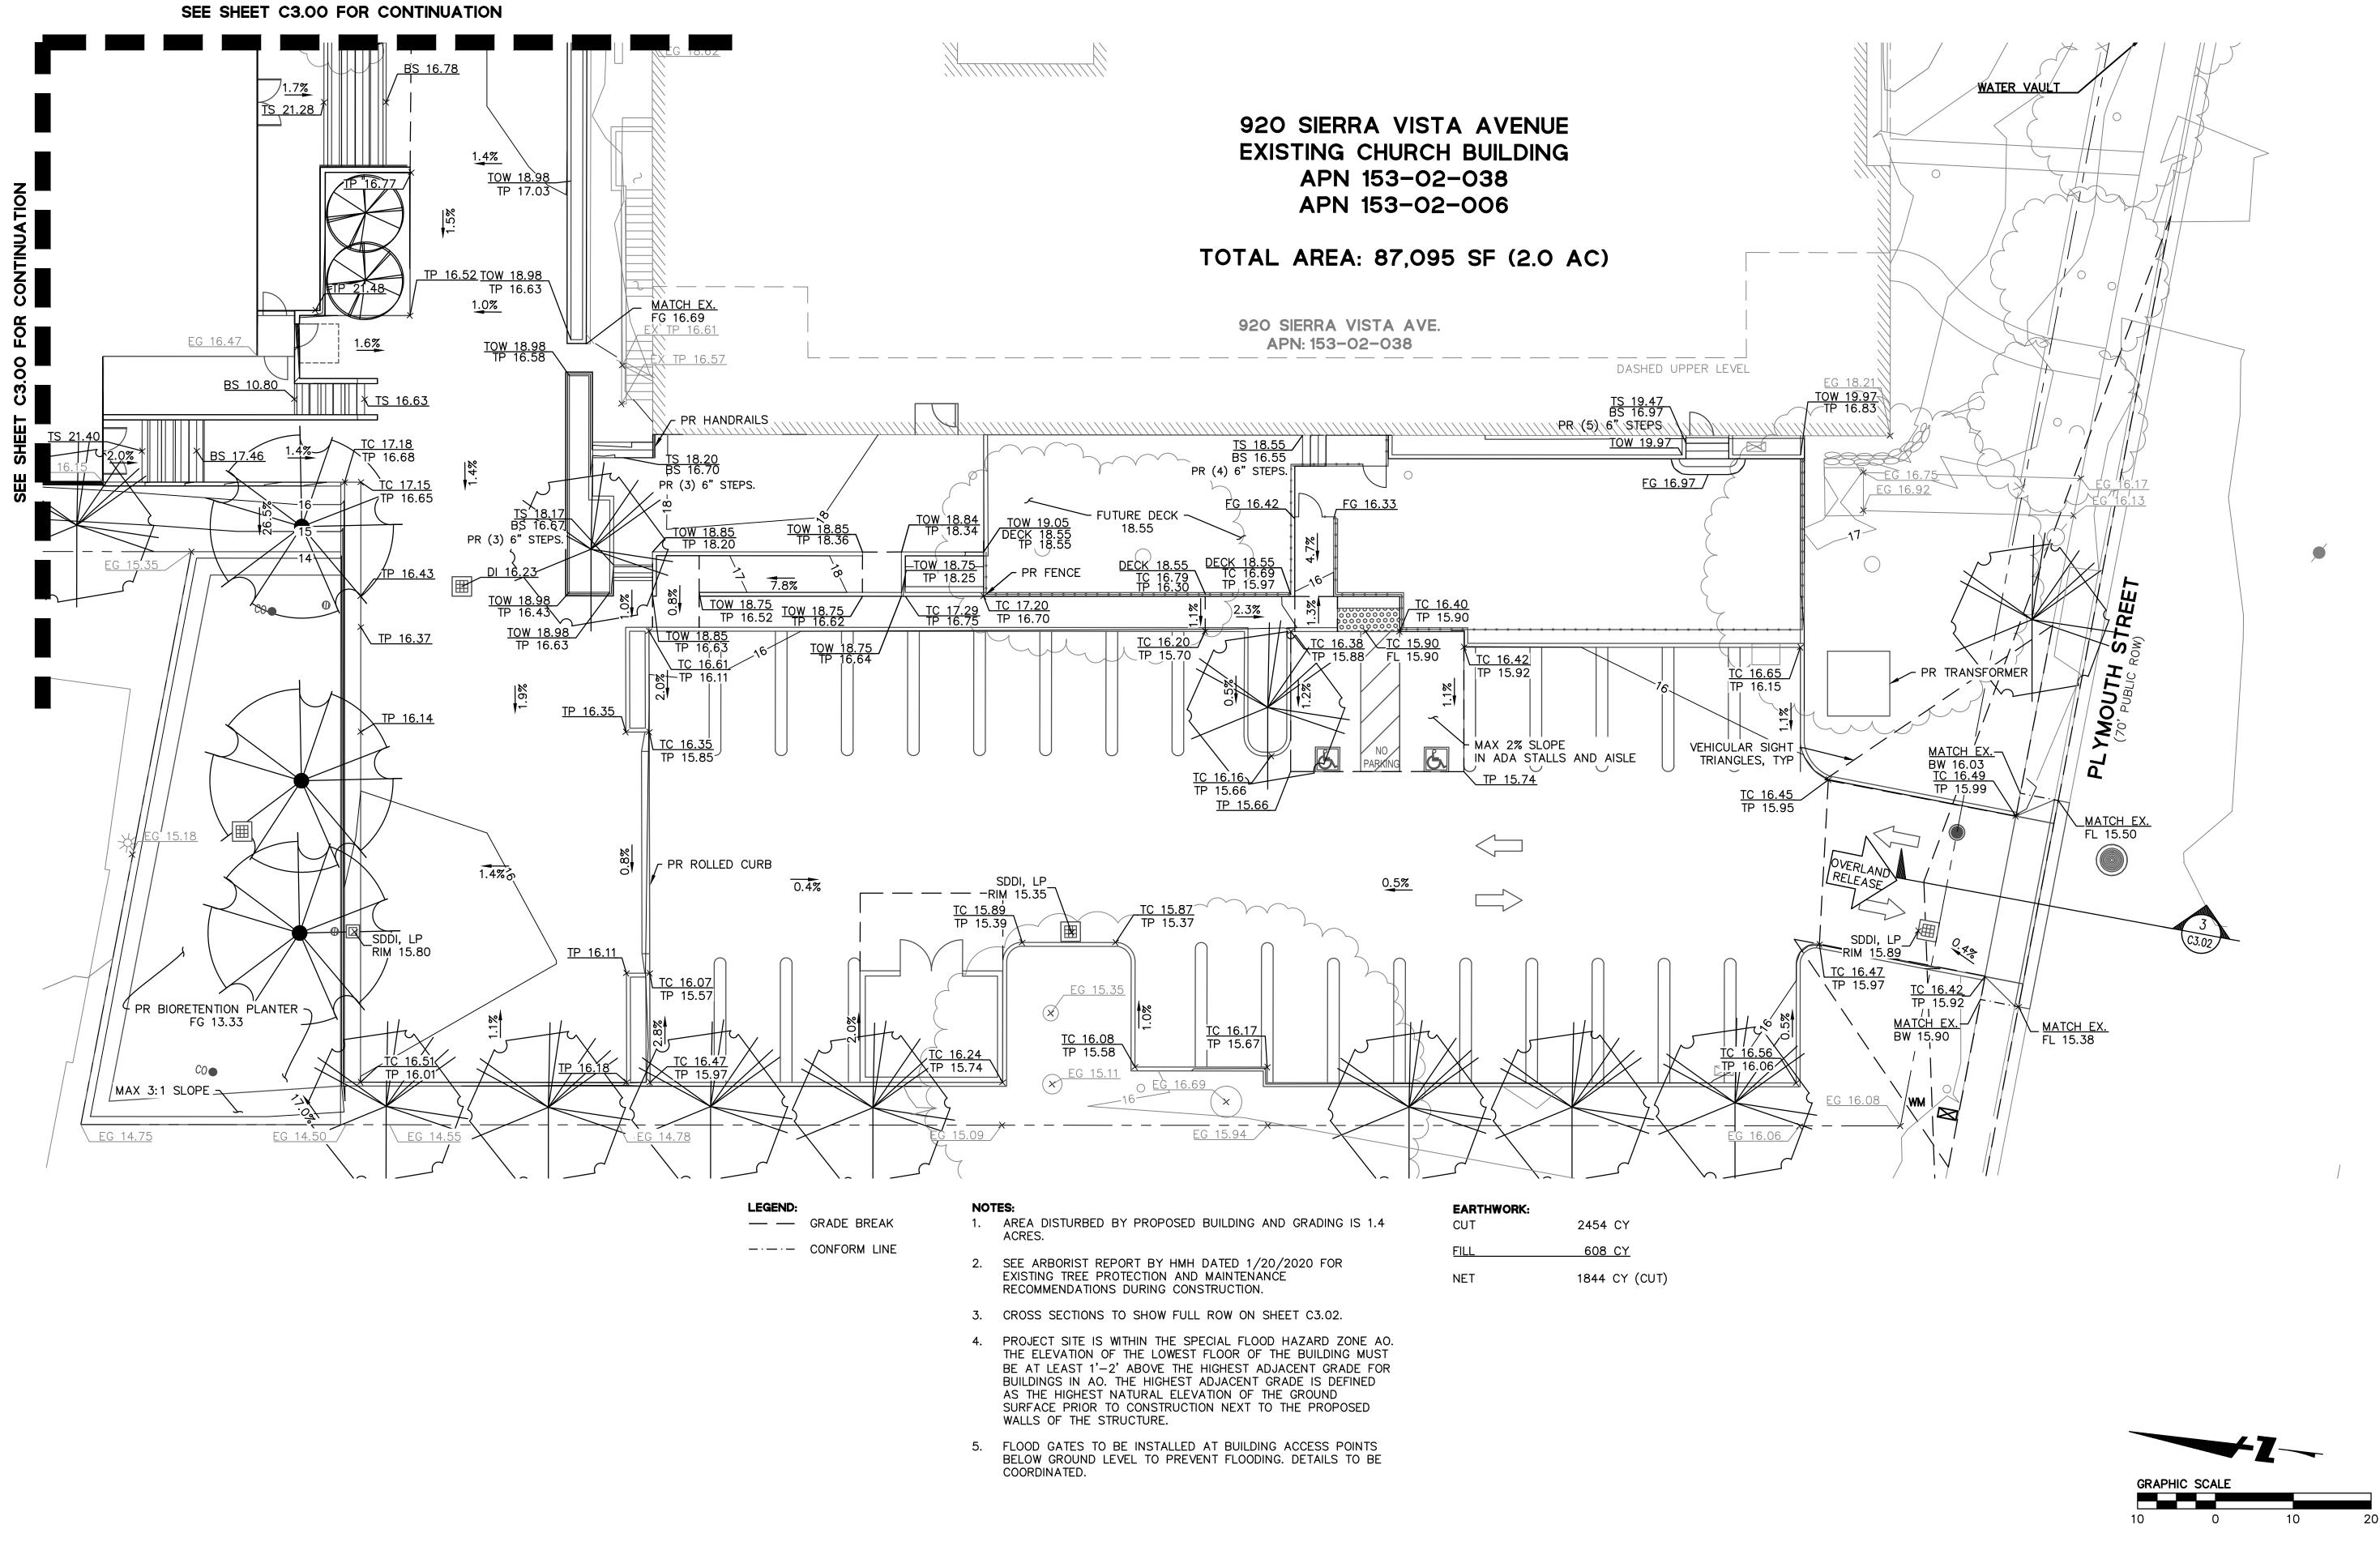
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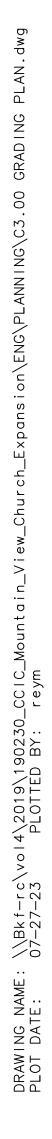


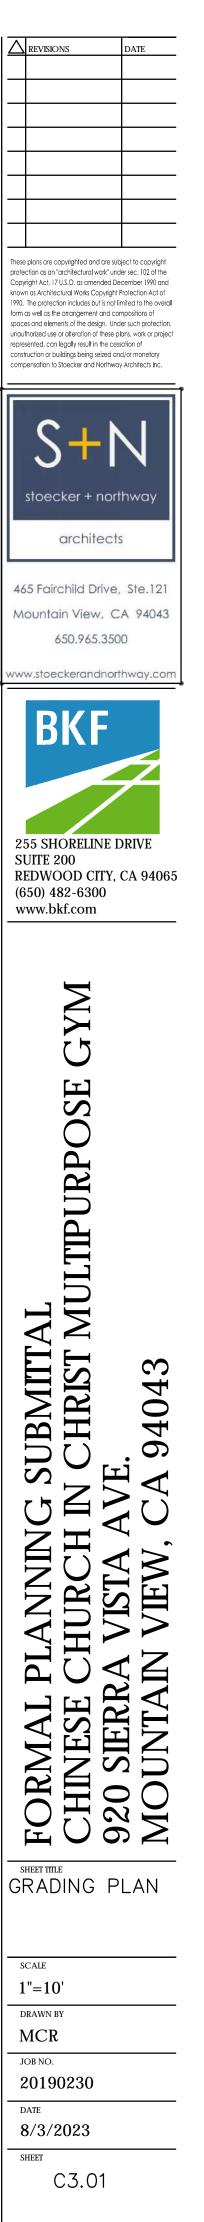




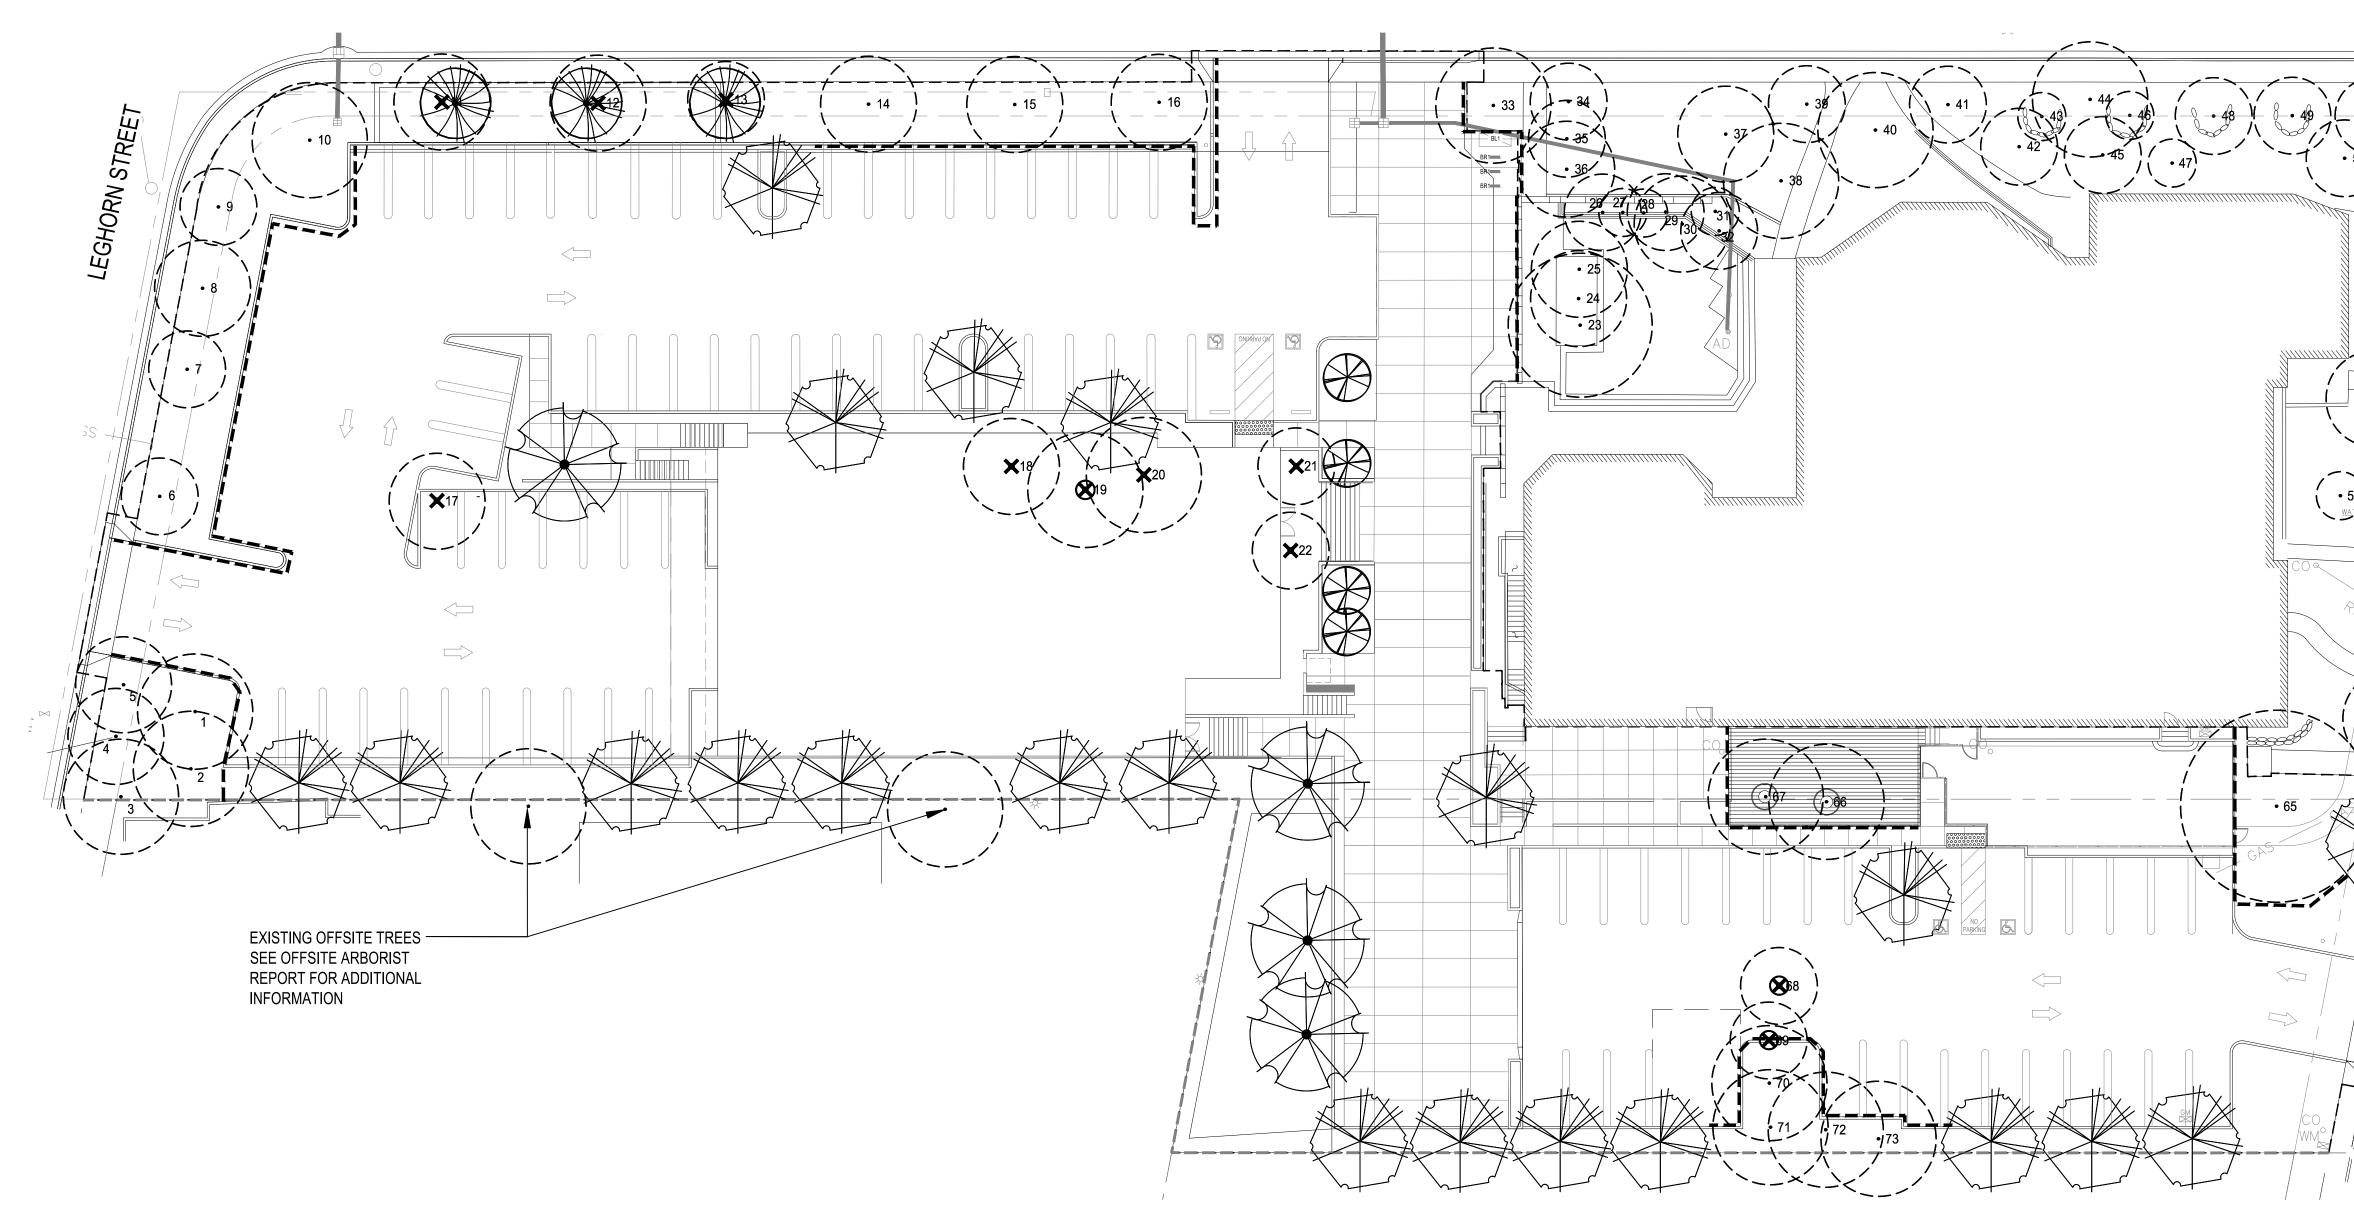
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TREE PROTECTION AND MITIGATION PLAN



SECTION I

SITE PREPARATION: ALL EXISTING TREES SHALL BE FENCED OFF WITHIN, AT OR OUTSIDE THE DRIP LINE (FOLIAR SPREAD) OF THE TREE USING THE FOLLOWING FORMULA: TWELVE INCHES IN DISTANCE FROM THE TRUNK FOR EVERY INCH IN TRUNK DIAMETER, MEASURED 2.0 FEET ABOVE THE AVERAGE GROUND LEVEL. EXAMPLE: A 24 INCH DIAMETER TREE WOULD HAVE A FENCE ERECTED 24 FEET FROM THE BASE OF THE TREE (24 X 12 = 288 / 12 = 24). THE FENCE SHOULD BE A MINIMUM OF SIX FEET HIGH, MADE OF WIRE WITH STEEL STAKES, SUCH AS CYCLONE FENCING. IF THE FENCE IS WITHIN THE DRIP LINE OF THE TREES, EVERY ATTEMPT SHOULD BE MADE TO RELOCATE THE FENCE OUTSIDE THE DRIPLINE OF THE TREE. IF NOT POSSIBLE, THE TREE SHALL BE PRUNED TO REDUCE THE CHANCE OF LIMB BREAKAGE FROM CONSTRUCTION EQUIPMENT ENCROACHING WITHIN THE DRIP LINE. ALL CONTRACTORS, SUBCONTRACTORS AND OTHER PERSONNEL SHALL BE WARNED THAT ENCROACHMENT WITHIN THE FENCED AREA IS FORBIDDEN WITHOUT THE CONSENT OF THE CERTIFIED ARBORIST ON THE JOB. THIS INCLUDES, BUT IS NOT LIMITED TO, STORAGE OF LUMBER AND OTHER MATERIALS, DISPOSAL OF PAINTS, SOLVENTS OR OTHER NOXIOUS MATERIALS, PARKED CARS, GRADING EQUIPMENT OR OTHER HEAVY EQUIPMENT. PENALTIES, BASED ON THE COST OF REMEDIAL REPAIRS AND THE EVALUATION GUIDE PUBLISHED BY THE INTERNATIONAL SOCIETY OF ARBORICULTURE, SHALL BE ASSESSED FOR DAMAGES TO THE TREES.

SECTION II

GRADING/EXCAVATING: ALL GRADING PLANS THAT SPECIFY GRADING WITHIN THE DRIP LINE OF ANY TREE, OR WITHIN THE DISTANCE FROM THE TRUNK AS OUTLINED IN SECTION I WHEN SAID DISTANCE IS OUTSIDE THE DRIP LINE, SHALL FIRST BE REVIEWED BY THE CERTIFIED ARBORIST. PROVISIONS FOR AERATION, DRAINAGE, PRUNING, TUNNELING BENEATH ROOTS, ROOT PRUNING OR OTHER NECESSARY ACTIONS TO PROTECT THE TREES SHALL BE OUTLINED BY THE ARBORIST. IF TRENCHING IS NECESSARY WITHIN THE AREA AS DESCRIBED ABOVE, SAID TRENCHING SHALL BE UNDERTAKEN BY HAND LABOR. ALL ROOTS 2 INCHES OR LARGER SHALL BE TUNNELED UNDER AND OTHER ROOTS SHALL BE CUT SMOOTHLY TO THE TRUNK SIDE OF THE TRENCH. THE TRUNK SIDE SHOULD BE DRAPED IMMEDIATELY WITH TWO LAYERS OF UNTREATED BURLAP TO A DEPTH OF 3 FEET FROM THE SURFACE. THE BURLAP SHALL BE SOAKED NIGHTLY AND LEFT IN PLACE UNTIL THE TRENCH IS BACK FILLED TO THE ORIGINAL LEVEL. THE ARBORIST SHALL EXAMINE THE TRENCH PRIOR TO BACK FILLING TO ASCERTAIN THE NUMBER AND SIZE OF ROOTS CUT, SO AS TO SUGGEST THE NECESSARY REMEDIAL REPAIRS.

SECTION IV

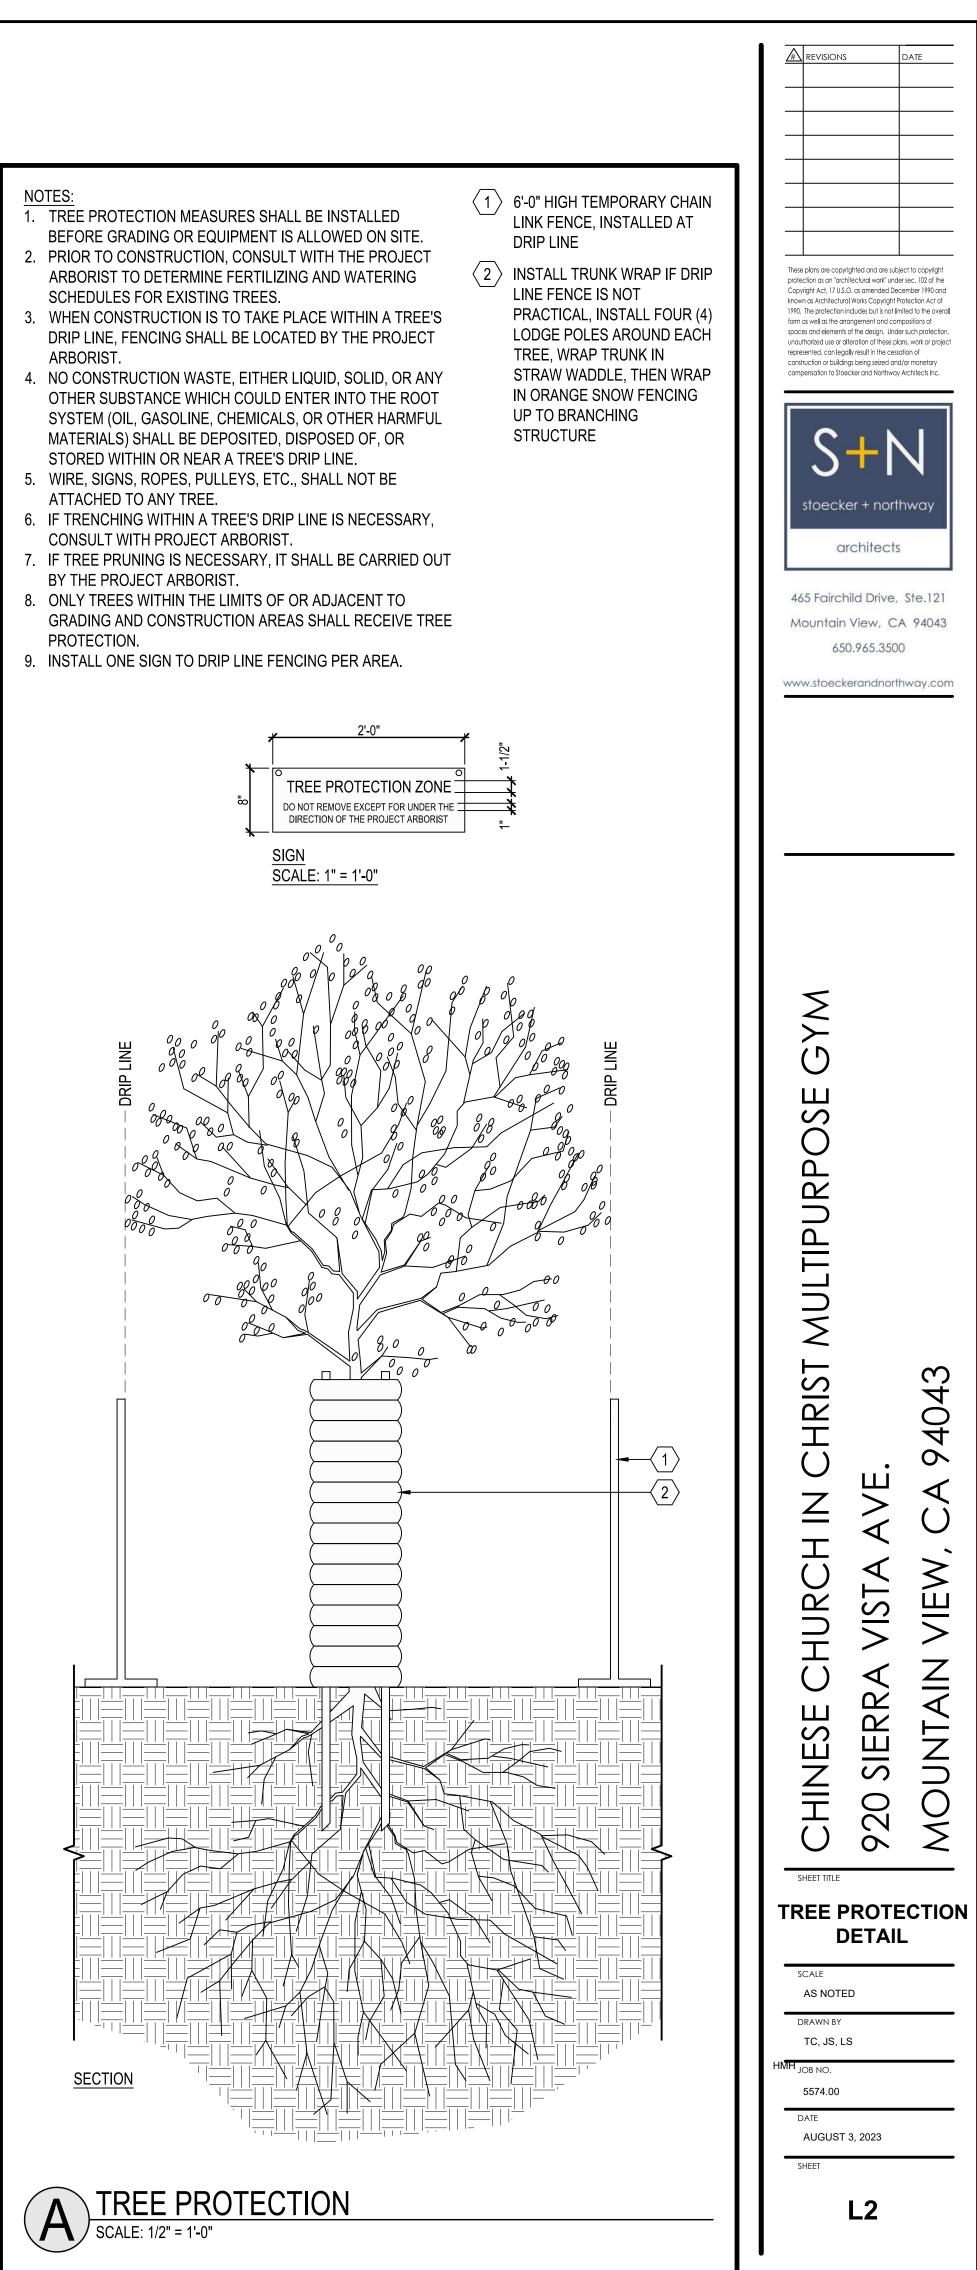
SECTION III REMEDIAL REPAIRS: THE ARBORIST ON THE JOB SHALL HAVE THE RESPONSIBILITY OF OBSERVING ALL ONGOING ACTIVITIES THAT MAY AFFECT THE TREES, AND PRESCRIBING NECESSARY REMEDIAL WORK TO INSURE THE HEALTH AND STABILITY OF SAID TREES. THIS INCLUDES, BUT IS NOT LIMITED TO, ALL ARBORIST ACTIVITIES BROUGHT OUT IN SECTIONS I AND II. IN ADDITION, PRUNING SHALL BE PRESCRIBED AS NECESSARY AND FOLLOW THE STANDARDS OUTLINED IN ANSI A300 PART1. FERTILIZING, AERATION, IRRIGATION, PEST CONTROL AND OTHER ACTIVITIES SHALL BE PRESCRIBED ACCORDING TO THE TREE NEEDS, LOCAL SITE REQUIREMENTS, AND STATE AGRICULTURAL PEST CONTROL LAWS. ALL SPECIFICATIONS SHALL BE IN WRITING. FOR PEST CONTROL OPERATIONS, CONSULT THE LOCAL COUNTY AGRICULTURAL COMMISSIONERS OFFICE FOR INDIVIDUALS LICENSED AS PEST CONTROL ADVISORS OR PEST CONTROL OPERATORS.

SIERRA VISTA AVENUE

FINAL INSPECTION: UPON COMPLETION OF THE PROJECT, THE ARBORIST SHALL REVIEW ALL WORK UNDERTAKEN THAT MAY IMPACT THE EXISTING TREES. SPECIAL ATTENTION SHALL BE GIVEN TO CUTS AND FILLS, COMPACTING, DRAINAGE, PRUNING AND FUTURE REMEDIAL WORK. THE ARBORIST SHOULD SUBMIT A FINAL REPORT IN WRITING OUTLINING THE ONGOING REMEDIAL CARE FOLLOWING THE FINAL INSPECTION.

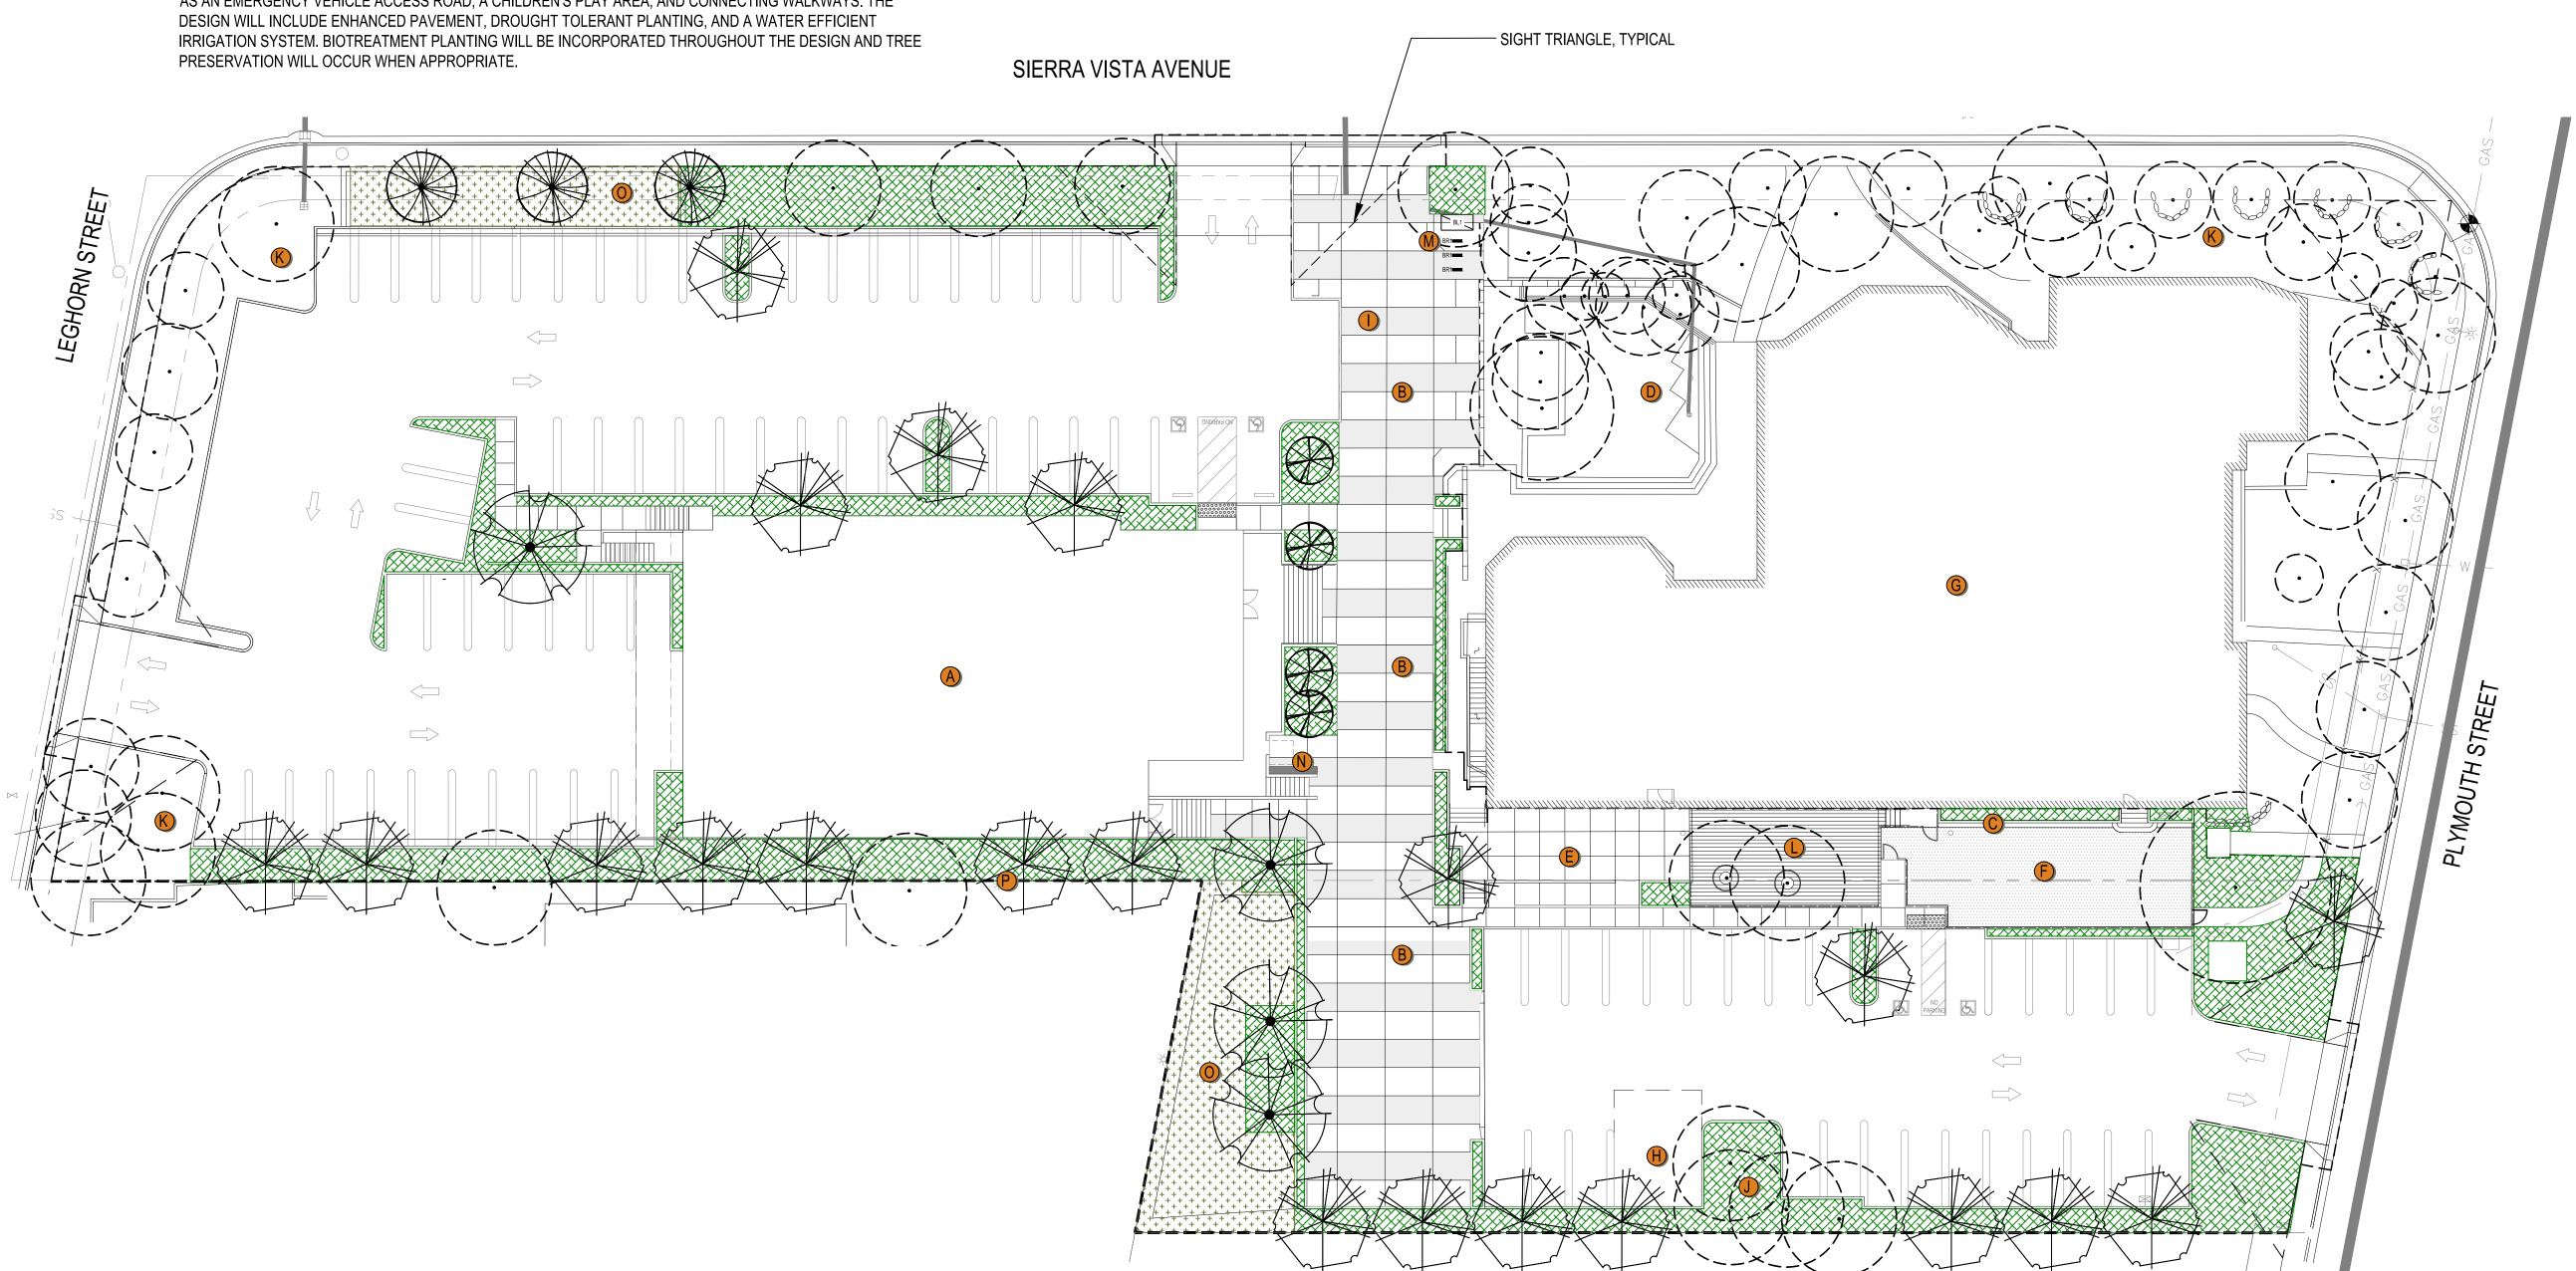
	TREE REMOVAL TABLE				DATE
	TOTAL NUMBER OF NON-HERITIAGE TREES TO BE REMOVED	DIAMETER QTY DBH < 15.3" 8	SPECIES PER ARBORIST REPORT		
	TOTAL NUMBER OF HERITAGE TREES TO BE REMOVED	DBH > 15.3" 3	PER TREE INVENTORY		
	TREE PROTECTION LEC	GEND	SYMBOL	These plans are copyrighted and are su protection as an "architectural work" un Copyright Act. 17 U.S.O. as amended D known as Architectural Works Copyright	nder sec. 102 of the December 1990 and t Protection Act of
	TREE TO BE REMOVED		★#	1990. The protection includes but is not form as well as the arrangement and cr spaces and elements of the design. Un unauthorized use or alteration of these represented, can legally result in the ce	ompositions of ider such protection, plans, work or project
GAS	HERRITAGE TREE TO BE REMOVE	ED	8 [#]	construction or buildings being seized a compensation to Stoecker and Northwo	
58)	TREE TO REMAIN / PROTECT		(· #)	S+1	\mathbf{V}
	TREE PROTECTION FENCING (SEE DETAIL, SHEET L3)			stoecker + nor architect	
·54	PROPOSED TREES. SEE LANDSCAPE PLAN AND TREE LEGEND.			465 Fairchild Drive Mountain View, C	CA 94043
de ses	TREE SUMMARY			650.965.350 www.stoeckerandnor	41746
	TREES TO BE REMOVED / MITIGA TREES TO REMAIN	TED	11 62		
• 61	TOTAL EXISTING TREES ON SITE		73		
	TREE MITIGATION SU TOTAL TREES REQUIRED TO MEE				
• 62	MITIGATATION REQUIREMENTS TOTAL PROPOSED TREES	14	24" BOX		
	(NOT INCLUDING STREET TREES)		52		
PLYMOUTH STREET	NOTES: 1. SEE ONSITE ARBORIST REPO CERTIFIED ARBORIST #WE-12	270A DATED: JANUA		Ţ	
A HON	 SEE TREE PROTECTION DETA TREE REPLACEMENTS WILL N NON-HERITAGE TREES AND 2 	IEED TO MET A 1:1 F		GYM	
J L YMG					
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				CHINESE CHURCH IN CHRIST MULTIP 920 SIERRA VISTA AVE.	MOUNTAIN VIEW, CA 94043
					<u> </u>
				TREE PROTI	
	1			SCALE AS NOTED	
				DRAWN BY TC, JS, LS	
	GRAPHIC SCALE			JOB NO. 5574.00	<u> </u>
	10 20 40	80 J		5574.00 DATE AUGUST 3, 2023	
	(In Feet) 1 inch = 20 feet			SHEET	
				L1	

TREE #	BOTANICAL NAME	COMMON NAME	DBH (INCHES)	CIRCUMFERENC E (INCHES)	HERITAGE TREE	HEALTH	PRESERVATION SUITABILITY	NOTES	TREE #	BOTANICAL NAME	COMMON NAME	DBH (INCHES)	CIRCUMFERENC E (INCHES)	HERITAGE TREE	HEALTH	PRESERVATION SUITABILITY	NOTES
1	Sequoia sempervirens	Coast Redwood	17.5	55	YES	4	Good	CR	41	Fraxinus Sp.	Ash	10.0	31		3	Moderate	SD, CR
2	Sequoia sempervirens	Coast Redwood	17.0	53	YES	4	Good	CR	42	Robinia × ambigua 'Idahoensis'	Idaho Locust	9.0	28		3	Moderate	SD, CR
3	Pistacia Chinensis	Chinese Pistache	14.0	44	YES	3	Moderate	SD,CR,Ivy infested	43	Robinia × ambigua 'Idahoensis'	Idaho Locust	4.5	14		3	Moderate	SD, CR
4	Pyrus calleryana	Callery Pear	13.5	42	YES	3	Moderate	SD, CR, Ivy infested	44	Fraxinus Sp.	Ash	16.0	50	YES	3	Moderate	SD, CR
5	Sequoia sempervirens	Coast Redwood	16.5	52	YES	4	Good	CR	45	Fraxinus Sp.	Ash	5.5	17		3	Moderate	SD, CR
6	Pistacia Chinensis	Chinese Pistache	9.0	28		3	Good		46	Robinia × ambigua 'Idahoensis'	Idaho Locust	4.0	13		3	Moderate	SD, CR
7	Pistacia Chinensis	Chinese Pistache	9.5	30		3	Good		47	Chionanthus retusus	Chinese Fringe Tree	3.0	9		3	Moderate	SD, CR
8	Pyrus calleryana	Callery Pear	13.5	42	YES	3	Good		48	Robinia × ambigua 'Idahoensis'	Idaho Locust	5.5	17		3	Moderate	SD, CR
9	Pyrus calleryana	Callery Pear	9.5	30		3	Good		49	Robinia × ambigua 'Idahoensis'	Idaho Locust	6.5	20		3	Moderate	SD, CR
10	Sequoia sempervirens	Coast Redwood	20.0	63	YES	4	Good		50	Chionanthus retusus	Chinese Fringe Tree	6.0	19		2	Moderate	SD, CR
11	Fraxinus Sp.	Ash	12.5	39	YES	2	Poor	SD,CD,CDB,CR, IB	51	Chionanthus retusus	Chinese Fringe Tree	4.0	13		3	Moderate	SD, CR
12	Fraxinus Sp.	Ash	11.0	35		2	Poor	SD,CD,CDB,CR, IB	52	Robinia × ambigua 'Idahoensis'	Idaho Locust	5.5	17		3	Moderate	SD, CR
13	Fraxinus Sp.	Ash	9.5	30		2	Poor	SD,CD,CDB,CR, IB	53	Chionanthus retusus	Chinese Fringe Tree	3.0	9		3	Moderate	SD, CR
14	Fraxinus Sp.	Ash	10.5	33		2	Poor	SD,CD,CDB,CR, IB	54	Chionanthus retusus	Chinese Fringe Tree	4.0	13		2	Moderate	SD, CR
15	Fraxinus Sp.	Ash	10.5	33		2	Poor	SD,CD,CDB,CR, IB	55	Sequoia sempervirens	Coast Redwood	12.0	38	YES	4	Good	
16	Fraxinus Sp.	Ash	12.0	38	YES	2	Poor	SD,CD,CDB,CR, IB	56	Sequoia sempervirens	Coast Redwood	12.0	38	YES	4	Good	Near Building, On Slope
17	Prunus cerasifera	Flowering Plum	10.5	33		2	Moderate	SD,CD,CDB,CR, IB	57	Cedrus Sp	Cedar	3.0	9		4	Good	
18	Fraxinus Sp.	Ash	13.0	41	YES	3	Moderate	SD,CD,CDB,CR, IB	58	Robinia × ambigua 'Idahoensis'	Idaho Locust	4.0	13		3	Moderate	SD, CR
19	Prunus cerasifera	Flowering Plum	16.0	50	YES	1	Poor	DEAD	59	Robinia × ambigua 'Idahoensis'	Idaho Locust	2.0	6		3	Moderate	SD, CR
20	Morus alba	Mulberry	9.0	28		3	Moderate	SD,CD,IB	60			16.0	50	VEO	3	Moderate	HD, SD, Cut off Powelines
						Ű	Moderate	50,00,10	60	Pyrus calleryana	Callery Pear	10.0	50	YES		modorato	
TREE #	BOTANICAL NAME	COMMON NAME	DBH (INCHES)	CIRCUMFERENC	HERITAGE TREE	HEALTH	PRESERVATION	NOTES	TREE #	BOTANICAL NAME	Common NAME	DBH (INCHES)	CIRCUMFERENC E (INCHES)	HERITAGE TREE	HEALTH	PRESERVATION	NOTES
TREE #	BOTANICAL NAME	COMMON NAME Mulberry	DBH	CIRCUMFERENC	HERITAGE TREE		PRESERVATION				-	DBH	CIRCUMFERENC			PRESERVATION	
21			DBH (INCHES)	CIRCUMFERENC E (INCHES)	HERITAGE TREE	HEALTH	PRESERVATION SUITABILITY	NOTES	TREE #	BOTANICAL NAME	COMMON NAME	DBH (INCHES)	CIRCUMFERENC E (INCHES)	HERITAGE TREE	HEALTH	PRESERVATION SUITABILITY	NOTES
21 22	Morus alba	Mulberry	DBH (INCHES) 7.0	CIRCUMFERENC E (INCHES) 22	HERITAGE TREE	HEALTH	PRESERVATION SUITABILITY Moderate	NOTES SD,CD,IB	TREE #	BOTANICAL NAME Pyrus calleryana	COMMON NAME	DBH (INCHES) 13.0	CIRCUMFERENC E (INCHES) 41	HERITAGE TREE YES	HEALTH 3	PRESERVATION SUITABILITY Moderate	NOTES HD, SD, Cut off Powelines
21 22 23	Morus alba Prunus cerasifera	Mulberry Flowering Plum	DBH (INCHES) 7.0 10.0	CIRCUMFERENC E (INCHES) 22 31		HEALTH 3 2	PRESERVATION SUITABILITY Moderate Moderate	NOTES SD,CD,IB SD,CD,CDB,CR, IB	TREE # 61 62	BOTANICAL NAME Pyrus calleryana Pyrus calleryana	COMMON NAME Callery Pear Callery Pear	DBH (INCHES) I 13.0 14.0	CIRCUMFERENC E (INCHES) 41 44	HERITAGE TREE YES YES	HEALTH 3 3	PRESERVATION SUITABILITY Moderate Moderate	NOTES HD, SD, Cut off Powelines HD, SD, Cut off Powelines
21 22 23 24	Morus alba Prunus cerasifera Prunus cerasifera	Mulberry Flowering Plum Flowering Plum	DBH (INCHES) 7.0 10.0 21.0	CIRCUMFERENC E (INCHES) 22 31 66		HEALTH 3 2 2	PRESERVATION SUITABILITY Moderate Moderate Moderate	NOTES SD,CD,IB SD,CD,CDB,CR, IB SD,CD,CDB,CR, IB	TREE # 61 62 63	BOTANICAL NAME Pyrus calleryana Pyrus calleryana Pyrus calleryana	COMMON NAME Callery Pear Callery Pear Callery Pear	DBH (INCHES) I 13.0 I 14.0 I 15.0 I	CIRCUMFERENC E (INCHES) 41 44 44 47	HERITAGE TREE YES YES	HEALTH 3 3 3	PRESERVATION SUITABILITY Moderate Moderate Moderate	NOTES HD, SD, Cut off Powelines HD, SD, Cut off Powelines HD, SD, Cut off Powelines
21 22 23 24	Morus alba Prunus cerasifera Prunus cerasifera Prunus cerasifera	Mulberry Flowering Plum Flowering Plum Flowering Plum	DBH (INCHES) 7.0 10.0 21.0 11.0	CIRCUMFERENC E (INCHES) 22 31 66 35	YES	HEALTH 3 2 2 2 2 2	PRESERVATION SUITABILITY Moderate Moderate Moderate Moderate Moderate	NOTES SD,CD,IB SD,CD,CDB,CR, IB SD,CD,CDB,CR, IB SD,CD,CDB,CR, IB	TREE # 61 62 63 64	BOTANICAL NAME Pyrus calleryana Pyrus calleryana Pyrus calleryana Pyrus calleryana	COMMON NAME Callery Pear Callery Pear Callery Pear Callery Pear	DBH (INCHES) I 13.0 I 14.0 I 15.0 I 11.0 I	CIRCUMFERENC E (INCHES) 41 44 44 47 35	HERITAGE TREE YES YES YES	HEALTH 3 3 3 3 3	PRESERVATION SUITABILITY Moderate Moderate Moderate Moderate	NOTES HD, SD, Cut off Powelines HD, SD, Cut off Powelines HD, SD, Cut off Powelines HD, SD, Cut off Powelines
21 22 23 24 25	Morus alba Prunus cerasifera Prunus cerasifera Prunus cerasifera Prunus cerasifera	Mulberry Flowering Plum Flowering Plum Flowering Plum Flowering Plum	DBH (INCHES) 7.0 10.0 21.0 11.0 13.0	CIRCUMFERENC E (INCHES) 22 31 66 35 41	YES	HEALTH	PRESERVATION SUITABILITY Moderate Moderate Moderate Moderate Moderate Moderate Moderate Moderate	NOTES SD,CD,IB SD,CD,CDB,CR, IB SD,CD,CDB,CR, IB SD,CD,CDB,CR, IB SD,CD,CDB,CR, IB	TREE # 61 62 63 64 65	BOTANICAL NAME Pyrus calleryana Pyrus calleryana Pyrus calleryana Pyrus calleryana Ulmus parvifolia Sequoia	COMMON NAME Callery Pear Callery Pear Callery Pear Callery Pear Elm Tree	DBH (INCHES) I 13.0 I 14.0 I 15.0 I 11.0 I 23.0 I	CIRCUMFERENC E (INCHES) 41 44 44 47 35 72	HERITAGE TREE YES YES YES YES	HEALTH 3 3 3 3 3 4	PRESERVATION SUITABILITY Moderate Moderate Moderate Good	NOTES HD, SD, Cut off Powelines HD, SD, Cut off Powelines HD, SD, Cut off Powelines HD, SD, Cut off Powelines EG, CR
21 22 23 24 25 26	Morus alba Prunus cerasifera Prunus cerasifera Prunus cerasifera Prunus cerasifera Betula pendula	Mulberry Flowering Plum Flowering Plum Flowering Plum Flowering Plum White Birch	DBH (INCHES) 7.0 10.0 21.0 11.0 13.0 7.0	CIRCUMFERENC E (INCHES) 22 31 66 35 41	YES	HEALTH	PRESERVATION SUITABILITY Moderate	NOTES SD,CD,IB SD,CD,CDB,CR, IB SD,CD,CDB,CR, IB SD,CD,CDB,CR, IB SD,CD,CDB,CR, IB SD,CD,CDB,CR, IB	TREE # 61 62 63 64 65 66	BOTANICAL NAME Pyrus calleryana Pyrus calleryana Pyrus calleryana Pyrus calleryana Ulmus parvifolia Sequoia sempervirens Sequoia	Common name Callery Pear Callery Pear Callery Pear Callery Pear Elm Tree Coast Redwood	DBH (INCHES) I 13.0 I 14.0 I 15.0 I 23.0 I 26.0 I	CIRCUMFERENC E (INCHES) 41 44 47 35 72 82	HERITAGE TREE YES YES YES YES YES	HEALTH	PRESERVATION SUITABILITY Moderate Moderate Moderate Good Good	NOTES HD, SD, Cut off Powelines HD, SD, Cut off Powelines HD, SD, Cut off Powelines HD, SD, Cut off Powelines EG, CR EG, CR
21 22 23 24 25 26 27	Morus alba Prunus cerasifera Prunus cerasifera Prunus cerasifera Prunus cerasifera Betula pendula Betula pendula	Mulberry Flowering Plum Flowering Plum Flowering Plum Flowering Plum White Birch White Birch	DBH (INCHES) 7.0 10.0 21.0 11.0 13.0 7.0 3.0	CIRCUMFERENC E (INCHES) 22 31 66 35 41 22 9 9	YES	HEALTH	PRESERVATION SUITABILITY Moderate	NOTES SD,CD,IB SD,CD,CDB,CR, IB SD,CD,CDB,CR, IB SD,CD,CDB,CR, IB SD,CD,CDB,CR, IB SD,CD,CDB,CR, IB SD,LN, CDB,CR SD,LN, CDB,CR	TREE # 61 62 63 64 65 66 66 67	BOTANICAL NAME Pyrus calleryana Pyrus calleryana Pyrus calleryana Pyrus calleryana Ulmus parvifolia Ulmus parvifolia Sequoia sempervirens Sequoia sempervirens Sequoia	COMMON NAME Callery Pear Callery Pear Callery Pear Callery Pear Elm Tree Coast Redwood Coast Redwood	DBH (INCHES) I 13.0 I 14.0 I 15.0 I 11.0 I 23.0 I 26.0 I 18.0 I	CIRCUMFERENC E (INCHES) 41 44 47 35 72 82 82 57	HERITAGE TREE YES YES YES YES YES YES	HEALTH	PRESERVATION SUITABILITY Moderate Moderate Moderate Good Good Good	NOTES HD, SD, Cut off Powelines HD, SD, Cut off Powelines HD, SD, Cut off Powelines HD, SD, Cut off Powelines EG, CR EG, CR EG, CR
21 22 23 24 25 26 27 28	Morus alba Prunus cerasifera Prunus cerasifera Prunus cerasifera Prunus cerasifera Betula pendula Betula pendula Betula pendula	Mulberry Flowering Plum Flowering Plum Flowering Plum Flowering Plum White Birch White Birch White Birch	DBH (INCHES) 7.0 10.0 21.0 11.0 13.0 7.0 3.0 5.0	CIRCUMFERENC E (INCHES) 22 31 66 35 41 22 9 9 16	YES	HEALTH	PRESERVATION SUITABILITY Moderate	NOTES SD,CD,IB SD,CD,CDB,CR, IB SD,CD,CDB,CR, IB SD,CD,CDB,CR, IB SD,CD,CDB,CR, IB SD,CD,CDB,CR, IB SD,CD,CDB,CR, IB SD,LN, CDB,CR SD,LN, CDB,CR	TREE # 61 62 63 64 65 66 67 68	BOTANICAL NAME Pyrus calleryana Pyrus calleryana Pyrus calleryana Pyrus calleryana Ulmus parvifolia Sequoia sempervirens Sequoia sempervirens Sequoia sempervirens Sequoia sempervirens	COMMON NAME Callery Pear Callery Pear Callery Pear Callery Pear Callery Pear Callery Pear Callery Pear Coast Redwood Coast Redwood	DBH (INCHES) I 13.0 I 14.0 I 15.0 I 23.0 I 26.0 I 18.0 I 28.0 I	CIRCUMFERENC E (INCHES) 41 44 47 35 72 82 57 88	HERITAGE TREE YES YES YES YES YES YES YES	HEALTH	PRESERVATION SUITABILITY Moderate Moderate Moderate Good Good Good Good	NOTES HD, SD, Cut off Powelines HD, SD, Cut off Powelines HD, SD, Cut off Powelines HD, SD, Cut off Powelines EG, CR EG, CR EG, CR EG, CR
21 22 23 24 25 26 27 28 29	Morus alba Prunus cerasifera Prunus cerasifera Prunus cerasifera Prunus cerasifera Betula pendula Betula pendula Betula pendula	Mulberry Flowering Plum Flowering Plum Flowering Plum Flowering Plum White Birch White Birch White Birch White Birch	DBH (INCHES) 7.0 10.0 21.0 11.0 13.0 7.0 3.0 5.0 9.5	CIRCUMFERENC E (INCHES) 22 31 66 35 41 22 9 9 16 30	YES	HEALTH	PRESERVATION SUITABILITY Moderate	NOTES SD,CD,IB SD,CD,CDB,CR, IB SD,CD,CDB,CR, IB SD,CD,CDB,CR, IB SD,CD,CDB,CR, IB SD,CD,CDB,CR, IB SD,CD,CDB,CR, IB SD,LN, CDB,CR SD,LN, CDB,CR SD,LN, CDB,CR	TREE # 61 62 63 64 65 66 67 68 69	BOTANICAL NAME Pyrus calleryana Pyrus calleryana Pyrus calleryana Pyrus calleryana Ulmus parvifolia Ulmus parvifolia Sequoia sempervirens Sequoia sempervirens Sequoia sempervirens Sequoia sempervirens Sequoia sempervirens	COMMON NAME Callery Pear Callery Pear Callery Pear Callery Pear Callery Pear Callery Pear Callery Pear Coast Redwood Coast Redwood Coast Redwood	DBH (INCHES) I 13.0 I 14.0 I 15.0 I 23.0 I 26.0 I 18.0 I 28.0 I 30.0 I	CIRCUMFERENC E (INCHES) 41 44 47 35 72 82 57 88 57 88 94	HERITAGE TREE YES YES YES YES YES YES YES	HEALTH	PRESERVATION SUITABILITY Moderate Moderate Moderate Good Good Good Good Good	NOTES HD, SD, Cut off Powelines HD, SD, Cut off Powelines HD, SD, Cut off Powelines HD, SD, Cut off Powelines EG, CR EG, CR EG, CR EG, CR EG, CR
21 22 23 24 25 26 27 28 29 30 31	Morus alba Prunus cerasifera Prunus cerasifera Prunus cerasifera Prunus cerasifera Betula pendula Betula pendula Betula pendula Betula pendula	Mulberry Flowering Plum Flowering Plum Flowering Plum Flowering Plum White Birch White Birch White Birch White Birch White Birch White Birch	DBH (INCHES) 7.0 10.0 21.0 11.0 13.0 7.0 3.0 5.0 9.5 12.0	CIRCUMFERENC E (INCHES) 22 31 66 35 41 22 9 9 16 30 30 38	YES	HEALTH	PRESERVATION SUITABILITY Moderate	NOTES SD,CD,IB SD,CD,CDB,CR, IB SD,CD,CDB,CR, IB SD,CD,CDB,CR, IB SD,CD,CDB,CR, IB SD,CD,CDB,CR, IB SD,LN, CDB,CR SD,LN, CDB,CR SD,LN, CDB,CR SD,LN, CDB,CR	TREE # 61 62 63 64 65 66 67 68 68 69 70	BOTANICAL NAME Pyrus calleryana Pyrus calleryana Pyrus calleryana Pyrus calleryana Ulmus parvifolia Ulmus parvifolia Sequoia sempervirens	COMMON NAME Callery Pear Callery Pear Caller	DBH I 13.0 I 14.0 I 15.0 I 15.0 I 23.0 I 26.0 I 18.0 I 28.0 I 30.0 I 22.5 I	CIRCUMFERENC E (INCHES) 41 44 47 35 72 82 57 88 88 94 94 71	HERITAGE TREE YES YES YES YES YES YES YES YES	HEALTH	PRESERVATION SUITABILITY Moderate Moderate Moderate Good Good Good Good Good Good	NOTES HD, SD, Cut off Powelines HD, SD, Cut off Powelines HD, SD, Cut off Powelines HD, SD, Cut off Powelines EG, CR EG, CR EG, CR EG, CR EG, CR EG, CR
21 22 23 24 25 26 27 28 29 30 31 32	Morus alba Prunus cerasifera Prunus cerasifera Prunus cerasifera Prunus cerasifera Betula pendula Betula pendula Betula pendula Betula pendula	Mulberry Flowering Plum Flowering Plum Flowering Plum Flowering Plum White Birch	DBH (INCHES) 7.0 10.0 21.0 11.0 13.0 7.0 3.0 5.0 9.5 12.0 5.0	CIRCUMFERENC E (INCHES) 22 31 66 35 41 22 9 16 16 30 38 16	YES	HEALTH 3 2 2 2 2 2 2 2 2 2 3 3 3 3 3 3 3 3 3 3 3 3 3 3	PRESERVATION SUITABILITY Moderate	NOTES SD,CD,IB SD,CD,CDB,CR, IB SD,CD,CDB,CR, IB SD,CD,CDB,CR, IB SD,CD,CDB,CR, IB SD,CD,CDB,CR, IB SD,LN, CDB,CR SD,LN, CDB,CR SD,LN, CDB,CR SD,LN, CDB,CR SD,LN, CDB,CR	TREE # 61 62 63 64 65 66 67 68 69 70 71	BOTANICAL NAME Pyrus calleryana Pyrus calleryana Pyrus calleryana Pyrus calleryana Ulmus parvifolia Sequoia Sempervirens	COMMON NAME Callery Pear Callery Pear Callery Pear Callery Pear Callery Pear Callery Pear Callery Pear Coast Redwood Coast Redwood Coast Redwood Coast Redwood	DBH (INCHES) I 13.0 I 14.0 I 15.0 I 15.0 I 23.0 I 26.0 I 28.0 I 30.0 I 22.5 I	CIRCUMFERENC E (INCHES) 41 44 47 35 72 82 57 88 94 71 79	HERITAGE TREE YES YES YES YES YES YES YES YES YES Y	HEALTH	PRESERVATION SUITABILITY Moderate Moderate Moderate Good Good Good Good Good Good Good	NOTES HD, SD, Cut off Powelines HD, SD, Cut off Powelines HD, SD, Cut off Powelines HD, SD, Cut off Powelines EG, CR EG, CR EG, CR EG, CR EG, CR EG, CR EG, CR
21 22 23 24 25 26 27 28 29 30 30 31 32 33	Morus alba Prunus cerasifera Prunus cerasifera Prunus cerasifera Prunus cerasifera Betula pendula Betula pendula Betula pendula Betula pendula Betula pendula	Mulberry Flowering Plum Flowering Plum Flowering Plum Flowering Plum White Birch White Birch White Birch White Birch White Birch White Birch Coast Live Oak	DBH (INCHES) 7.0 10.0 21.0 11.0 13.0 7.0 3.0 5.0 9.5 12.0 5.0 7.0	CIRCUMFERENC E (INCHES) 22 31 66 35 41 22 9 16 16 30 38 16 38 16 22	YES	HEALTH	PRESERVATION SUITABILITY Moderate Poor	NOTES SD,CD,IB SD,CD,CDB,CR, IB SD,CD,CDB,CR, IB SD,CD,CDB,CR, IB SD,CD,CDB,CR, IB SD,CD,CDB,CR, IB SD,LN, CDB,CR SD,LN, CDB,CR SD,LN, CDB,CR SD,LN, CDB,CR SD,LN, CDB,CR SD,LN, CDB,CR	TREE # 61 62 63 64 65 66 67 68 69 70 71 72	BOTANICAL NAME Pyrus calleryana Pyrus calleryana Pyrus calleryana Pyrus calleryana Ulmus parvifolia Ulmus parvifolia Ulmus parvifolia Sequoia sempervirens	COMMON NAME Callery Pear Callery Pear Callery Pear Callery Pear Callery Pear Callery Pear Callery Pear Coast Redwood Coast Redwood Coast Redwood Coast Redwood Coast Redwood	DBH I 13.0 I 14.0 I 15.0 I 15.0 I 23.0 I 26.0 I 30.0 I 30.0 I 22.5 I 25.0 I 15.0 I	CIRCUMFERENC E (INCHES) 41 44 47 35 72 82 57 82 57 88 94 71 79 47	HERITAGE TREE YES YES YES YES YES YES YES YES YES Y	HEALTH	PRESERVATION SUITABILITY Moderate Moderate Moderate Moderate Good Good Good Good Good Good Good Goo	NOTES HD, SD, Cut off Powelines HD, SD, Cut off Powelines HD, SD, Cut off Powelines HD, SD, Cut off Powelines EG, CR EG, CR EG, CR EG, CR EG, CR EG, CR EG, CR EG, CR
21 22 23 24 25 26 27 28 29 30 31 32 33 34	Morus alba Prunus cerasifera Prunus cerasifera Prunus cerasifera Prunus cerasifera Prunus cerasifera Betula pendula Betula pendula Betula pendula Betula pendula Quercus agrifolia Prunus cerasifera	Mulberry Flowering Plum Flowering Plum Flowering Plum Flowering Plum White Birch White Birch White Birch White Birch White Birch Coast Live Oak Flowering Plum	DBH (INCHES) 7.0 10.0 21.0 11.0 13.0 7.0 3.0 5.0 9.5 12.0 5.0 7.0 18.0	CIRCUMFERENC E (INCHES) 22 31 66 35 41 22 9 9 16 30 38 16 38 16 22 38 16 22 57	YES	HEALTH 3 2 2 2 2 2 2 2 2 2 2 3 3 3 3 3 3 3 3 2 2 2 2 3 3 2 2 2 2 3 3 2 2 2 2 2 2 2 2 2 2 2	PRESERVATION SUITABILITY Moderate Moderate <t< th=""><th>NOTES SD,CD,IB SD,CD,CDB,CR, IB SD,CD,CDB,CR, IB SD,CD,CDB,CR, IB SD,CD,CDB,CR, IB SD,CD,CDB,CR, IB SD,LN, CDB,CR SD,LN, CDB,CR SD,LN, CDB,CR SD,LN, CDB,CR SD,LN, CDB,CR SD,LN, CDB,CR SD,LN, CDB,CR SD,LN, CDB,CR</th><th>TREE # 61 62 63 64 65 66 67 68 69 70 71 72</th><th>BOTANICAL NAME Pyrus calleryana Pyrus calleryana Pyrus calleryana Pyrus calleryana Ulmus parvifolia Ulmus parvifolia Ulmus parvifolia Sequoia sempervirens Sequoia sempervirens</th><th>COMMON NAME Callery Pear Callery Pear Callery Pear Callery Pear Callery Pear Callery Pear Callery Pear Coast Redwood Coast Redwood Coast Redwood Coast Redwood Coast Redwood</th><th>DBH I 13.0 I 14.0 I 15.0 I 15.0 I 23.0 I 26.0 I 30.0 I 30.0 I 22.5 I 25.0 I 15.0 I</th><th>CIRCUMFERENC E (INCHES) 41 44 47 35 72 82 57 82 57 88 94 71 79 47</th><th>HERITAGE TREE YES YES YES YES YES YES YES YES YES Y</th><th>HEALTH</th><th>PRESERVATION SUITABILITY Moderate Moderate Moderate Good Good Good Good Good Good Good Goo</th><th>NOTES HD, SD, Cut off Powelines HD, SD, Cut off Powelines HD, SD, Cut off Powelines HD, SD, Cut off Powelines EG, CR EG, CR EG, CR EG, CR EG, CR EG, CR EG, CR EG, CR</th></t<>	NOTES SD,CD,IB SD,CD,CDB,CR, IB SD,CD,CDB,CR, IB SD,CD,CDB,CR, IB SD,CD,CDB,CR, IB SD,CD,CDB,CR, IB SD,LN, CDB,CR SD,LN, CDB,CR SD,LN, CDB,CR SD,LN, CDB,CR SD,LN, CDB,CR SD,LN, CDB,CR SD,LN, CDB,CR SD,LN, CDB,CR	TREE # 61 62 63 64 65 66 67 68 69 70 71 72	BOTANICAL NAME Pyrus calleryana Pyrus calleryana Pyrus calleryana Pyrus calleryana Ulmus parvifolia Ulmus parvifolia Ulmus parvifolia Sequoia sempervirens	COMMON NAME Callery Pear Callery Pear Callery Pear Callery Pear Callery Pear Callery Pear Callery Pear Coast Redwood Coast Redwood Coast Redwood Coast Redwood Coast Redwood	DBH I 13.0 I 14.0 I 15.0 I 15.0 I 23.0 I 26.0 I 30.0 I 30.0 I 22.5 I 25.0 I 15.0 I	CIRCUMFERENC E (INCHES) 41 44 47 35 72 82 57 82 57 88 94 71 79 47	HERITAGE TREE YES YES YES YES YES YES YES YES YES Y	HEALTH	PRESERVATION SUITABILITY Moderate Moderate Moderate Good Good Good Good Good Good Good Goo	NOTES HD, SD, Cut off Powelines HD, SD, Cut off Powelines HD, SD, Cut off Powelines HD, SD, Cut off Powelines EG, CR EG, CR EG, CR EG, CR EG, CR EG, CR EG, CR EG, CR
21 22 23 24 25 26 27 28 29 30 31 32 33 34 35	Morus alba Prunus cerasifera Prunus cerasifera Prunus cerasifera Prunus cerasifera Prunus cerasifera Betula pendula Betula pendula Betula pendula Betula pendula Quercus agrifolia Prunus cerasifera	Mulberry Flowering Plum Flowering Plum Flowering Plum Flowering Plum White Birch White Birch White Birch White Birch White Birch White Birch Coast Live Oak Flowering Plum Flowering Plum	DBH (INCHES) 7.0 10.0 21.0 11.0 13.0 7.0 3.0 5.0 9.5 12.0 5.0 7.0 8.0	CIRCUMFERENC E (INCHES) 22 31 66 35 41 22 9 16 30 30 38 16 38 16 22 57 25	YES	HEALTH 3 2 2 2 2 2 2 2 2 2 3 3 3 3 3 3 3 3 2 2 2 2 3 3 2 2 2 2 2 2 3 3 2 2 2 2 2 2 2 2 2 2 2 2 2 2 2 2 2 2 2 2 3 3 <t< th=""><th>PRESERVATION SUITABILITY Moderate Poor Moderate Moderate</th><th>NOTES SD,CD,IB SD,CD,CDB,CR, IB SD,CD,CDB,CR, IB SD,CD,CDB,CR, IB SD,CD,CDB,CR, IB SD,CD,CDB,CR, IB SD,LN, CDB,CR SD,LN, CDB,CR SD,LN, CDB,CR SD,LN, CDB,CR SD,LN, CDB,CR SD,LN, CDB,CR SD,LN, CDB,CR SD,LN, CDB,CR SD,LN, CDB,CR</th><th>TREE # 61 62 63 64 65 66 67 68 69 70 71 72</th><th>BOTANICAL NAME Pyrus calleryana Pyrus calleryana Pyrus calleryana Pyrus calleryana Ulmus parvifolia Ulmus parvifolia Ulmus parvifolia Sequoia sempervirens Sequoia sempervirens</th><th>COMMON NAME Callery Pear Callery Pear Callery Pear Callery Pear Callery Pear Callery Pear Callery Pear Coast Redwood Coast Redwood Coast Redwood Coast Redwood Coast Redwood</th><th>DBH I 13.0 I 14.0 I 15.0 I 15.0 I 23.0 I 26.0 I 30.0 I 30.0 I 22.5 I 25.0 I 15.0 I</th><th>CIRCUMFERENC E (INCHES) 41 44 47 35 72 82 57 82 57 88 94 71 79 47</th><th>HERITAGE TREE YES YES YES YES YES YES YES YES YES Y</th><th>HEALTH</th><th>PRESERVATION SUITABILITY Moderate Moderate Moderate Good Good Good Good Good Good Good Goo</th><th>NOTES HD, SD, Cut off Powelines HD, SD, Cut off Powelines HD, SD, Cut off Powelines HD, SD, Cut off Powelines EG, CR EG, CR EG, CR EG, CR EG, CR EG, CR EG, CR EG, CR</th></t<>	PRESERVATION SUITABILITY Moderate Poor Moderate Moderate	NOTES SD,CD,IB SD,CD,CDB,CR, IB SD,CD,CDB,CR, IB SD,CD,CDB,CR, IB SD,CD,CDB,CR, IB SD,CD,CDB,CR, IB SD,LN, CDB,CR SD,LN, CDB,CR SD,LN, CDB,CR SD,LN, CDB,CR SD,LN, CDB,CR SD,LN, CDB,CR SD,LN, CDB,CR SD,LN, CDB,CR SD,LN, CDB,CR	TREE # 61 62 63 64 65 66 67 68 69 70 71 72	BOTANICAL NAME Pyrus calleryana Pyrus calleryana Pyrus calleryana Pyrus calleryana Ulmus parvifolia Ulmus parvifolia Ulmus parvifolia Sequoia sempervirens	COMMON NAME Callery Pear Callery Pear Callery Pear Callery Pear Callery Pear Callery Pear Callery Pear Coast Redwood Coast Redwood Coast Redwood Coast Redwood Coast Redwood	DBH I 13.0 I 14.0 I 15.0 I 15.0 I 23.0 I 26.0 I 30.0 I 30.0 I 22.5 I 25.0 I 15.0 I	CIRCUMFERENC E (INCHES) 41 44 47 35 72 82 57 82 57 88 94 71 79 47	HERITAGE TREE YES YES YES YES YES YES YES YES YES Y	HEALTH	PRESERVATION SUITABILITY Moderate Moderate Moderate Good Good Good Good Good Good Good Goo	NOTES HD, SD, Cut off Powelines HD, SD, Cut off Powelines HD, SD, Cut off Powelines HD, SD, Cut off Powelines EG, CR EG, CR EG, CR EG, CR EG, CR EG, CR EG, CR EG, CR
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LANDSCAPE PLAN

THIS PROJECT INCLUDES LANDSCAPE DESIGN OF THE MULTI-USE, FLEXIBLE PEDESTRIAN PLAZA, THAT DOUBLES AS AN EMERGENCY VEHICLE ACCESS ROAD, A CHILDREN'S PLAY AREA, AND CONNECTING WALKWAYS. THE





LEGEND

- PROPOSED NEW BUILDING
- COLORED CONCRETE PEDESTRIAN PLAZA/EVA
- PLANTER LOW WALL
- EXISITNG PLAZA TO REMAIN (D)
- DINING PATIO (E)
- FENCED PLAYGROUND WITH RESILIENT PLAY SURFACING
- **G** EXISTING BUILDING TO REMAIN
- COVERED TRASH ENCLOSURE, BY OTHERS COLORED CONCRETE
- ORNAMENTAL ADAPTIVE PLANTING
- EXISTING PLANTER AREA TO REMAIN (\mathbf{K}) FLUSH DECKING WITH GUARDRAIL AND CUT-OUTS AND CIRCULAR BENCH FOR EXISTING TREES TO REMAIN
- M LONG-TERM BIKE LOCKER (2 SPACES) WITH THREE BIKE RACKS (6 SPACES)
- LOW WALL SEATING
- BIOTREATMENT PLANTING
- P 7' TALL GOOD NEIGHBOR FENCE

MATERIALS LIST

CONCRETE PAVING - DAVIS INTEGRAL COLOR ALTERNATING BAND OF SILVERSMOKE AND DARK GRAY

PLANTER WALLS - SMOOTH TROWEL FINISH COLOR: MATCH BUILDING. TEXTURE SMOOTH TROWEL

LOW WALL - SMOOTH TROWEL FINISH COLOR: MATCH BUILDING. TEXTURE SMOOTH TROWEL

FLUSH DECKING - TREX DECKING. COLOR BISCANE

<u>SYNTHETIC TURF PLAY SURFACE</u> - SYNLAWN PLAYGROUND SYSTEM WITH UNDERLAYMENT PAD. MODEL: PLAY PREMIUM.

FENCING AT PLAYGROUND - AMERISTAR MONTAGE II. HEIGHT: 6' COLOR: BLACK. GATE TO MATCH WITH PANIC HARDWARE.

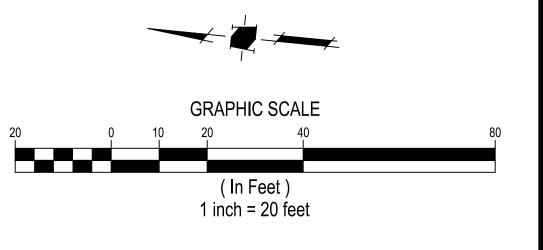
GUARDRAIL AT DECK - AMERISTAR MONTAGE II, HEIGHT: 4' COLOR: BLACK.

HANDRAILS AT RAMP AND STEPS - STAINLESS STEEL FLATBAR WITH EMBED MOUNTS

<u>CIRCULAR BENCH AT DECK -</u> LANDSCAPE FORMS LINK OUTDOOR BENCH. COLOR IPE

BIKE RACK - LANDSCAPE FORMS EMERSON BIKE RACK WITH EMBED MOUNT.

BIKE LOCKER - HUNTCO SITE FURNISHINGS BV-2 DOUBLE BIKE LOCKER. COLOR SILVER GRAY

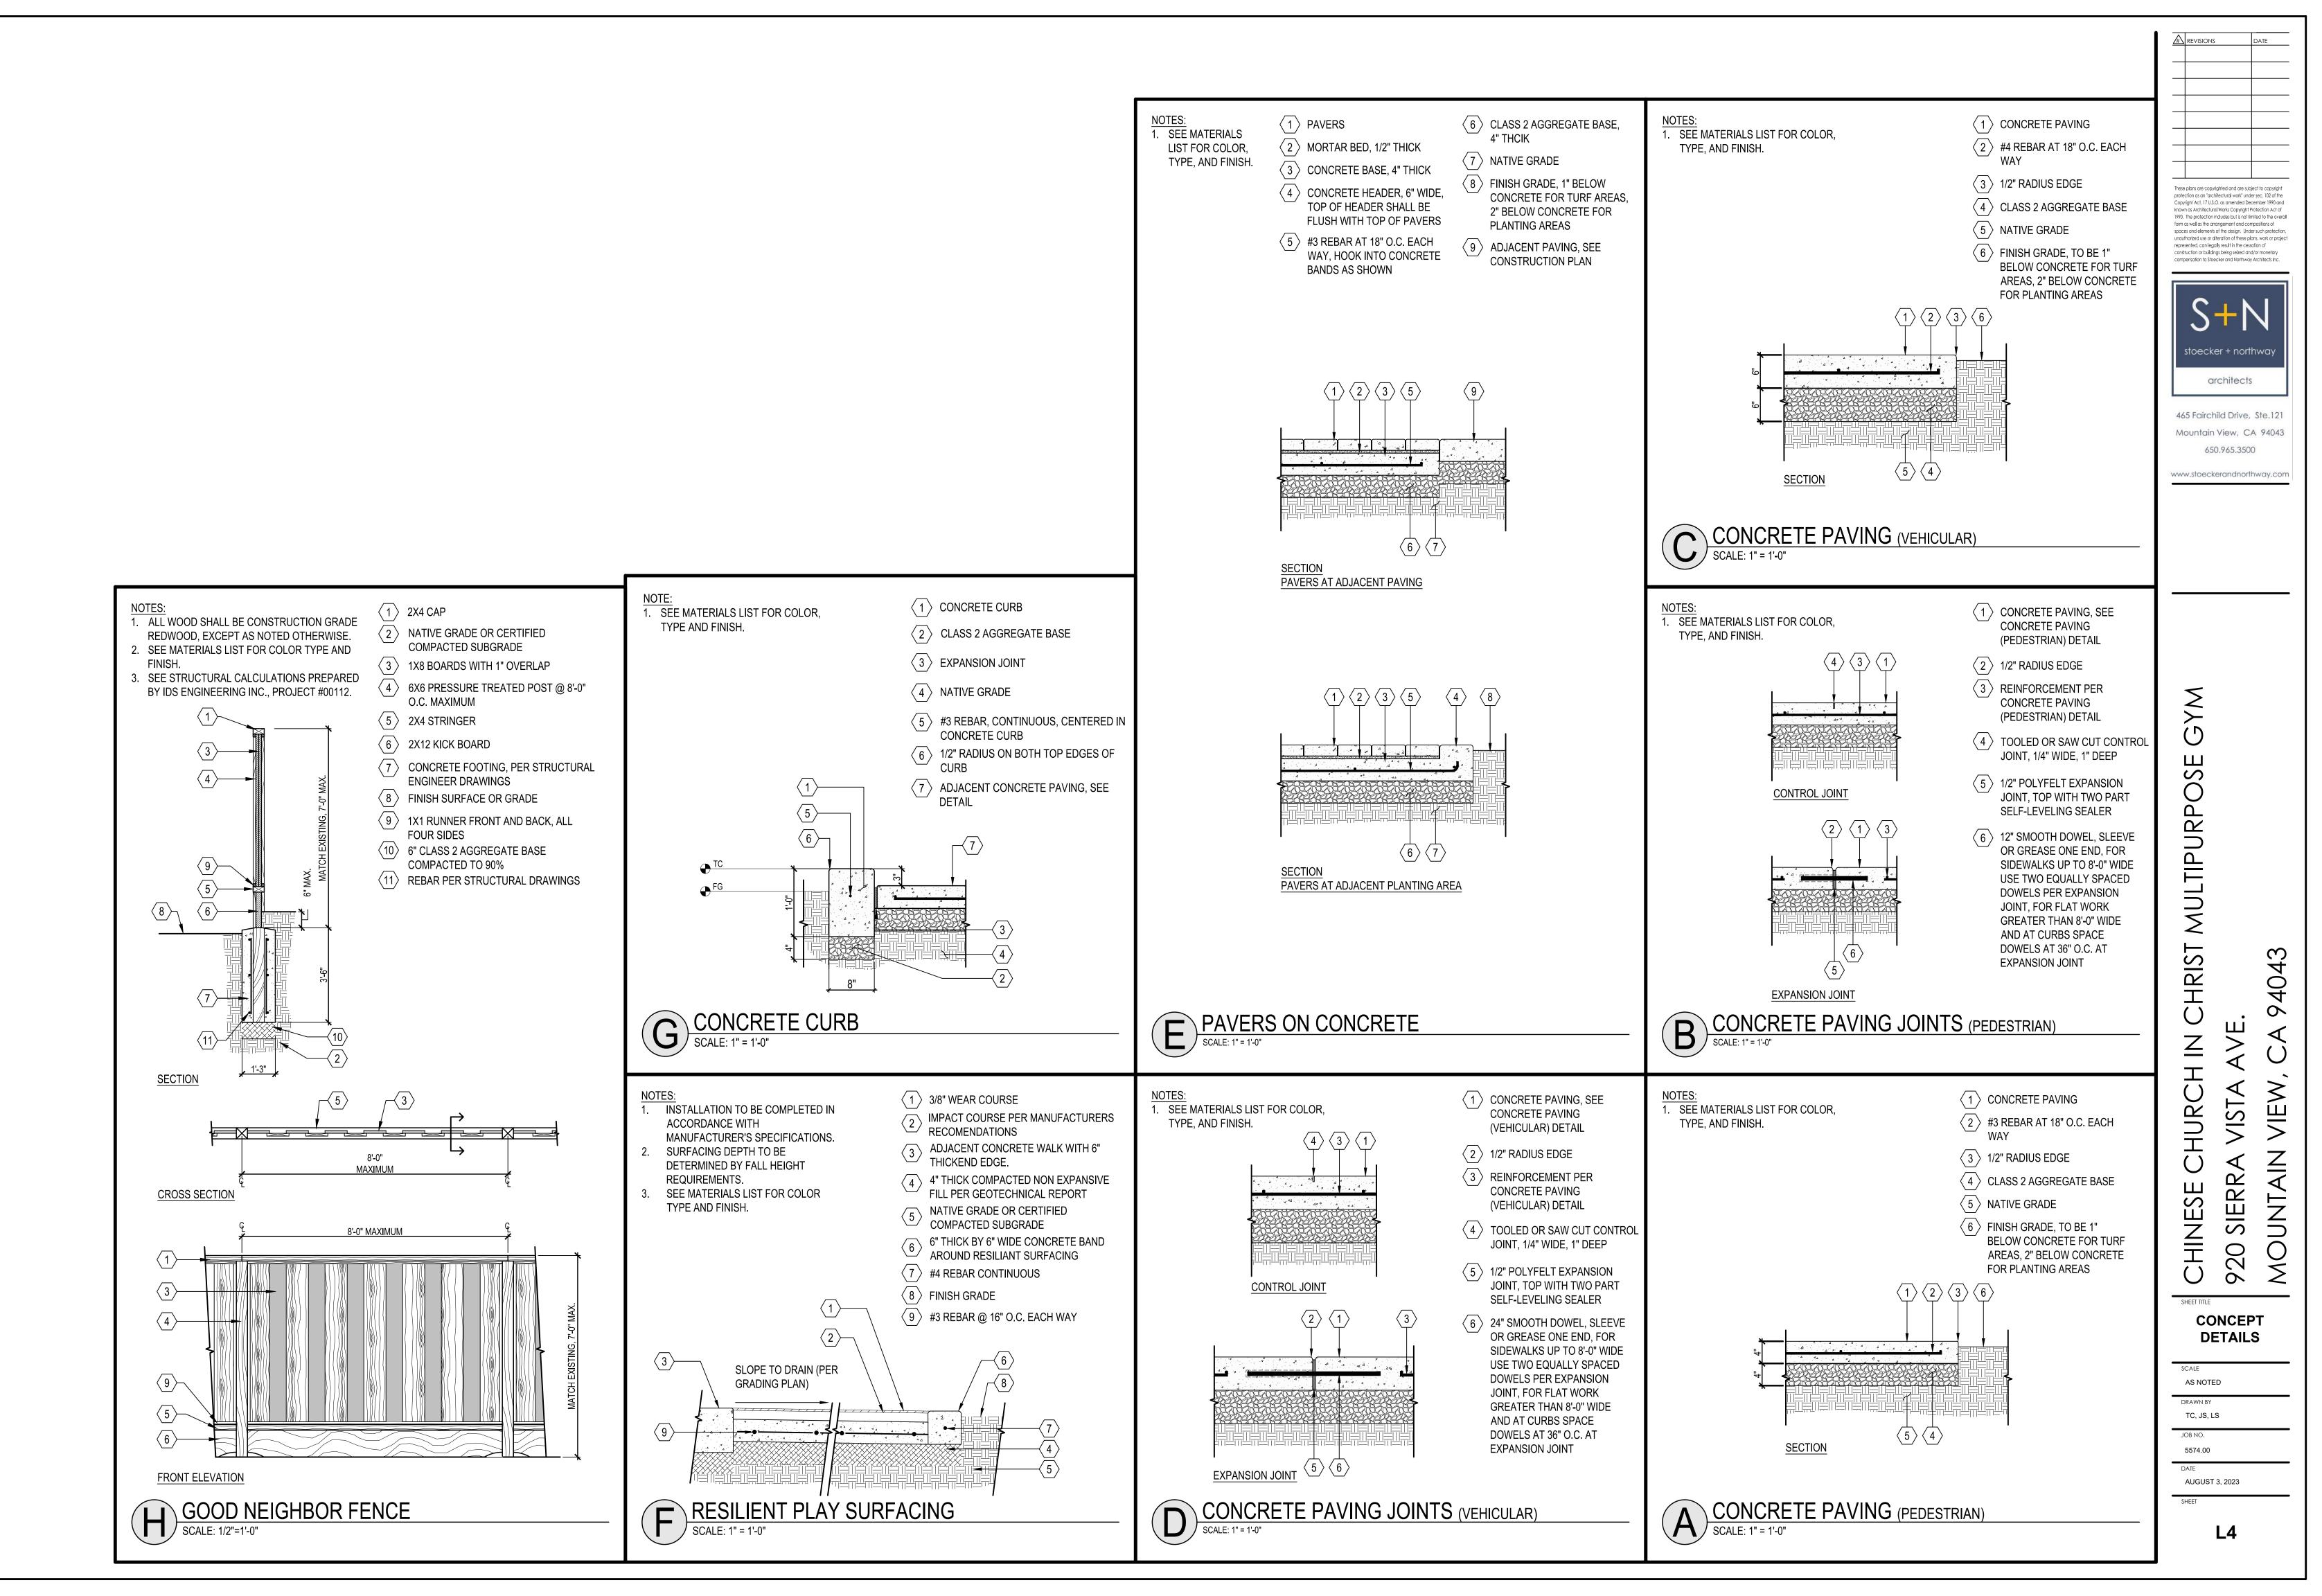


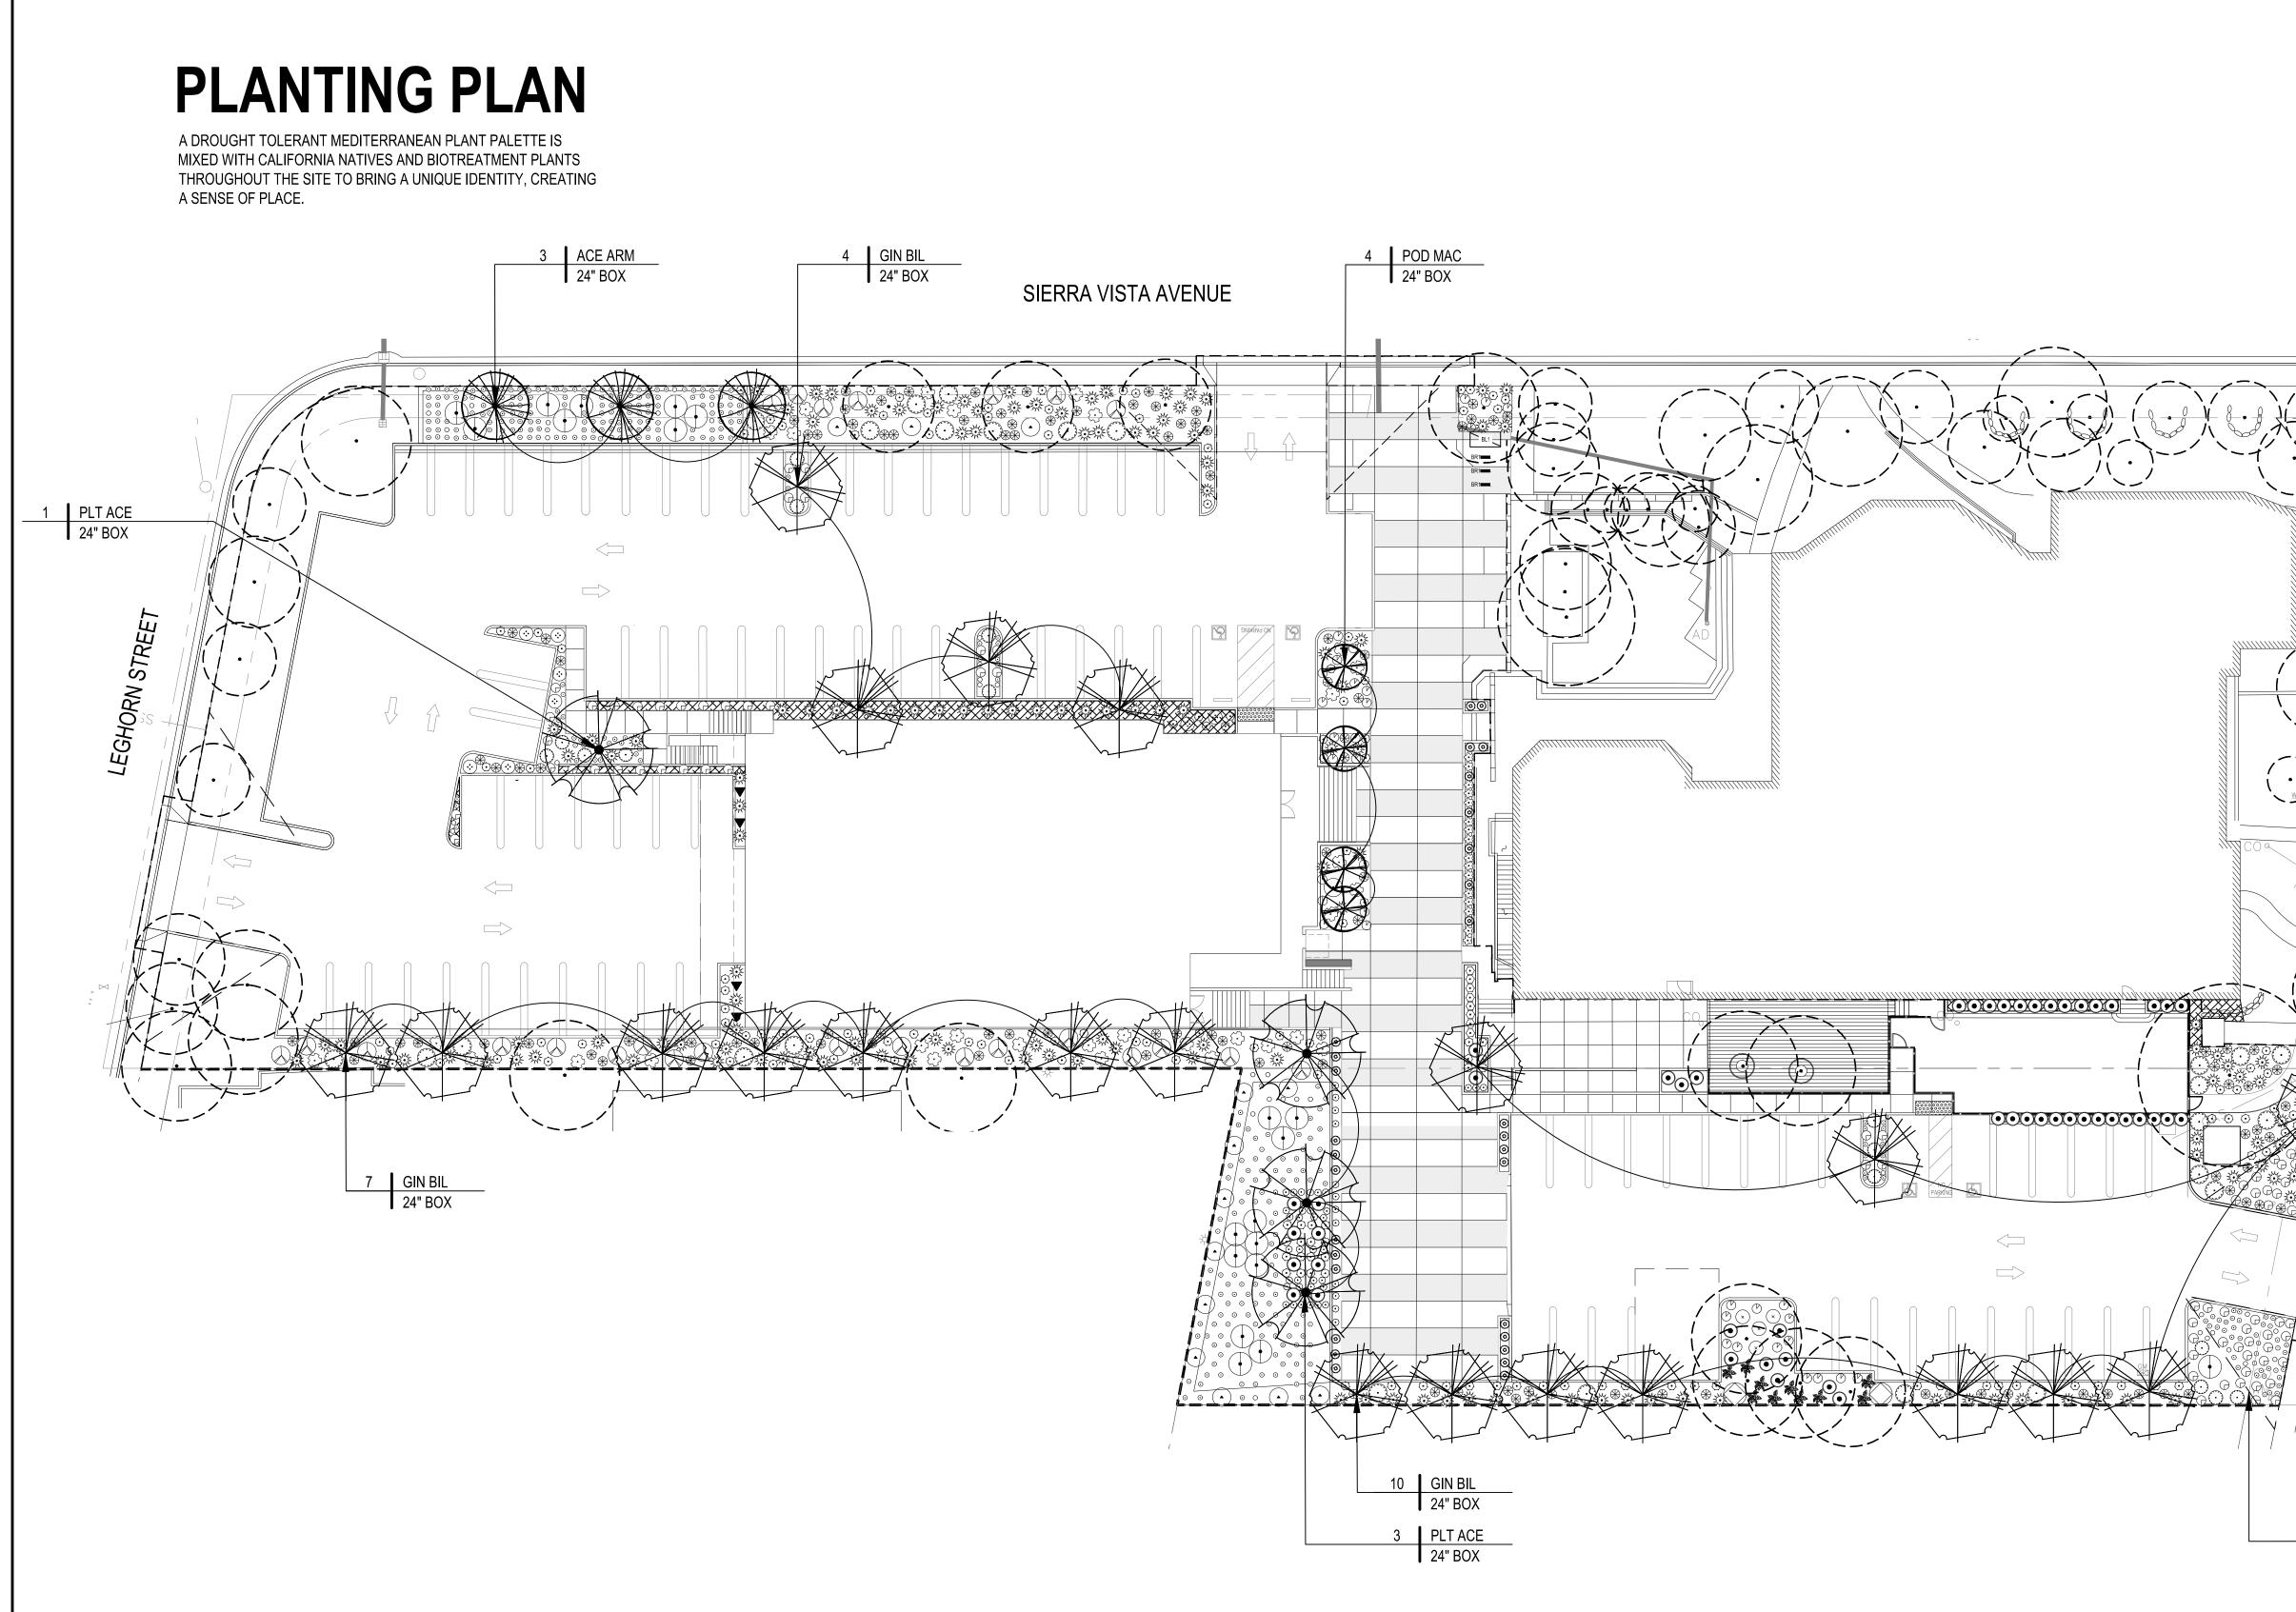
AUGUST 3, 2023

JOB NO.

DAI

5574.00





GRAPHIC SCALE 0 10 20 40 (In Feet) 1 inch = 20 feet

	PLANTING	G LEGEND	
	TREE LEGEND SYMBOL		
	ACE ARM	BOTANICAL NAME ACER RUBRUM 'ARMSTRONG'	
	GIN BIL	GINKO BILOBA	
	PLT ACE	PLATANUS ACERFOLIA	These plans are copyrighted and are subject to copyright
			protection as an "architectural work" under sec. 102 of the Copyright Act, 17 U.S.O. as amended December 1990 and known as Architectural Works Copyright Protection Act of 1990. The protection includes but is not limited to the overall
	POD MAC SHRUB/GRASS		form as well as the arrangement and compositions of spaces and elements of the design. Under such protection, unauthorized use or alteration of these plans, work or project represented, can legally result in the cessation of construction or buildings being seized and/or monetary
	STIKOD/GRASS SYMBOL	BOTANICAL NAME	compensation to Stoecker and Northway Architects Inc.
CAS	\odot	ACHILLEA MILLEFOLIUM	S+N
		ANIGOZANTHOS SP.	
X	\bigcirc	CAREX TUMULICOLA	stoecker + northway
		HEUCHERA MAXIMA	architects
	\bigcirc	IRIS DOUGLASIANA	465 Fairchild Drive, Ste.121 Mountain View, CA 94043
		IRIS DOUGLASIANA 'CANYON SNOW'	650.965.3500
CAS	$\langle \cdot \rangle$	LAVANDULA ANGUSTIFOLIA	www.stoeckerandnorthway.com
•	\bigcirc	LOMANDRA LONGIFOLIA 'BREEZE'	-
	ML Nor	LEYMUS CONDENSATUS 'CANYON PRINCE'	
w -	×	MAIANTHEMUM RACEMOSUM	
TR VALT		MUHLENBERGIA RIGENS	
	م م م م م م م م م م م م م م م م م م م	PENNISETUM 'LITTLE BUNNY'	_
STREE		PHLOMIS FRUTICOSA	Σ
HENO HENO		POLYSTICHUM MUNITUM	0 Z V
PLYMOUTH STREET		RHODODENDRON MACRPHYLLUM	POSE
	$(\cdot \cdot \cdot)$	ROSMARINUS OFFICIANALIS	URP(
	~~~~~~~~~~~~~~~~~~~~~~~~~~~~~~~~~~~~~~	SALVIA LEUCANTHA	
	(··)	STIPA ARUNDINACEA	MULT
	BIOTREATMEN	TLEGEND	
	SYMBOL	BOTANICAL NAME CHONDROPETALUM ELEPHANTINUM	
	$\odot$	JUNCUS PATENS	
-		RHAMNUS CALIFORNICA	IRCH STA / IEW,
			<b>1</b> ⊋ ⋝ >
	SYMBOL	BOTANICAL NAME TRACHELOSPERMUM JASMINIOIDES	
	GROUNDCOVE		NESE CH SIERRA UNTAIN
	SYMBOL	BOTANICAL NAME	
		BACCHARIS PILULARIS 'PIGEON POINT'	CHII 920 MO
		NTED MINIMUM 5' FROM UNDERGROUND	
	UTILITIES. 2. SEE SHEET L8 FOI	R PLANTING LEGEND AND NOTES.	
			PLAN
			SCALE AS NOTED
Ł			DRAWN BY TC, JS, LS
			JOB NO. 5574.00
80			DATE AUGUST 3, 2023
			AUGUST 3, 2023
			L7
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### PLANTING NOTES

CONTRACTOR SHALL PROVIDE ALL LABOR, MATERIALS, AND EQUIPMENT NECESSARY TO FURNISH AND INSTALL PLANT MATERIAL AS SHOWN ON THE DRAWINGS AND AS DESCRIBED IN THE SPECIFICATIONS.

UNLESS DESIGNATED ON THE DRAWINGS OTHERWISE, STRUCTURAL IMPROVEMENTS AND HARDSCAPE SHALL BE INSTALLED PRIOR TO PLANTING OPERATIONS.

PLANT LIST ON THE DRAWINGS SHALL BE USED AS A GUIDE ONLY. CONTRACTOR SHALL TAKEOFF AND VERIFY SIZES AND QUANTITIES BY PLAN CHECK.

A SOIL MANAGEMENT REPORT SHALL BE PROVIDED BY LANDSCAPE CONTRACTOR AND SOIL AMENDMENTS SHALL BE FOLLOWED PER THE REPORT. PHYSICAL COPIES OF THE SOIL MANAGEMENT REPORT SHALL BE PROVIDED TO THE CLIENT, PROJECT LANDSCAPE ARCHITECT AND LOCAL AGENCY AS REQUIRED. THE SOIL MANAGEMENT REPORT SHALL CONFORM TO STATE AB1881 WATER EFFICIENT LANDSCAPE ORDINANCE (WELO) OR LOCAL AGENCY ADOPTED WELO. CONTRACTOR SHALL OBTAIN A SOILS MANAGEMENT REPORT AFTER GRADING OPERATIONS AND PRIOR TO PLANT INSTALLATION.

SAMPLES OF FERTILIZERS, ORGANIC AMENDMENT, SOIL CONDITIONERS, AND SEED SHALL BE SUBMITTED PRIOR TO INCORPORATION. CONTRACTOR SHALL FURNISH TO THE OWNER'S AUTHORIZED REPRESENTATIVE A CERTIFICATE OF COMPLIANCE FOR SUCH FURNISHED MATERIALS.

ALL WORK ON THE IRRIGATION SYSTEM, INCLUDING HYDROSTATIC, COVERAGE, AND OPERATIONAL TESTS AND THE BACKFILLING AND COMPACTION OF TRENCHES SHALL BE PERFORMED PRIOR TO PLANTING OPERATIONS.

LOCATIONS OF PLANT MATERIAL SHALL BE REVIEWED ON SITE BY THE OWNER'S AUTHORIZED REPRESENTATIVE PRIOR TO INSTALLATION.

TREES SHALL BE PLANTED NO CLOSER THAN TEN FEET (10') FROM UTILITIES.

TREES PLANTED WITHIN FIVE FEET (5') OF HARDSCAPE OR STRUCTURES SHALL BE INSTALLED WITH A ROOT BARRIER AS APPROVED BY THE OWNER'S AUTHORIZED REPRESENTATIVE.

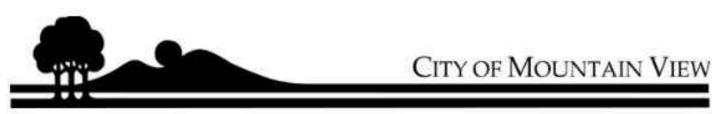
CONTRACTOR MUST CONTACT THE CITY ARBORIST TO VERIFY SPECIES (EVEN IF SHOWN ON THE PLANS), LOCATIONS, AND QUANTITIES OF ALL STREET TREES PRIOR TO ORDERING MATERIAL. IF STREET TREES ARE TO BE PLANTED IN TREE WELLS, FINAL LOCATION OF TREE WELLS SHALL BE DETERMINED BY THE ARBORIST PRIOR TO INSTALLATION OF SIDEWALK.

ALL PLANTING AREAS TO RECEIVE 3" THICK BARK MULCH LAYER. CONTRACTOR SHALL PROVIDE SAMPLE OF PROPOSED BARK MULCH FOR APPROVAL. BARK MULCH SHALL BE LYNGSO SMALL FIR BARK (3/4" TO 1-1/2") OR APPROVED EQUAL.

ALL PLANT MATERIAL SHALL BE SELECTED IN ACCORDANCE WITH THE AMERICAN STANDARD FOR NURSERY STOCK (ANSI Z60.1)

FOR STANDARD FORM TREES, CALIPER SIZE SHALL BE MEASURED 6" ABOVE THE SOIL LINE FOR CALIPERS EQUAL TO OR LESS THAN 4" FOR CALIPERS GREATER THAN 4", CALIPER SHALL BE MEASURES 12" ABOVE THE SOIL LINE. FOR MULTI-TRUNK TREES THE CALIPER SHALL BE ESTABLISHED BY TAKING THE AVERAGE OF THE CALIPER OF THE TWO LARGEST TRUNKS.

CALIPER IS MEASURED 6" ABOVE ORIGINATION POINT OF THE SECOND LARGEST TRUNK OR 6" ABOVE GROUND IF ALL TRUNKS ORIGINATE FROM THE SOIL.



### WATER-EFFICIENT DESIGN AND MAINTENANCE CHECKLIST

Project Site Address: 920 SIERRA VISTA AVE, MOUNTAIN VIEW CA 94043

Required Submittals (check if completed)

- 1. Water-Efficient Design and Maintenance Checklist
- 🗹 2. Landscape Design Plan
- Y 3. Irrigation Design Plan
- 4. Water Budget Calculation Worksheet (NOT needed if Plant-Type Restriction Option is chosen)
   5. Certification of Installation (Within 60 days of installation)
- 5. Certification of instantation (within 60 days of insta

### Landscape Design Plan Requirements

Parameter	Requirements	Completee
Plantings	Plant Table included in plan with plant symbol, common name, botanical name, container size, quantity, type (e.g., grass, succulent, vine, shrub, tree), water-efficient species identification (low, moderate, high), and unique physical specifications of plants, if applicable.	đ
	Plant types are assigned appropriate water-use levels based on the WUCOLS species evaluation list (i.e., "turf" is not assigned a "low"-water use).	2
	Avoid invasive plants in plan, such as those listed by the California Invasive Plant Council.	
	Square footages of planted areas and water features (i.e., fountains and pools) noted on the Landscape Design Plan and match areas listed in Compliance Option 1 calculations on Page 2, if applicable.	ø
Turf	Turf areas are at least 10' wide, unless watered with subsurface drip irrigation.	N.
	Turf is not planted on slopes of 25 percent grade or more.	
	Turf is at least 24" away from nonpermeable hardscape (except internal pathways), unless watered with subsurface drip irrigation.	M
Special Landscape Areas	Areas identified as SLAs meet the definition of a Special Landscape Area: An area of landscape dedicated solely to edible plants, areas irrigated with nonpotable water, water features using nonpotable water, and areas dedicated to active play (parks, sports fields, golf courses). SLAs DO NOT INCLUDE front-yard and backyard lawns of private residences or water features that use potable water.	٥
Hydrozones	Plants are grouped by hydrozone (similar water needs, sun exposure, slope, soil).	M
	Hydrozones, including SLAs, are delineated and labeled with square footages.	
	Hydrozones are labeled as low, moderate, high, or mixed (low/moderate) water use.	No.
	High-water-use plants are confined to their own hydrozones (not mixed with plants with low- or moderate-water needs).	5
	Single hydrozones with both low- and moderate-water-use plants are labeled "mixed."	
	Hardscapes are identified.	No.
	Square footages for hydrozones, water features, and SLAs on plan match those listed on the Water Budget Calculation Worksheets (if Compliance Option 2 is chosen).	
Mulch	Mulch is at least 3" deep on exposed soil surfaces. Depth and type of mulch are noted in plan.	M
Water	Recirculating (if water features are included in plan).	
Features	Pool/spa cover (if pool/spa is included in plan).	
Grading and	Grading contours and quantities shown on Landscape Design and/or Irrigation Design Plan.	
Stormwater	Grading meets applicable requirements of City Standard Design Criteria.	
Management	Stormwater management practices are incorporated appropriately.	M

	G LEGEND						
	) BOTANICAL NAME	COMMON NAME	QUANTITY	MINIMUM CONTAINER SIZE	HxW	WUCOLS	NOTES
ACE ARM	ACER RUBRUM 'ARMSTRONG'	ARMSTRONG RED MAPLE	3	24" BOX	45'X15'	M	NA
GIN BIL	GINKGO BILOBA	MAIDENHAIR TREE	21	24" BOX	25'X25'	L	MALE SPECIMENS ONLY
PLT ACE	PLATANUS ACERFOLIA	LONDON PLANE	4	24" BOX	20'x20'	L	NA
POD MAC	PODOCARPUS MACROPHYLUS	YEW PINE	4	24" BOX	35'X10'	М	NA
HRUB/GRASS	S LEGEND BOTANICAL NAME	COMMON NAME	QUANTITY	MINIMUM CONTAINER SIZE	HxW	WUCOLS	NOTES
$\odot$	ACHILLEA MILLEFOLIUM *	COMMON YARROW	47	5 GALLON	2'X2'	L	NA
$\langle \cdot \rangle$	ANIGOZANTHOS SP.	KANGAROO PAW	16	5 GALLON	3'X2'	L-M	NA
$\bigcirc$	CAREX TUMULICOLA *	BERKELEY SEDGE	83	5 GALLON	2'X2'	L	NA
	HEUCHERA MAXIMA *	ISLAND ALUM ROOT	35	5 GALLON	2'X2'	L	NA
$\bigoplus$	IRIS DOUGLASIANA *	DOUGLAS IRIS	124	5 GALLON	2'X2'	L	NA
$\bigcirc$	IRIS DOUGLASIANA 'CANYON SNOW' *	CANYON SNOW DOUGLAS IRIS	49	5 GALLON	2'X3'	L	NA
$\langle \bullet \rangle$	LAVANDULA ANGUSTIFOLIA	ENGLISH LAVANDER	10	5 GALLON	2'X2'	L	NA
$\langle \bullet \rangle$	LOMANDRA LONGIFOLIA 'BREEZE'	DWARF MAT RUSH	157	5 GALLON	2'X2'	L	NA
M.	LEYMUS CONDENSATUS 'CANYON PRINCE' *	CANYON PRINCE WILD RYE	152	5 GALLON	2'X3'	L	NA
×	MAIANTHEMUM RACEMOSUM *	LARGE FALSE SOLOMON'S SEAL	4	5 GALLON	1.4'X3'	L	NA
	MUHLENBERGIA RIGENS *	DEER GRASS	25	5 GALLON	4'X4'	L	NA
	PENNISETUM 'LITTLE BUNNY'	LITTLE BUNNY FEATHER GRASS	30	5 GALLON	2'X2'	L	NA
	PHLOMIS FRUTICOSA	JERUSALEM SAGE	33	5 GALLON	3'X3'	L	NA
	POLYSTICHUM MUNITUM *	WESTERN SWORD FERN	10	5 GALLON	3'X3'	М	NA
	RHODODENDRON MACRPHYLLUM *	PACIFIC RHODODENDRON	2	5 GALLON	5'X5'	М	NA
$\overbrace{\boldsymbol{\cdot}}$	ROSMARINUS OFFICIANALIS	ROSEMARY	10	5 GALLON	4'X3'	L	NA
	SALVIA LEUCANTHA	MEXICAN SAGE	26	5 GALLON	4'X4'	М	NA
	STIPA ARUNDINACEA	NEW ZEALAND WIND GRASS	15	5 GALLON	3'X3'	Μ	NA
IOTREATMEN SYMBOL	NT LEGEND BOTANICAL NAME	COMMON NAME	QUANTITY	MINIMUM CONTAINER SIZE	HxW	WUCOLS	NOTES
	CHONDROPETALUM ELEPHANTINUM	LARGE CAPE RUSH	20	5 GALLON	4'X5'	L-M	NA
$\odot$	JUNCUS PATENS *	CALIFORNIA GRAY RUSH	416	5 GALLON	2'X1'	L	NA
	RHAMNUS CALIFORNICA 'LITTLE SUR' *	LITTLE SUR COFFEEBERRY	14	5 GALLON	4'X4'	L	NA
INE LEGEND SYMBOL	BOTANICAL NAME	COMMON NAME	QUANTITY	MINIMUM CONTAINER SIZE	HxW	WUCOLS	NOTES
▼	TRACHELOSPERMUM JASMINIOIDES	STAR JASMINE	4	5 GALLON	NA	М	NA
ROUNDCOVE SYMBOL		COMMON NAME	QUANTITY	MINIMUM CONTAINER SIZE	HxW	WUCOLS	NOTES
	BOTANICAL NAME BACCHARIS PILULARIS 'PIGEON POINT' *	COYOTE BUSH	36" O.C.	5 GALLON	SPREADING		NA

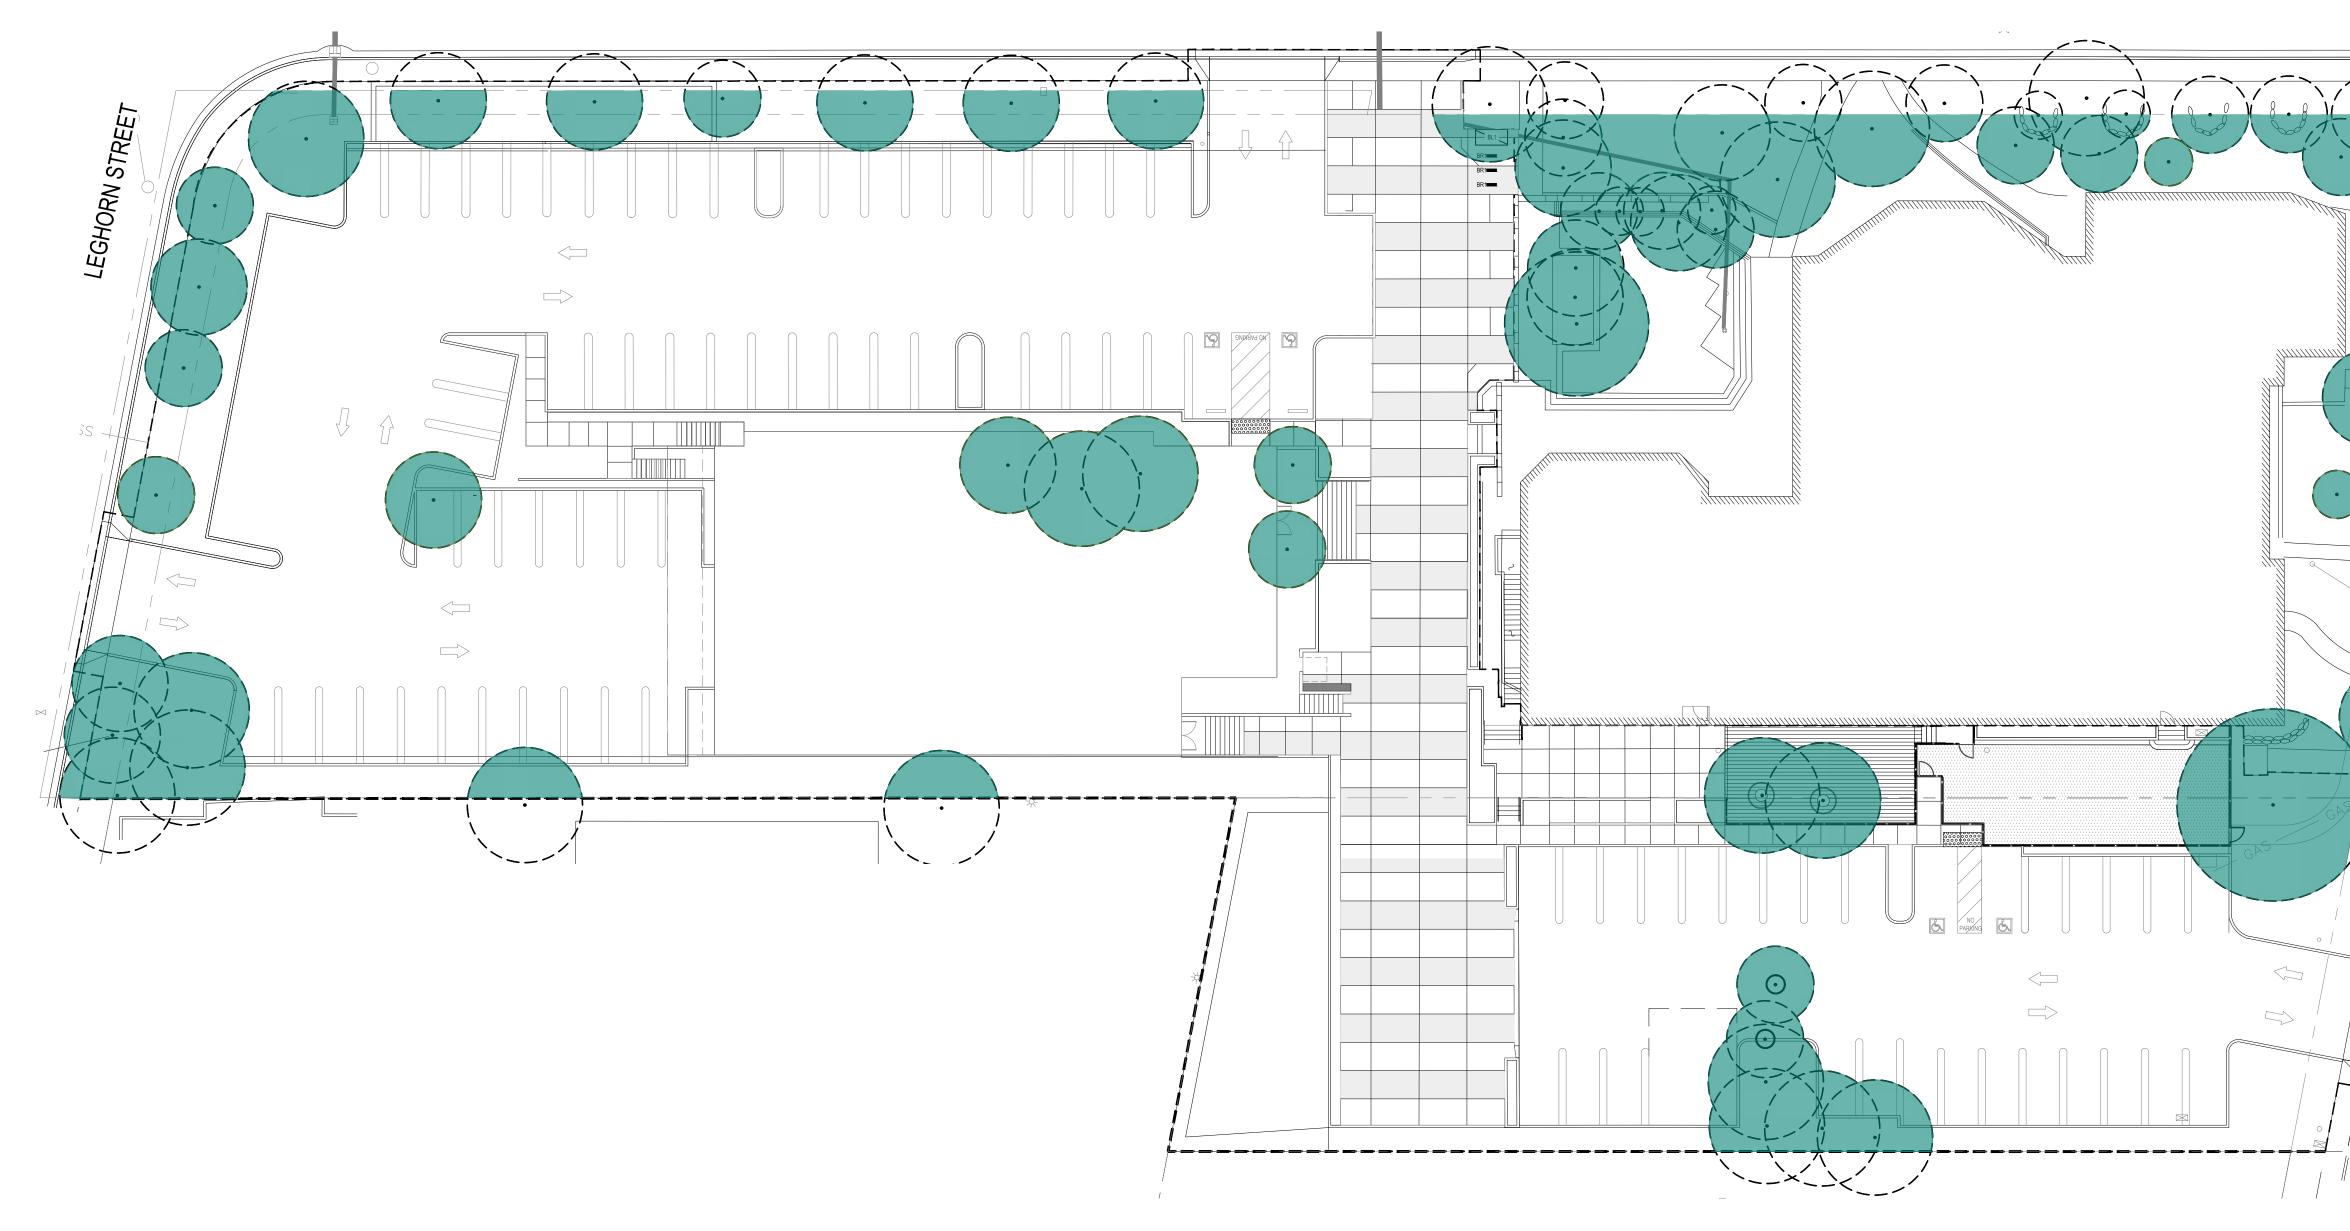
* = NATIVE TO CALIFORNIA

** PROJECT WILL HAVE 75% NATIVE PLANTS OR LOW WATER USE PLANTS PER CITY REQUIREMENT.

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	.O. as amended De al Works Copyright F includes but is not lir rangement and cor s of the design. Und siteration of these pl ally result in the cess ngs being seized and	cember 1990 and rotection Act of mited to the overall positions of er such protection, ans, work or project ation of J/or monetary Architects Inc.
	View, C 0.965.350	A 94043
CHINESE CHURCH IN CHRIST MULTIPURPOSE GYM	920 SIERRA VISTA AVE.	MOUNTAIN VIEW, CA 94043
DRAWN BY TC, JS, L JOB NO. 5574.00 DATE	S	

AUGUST 3, 2023

# **EXISTING TREE CANOPY PLAN**



# SIERRA VISTA AVENUE

TREE CANOPY LEGE		SYMBOL	
FULL GROWTH			
PERCENTAGE OF SI DESCRIPTION	TE COVER BY TRI AREA	EE CANOPY PERCENTAGE	
EXISTING CONDITION	14,150 / 88,001 SF	16%	
*CALCULATIONS DO NOT INC	CLUDE OFFSITE TREE CA	NOPY	These plans are copyrighted and are subject to cop protection as an "architectural work" under sec. 102. Copyright Act, 17 U.S.O. as amended December 199 known as Architectural Works Copyright Protection A 1990. The protection includes but is not limited to the
			form as well as the arrangement and compositions a spaces and elements of the design. Under such pro unauthorized use or alteration of these plans, work on represented, can legally result in the cessation of construction or buildings being seized and/or monet
			compensation to Stoecker and Northway Architects
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			architects
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			650.965.3500
			www.stoeckerandnorthway.
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			JRC 'IST,
			SE ( RR/
			INESE CHURCH IN CHRIST MULTIPU ) SIERRA VISTA AVE.
			CHINESE CHURCH IN CHRIST 920 SIERRA VISTA AVE.
. 1 .			EXISTING TRE CANOPY PLA
			SCALE AS NOTED
			DRAWN BY TC, JS, LS
<b>GRAPHIC SCALE</b>			10, J3, L3

JOB NO. 5574.00

DATE

SHEET

AUGUST 3, 2023

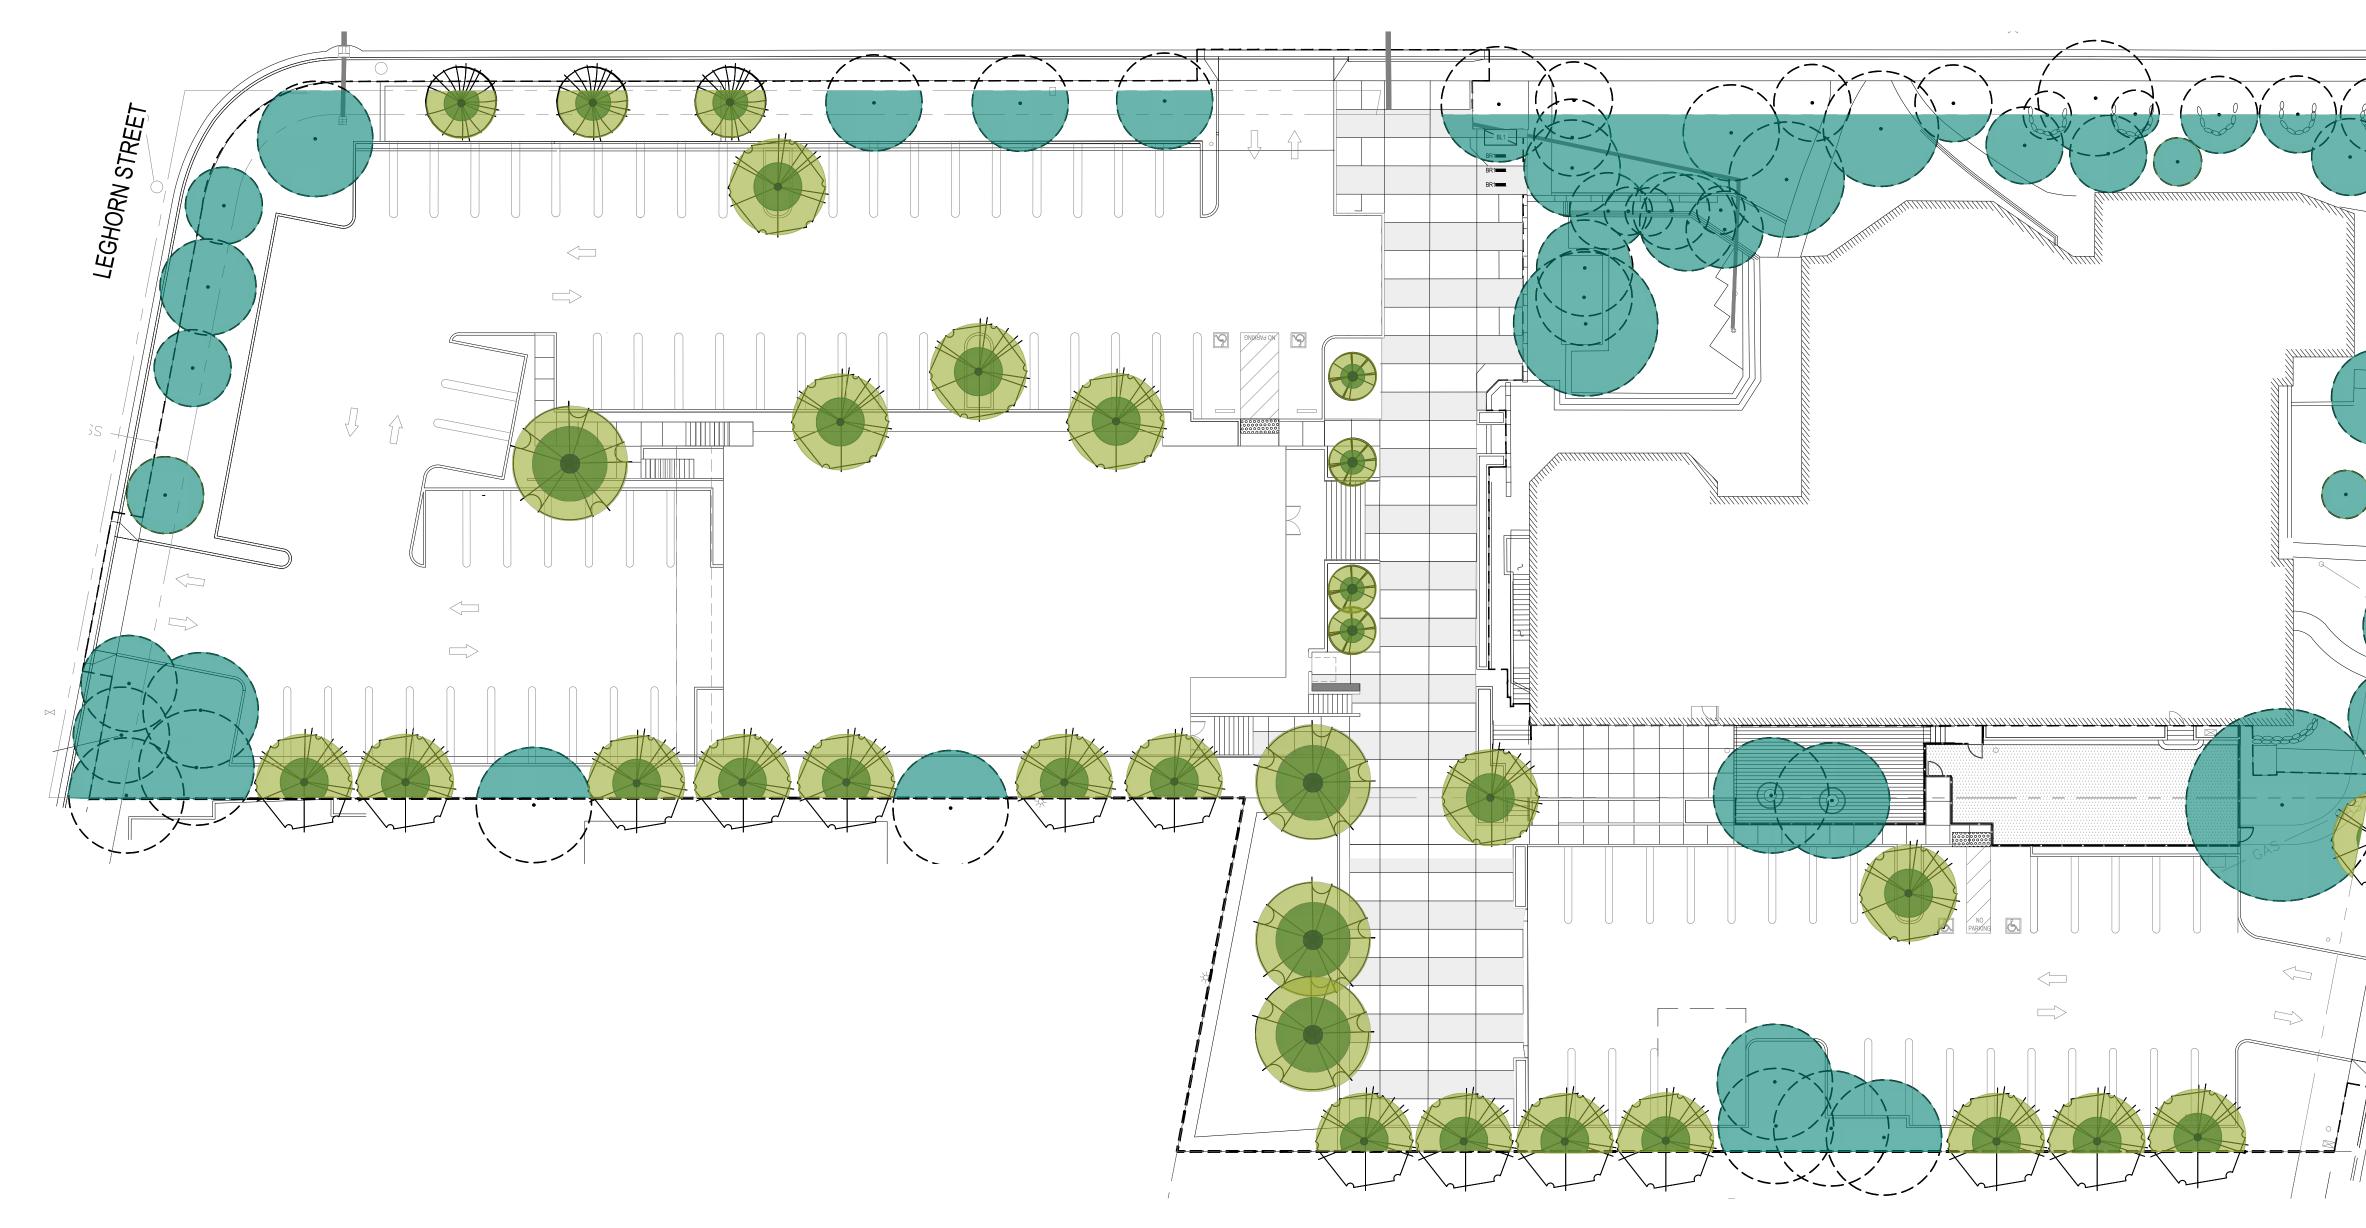
L10

PL YMOUTH STREET

(In Feet)	
1 inch = 20 feet	

# **TREE CANOPY PLAN**

## SIERRA VISTA AVENUE

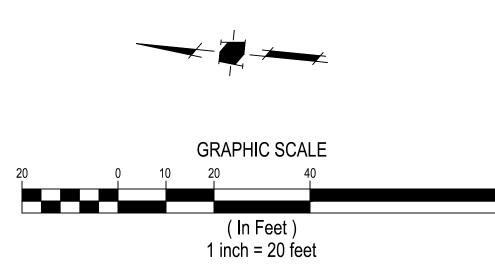


TREE CANOPY LEGEND		SYMBOL	<u>_</u>		DATE
CONSTRUCTION COMPLETION					
5-10 YEARS					
FULL GROWTH					
EXISTING TO REMAIN			prote	e plans are copyrighted and ection as an "architectural w yright Act, 17 U.S.O. as amer	ork" under sec. 102 of the
PERCENTAGE OF SITE ( DESCRIPTION	COVER BY TRE AREA	EE CANOPY PERCENTAGE	1990 form spac unai	as well as the arrangement ces and elements of the desi	it is not limited to the overall and compositions of ign. Under such protection, these plans, work or project
CONSTRUCTION COMPLETION	11,722 / 88,001 SF	13%	cons	truction or buildings being se pensation to Stoecker and M	eized and/or monetary
5-10 YEARS	13,952 / 88,001 SF	16%		<b>C</b> I	NI
FULL GROWTH	19,008 / 88,001 SF	22%		S+	IN
*CALCULATIONS DO NOT INCLUDI	E OFFSITE TREE CAI	NOPY		stoecker + 1	
				archite	ects



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PLYMOUTH STREET