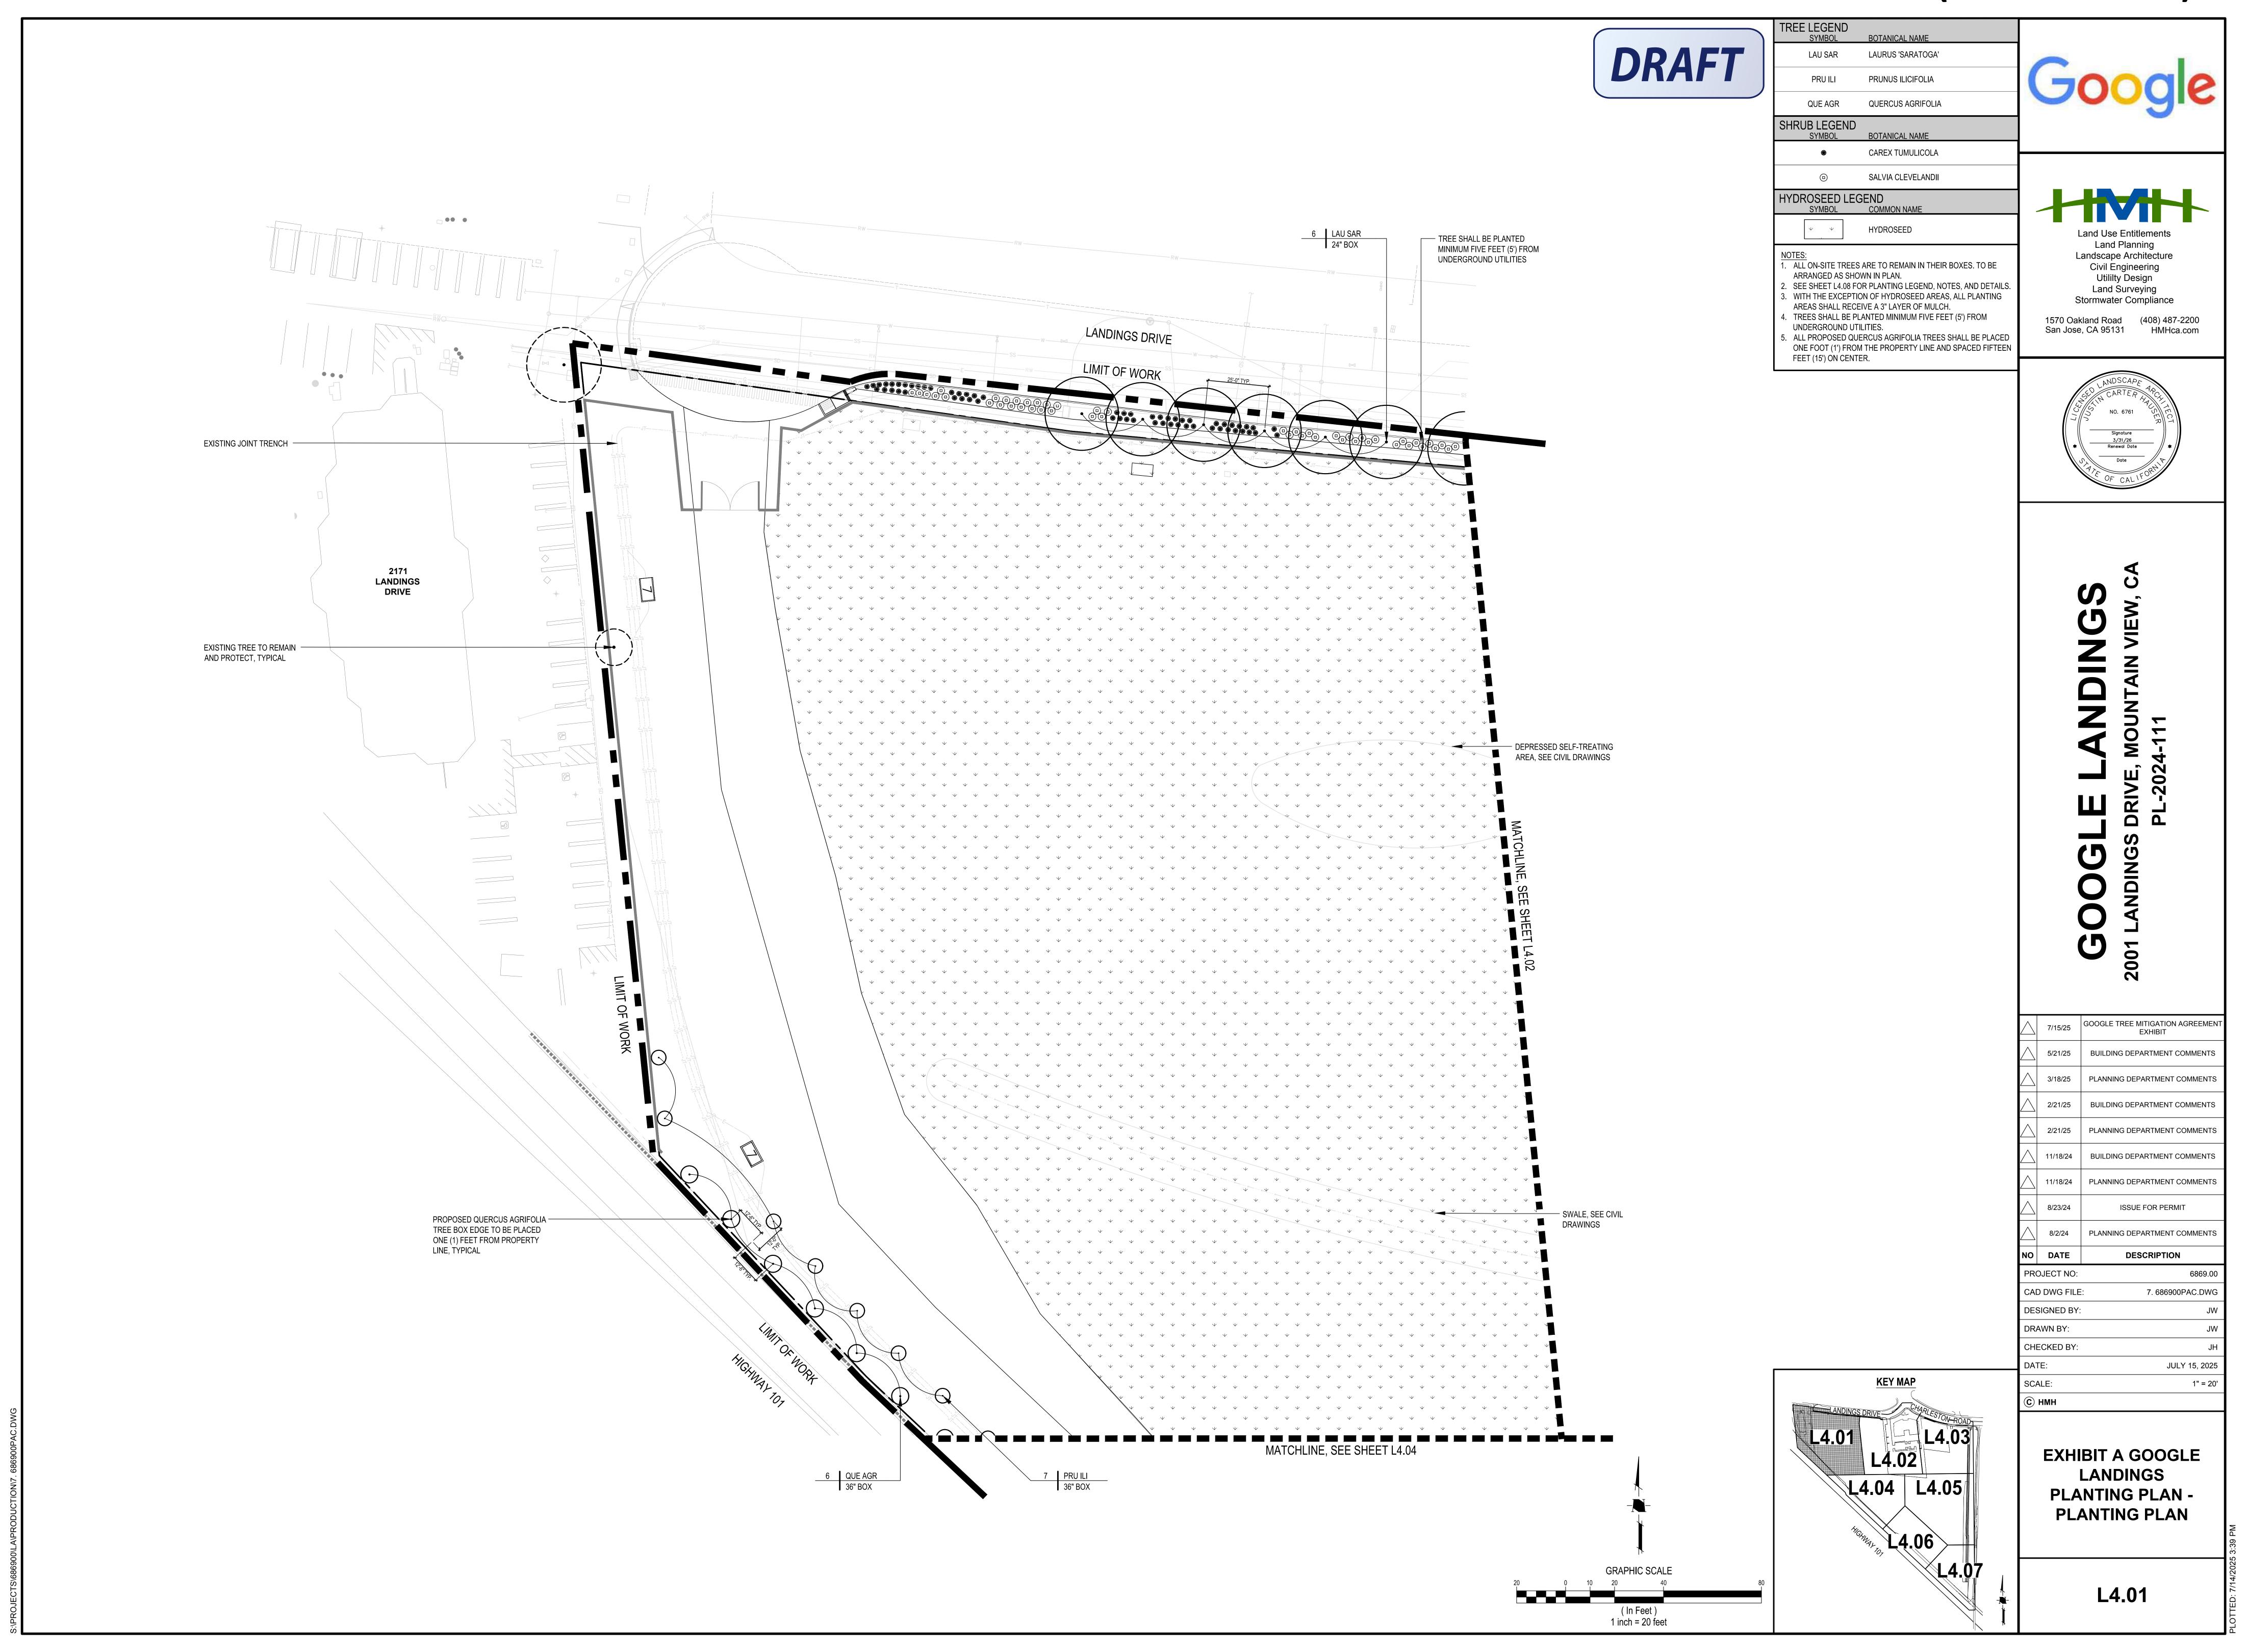
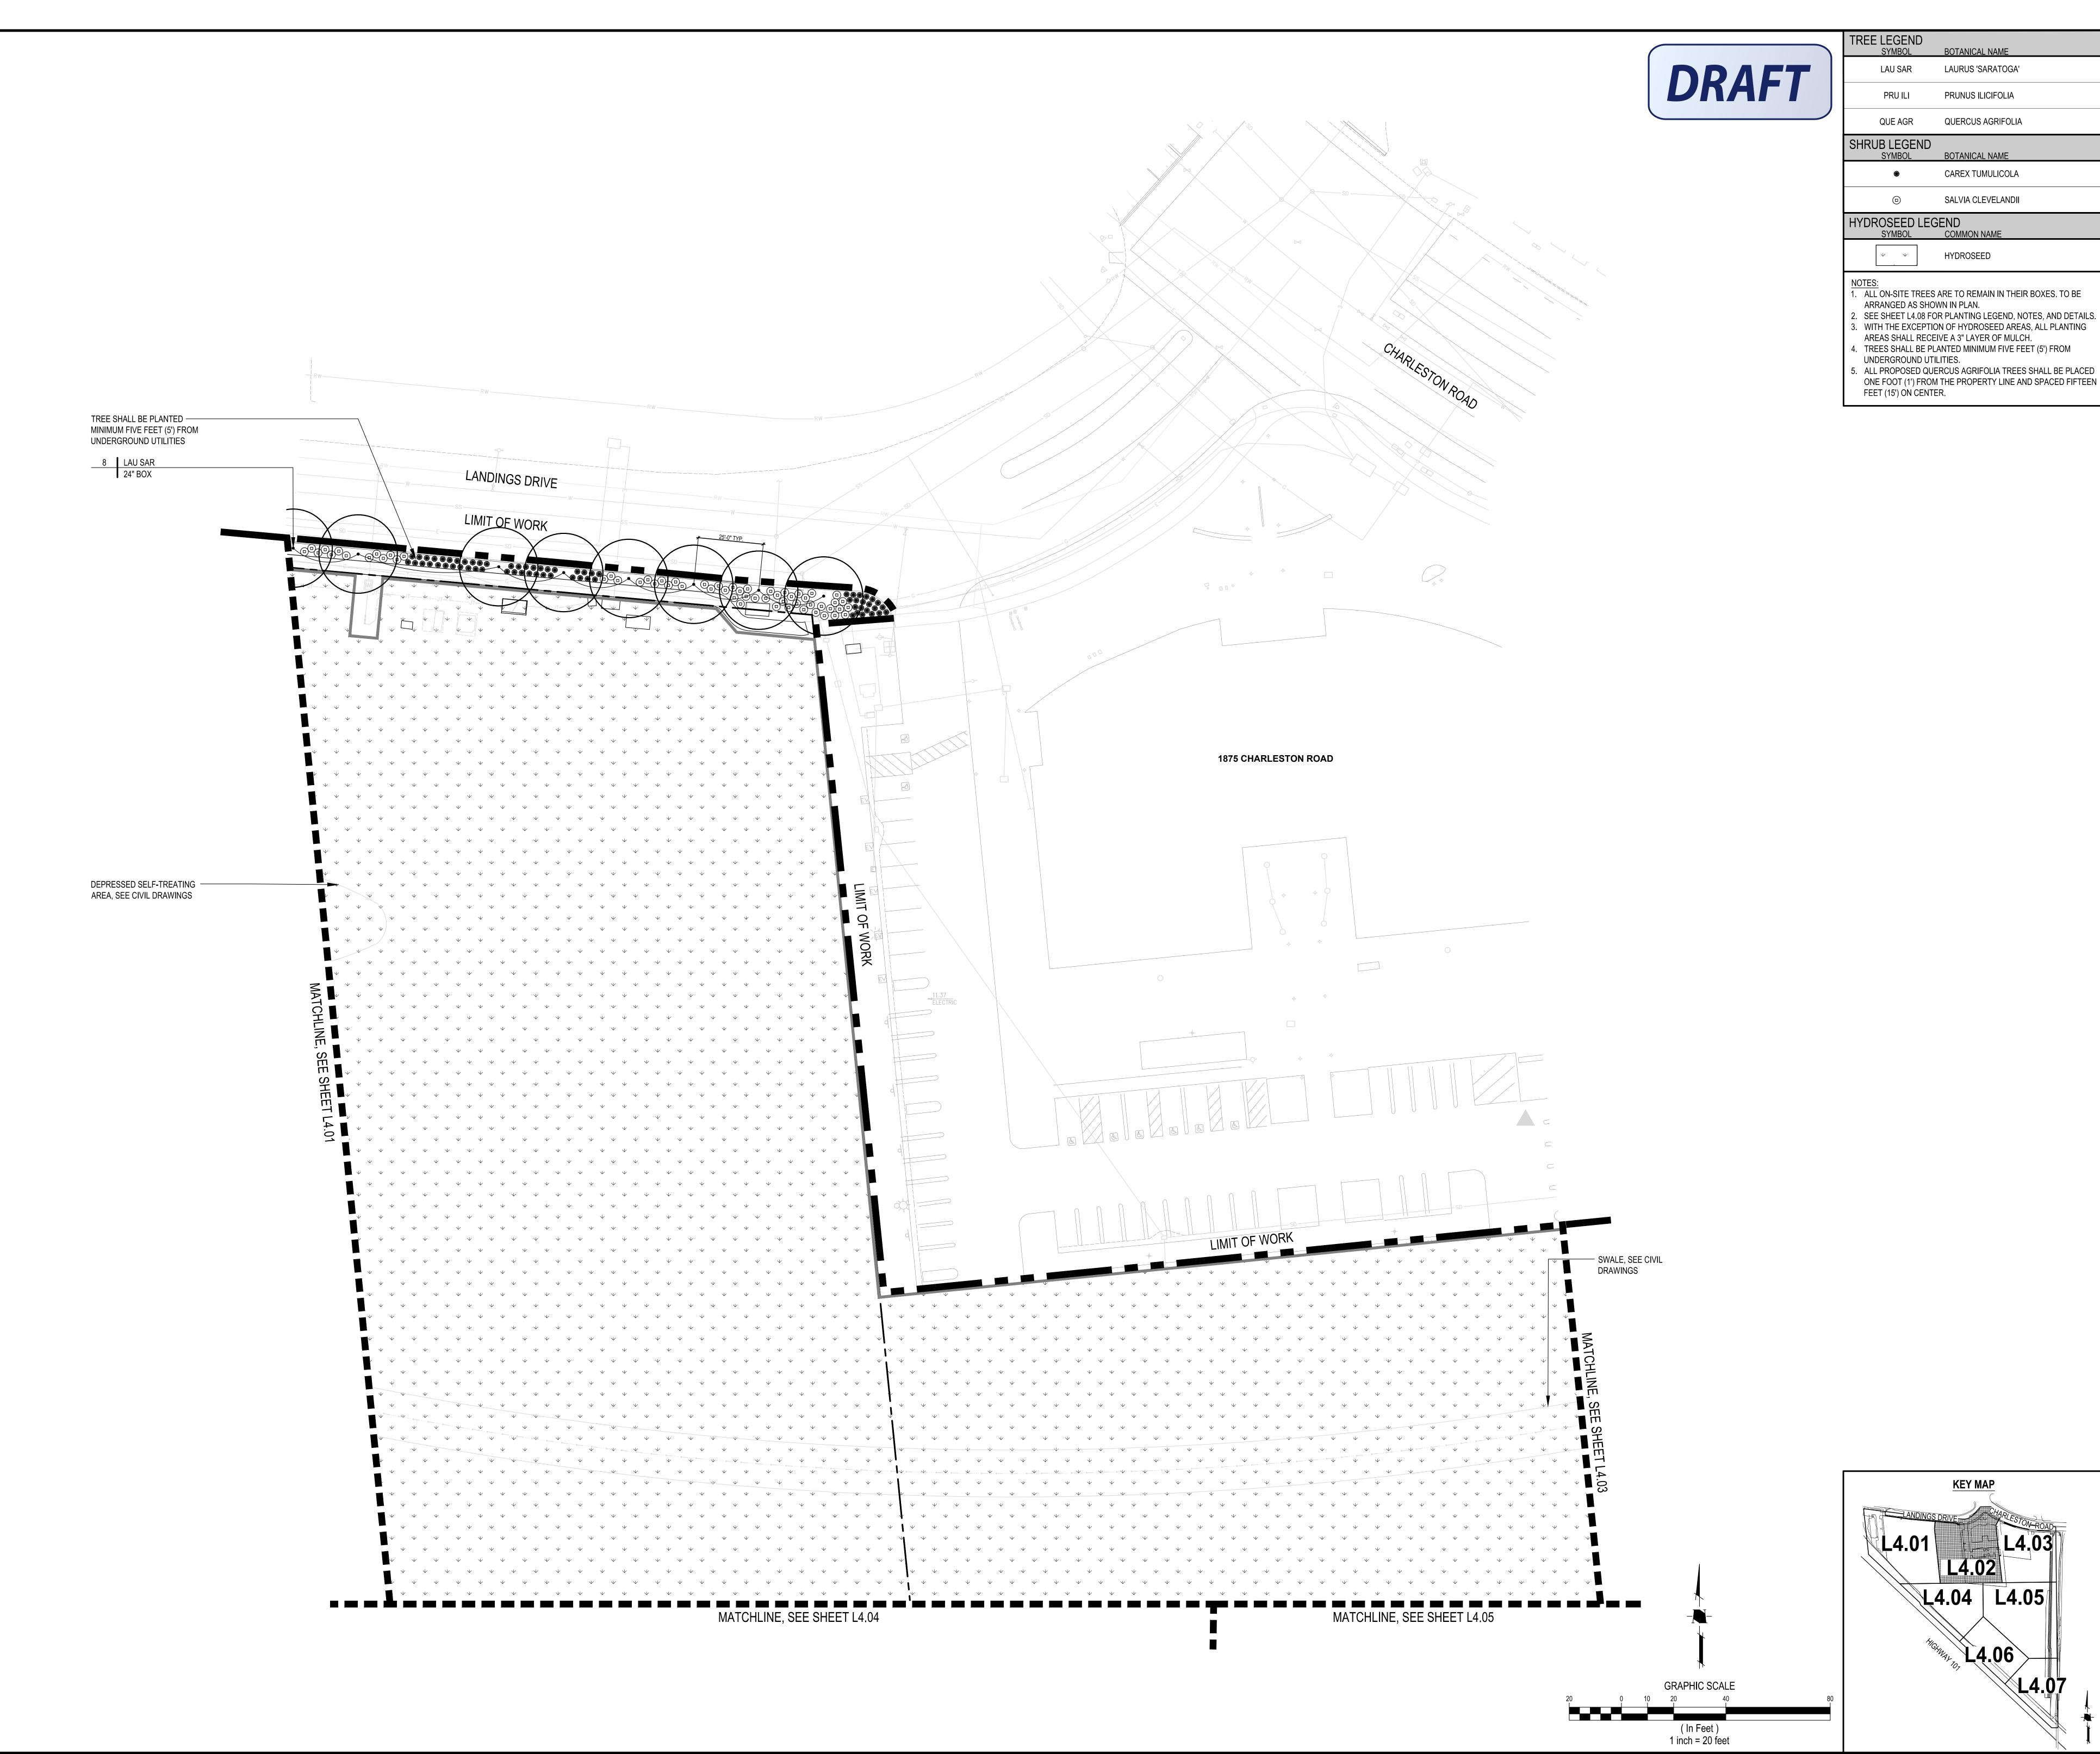
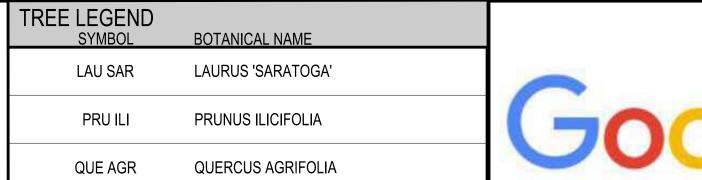
Exhibit A (Attachment 2)







CAREX TUMULICOLA

SALVIA CLEVELANDII

HYDROSEED

Land Use Entitlements Land Planning Landscape Architecture Civil Engineering Utililty Design Land Surveying Stormwater Compliance

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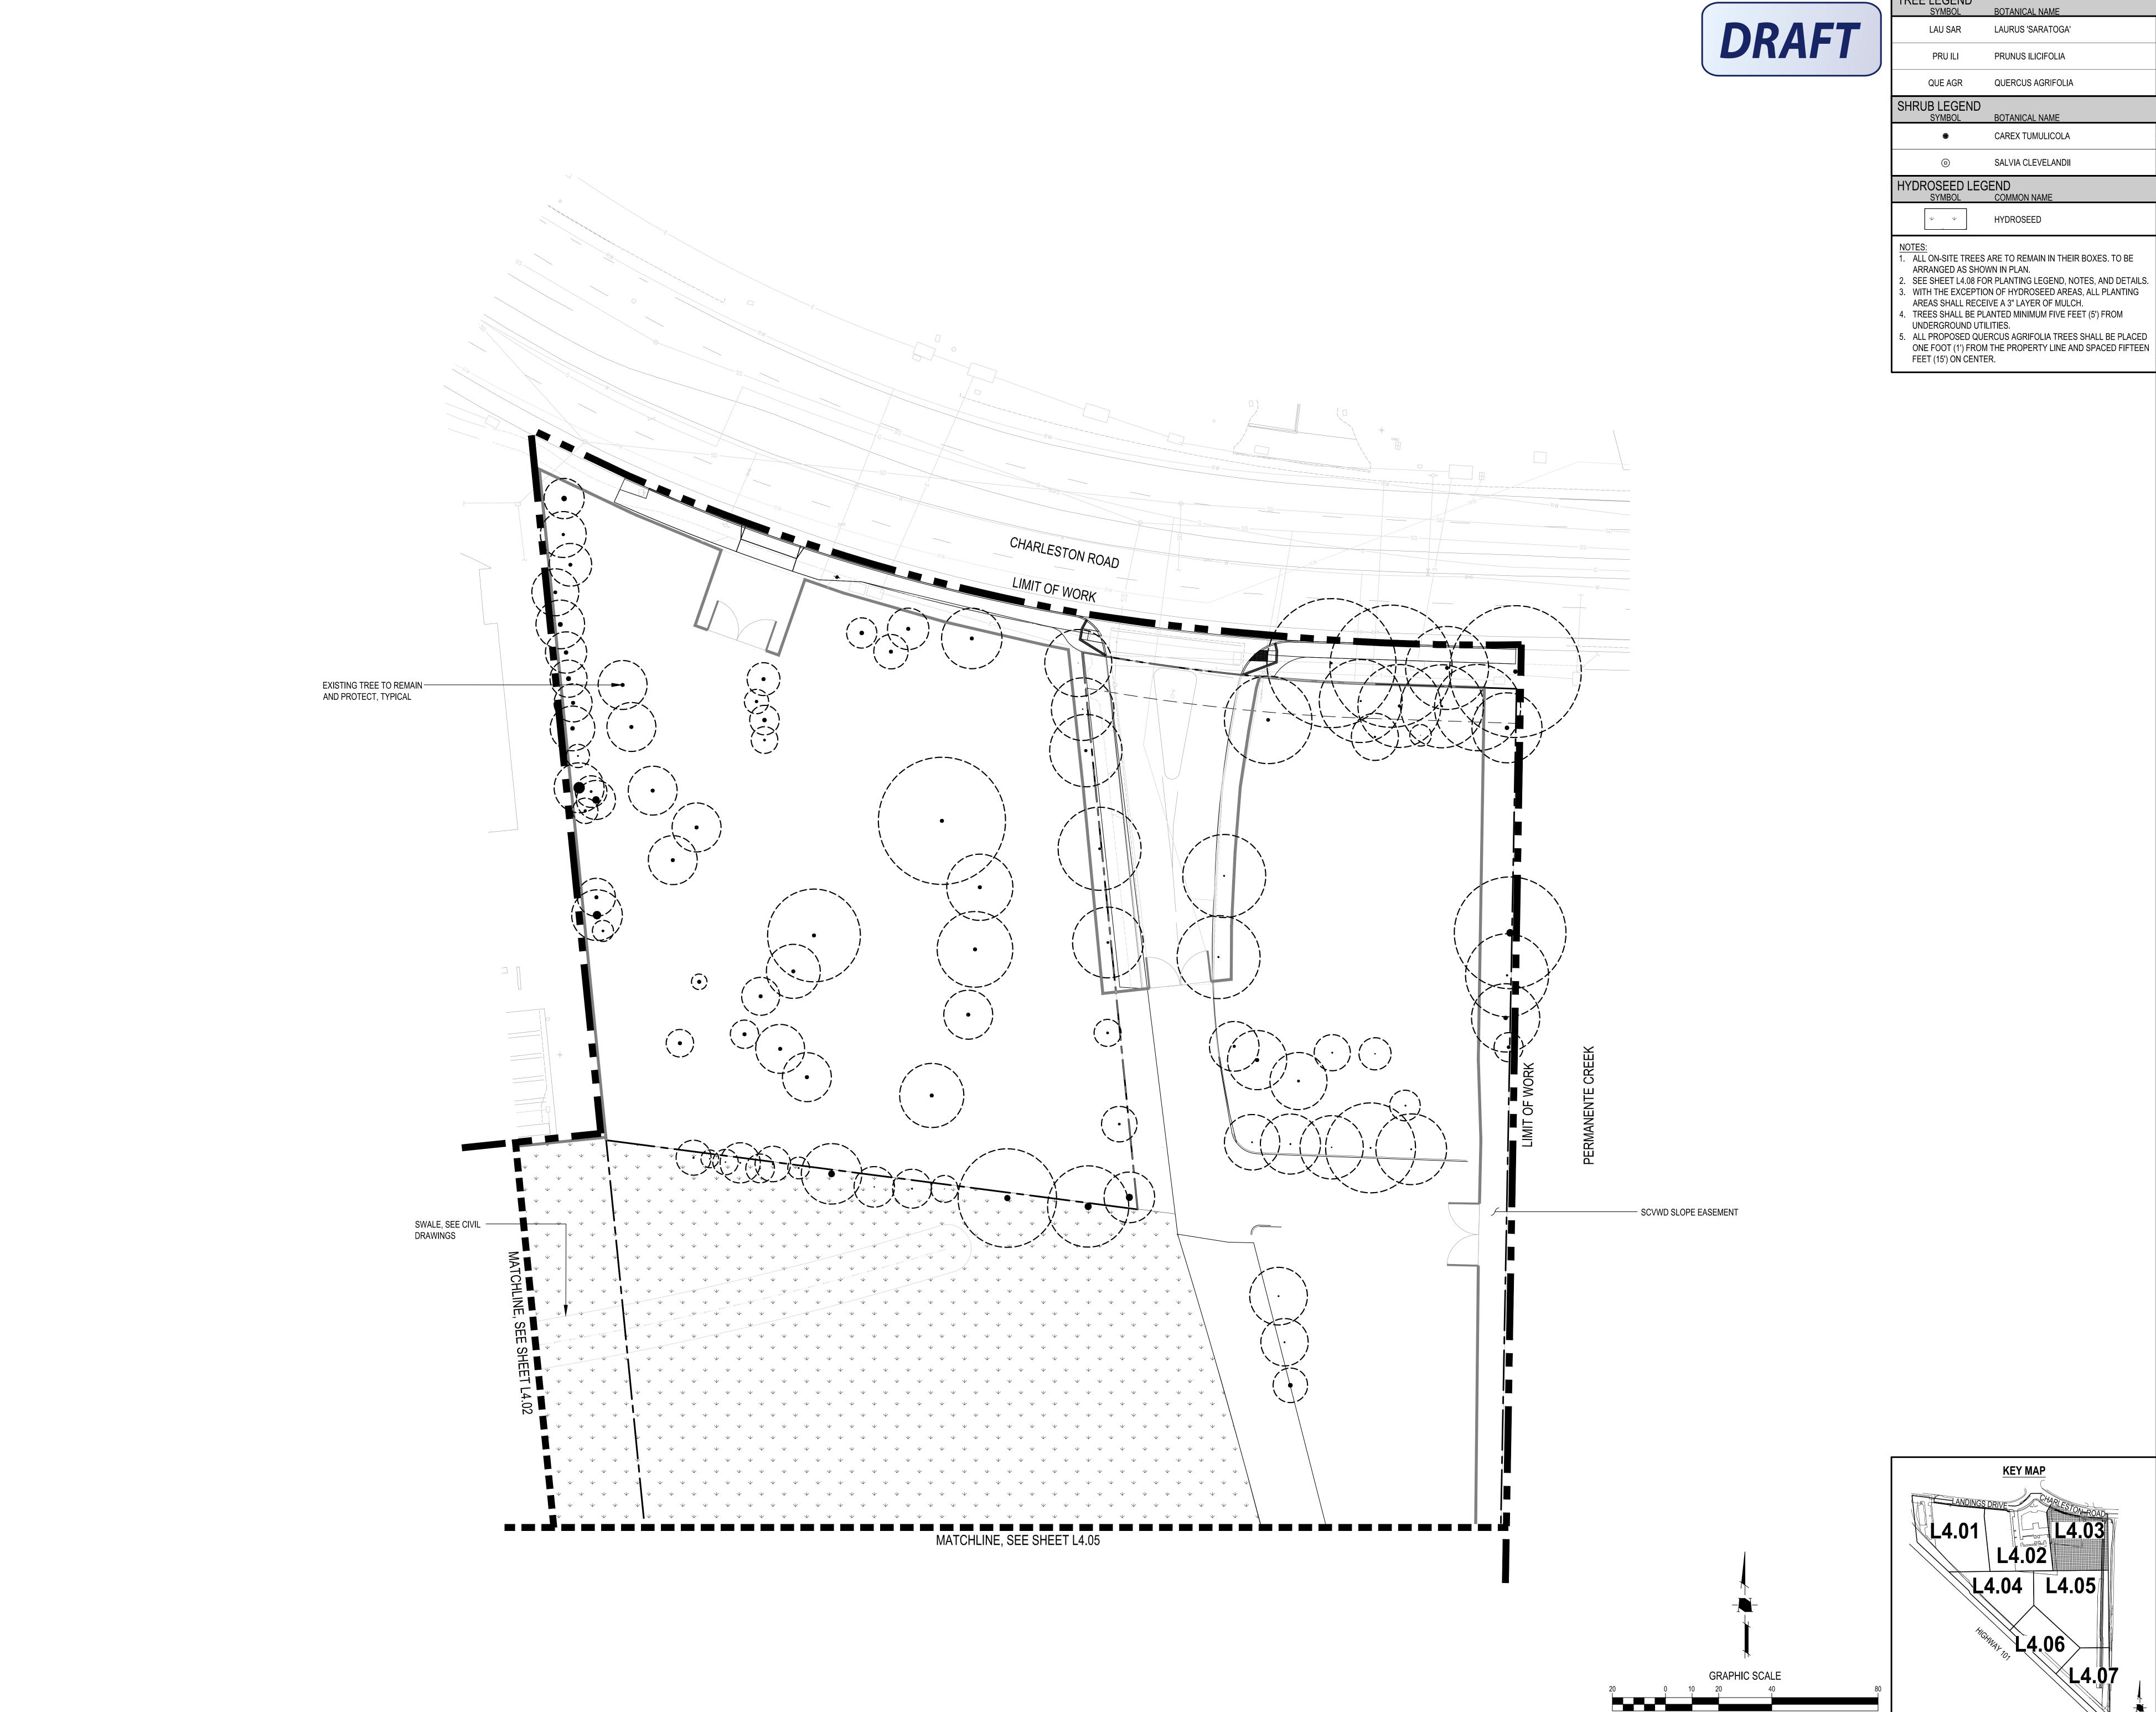
\triangle	7/15/25	GOOGLE TREE MITIGATION AGREEMENT EXHIBIT
\triangle	5/21/25	BUILDING DEPARTMENT COMMENTS
	3/18/25	PLANNING DEPARTMENT COMMENTS
	2/21/25	BUILDING DEPARTMENT COMMENTS
	2/21/25	PLANNING DEPARTMENT COMMENTS
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	11/18/24	PLANNING DEPARTMENT COMMENTS
\triangle	8/23/24	ISSUE FOR PERMIT
\triangle	8/2/24	PLANNING DEPARTMENT COMMENTS
NO	DATE	DESCRIPTION
PR	OJECT NO:	6869.00
CAI	D DWG FILE	7. 686900PAC.DWG

CHECKED BY: SCALE:

DESIGNED BY:

DRAWN BY:

EXHIBIT A GOOGLE LANDINGS PLANTING PLAN -**PLANTING PLAN**





CAREX TUMULICOLA

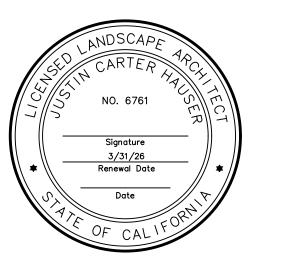
SALVIA CLEVELANDII

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NO	8/2/24 DATE	PLANNING DEPARTMENT COMMENTS DESCRIPTION
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\wedge		
	8/23/24	ISSUE FOR PERMIT
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\triangle	5/21/25	BUILDING DEPARTMENT COMMENTS
\triangle	7/15/25	GOOGLE TREE MITIGATION AGREEMENT EXHIBIT

7. 686900PAC.DWG DESIGNED BY: DRAWN BY: CHECKED BY:

EXHIBIT A GOOGLE LANDINGS PLANTING PLAN -PLANTING PLAN

L4.04 L4.05



MATCHLINE, SEE SHEET L4.02

7 PRU ILI 36" BOX

8 QUE AGR 36" BOX

TREE LEGEND SYMBOL	BOTANICAL NAME
LAU SAR	LAURUS 'SARATOGA'
PRU ILI	PRUNUS ILICIFOLIA
QUE AGR	QUERCUS AGRIFOLIA
0110110 1 50510	

SHRUB LEGEND
SYMBOL BOTANICAL NAME

CAREX TUMULICOLA

SALVIA CLEVELANDII HYDROSEED LEGEND SYMBOL COMMON NAME

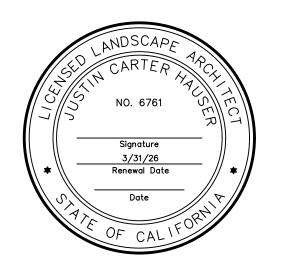
HYDROSEED

1. ALL ON-SITE TREES ARE TO REMAIN IN THEIR BOXES. TO BE ARRANGED AS SHOWN IN PLAN.

- 2. SEE SHEET L4.08 FOR PLANTING LEGEND, NOTES, AND DETAILS. B. WITH THE EXCEPTION OF HYDROSEED AREAS, ALL PLANTING AREAS SHALL RECEIVE A 3" LAYER OF MULCH. I. TREES SHALL BE PLANTED MINIMUM FIVE FEET (5') FROM
- UNDERGROUND UTILITIES. 5. ALL PROPOSED QUERCUS AGRIFOLIA TREES SHALL BE PLACED ONE FOOT (1') FROM THE PROPERTY LINE AND SPACED FIFTEEN FEET (15') ON CENTER.



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	5/21/25	BUILDING DEPARTMENT COMMENTS
	7/15/25	GOOGLE TREE MITIGATION AGREEMENT EXHIBIT

ROJECT NO.	0009.00
AD DWG FILE:	7. 686900PAC.DWG
ESIGNED BY:	JW
PRAWN BY:	JW
CHECKED BY:	JH
ATE:	JULY 15, 2025
CALE:	1" = 20'

EXHIBIT A GOOGLE LANDINGS PLANTING PLAN -

PLANTING PLAN

L4.01

(In Feet) 1 inch = 20 feet

SEE CIVIL DRAWINGS

PROPOSED QUERCUS AGRIFOLIA — TREE BOX EDGE TO BE PLACED

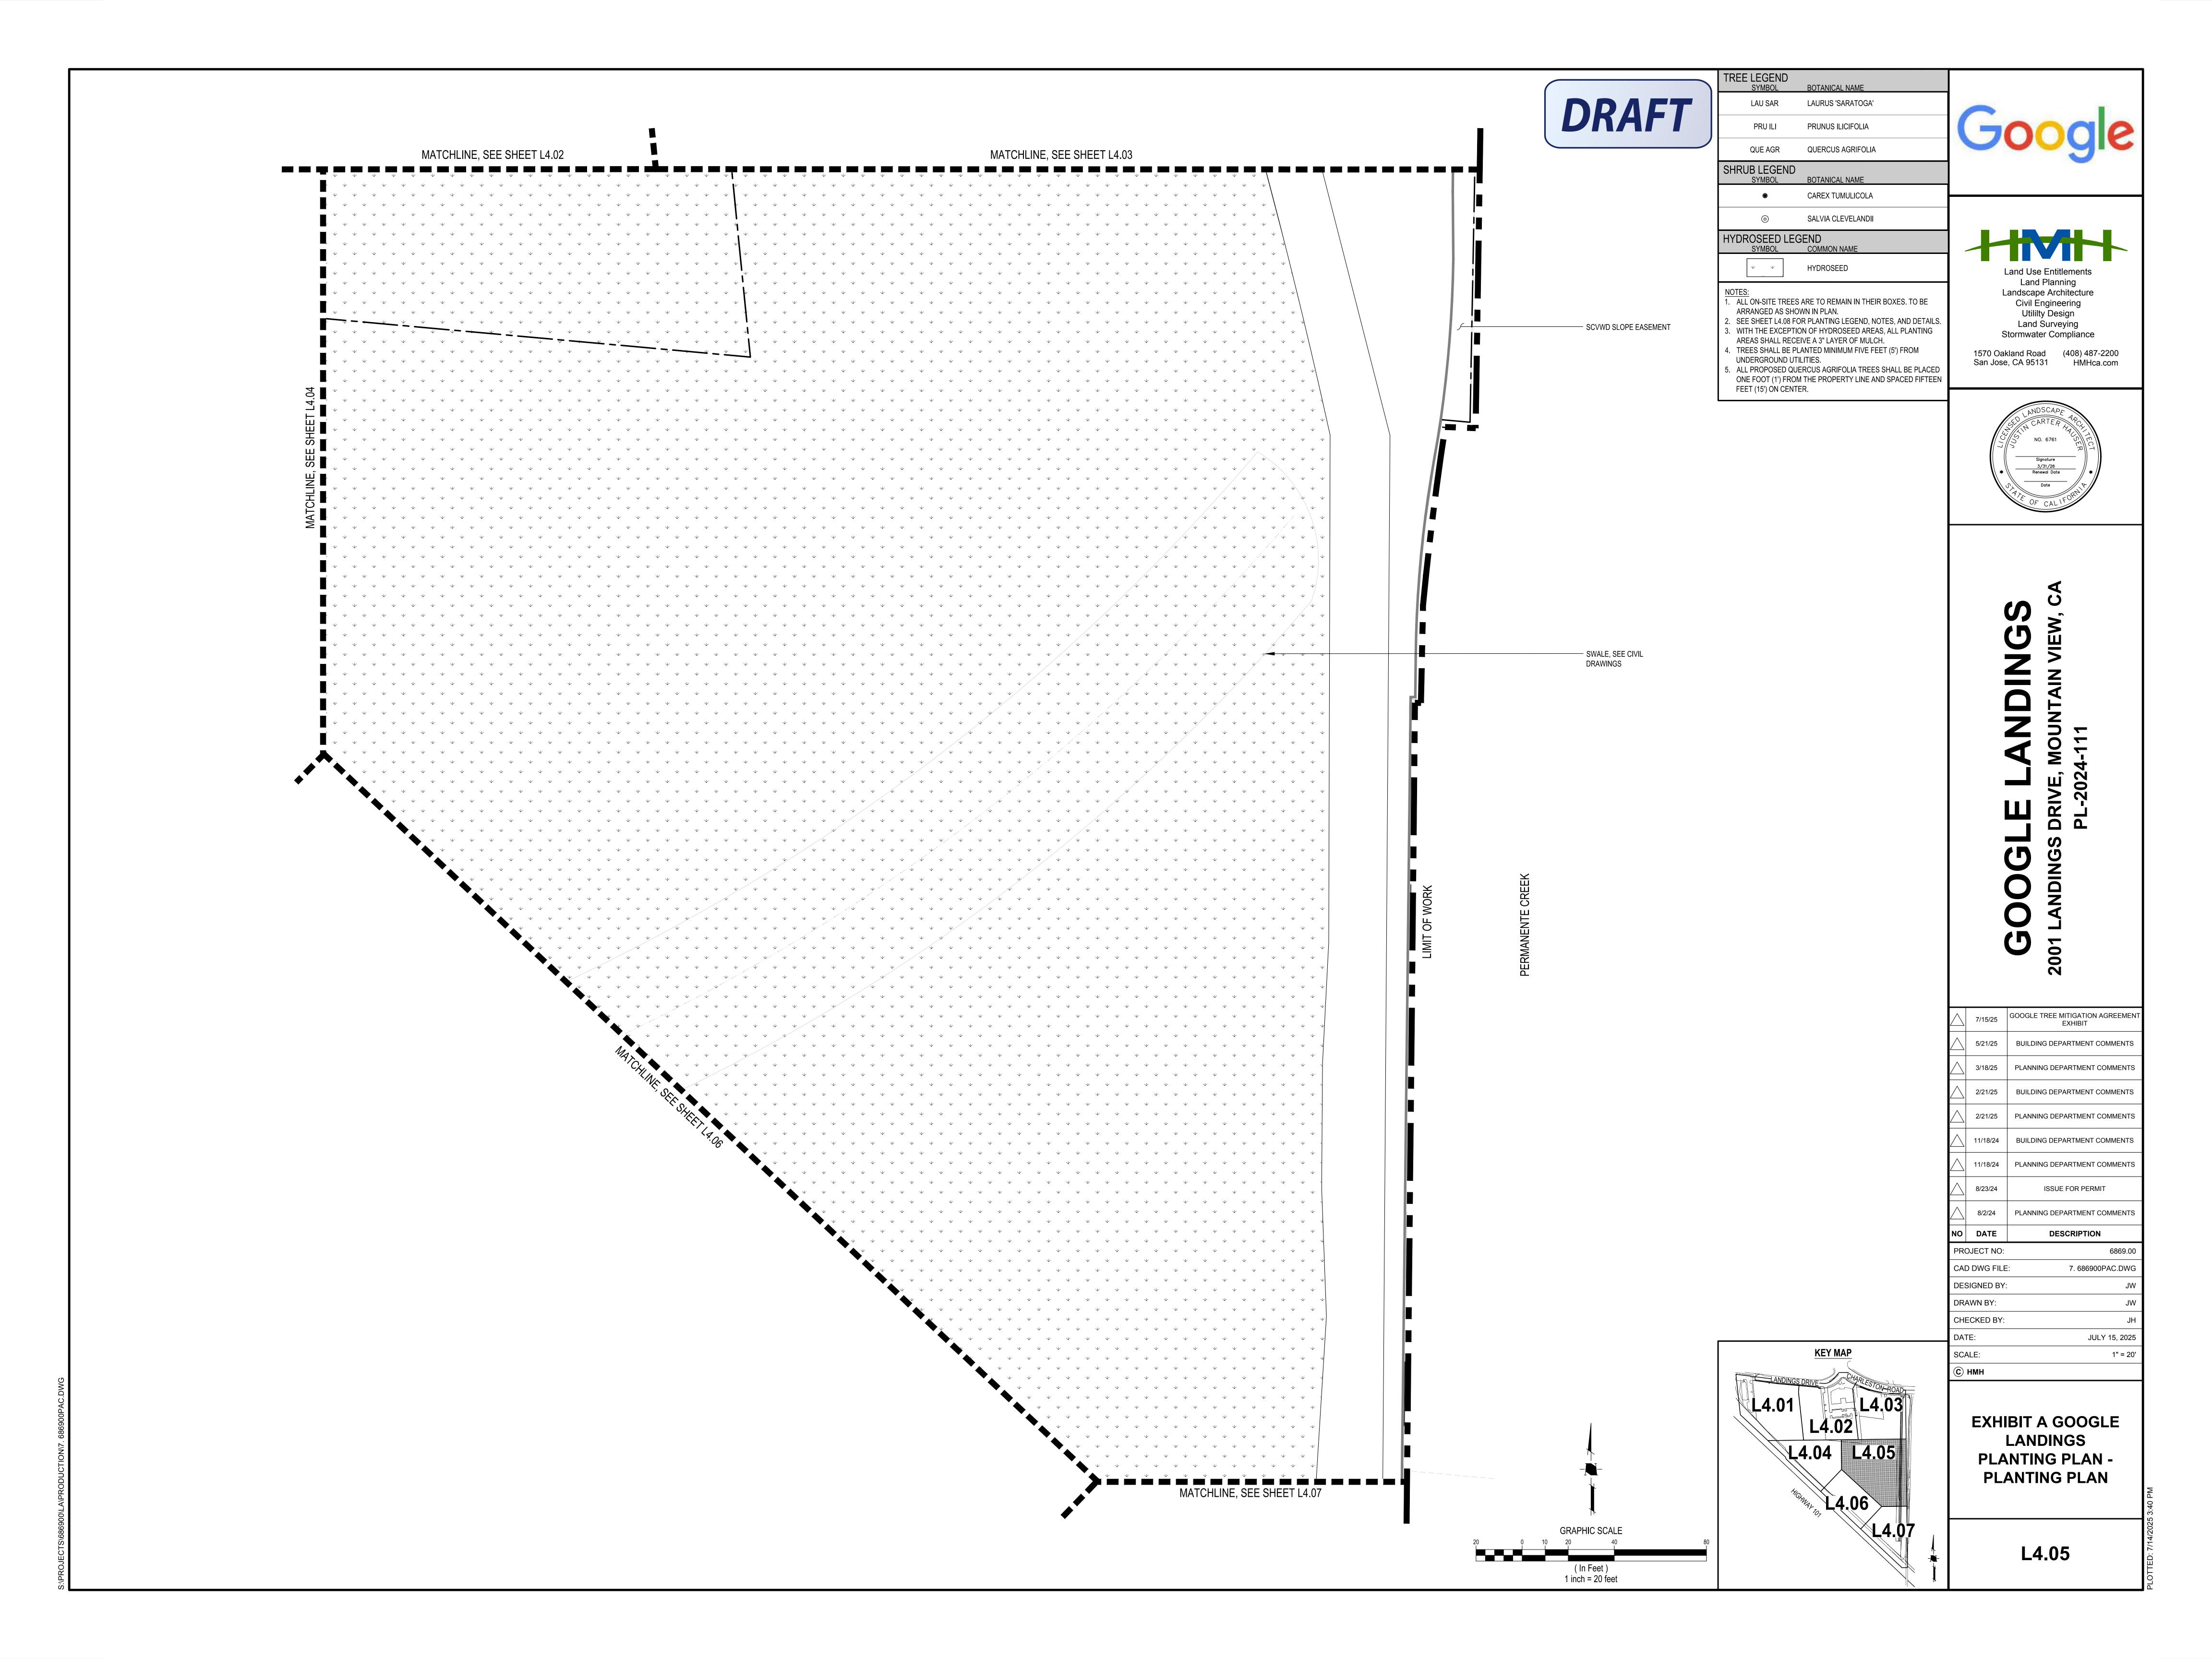
ONE (1) FEET FROM PROPERTY LINE, TYPICAL

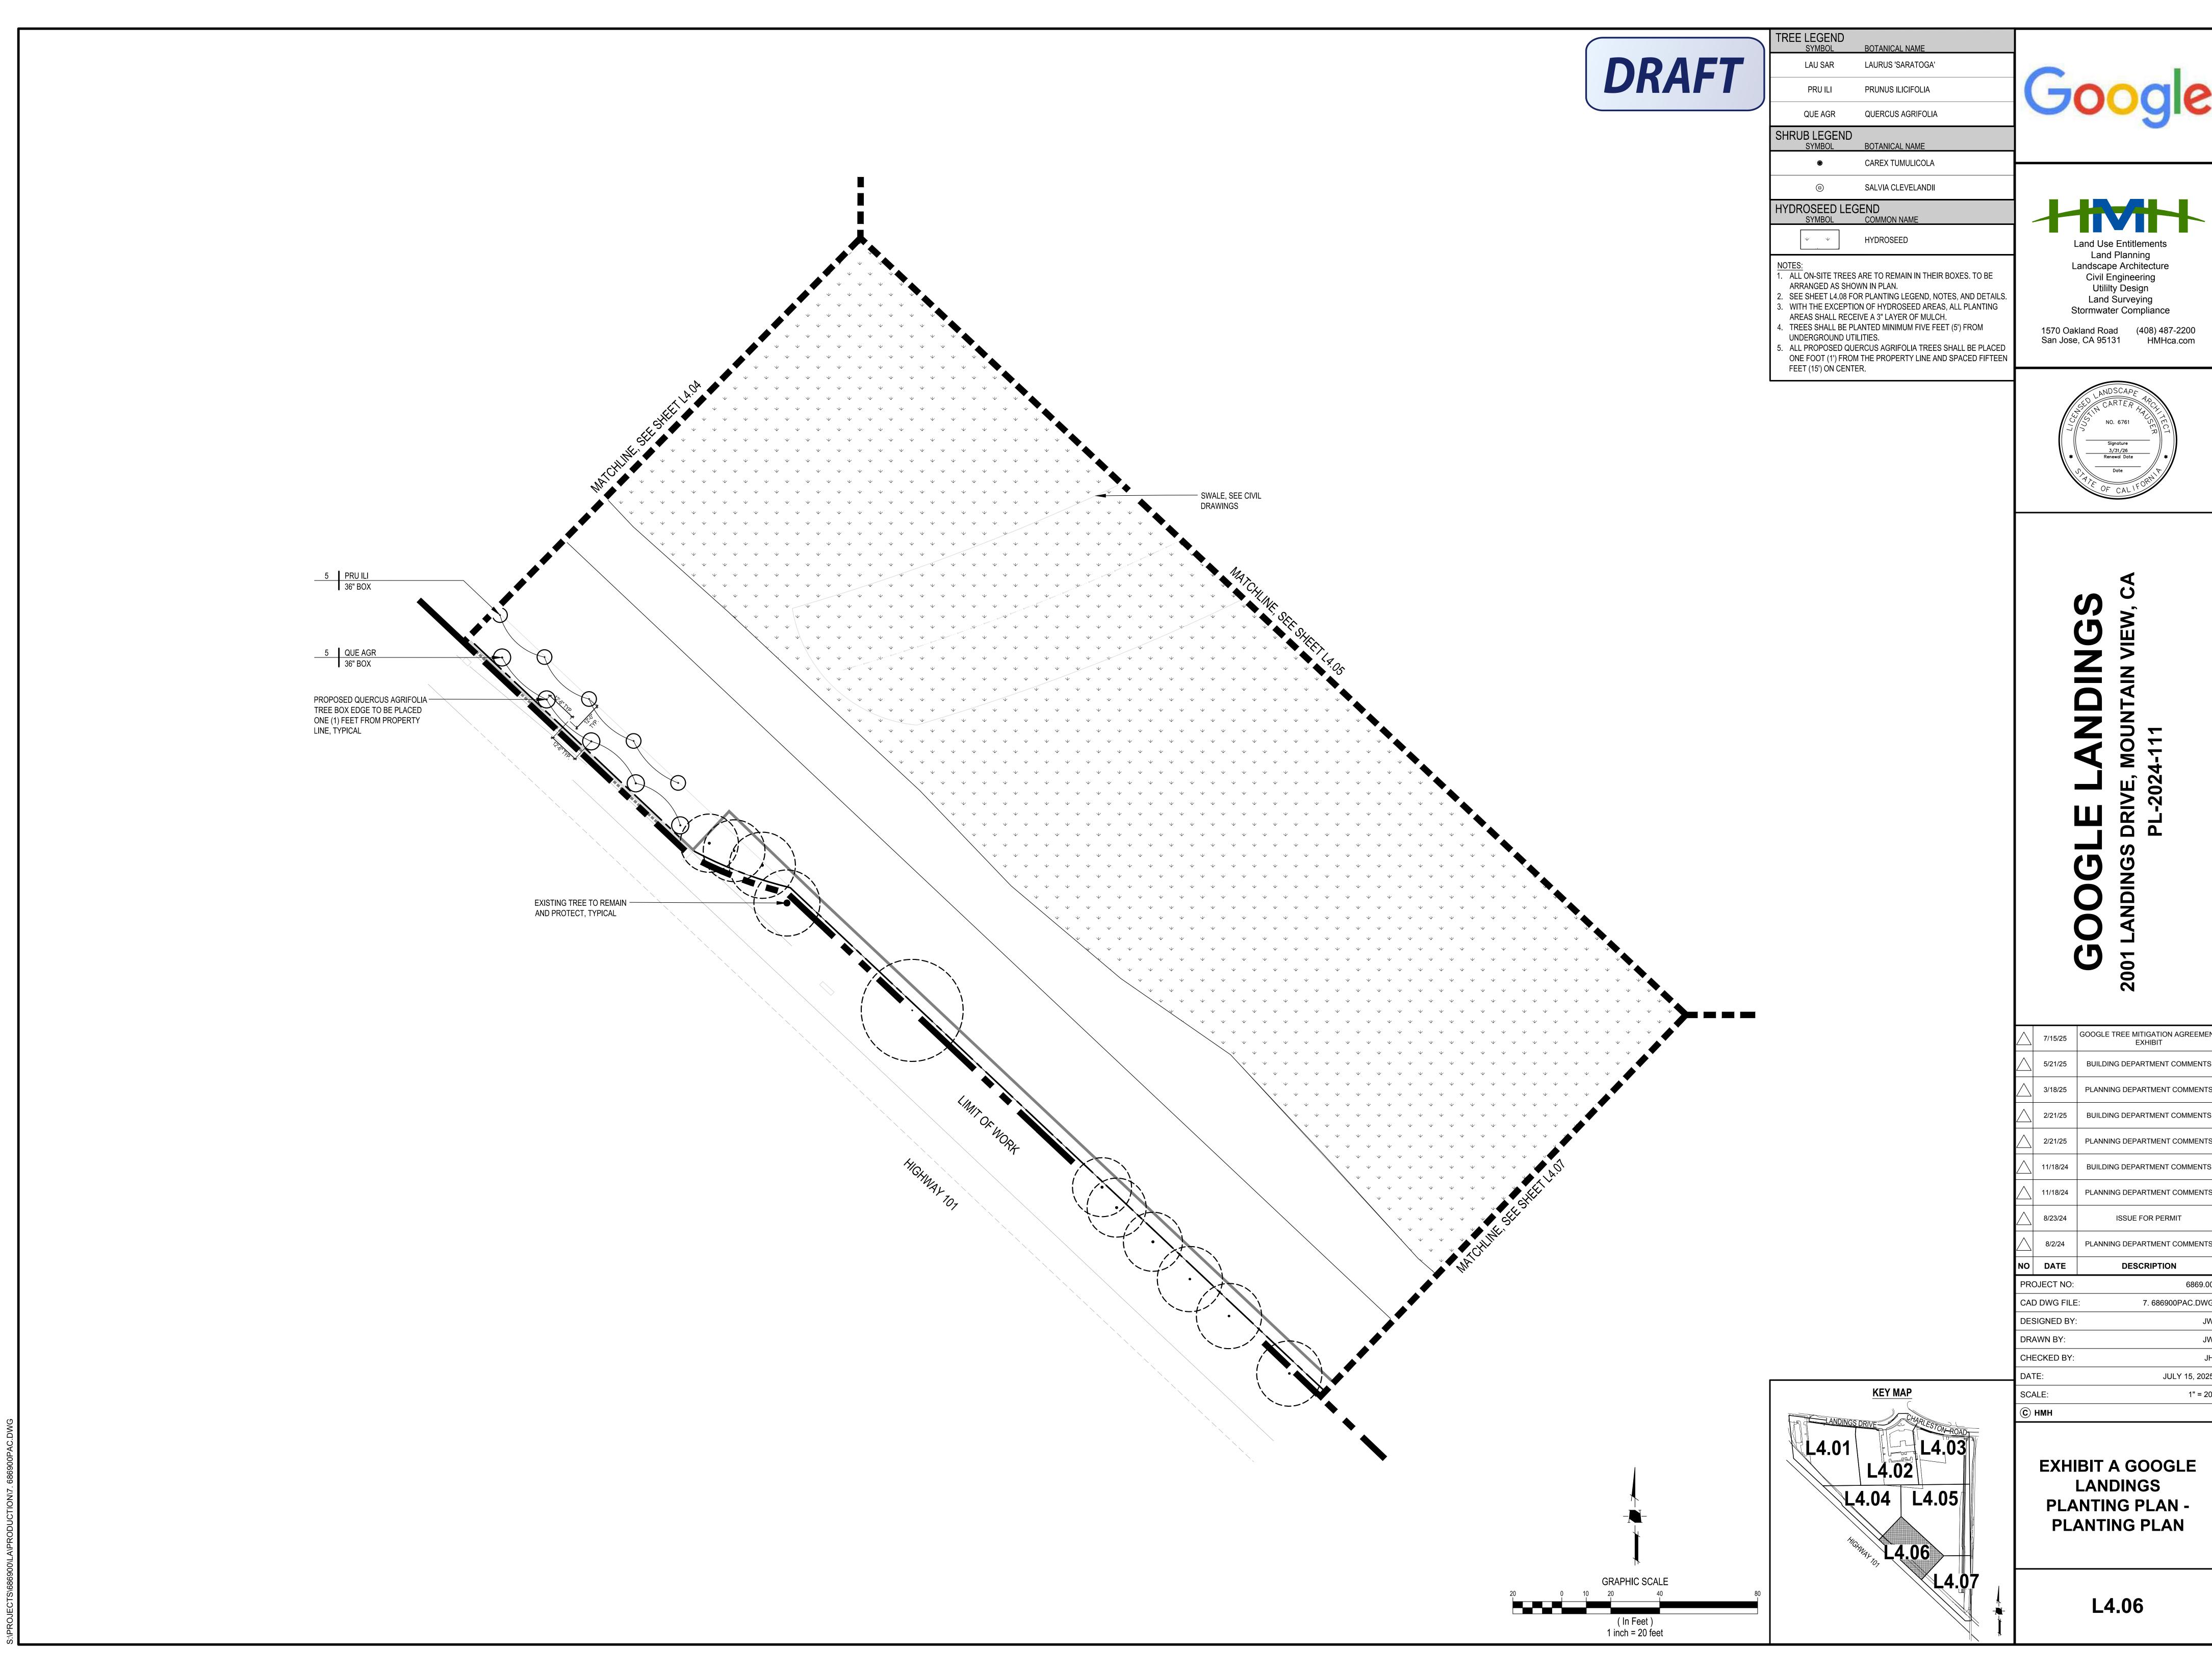
MATCHLINE, SEE SHEET L4.01

PLACEMENT OF TREE TO $\overline{}$ PRIORITIZE TEN FEET (10') OF CLEAR SPACE BETWEEN TREE CANOPY AND EXISTING PG&E POWER TRANSMISSION POLE OVER SPACING BETWEEN

EXISTING PG&E POWER -TRANSMISSION POLE

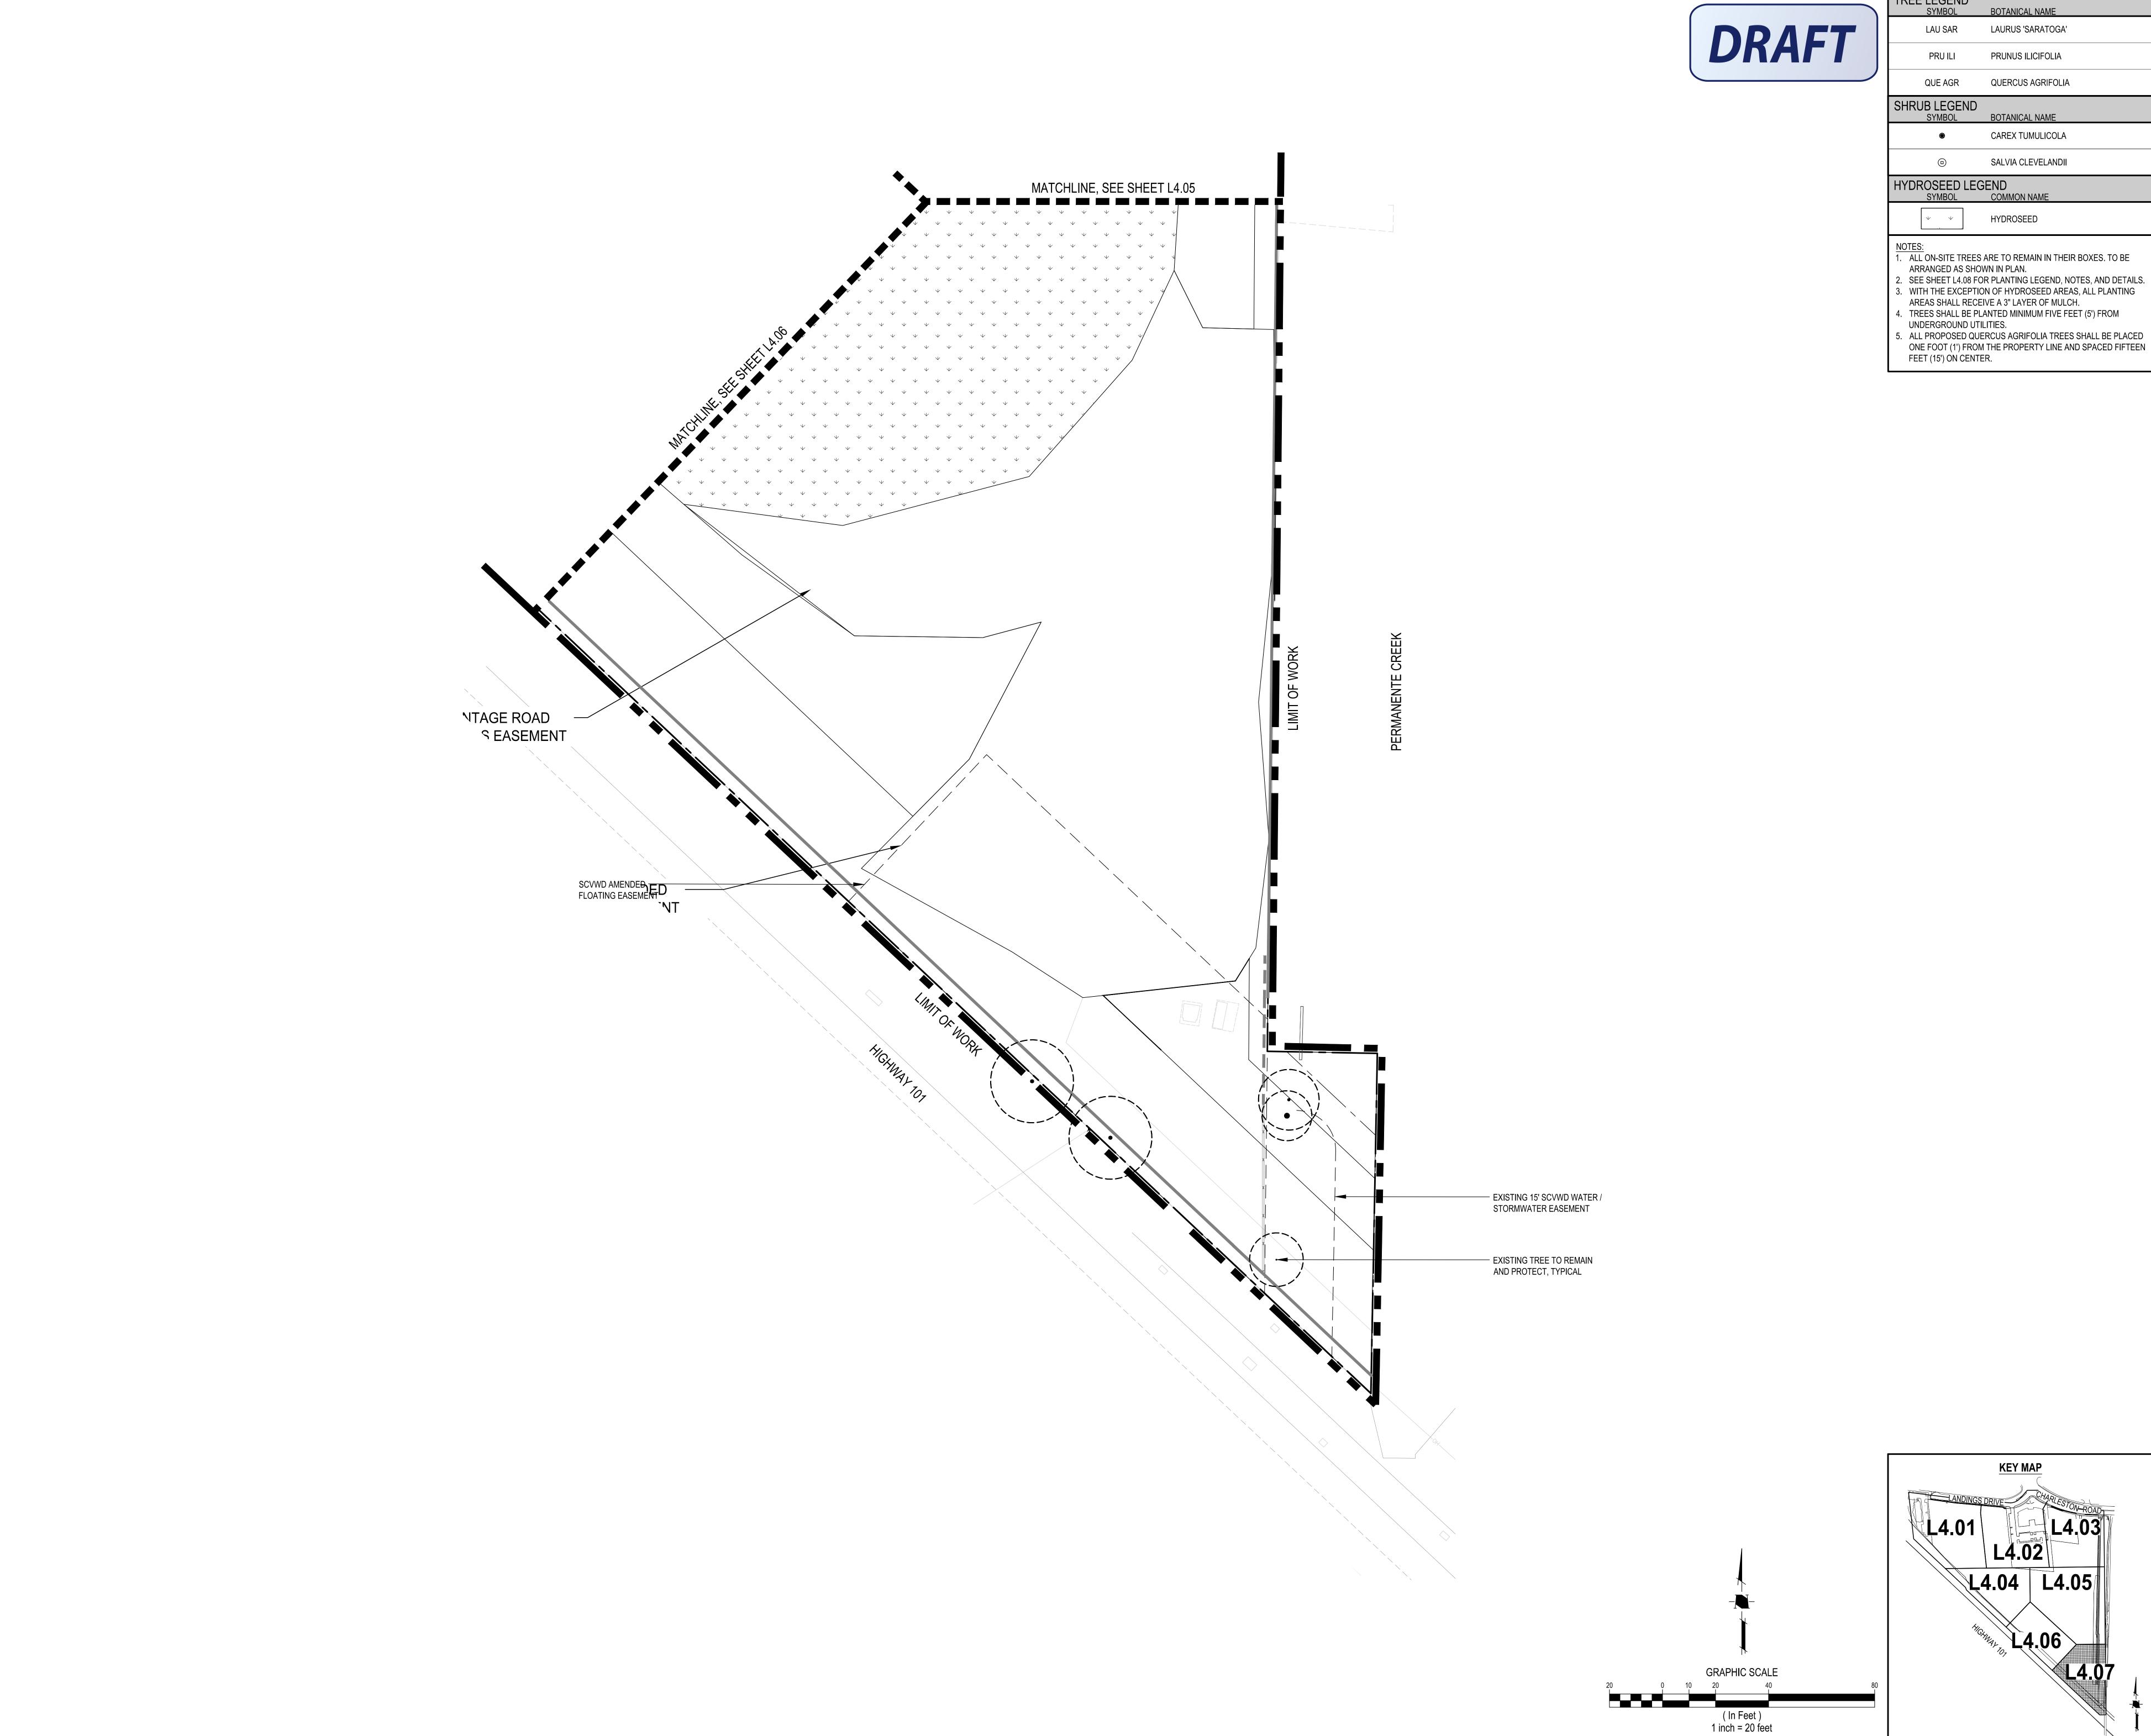
MAINTAIN TEN FEET (10') OF CLEAR SPACE BETWEEN PROPOSED MATURE TREE CANOPIES AND THE POLE





NO	DATE	DESCRIPTION
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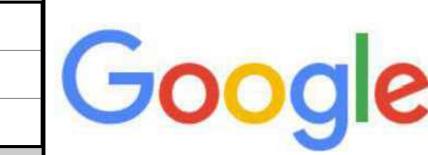
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DES	SIGNED BY:	JW
DRA	AWN BY:	JW
CHI	ECKED BY:	JH
DA	ΓE:	JULY 15, 2025
SCA	ALE:	1" = 20'
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TREE LEGEND SYMBOL	BOTANICAL NAME
LAU SAR	LAURUS 'SARATOGA'
PRU ILI	PRUNUS ILICIFOLIA
QUE AGR	QUERCUS AGRIFOLIA
SHRUB LEGEND SYMBOL	BOTANICAL NAME
•	CAREX TUMULICOLA

SALVIA CLEVELANDII

HYDROSEED



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CHECKED BY:	JH
DATE:	JULY 15, 2025
SCALE:	1" = 20'
С нмн	

DESIGNED BY:

L4.04 L4.05

EXHIBIT A GOOGLE LANDINGS PLANTING PLAN -PLANTING PLAN

PLANTING NOTES

- 1. TO ALLOW PROPOSED TREES TO REACH THEIR MATURITY, EACH TREE SHALL HAVE THE FOLLOWING CUBIC FEET OF NON-COMPACTED SOIL: 700 CUBIC FEET FOR SMALL TREES, 1,400 CUBIC FEET FOR MEDIUM TREES, 2,100 CUBIC FEET FOR LARGE TREES.
- 2. ALL ORNAMENTAL PLANTING AREAS SHALL RECEIVE A 3" LAYER OF MULCH. CONTRACTOR SHALL PROVIDE SAMPLE OF PROPOSED BARK MULCH FOR APPROVAL. BARK MULCH SHALL BE LYNGSO SMALL FIR BARK (3/4" TO 1-1/2") OR APPROVED EQUAL.
- 3. ALL STORM WATER TREATMENT AREAS SHALL RECEIVE 3" OF COMPOSTED, NON-FLOATABLE MULCH.
- 4. TO MAXIMIZE DISPERSAL OF RUNOFF THROUGHOUT THE STORMWATER TREATMENT SYSTEMS, THE PROJECT WILL NOT LOCATE TREES WITHIN THE BASIN OR BANK PLANTING ZONES OF BIORETENTION AREAS, BUT RATHER ON THE UPLAND PLANTING ZONES OF BIORETENTION AREAS PER APPENDIX D OF THE SCVURPPP C.3 STORMWATER HANDBOOK, TREES WILL ALSO NOT BE LOCATED DIRECTLY IN LINE WITH OR NEXT TO STORMWATER INLETS (CURBS, OPENINGS, DOWNSPOUTS, CHANNEL/GRATES, ETC.).
- 5. CONTRACTOR SHALL PROVIDE ALL LABOR. MATERIALS. AND EQUIPMENT NECESSARY TO FURNISH AND INSTALL PLANT MATERIAL AS SHOWN ON THE DRAWINGS AND AS DESCRIBED IN THE SPECIFICATIONS.
- 6. UNLESS DESIGNATED ON THE DRAWINGS OTHERWISE, STRUCTURAL IMPROVEMENTS AND HARDSCAPE SHALL BE INSTALLED PRIOR TO PLANTING OPERATIONS.
- 7. PLANT LIST SIZES AND QUANTITIES SHALL BE USED AS A GUIDE ONLY. CONTRACTOR SHALL TAKEOFF AND VERIFY SIZES AND QUANTITIES BY PLAN CHECK.
- 8. A SOIL MANAGEMENT REPORT SHALL BE PROVIDED BY LANDSCAPE CONTRACTOR AND SOIL AMENDMENTS SHALL BE FOLLOWED PER THE REPORT. PHYSICAL COPIES OF THE SOIL MANAGEMENT REPORT SHALL BE PROVIDED TO THE CLIENT,

- PROJECT LANDSCAPE ARCHITECT AND LOCAL AGENCY AS REQUIRED. THE SOIL MANAGEMENT REPORT SHALL CONFORM TO STATE AB1881 WATER EFFICIENT LANDSCAPE ORDINANCE (WELO) OR LOCAL AGENCY ADOPTED WELO. CONTRACTOR SHALL OBTAIN A SOILS MANAGEMENT REPORT AFTER GRADING OPERATIONS AND PRIOR TO PLANT INSTALLATION.
- 9. SAMPLES OF FERTILIZERS, ORGANIC AMENDMENT, SOIL CONDITIONERS, AND SEED SHALL BE SUBMITTED PRIOR TO INCORPORATION. CONTRACTOR SHALL FURNISH TO THE OWNER'S AUTHORIZED REPRESENTATIVE A CERTIFICATE OF COMPLIANCE FOR SUCH FURNISHED MATERIALS.
- 10. ALL WORK ON THE IRRIGATION SYSTEM, INCLUDING HYDROSTATIC, COVERAGE, AND OPERATIONAL TESTS AND THE BACKFILLING AND COMPACTION OF TRENCHES SHALL BE PERFORMED PRIOR TO PLANTING OPERATIONS.
- 11. LOCATIONS OF PLANT MATERIAL SHALL BE REVIEWED ON SITE BY THE OWNER'S AUTHORIZED REPRESENTATIVE PRIOR TO INSTALLATION.
- 12. TREES SHALL BE PLANTED MINIMUM FIVE FEET (5') FROM UNDERGROUND UTILITIES.
- 13. TREES PLANTED WITHIN FIVE FEET (5') OF HARDSCAPE OR STRUCTURES SHALL BE INSTALLED WITH A ROOT BARRIER AS APPROVED BY THE OWNER'S AUTHORIZED REPRESENTATIVE.
- 14. CONTRACTOR MUST CONTACT THE CITY ARBORIST TO VERIFY SPECIES (EVEN IF SHOWN ON THE PLANS), LOCATIONS, AND QUANTITIES OF ALL STREET TREES PRIOR TO ORDERING MATERIAL. IF STREET TREES ARE TO BE PLANTED IN TREE WELLS, FINAL LOCATION OF TREE WELLS SHALL BE DETERMINED BY THE ARBORIST PRIOR TO INSTALLATION OF SIDEWALK.
- 15. ALL PLANT MATERIAL SHALL BE SELECTED IN ACCORDANCE WITH THE AMERICAN STANDARD FOR NURSERY STOCK (ANSI
- 16. FOR STANDARD FORM TREES, CALIPER SIZE SHALL BE

- MEASURED 6" ABOVE THE SOIL LINE FOR CALIPERS EQUAL TO OR LESS THAN 4" FOR CALIPERS GREATER THAN 4", CALIPER SHALL BE MEASURES 12" ABOVE THE SOIL LINE. FOR MULTI-TRUNK TREES THE CALIPER SHALL BE ESTABLISHED BY TAKING THE AVERAGE OF THE CALIPER OF THE TWO LARGEST TRUNKS. CALIPER IS MEASURED 6" ABOVE ORIGINATION POINT OF THE SECOND LARGEST TRUNK OR 6" ABOVE GROUND IF ALL TRUNKS ORIGINATE FROM THE SOIL.
- 17. FOR SOILS LESS THAN 6% ORGANIC MATTER IN THE TOP 6" OF SOIL, COMPOST AT A RATE OF A MINIMUM OF FOUR CUBIC YARDS PER 1,000 SQUARE FEET OF PERMEABLE AREA SHALL BE INCORPORATED TO A DEPTH OF 6" INTO THE SOIL.
- 18. CALIPER IS MEASURED 6" ABOVE ORIGINATION POINT OF THE SECOND LARGEST TRUNK OR 6" ABOVE GROUND IF ALL TRUNKS ORIGINATE FROM THE SOIL.
- CALIPER SIZES STANDARDS: 15 GALLON: 0.75-1.25" 24" BOX: 1.25-2" 36" BOX: 2-3.5" 48" BOX: 3.5-5" 60" BOX: 4-6"

(VL) VERY LOW: <0.1

- 19. WATER NEEDS CATEGORY BASED ON WUCOLS IV (JANUARY 2014) LANDSCAPE COEFFICIENT METHOD: PERCENTAGE OF ETo CATEGORY 0.7-0.9 (H) HIGH: (M) MEDIUM: 0.4-0.6 (L) LOW: 0.1-0.3
- 20. SITE CLEANLINESS: THE CONTRACTOR IS RESPONSIBLE TO KEEP THE SITE CLEAN FOR SOIL EROSION CONTROL MEASURES AND FOR ANY OTHER GENERAL REQUIREMENTS. SHOULD EXISTING CONDITIONS REQUIRE MITIGATION, THE CONTRACTOR SHALL ALERT THE OWNER OR LANDSCAPE ARCHITECT PRIOR TO PERFORMING WORK.
- 21. CERTIFICATE OF COMPLETION: A CERTIFICATE OF COMPLETION SHALL BE FILLED OUT AND CERTIFIED BY EITHER THE DESIGNER OF THE LANDSCAPE PLANS, IRRIGATION PLANS, OR LICENSED LANDSCAPE CONTRACTOR FOR THE PROJECT.

PLANTING LEGEND

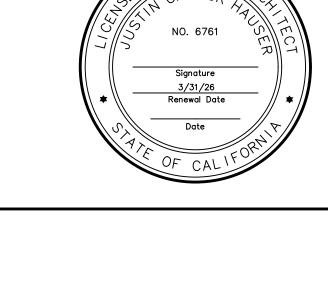
TREE LEGEND SYMBOL	QUANTITY	BOTANICAL NAME	COMMON NAME	MINIMUM CONTAINER SIZE	HxW	WUCOLS	CA NATIVE	NOTES
LAU SAR	14	LAURUS 'SARATOGA'	SARATOGA SWEET BAY	24" BOX	35' x 30'	L		
PRU ILI	33	PRUNUS ILICIFOLIA	HOLLYLEAF CHERRY	36" BOX	10' x 6'	L	√	NATURAL FORM. TREES ARE TO REMAIN IN THEIR BOXES
QUE AGR	34	QUERCUS AGRIFOLIA	COAST LIVE OAK	36" BOX	12' x 7'	L	√	NATURAL FORM. TREES ARE TO REMAIN IN THEIR BOXES
SHRUB LEGEND SYMBOL	QUANTITY	BOTANICAL NAME	COMMON NAME	MINIMUM CONTAINER SIZE	HxW	WUCOLS	CA NATIVE	NOTES
₩	124	CAREX TUMULICOLA	BERKELEY SEDGE	1 GALLON	2' x 2'	L	✓	
•	106	SALVIA CLEVELANDII	CLEVELAND SAGE	5 GALLON	3' x 3'	L	√	
HYDROSEED LEGEN	ND	BOTANICAL NAME	COMMON NAME	MINIMUM CONTAINER SIZE	HxW	WUCOLS	CA NATIVE	NOTES
\(\psi\) \(\psi\) \(\psi\)		ACHILLEA MILLEFOLIUM CLARKIA ELEGANS COLLINSIA HETEROPHYLLA ESCHSCHOLZIA CALIFORNICA GILIA CAPITATA LASTHENIA GLABRATA LAYIA PLATYGLOSSA LINUM LEWISII LUPINUS MICROCARPUS LUPINUS SUCCULENTUS NEMOPHILA MENZIESII PHACELIA CAMPANULARIA TRIPHYSARIA VERSICOLOR	WHITE YARROW ELEGANT CLARKIA CHINESE HOUSES CALIFORNIA POPPY GLOBE GILIA GOLDFIELDS TIDY TIPS BLUE FLAX ED GEDLING GOLDEN LUPII ARROYO LUPINE BABY BLUE EYES CALIFORNIA BLUE BELLS YELLOW OWL'S CLOVER	N/A	VARIES	L		HYDROSEED SHALL BE CALIFORNIA NATIVE WILDFLOWER MIX BY PACIFIC COAST SEED (925) 373-4417, INSTALL PER MANUFACTURER'S RECOMMENDATIONS ALL PLANTS IN THIS SECTION ARE CA NATIVE





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1 NATIVE GRADE

 $\langle 5 \rangle$ TREE

6 ROOT BALL

8 CINCH TIE

2 FOOT TAMP BASE

3 BACKFILL, PUDDLE AND

4 AGRIFORM PLANT TABLETS,

SETTLE PRIOR TO PLANTING

3 PER 15 GALLON, 6 PER 24"

BOX, AND 8 FOR 36" BOX

7 PINE LODGE POLE STAKE, 2" DIAMETER, PLACED ON WINDWARD SIDES OF TREE AND OUTSIDE OF ROOT BALL

9 2" DEEP BASIN AROUND

ROOT BALL, TREES PLANTED IN TURF SHALL NOT HAVE

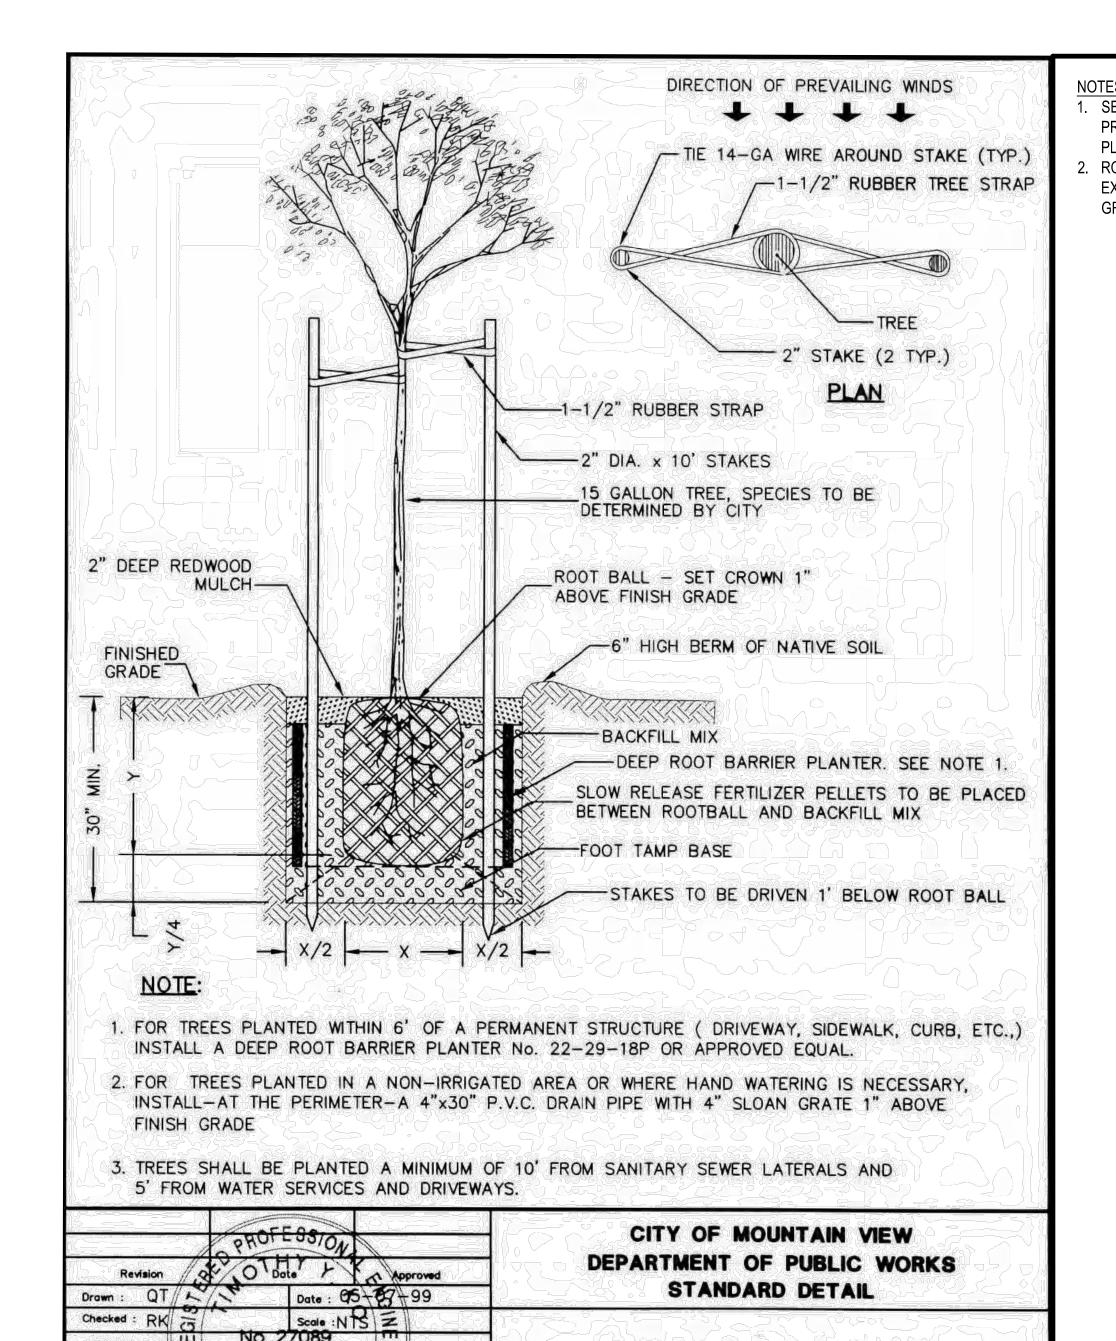


△ △ △ NO	11/18/24 8/23/24 8/2/24 DATE	PLANNING DEPARTMENT COMMENTS ISSUE FOR PERMIT PLANNING DEPARTMENT COMMENTS DESCRIPTION
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DESIGNED BY:		JW
DRAWN BY:		JW
CHECKED BY:		JH
DATE:		JULY 15, 2025
SCALE:		AS NOTED
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EXHIBIT A GOOGLE LANDINGS PLANTING PLAN -PLANTING PLAN LEGEND, NOTES, **AND DETAILS**

L4.08

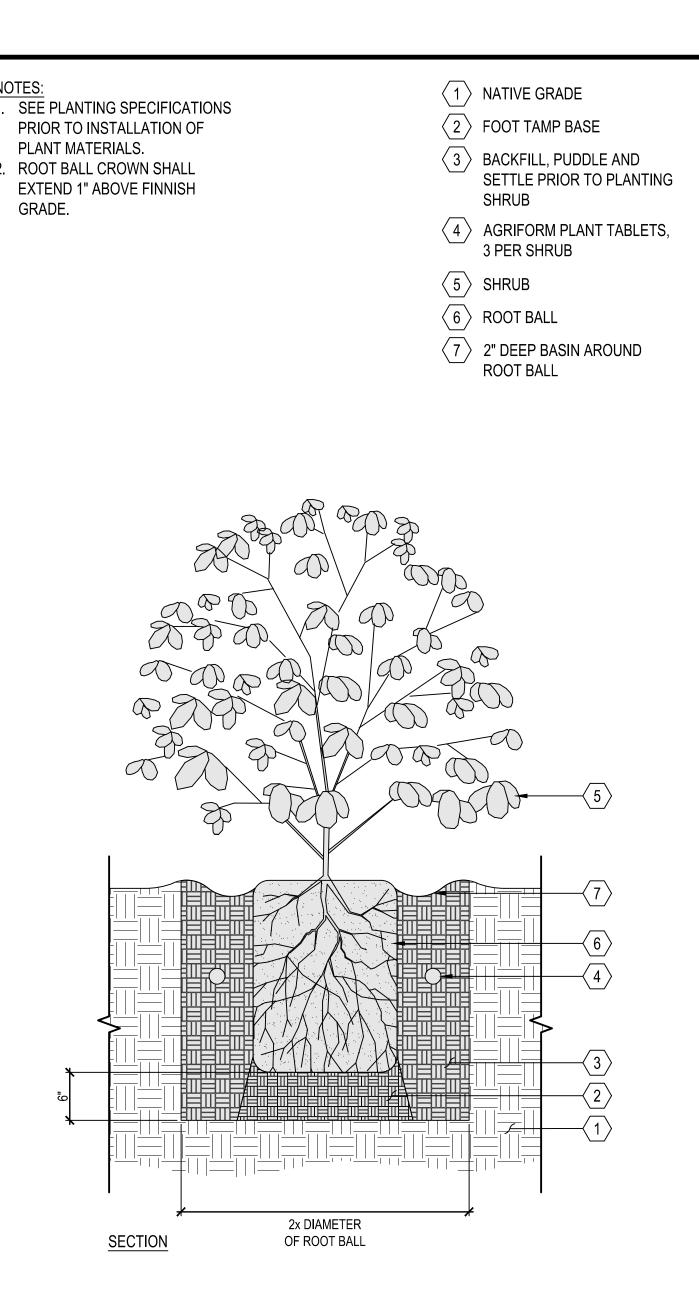


TREE PLANTING AND STAKING

(STREET TREES ONLY)

Caus No. - F-1

B SHRUB SCALE: 1" = 1'-0"



2x DIAMETER OF ROOT BALL

ON-SITE TREES

SCALE: 1" = 1'-0"

. SEE PLANTING SPECIFICATIONS

PRIOR TO INSTALLATION OF

. ROOT BALL CROWN SHALL

EXTEND 1" ABOVE FINNISH

. TREE INSTALLED IN TURF

AREAS SHALL BE INSTALLED

WITH 'ARBOR-GUARD' AT BASE

PLANT MATERIALS.

OF TRUNK.