



HYDRATION ROOM

PERMIT SET

555 SAN ANTONIO ROAD, SUITE # 39

MOUNTAIN VIEW, CA 94040

Architect:

Menemsha
SOLUTIONS

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Stamp:



Project Owner:



Project Address:

HYDRATION ROOM
555 SAN ANTONIO ROAD
SUITE #39
MOUNTAIN VIEW, CA 94040

CITY DATE AND APPROVAL STAMP

CITY DATE AND APPROVAL STAMP

PERMIT SET

Issue Date:

05.08.25

Revisions:

| NO. | DESCRIPTION | DATE |
|-----|-------------------------|----------|
| 1 | BUILDING DEPT. COMMENTS | 05.15.25 |
| 2 | BUILDING DEPT. COMMENTS | 06.26.25 |
| 3 | BUILDING DEPT. COMMENTS | 07.25.25 |

Principal in Charge:

Project Manager:
CARLOS VILLEGAS

Drawn By:

AEC

Project Number 27998

Sheet Title:

COVER SHEET

Sheet Number:

T001

PROJECT DIRECTORY

OWNER / TENANT

COMPANY: HYDRATION ROOM
CONTACT: SHAUN HAYWARD, VICE PRESIDENT, OPERATIONS AND NEW STORES
ADDRESS:

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LANDLORD

CONTACT: CARMELO S.
PHONE: 650-556-6143

SURVEYOR / ARCHITECT:

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PROJECT COORDINATOR

COMPANY: MENEMSHA
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TORRANCE, CA, 90503

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MEP ENGINEER

COMPANY: NEARBY ENGINEERS
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ADDRESS: 382 NE 191st St, SUITE 49674
MIAMI, FL 33179.

PHONE: (646) 878-9217
EMAIL: sanket@ny-engineers.com

PROJECT SCOPE / DATA

EXISTING OCCUPANCY / CLASSIFICATION: (B) BUSINESS
NO CHANGE OF USE

EXISTING CONSTRUCTION TYPE: II B

EXISTING GROSS LEASE AREA: 1,644 SF

TOTAL OCCUPANTS: 11
REFER TO SHEET A001

EXISTING FIRE ALARM SYSTEM: YES

EXISTING FIRE SPRINKLERS: YES

APN: 14820008
ZONING DISTRICT : P(40) SAN ANTONIO PRECISE PLAN

PROJECT SCOPE

INTERIOR RETAIL TENANT IMPROVEMENT; INCLUDING NON-STRUCTURAL PARTITIONS, NEW DROP CEILING MILLWORK AND FINISHES. SCOPE ALSO INCLUDES THE REQUIRED MECHANICAL, ELECTRICAL, AND PLUMBING UPDATES.

SIGNAGE UNDER SEPARATE SCOPE AND NOT INCLUDED IN THIS PERMIT'S SCOPE.

NO EXTERIOR SCOPE INCLUDED UNDER THIS PERMIT.

CODE SUMMARY

APPLICABLE CODES:

BUILDING CODE: 2022 CALIFORNIA BUILDING CODE PART 2; VOLUME 1 AND 2

PLUMBING CODE: 2022 CALIFORNIA PLUMBING CODE

MECHANICAL CODE: 2022 CALIFORNIA MECHANICAL CODE

ELECTRICAL CODE: 2022 CALIFORNIA ELECTRICAL CODE

ENERGY CODE: 2022 CALIFORNIA ENERGY CODE

FIRE AND LIFE SAFETY CODE: 2022 CALIFORNIA FIRE CODE

ACCESIBILITY CODE: 2022 CALIFORNIA BUILDING CODE - CHAPTER 11B

JURISDICTION NOTES

1. STAMPING OF THESE PLANS AND SPECIFICATIONS IS NOT AN APPROVAL TO VIOLATE AND CITY POLICY OR ORDINANCE, COUNTY, STATE OR FEDERAL LAW.

2. MUST OBTAIN DEBRIS BOXES, PLEASE CONTACT RECOLOGY MOUNTAIN VIEW AT (650) 967-3034, OR THE CITY OF MOUNTAIN VIEW PUBLIC WORKS DEPARTMENT FOR REQUIREMENTS AT (650) 903-6311.

3. THE ORIGINAL JOB CARD AND APPROVED CONSTRUCTION PLANS MUST BE ON SITE AT TIME OF EACH INSPECTION. THE CONTRACTOR MUST BE PRESENT AT TIME OF FINAL INSPECTION.

DEFERRED SUBMITTALS

- FIRE SPRINKLER AND ALARM SYSTEM MODIFICATIONS.
- SIGNAGE UNDER SEPARATE PERMIT BY SIGNAGE FABRICATOR

| SHEET # | DESCRIPTION | CD SET | REVISION 01 | REVISION 02 | REVISION 03 |
|---------|-------------|--------|-------------|-------------|-------------|
|---------|-------------|--------|-------------|-------------|-------------|

GENERAL

| | | | | | |
|------|-------------------------------|---|---|--|--|
| T001 | COVER SHEET | ● | ● | | |
| T002 | GENERAL NOTES & ABBREVIATIONS | ● | ● | | |
| T003 | GENERAL NOTES | ● | ● | | |
| T004 | ACCESSIBILITY DETAILS | ● | ● | | |
| T005 | ACCESSIBILITY DETAILS | ● | ● | | |
| T006 | CITY APPROVALS | ● | ● | | |

TOTAL : 6

ARCHITECTURAL

| | | | | | |
|-------|--|---|---|---|--|
| A001 | EXITING AND LIFE SAFETY PLAN | ● | ● | | |
| A002 | SITE PLAN | ● | ● | ● | |
| AD101 | DEMO FLOOR PLAN | ● | ● | | |
| AD102 | DEMO REFLECTED CEILING PLAN | ● | ● | | |
| A101 | FLOOR PLAN | ● | ● | | |
| A111 | FINISH PLAN | ● | ● | | |
| A121 | REFLECTED CEILING PLAN & LIGHTING SCHEDULE | ● | ● | | |
| A221 | INTERIOR ELEVATIONS | ● | ● | | |
| A222 | INTERIOR ELEVATIONS | ● | ● | | |
| A223 | INTERIOR ELEVATIONS | ● | ● | | |
| A301 | ENLARGED RESTROOM PLAN | ● | ● | | |
| A501 | DETAILS | ● | ● | | |
| A502 | DETAILS | ● | ● | | |
| A503 | DETAILS | ● | ● | | |
| A601 | DOOR SCHEDULE | ● | ● | | |
| A602 | FINISH SCHEDULE | ● | ● | | |
| A603 | EXISTING EXTERIOR ELEVATION | ● | ● | | |

TOTAL : 17

| SHEET # | DESCRIPTION | PERMIT | REVISION 01 | REVISION 02 | REVISION 03 |
|---------|-------------|--------|-------------|-------------|-------------|
|---------|-------------|--------|-------------|-------------|-------------|

MECHANICAL

| | | | | | |
|------|---|---|---|--|--|
| M001 | MECHANICAL GENERAL NOTES, SYMBOL LIST & ABBREVIATIONS | ● | ● | | |
| M002 | MECHANICAL SPECIFICATIONS | ● | ● | | |
| M100 | MECHANICAL FLOOR PLAN | ● | ● | | |
| M500 | MECHANICAL DETAILS | ● | ● | | |
| M600 | MECHANICAL SCHEDULES | ● | ● | | |
| M700 | TITLE 24 | | ● | | |
| M701 | TITLE 24 | | ● | | |
| M702 | TITLE 24 | | ● | | |

TOTAL : 8

ELECTRICAL

| | | | | | |
|------|---|---|---|--|--|
| E001 | ELECTRICAL SYMBOLS, ABBREVIATIONS & GENERAL NOTES | ● | ● | | |
| E002 | ELECTRICAL SPECIFICATIONS | ● | ● | | |
| E003 | ELECTRICAL SPECIFICATIONS | ● | ● | | |
| E100 | ELECTRICAL LIGHTING PLAN | ● | ● | | |
| E200 | ELECTRICAL POWER PLAN | ● | ● | | |
| E300 | ELECTRICAL RISER DIAGRAM & PANEL SCHEDULE | ● | ● | | |
| E400 | ELECTRICAL DETAILS | ● | ● | | |
| E500 | TITLE 24 | ● | ● | | |
| E501 | TITLE 24 | ● | ● | | |


TOTAL : 9


PLUMBING

| | | | | | |
|------|---|---|---|--|--|
| P001 | PLUMBING SYMBOLS, ABBREVIATION, AND NOTES | ● | ● | | |
| P002 | PLUMBING SPECIFICATIONS | ● | ● | | |
| P101 | PLUMBING FLOOR PLAN | ● | ● | | |
| P201 | PLUMBING DETAILS | ● | ● | | |
| P202 | PLUMBING RISER AND SCHEDULES | ● | ● | | |
| P301 | TITLE 24 | ● | ● | | |
| P302 | TITLE 24 | ● | ● | | |

TOTAL : 7

VICINITY MAP PLAN

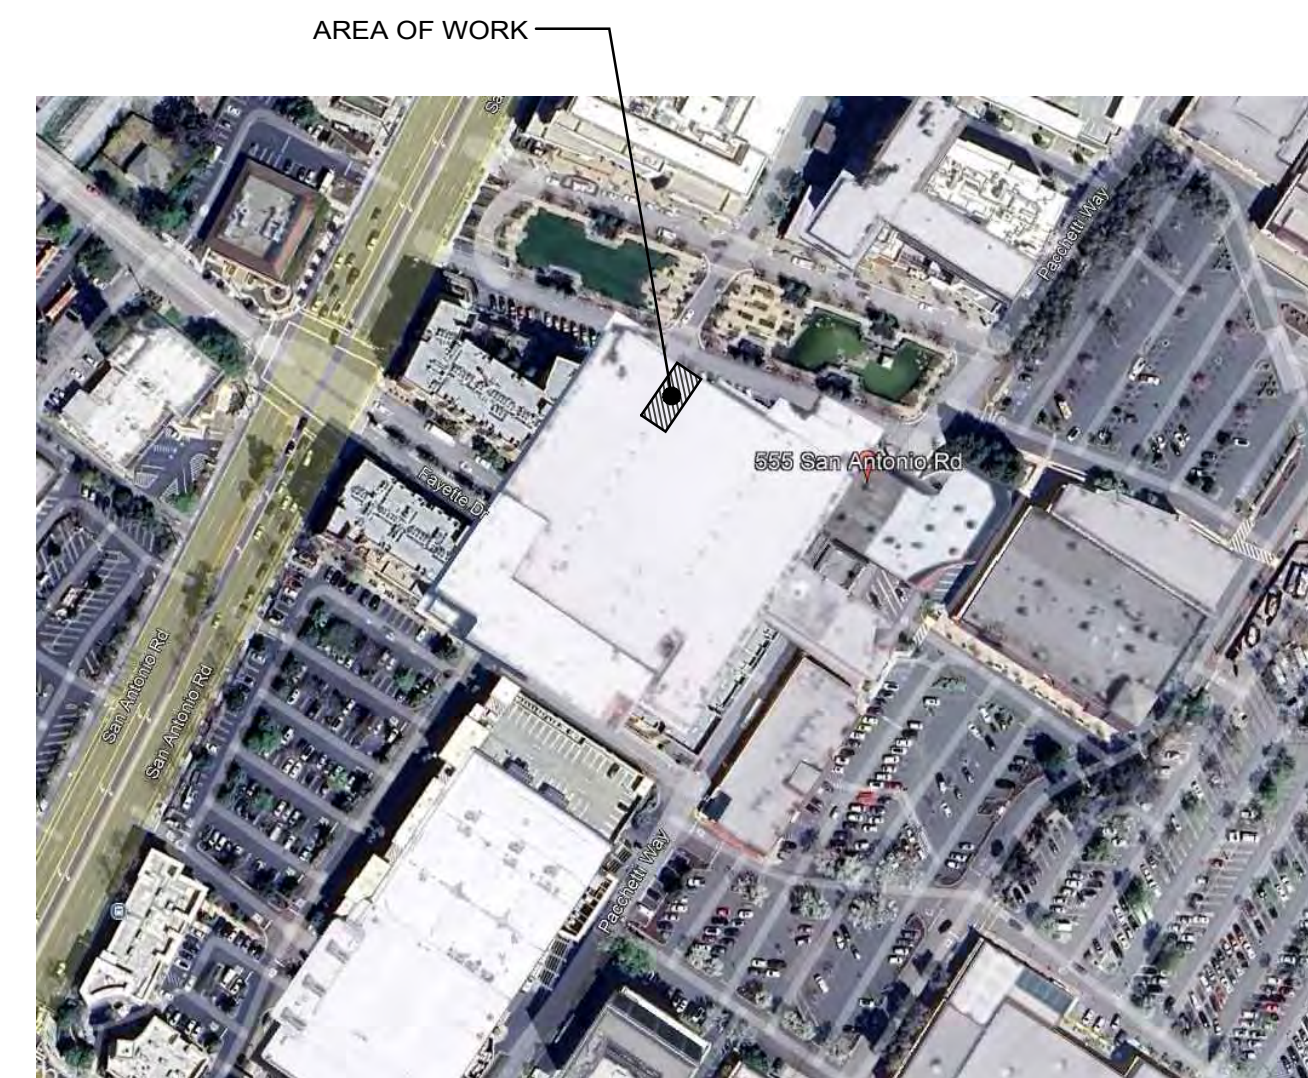

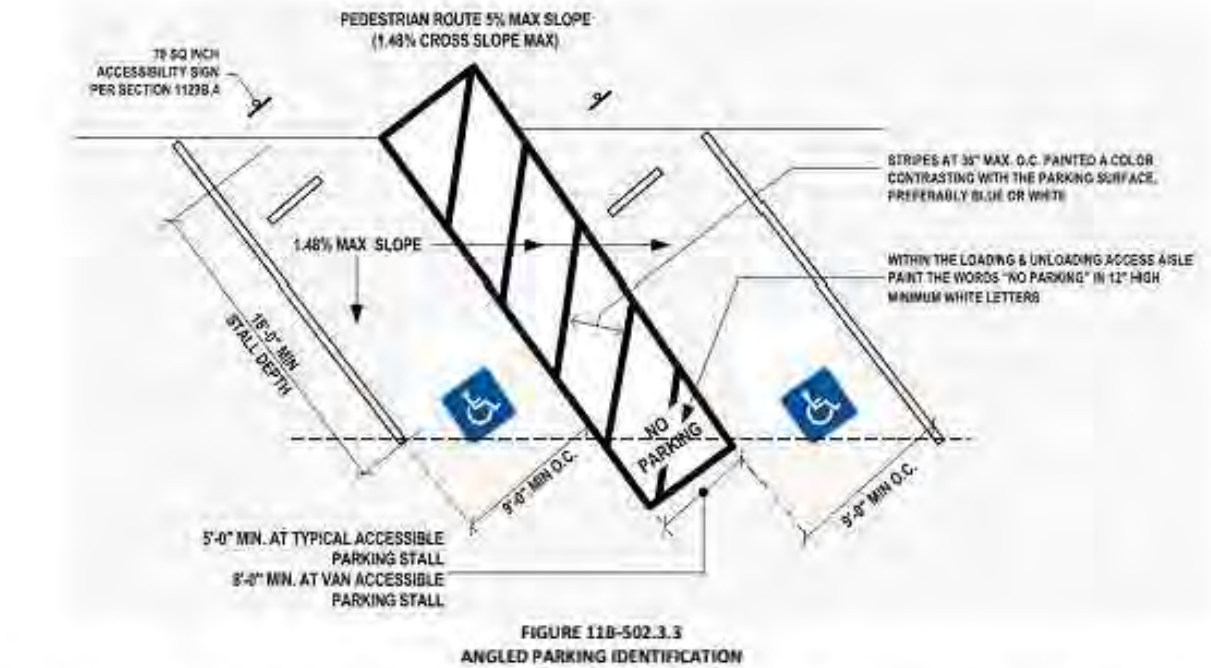

Location. A parking space identification sign shall be visible from each parking space. Signs shall be permanently posted either immediately adjacent to the parking space or within the projected parking space width at the front end of the parking space. Signs may also be permanently posted on a wall at the rear end of the parking space.

Marking. Each accessible car and van space shall have surface identification complying with either Sections 11B-502.6.4.1 or 11B-502.6.4.2.

The parking space shall be marked with an International Symbol of Accessibility complying with Section 11B-703.2.2.1 a minimum 36 inches wide by 36 inches high in white on a blue background contrasting color. The centerline of the International Symbol of Accessibility shall be a maximum of 6 inches from the centerline of the parking space, its sides parallel to the length of the parking space and its lower corner at, or lower side aligned with, the end of the parking space.

The parking space shall be outlined or painted blue and shall be marked with an International Symbol of Accessibility complying with Section 11B-703.2.2.1 a minimum 36 inches wide by 36 inches high in white on a suitable contrasting color. The centerline of the International Symbol of Accessibility shall be a maximum of 6 inches from the centerline of the parking space, its sides parallel to the length of the parking space and its lower corner at, or lower side aligned with, the end of the parking space.

Relationship to accessible routes. Parking spaces and access aisles shall be designed so that cars and vans, when parked, cannot obstruct the required clear width of adjacent accessible routes.

11B-502.7.1 Arrangement. Parking spaces and access aisles shall be designed so that persons using them are not required to travel behind parking spaces other than to pass behind the parking space in which they parked.

11B-502.7.2 Wheel stops. A curb or wheel stop shall be provided if required to prevent encroachment of vehicles over the required clear width of adjacent accessible routes.

11B-502.8 Additional signage. An additional sign shall be posted either:

- 1) in a conspicuous place at each entrance to an off-street parking facility or
- 2) immediately adjacent to on-site accessible parking and visible from each parking space.

11B-502.8.1 Size. The additional sign shall not be less than 17 inches wide by 22 inches high.

11B-502.8.2 Lettering. The additional sign shall clearly state in letters with a minimum height of 1 inch the following:

"Unauthorized vehicles parked in designated accessible spaces not displaying distinguishing placards or special license plates issued for persons with disabilities will be towed away at the owner's expense. Towed vehicles may be reclaimed at: _____ or by telephoning _____"


Blank spaces shall be filled in with appropriate information as a permanent part of the sign. (NOTE: Towing Co.'s Name and Telephone Number must be noted on the detail sheets on the plans).

PASSENGER DROP-OFF AND LOADING ZONES

General. Passenger drop-off and loading zones shall comply with Section 11B-503.

Vehicle pull-up space. Passenger drop-off and loading zones shall provide a vehicular pull-up space 90 inches wide minimum and 20 feet long minimum.

Access aisle. Passenger drop-off and loading zones shall provide access aisles complying with Section 11B-503 adjacent and parallel to the vehicle pull-up space. Access aisles shall adjoin an accessible route and shall not overlap the vehicular way.

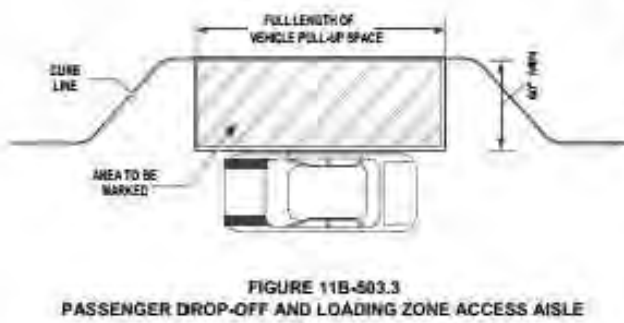

Width. Access aisles serving vehicle pull-up spaces shall be 60 inches wide minimum.

Length. Access aisles shall extend the full length of the vehicle pull-up spaces they serve.

Marking. Access aisles shall be marked with a painted borderline around their perimeter. The area within the borderline shall be marked with hatched lines a maximum of 36 inches on center in a color contrasting with that of the aisle surface.

Floor and ground surfaces. Vehicle pull-up spaces and access aisles serving them shall comply with Section 11B-302. Access aisles shall be at the same level as the vehicle pull-up space they serve. Changes in level are not permitted.

Exception: Slopes not steeper than 1:48 shall be permitted.

Vertical clearance. Vehicle pull-up spaces, access aisles serving them, and a vehicular route from an entrance to the passenger loading zone and from the passenger loading zone to a vehicular exit shall provide a vertical clearance of 114 inches minimum.

Identification. Each passenger loading zone designated for persons with disabilities shall be identified with a reflectized sign complying with Section 11B-703.5. It shall be permanently posted immediately adjacent to and visible from the passenger loading zone stating "Passenger Loading Zone Only" and including the International Symbol of Accessibility complying with Section 11B-703.2.2.1 in white on a dark blue background.

Medical care and long-term care facilities. At least one passenger loading zone complying with Section 11B-503 shall be provided at an accessible entrance to licensed medical care and licensed long-term care facilities where the period of stay may exceed twenty-four hours.


Valet parking. Parking facilities that provide valet parking services shall provide at least one passenger loading zone complying with Section 11B-503. The parking requirements of Section 11B-503.1 apply to facilities with valet parking.

Mechanical access parking garages. Mechanical access parking garages shall provide at least one passenger loading zone complying with Section 11B-503 at vehicle drop-off and vehicle pickup areas.

PARKING SPACES

General. Car and van parking spaces shall comply with Section 11B-502. Where parking spaces are marked with lines, width measurements of parking spaces and access aisles shall be made from the centerline of the markings.


Exception: Where parking spaces or access aisles are not adjacent to another parking space or access aisle, measurements shall be permitted to include the full width of the line defining the parking space or access aisle.

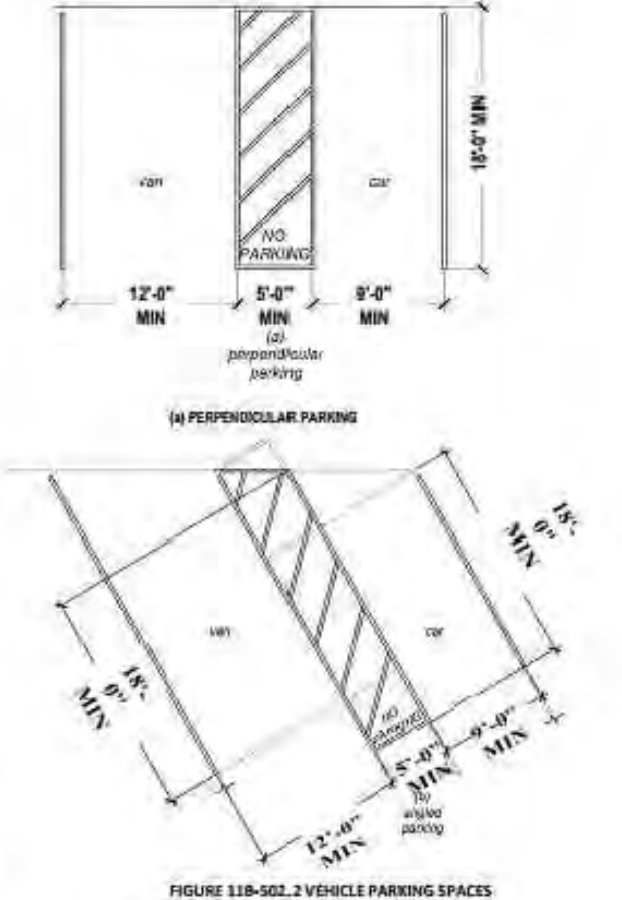

EXISTING ACCESSIBLE PARKING DETAILS

SCALE

2

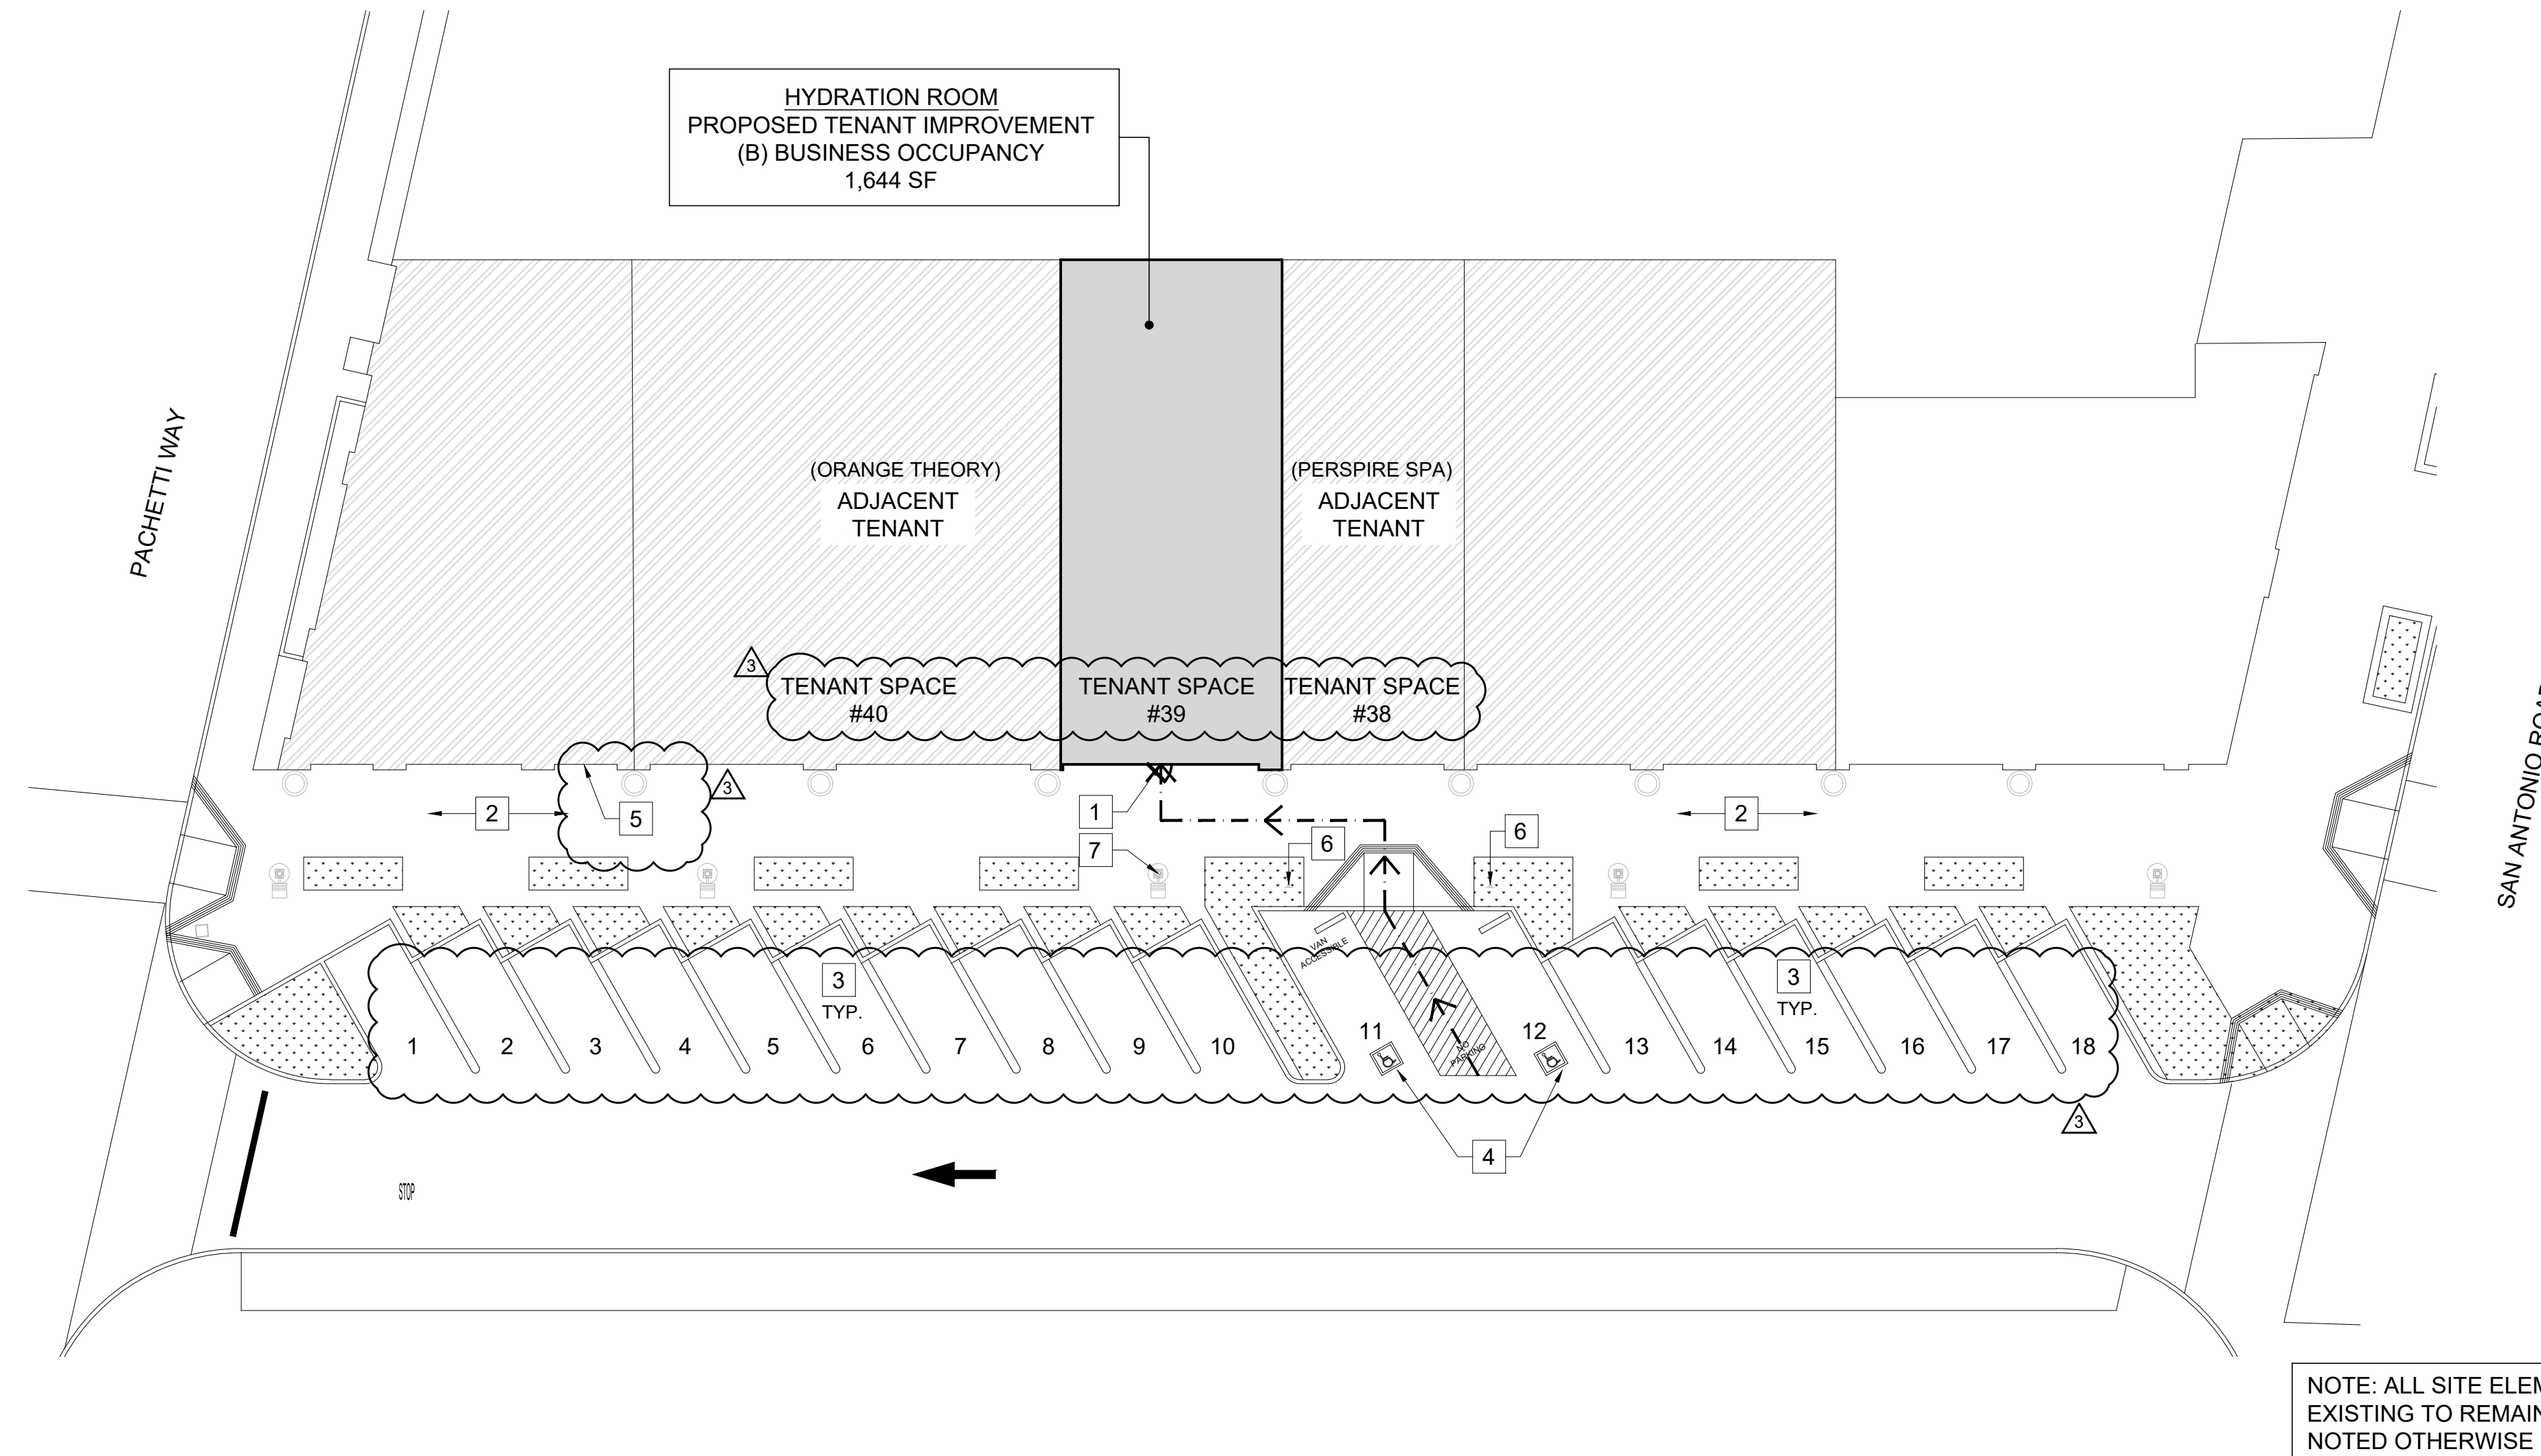

EXISTING SITE PLAN

SCALE

1/16"=1'-0"

1

GENERAL NOTES

SITE TO COMPLY WITH ALL ITEMS NOTED BELOW BY THE CITY OF MOUNTAIN VIEW

A. WALKWAYS AND SIDEWALKS ALONG ACCESSIBLE ROUTES OF TRAVEL (1) ARE CONTINUOUSLY ACCESSIBLE; (2) HAVE MAXIMUM 1/2" CHANGES IN ELEVATION OR PROVIDE CURB RAMPS COMPLYING WITH CBC 11B-406; (3) ARE MINIMUM 48" IN WIDTH AND (4) WHERE NECESSARY TO CHANGE ELEVATION AT A SLOPE EXCEEDING 5% (i.e., 1:20) SHALL HAVE PEDESTRIAN RAMPS COMPLYING WITH CBC 11B-405. CBC 11B-202.4, 11B-206.2.2, 11B-303.1, 11B-403.5, 11B-405 AND 11B-406.

Architect:

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Stamp:



Project Owner:

HYDRATION ROOM
IV AND INJECTION THERAPY

Project Address:

HYDRATION ROOM
555 SAN ANTONIO ROAD
SUITE #39
MOUNTAIN VIEW, CA 94040

CITY DATE AND APPROVAL STAMP

PARKING CALCULATIONS

| USE CLASSIFICATION | LOAD FACTOR | REQUIRED PARKING SPACES | PROVIDED SPACES |
|--------------------|-------------------|--------------------------|-----------------------------|
| B | 1/250 SQUARE FEET | 7 SPACES 1 ACCESSIBLE | 16 STANDARD 2 ACCESSIBLE |

CALCULATIONS PER SANTA CLARA COUNTY MUNICIPAL CODE

NO BICYCLE SPACES REQUIRED: In commercial and industrial projects with 20 or more required parking spaces, a rack or other secure device for storing and protecting bicycle theft shall be installed. The capacity of the secure devices shall be one bicycle per 20 required parking spaces. The devices shall be located so as not to interfere with pedestrian or vehicular traffic.

§ 4.30.040. - Parking spaces required - Non residential uses.

CITY DATE AND APPROVAL STAMP

KEYNOTES

- (E) MAIN ENTRANCE LOCATION
- (E) SIDEWALK
- (E) PARKING STALLS, TYPICAL THROUGHOUT
- (E) ACCESSIBLE PARKING STALL TO COMPLY WITH ALL ITEMS NOTED IN EXISTING ACCESSIBLE PARKING DETAILS
- LOCATION OF (E) KNOX BOX
- LOCATION OF ACCESSIBLE PARKING SIGNAGE. REFER TO EXISTING ACCESSIBLE PARKING DETAILS FOR ADDITIONAL INFORMATION.
- LOCATION OF "UNAUTHORIZED VEHICLES PARKED IN DESIGNATED ACCESSIBLE SPACES" SIGNAGE.

LEGEND

- ACCESSIBLE PATH OF TRAVEL
- SCOPE OF TENANT IMPROVEMENT
- LANDSCAPE & IRRIGATION (EXISTING)

PERMIT SET

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Revisions:

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| 1 | BUILDING DEPT. COMMENTS | 05.15.25 |
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Principal in Charge:

DANIEL K. WISCH

Project Manager:

CARLOS VILLEGAS

Drawn By:

AGC

Project Number


27998

Sheet Title:

SITE PLAN

Sheet Number:

A002

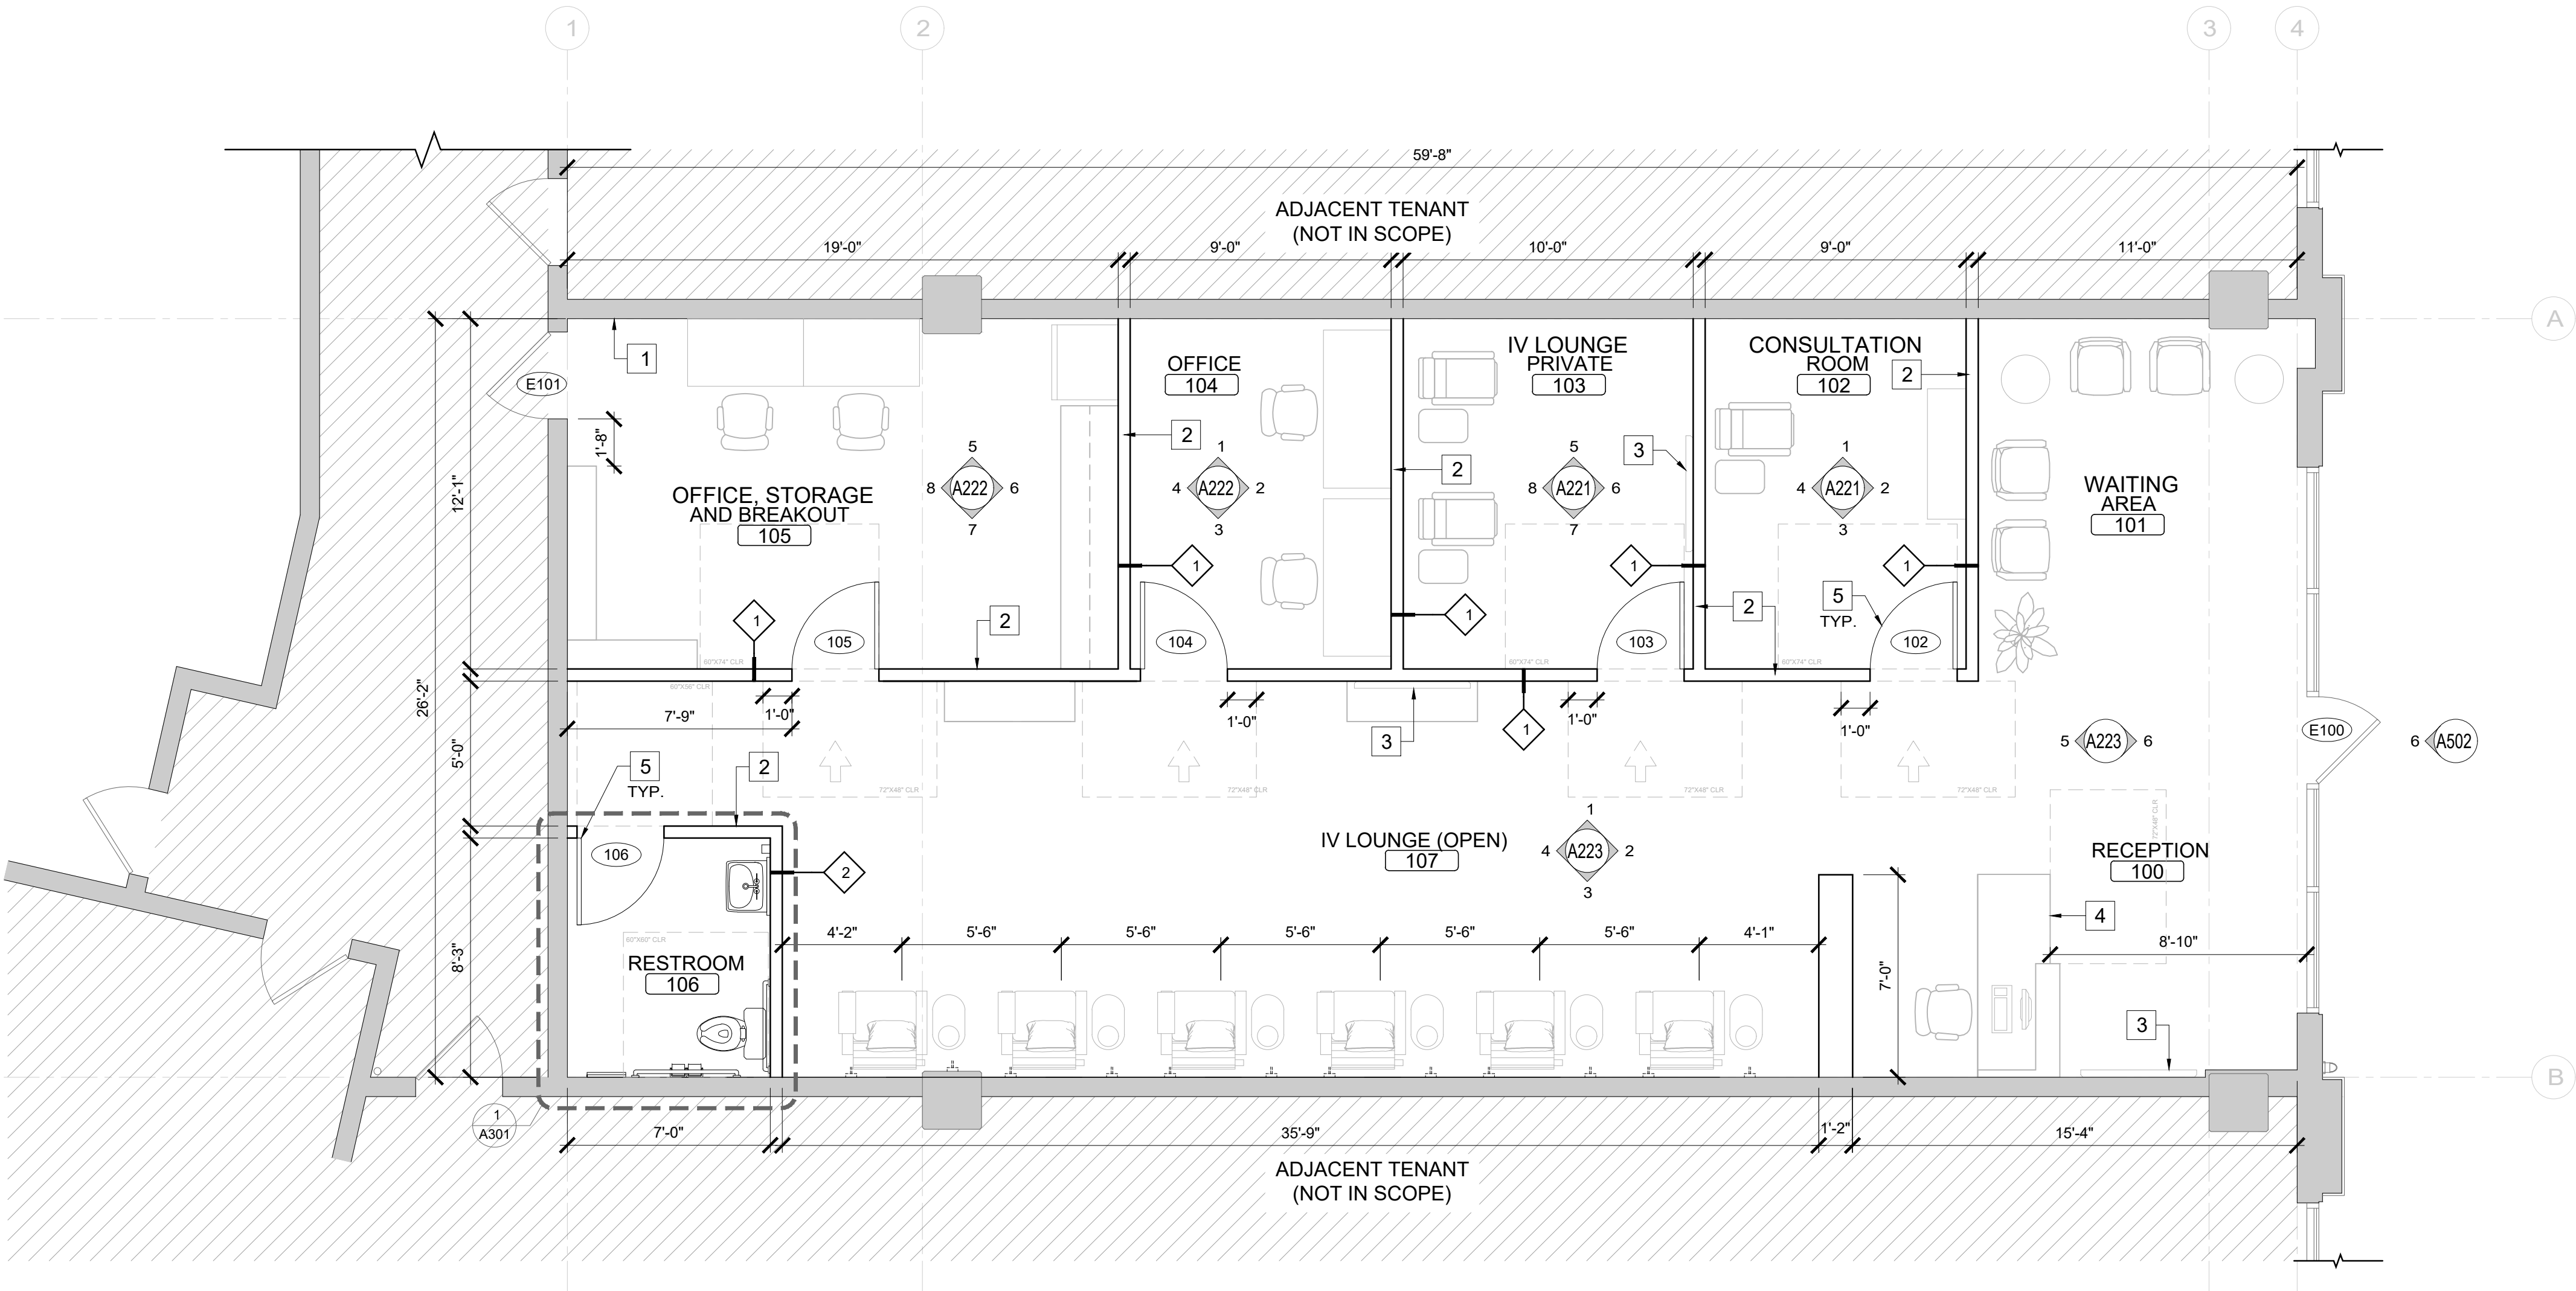

GENERAL NOTES

- DIMENSIONS TAKE PRECEDENCE OVER SCALE ON THE CONSTRUCTION DOCUMENTS. DO NOT SCALE THE DRAWINGS. NOTIFY THE ARCHITECT OF DISCREPANCIES BETWEEN DRAWING CONDITIONS AND FIELD CONDITIONS.
- INTERIOR PARTITIONS ARE DIMENSIONED TO THE FACE OF THE FINISHED WALL UNLESS NOTED OTHERWISE.
- DIMENSIONS FROM ANY CORNER OR WALL TO FRAMING STUD AT A DOOR JAMB OPENING IS TO BE 4 INCHES UNLESS NOTED OTHERWISE.
- PROVIDE BLOCKING FOR ALL WALL MOUNTED EQUIPMENT AND ACCESSORIES. PROVIDE FIRE-RESISTANT BLOCKING WHEN REQUIRED BY CODE.
- ALL PARTITIONS WITH SINKS AND / OR WET EQUIPMENT, ALL WALLS IN TOILET ROOMS AND ALL WALLS IN KITCHEN AREAS TO HAVE 5/8" CEMENT BOARD TO MINIMUM 1'-0" FROM THE FLOOR. THE BALANCE OF WALL SHEATHING IN WET AREAS IS TO BE 5/8" TYPE "X" WATER RESISTANT GYPSUM BOARD UNLESS NOTED OTHERWISE.
- ALL MILLWORK / PUBLIC SERVICE COUNTERS TO BE 34" AFF MAXIMUM.
- CONTRACTOR SHALL BE RESPONSIBLE FOR MAINTAINING INTEGRITY OF RATED PARTITIONS AND STRUCTURES INCLUDING ALL PENETRATIONS AS REQUIRED BY OTHERS TRADES.
- REFER TO FINISH SCHEDULE AND DETAILS FOR APPLIED WALL, CEILING AND FLOOR FINISHES.

KEY NOTES

- EXISTING EXTERIOR WALL OR NON-BEARING DEMISING PARTITION COMMON WITH ADJACENT SUITE. PATCH AND REPAIR GYPSUM BOARD FINISH WHERE REQUIRED DUE TO DEMOLITION. WHERE GYPSUM BOARD IS DAMAGED OR WHERE SCHEDULED SERVICES ARE TO BE INSTALLED IN WALL CAVITIES TO MATCH SMOOTH WALL FINISH READY FOR SCHEDULED PAINT FINISH.
- NEW 3 5/8" METAL STUD INTERIOR WALL PARTITION. USE 6" METAL STUD AS REQUIRED AT RESTROOM DOOR WALL TO ALIGN WITH EXISTING CONSTRUCTION. INSTALL R-13 BATT INSULATION IN CAVITIES FOR SOUND ATTENUATION BETWEEN ROOMS OR AREAS. SEE DETAILS - FOR STUD GAUGES, SPACING AND ADDITIONAL NOTES AND INFORMATION.
- PROPOSED LOCATION FOR TENANT-PROVIDED AND INSTALLED MONITOR TV. COORDINATE ALL LOCATIONS, MOUNTING HEIGHTS, SERVICE REQUIREMENTS, AND MONITOR SIZE AND WEIGHT WITH TENANT. IF REQUIRED, PROVIDE ADEQUATE BACKING FOR MONITOR BRACKET.
- TENANT-SUPPLIED FURNITURE / SERVICE COUNTER. A PORTION OF THE SERVICE COUNTER SHALL BE AT LEAST 36 INCHES LONG WITH A MAXIMUM HEIGHT IF 34 INCHES ABOVE FINISHED FLOOR, IN COMPLIANCE WITH C.B.C. 11B-904.4.
- ALL DOORS TO BE INSTALLED WITH A 4" OFFSET FROM ADJACENT PERPENDICULAR WALLS, UNLESS NOTED OTHERWISE. COORDINATE WITH DOOR FRAME TYPES, SWING CLEARANCES, AND ADJACENT FINISHES.

LEGEND

- EXISTING WALL
- NEW WALL
- PARTITION TYPE DESIGNATION. SEE PARTITION TYPES FOR DETAILS.
- DOOR IDENTIFICATION
- ROOM NAME
- ROOM NUMBER
- KEYNOTE
- SECTION MARKER

PARTITION LEGEND

- EXISTING PARTITION (1-HR RATED)
- NEW PARTITION (NON RATED)
- ADJACENT TENANT

Architect:

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ARCHITECTURE
A California Corporation

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Principal in Charge:

DARIUSZ K. WIECH
Project Manager:
CARLOS VILLEGAS

Drawn By:

AEC

Project Number 27998

Sheet Title:

FLOOR PLAN

Sheet Number:

A101

FLOOR PLAN

SCALE
1/4" = 1'-0"

1

GENERAL NOTES

- 1. NO MATERIAL SUBSTITUTIONS TO BE MADE WITHOUT APPROVAL FROM ARCHITECT AND/OR OWNER'S REPRESENTATIVE.
- 2. INSTALL FRP PANELS COMPLETE WITH ALL TRIM AND ACCESSORIES PER MANUFACTURER'S INSTRUCTIONS.
- 3. PROVIDE PROPER PROTECTION AGAINST DAMAGE TO ALREADY INSTALLED FIXTURES, FURNITURE, ADJACENT FINISHED WORK OR FLOORING.
- 4. ALL CRACKS, HOLES OR OTHER IMPERFECTIONS IN EXISTING GYPSUM BOARD SURFACES ARE TO BE PATCHED AND REPAIRED AS REQUIRED TO RECEIVE SCHEDULED FINISHES.
- 5. ALL PAINTED SURFACES TO RECEIVE (1) COAT PRIMER AND (2) COATS FINISH PAINT (MINIMUM) WITH ADDITIONAL COATS AS REQUIRED FOR PROPER COVERAGE.
- 6. PAINT CEILING OR SIGNAGE ACCESS PANELS TO MATCH ADJACENT FINISHES WHERE REQUIRED.
- 7. WALL COVERINGS TO BE INSTALLED ACCORDING TO MANUFACTURER'S SPECIFICATIONS: PREPARE, CLEAN AND PRIME SUBSTRATE AS REQUIRED.
- 8. PREPARE, CLEAN AND LEVEL THE EXISTING CONCRETE SLAB TO RECEIVE FLOORING FOR A FLUSH, SMOOTH FINISH.
- 9. SEAL ALL PENETRATIONS OF WALLS THAT ARE OPEN TO THE UNDERSIDE OF THE STRUCTURAL DECK.
- 10. REFER TO THE PLUMBING DRAWINGS FOR ALL FLOOR DRAINS AND FLOOR SINKS.
- 11. THE CONTRACTOR WILL BE RESPONSIBLE FOR COORDINATING DELIVERY LEAD TIMES FOR ALL FINISH MATERIALS.

KEY NOTES

- 1 REFER TO FINISH SCHEDULE FOR PAINT SPECIFICATIONS

SYMBOL LEGEND

| | |
|--|---|
| | WALL FINISH: LINE INDICATES EXTENT OF FINISH |
| | FLOOR TRANSITION |

Architect:

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PERMIT SET

Issue Date:

05.08.25

Revisions:

| ... | DESCRIPTION | DATE |
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| | | |

Principal in Charge:

DARIUSZ K. WIECHA

Project Manager:

CARLOS VILLEGAS

Drawn By:

AEC


Project Number 27998

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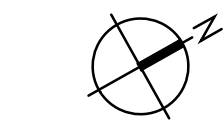
FINISH PLAN

Sheet Number:

A111

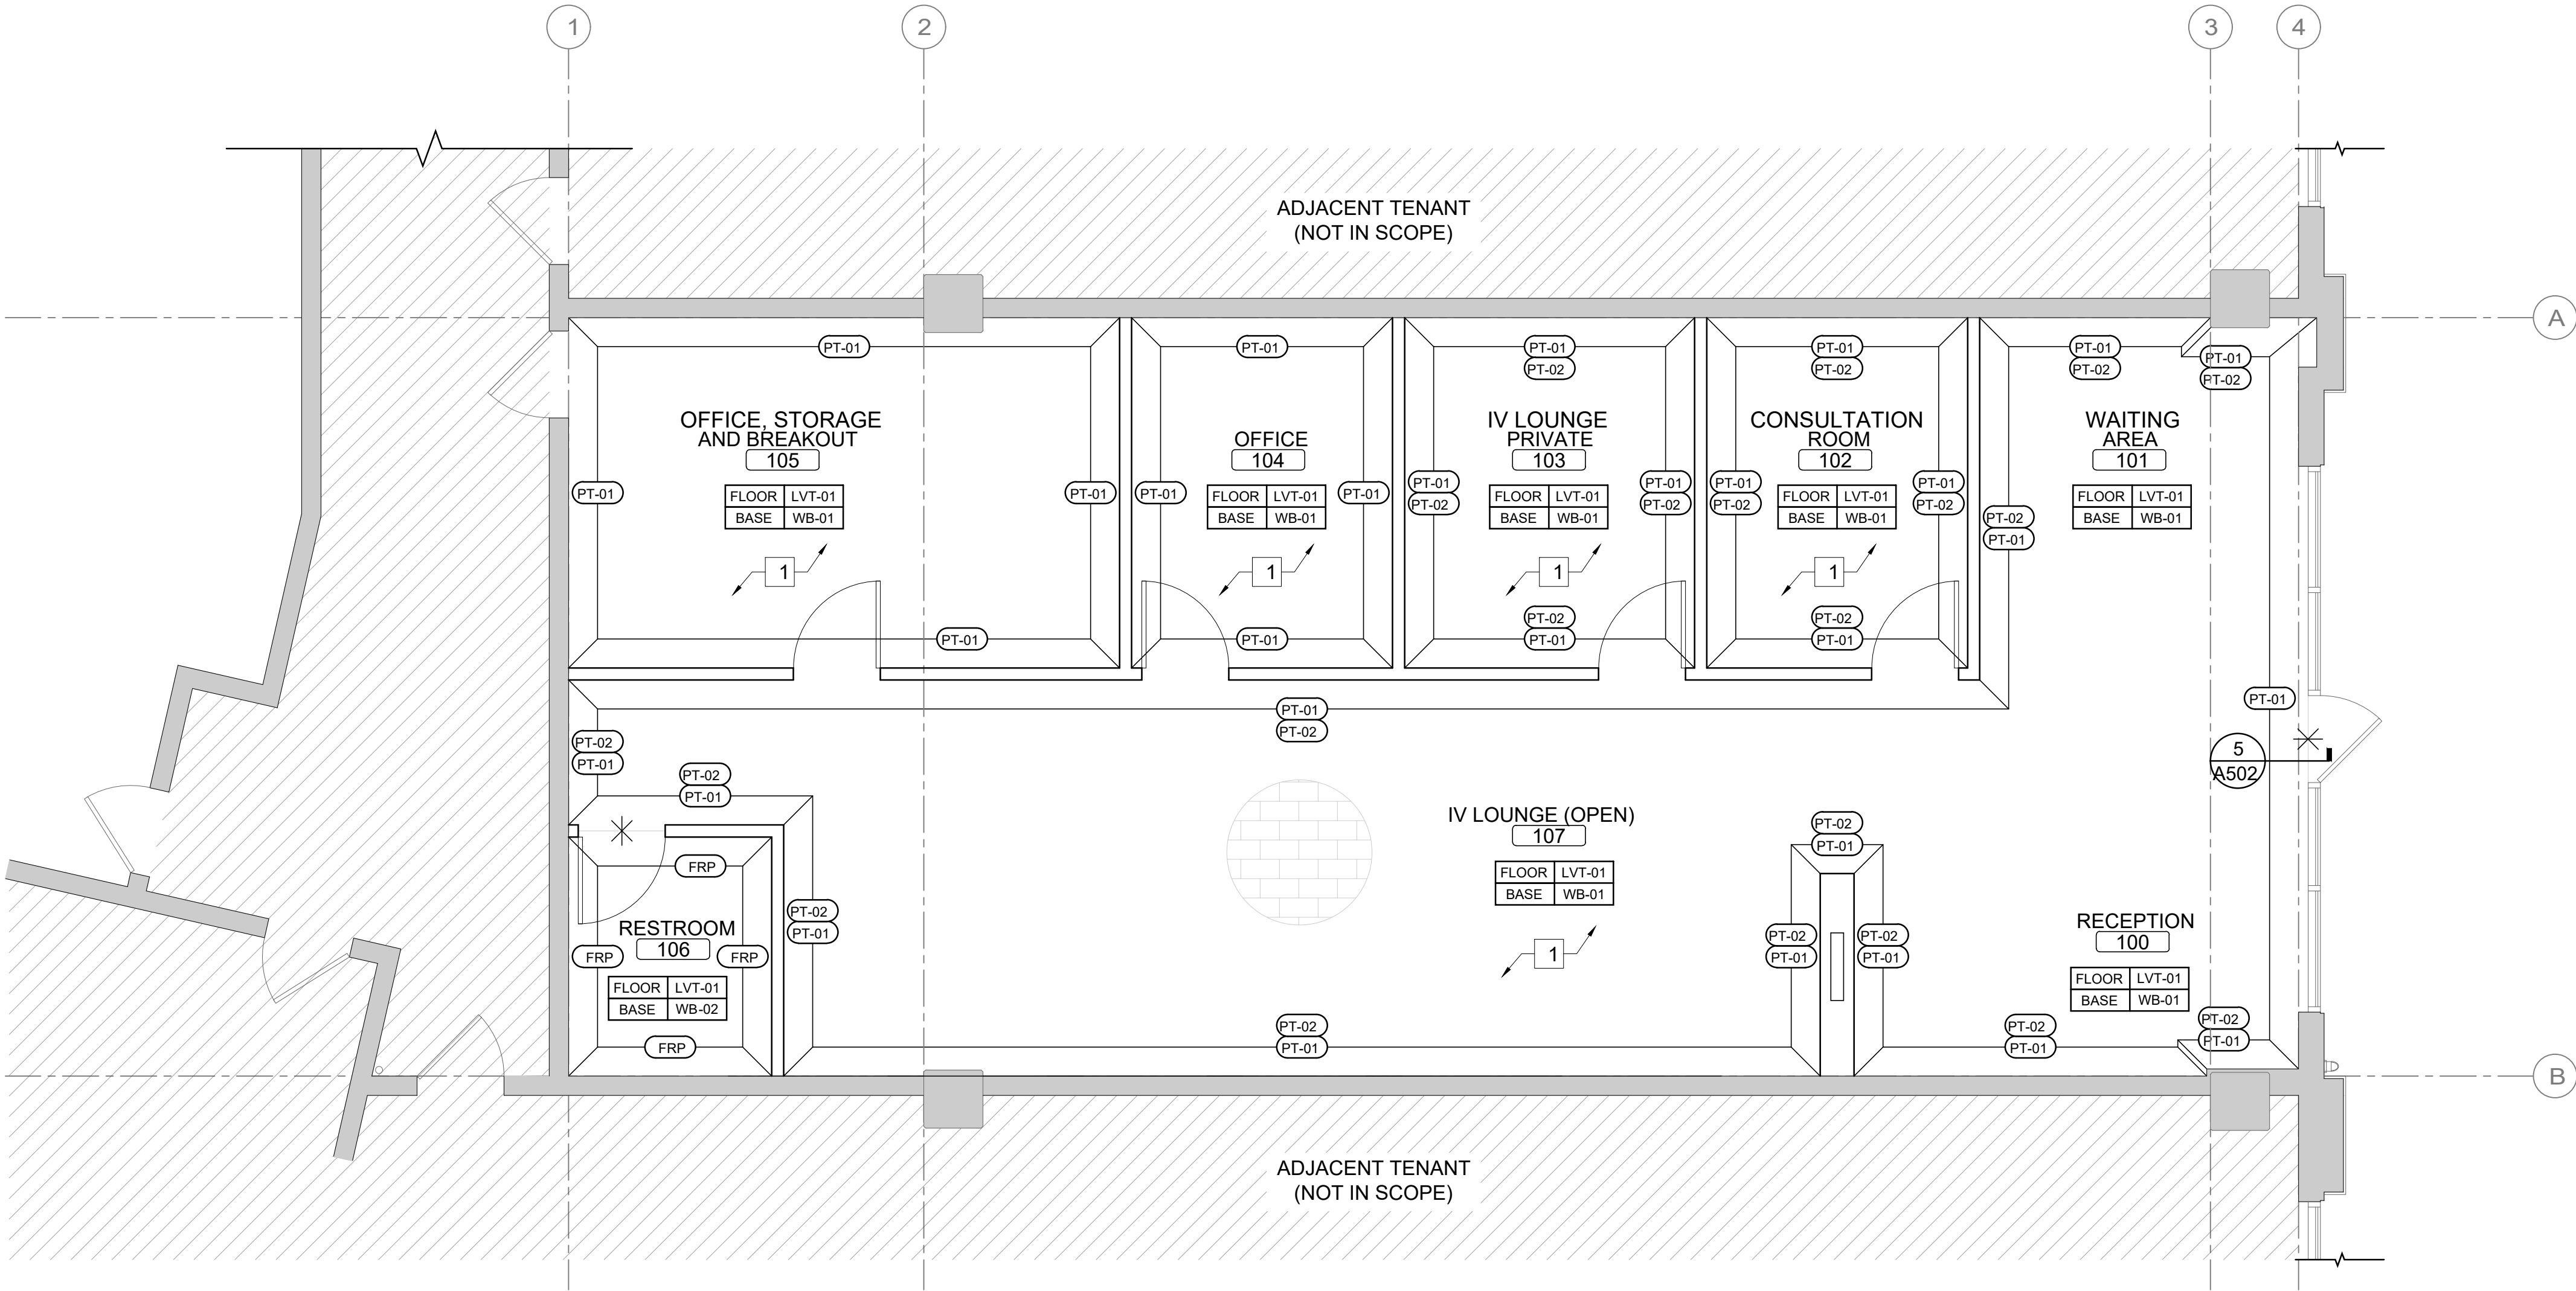

FINISH PLAN



SCALE
1/4" = 1'-0"

1

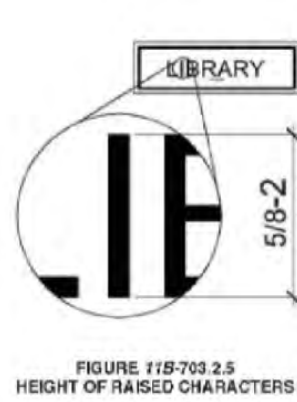


FIGURE 11B-703.2.5
HEIGHT OF RAISED CHARACTERS

11B-703 Signs

11B-703.1 General. Signs shall comply with Section 11B-703. Where both visual and tactile characters are required, either one sign with both visual and tactile characters, or two separate signs, one with visual, and one with tactile characters, shall be provided.

11B-703.1.1 Plan review and inspection. Signs as specified in Section 11B-703, or in other sections of this code, when included in the construction of new buildings or facilities, or when included, altered or replaced due to additions, alterations or renovations to existing buildings or facilities, and when a permit is required, shall comply with Sections 11B-703.1.1.1 and 11B-703.1.1.2.

11B-703.1.1.1 Plan review. Plans, specifications or other information indicating compliance with these regulations shall be submitted to the enforcing agency for review and approval.

11B-703.1.1.2 Inspection. Signs and identification devices shall be field inspected after installation and approved by the enforcing agency prior to the issuance of a final certificate of occupancy per Chapter 1, Division II, Section 111, or final approval where no certificate of occupancy is issued. The inspection shall include, but not be limited to, verification that Braille dots and cells are properly spaced and the size, proportion and type of raised characters are in compliance with these regulations.

| TABLE 11B-703.3.1 BRAILLE DIMENSIONS | |
|--|--|
| MEASUREMENT RANGE | MINIMUM IN INCHES MAXIMUM IN INCHES |
| Dot base diameter | 0.099 – 0.393 |
| Distance between two dots in the same cell | 0.193 |
| Distance between corresponding dots in adjacent cells | 0.383 |
| Dot height | 0.025 – 0.037 |
| Distance between corresponding dots from one cell directly below | 0.383 – 0.408 |

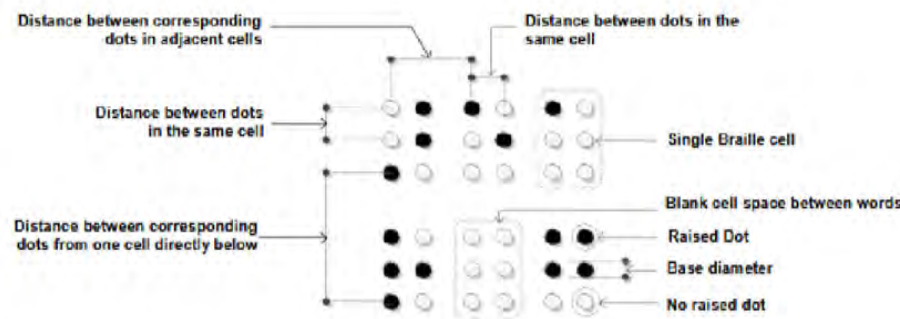


FIGURE 11B-703.3.1
BRAILLE MEASUREMENT



FIGURE 11B-703.7.2.1
INTERNATIONAL
SYMBOL OF
ACCESSIBILITY
(ISA)

The International Symbol of Accessibility shall comply with Figure 11B-703.7.2.1. The symbol shall consist of a white figure on a blue background. The blue shall be FS 15099 in Federal Standard 595C.



FIGURE 11B-703.3.2
POSITION OF BRAILLE

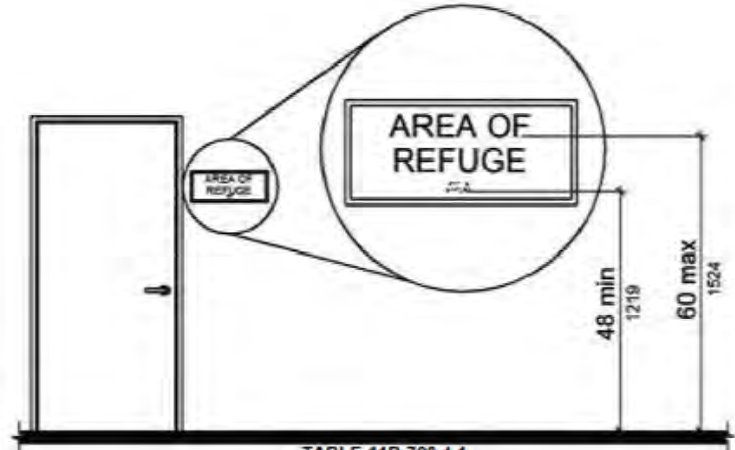


TABLE 11B-703.4.1
HEIGHT OF TACTILE CHARACTERS
ABOVE FINISH FLOOR OR GROUND


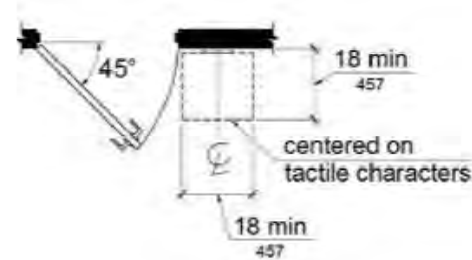


FIGURE 11B-703.4.2
LOCATION OF TACTILE SIGNS AT DOORS

SIGNAGE DETAILS

SCALE
NTS

2

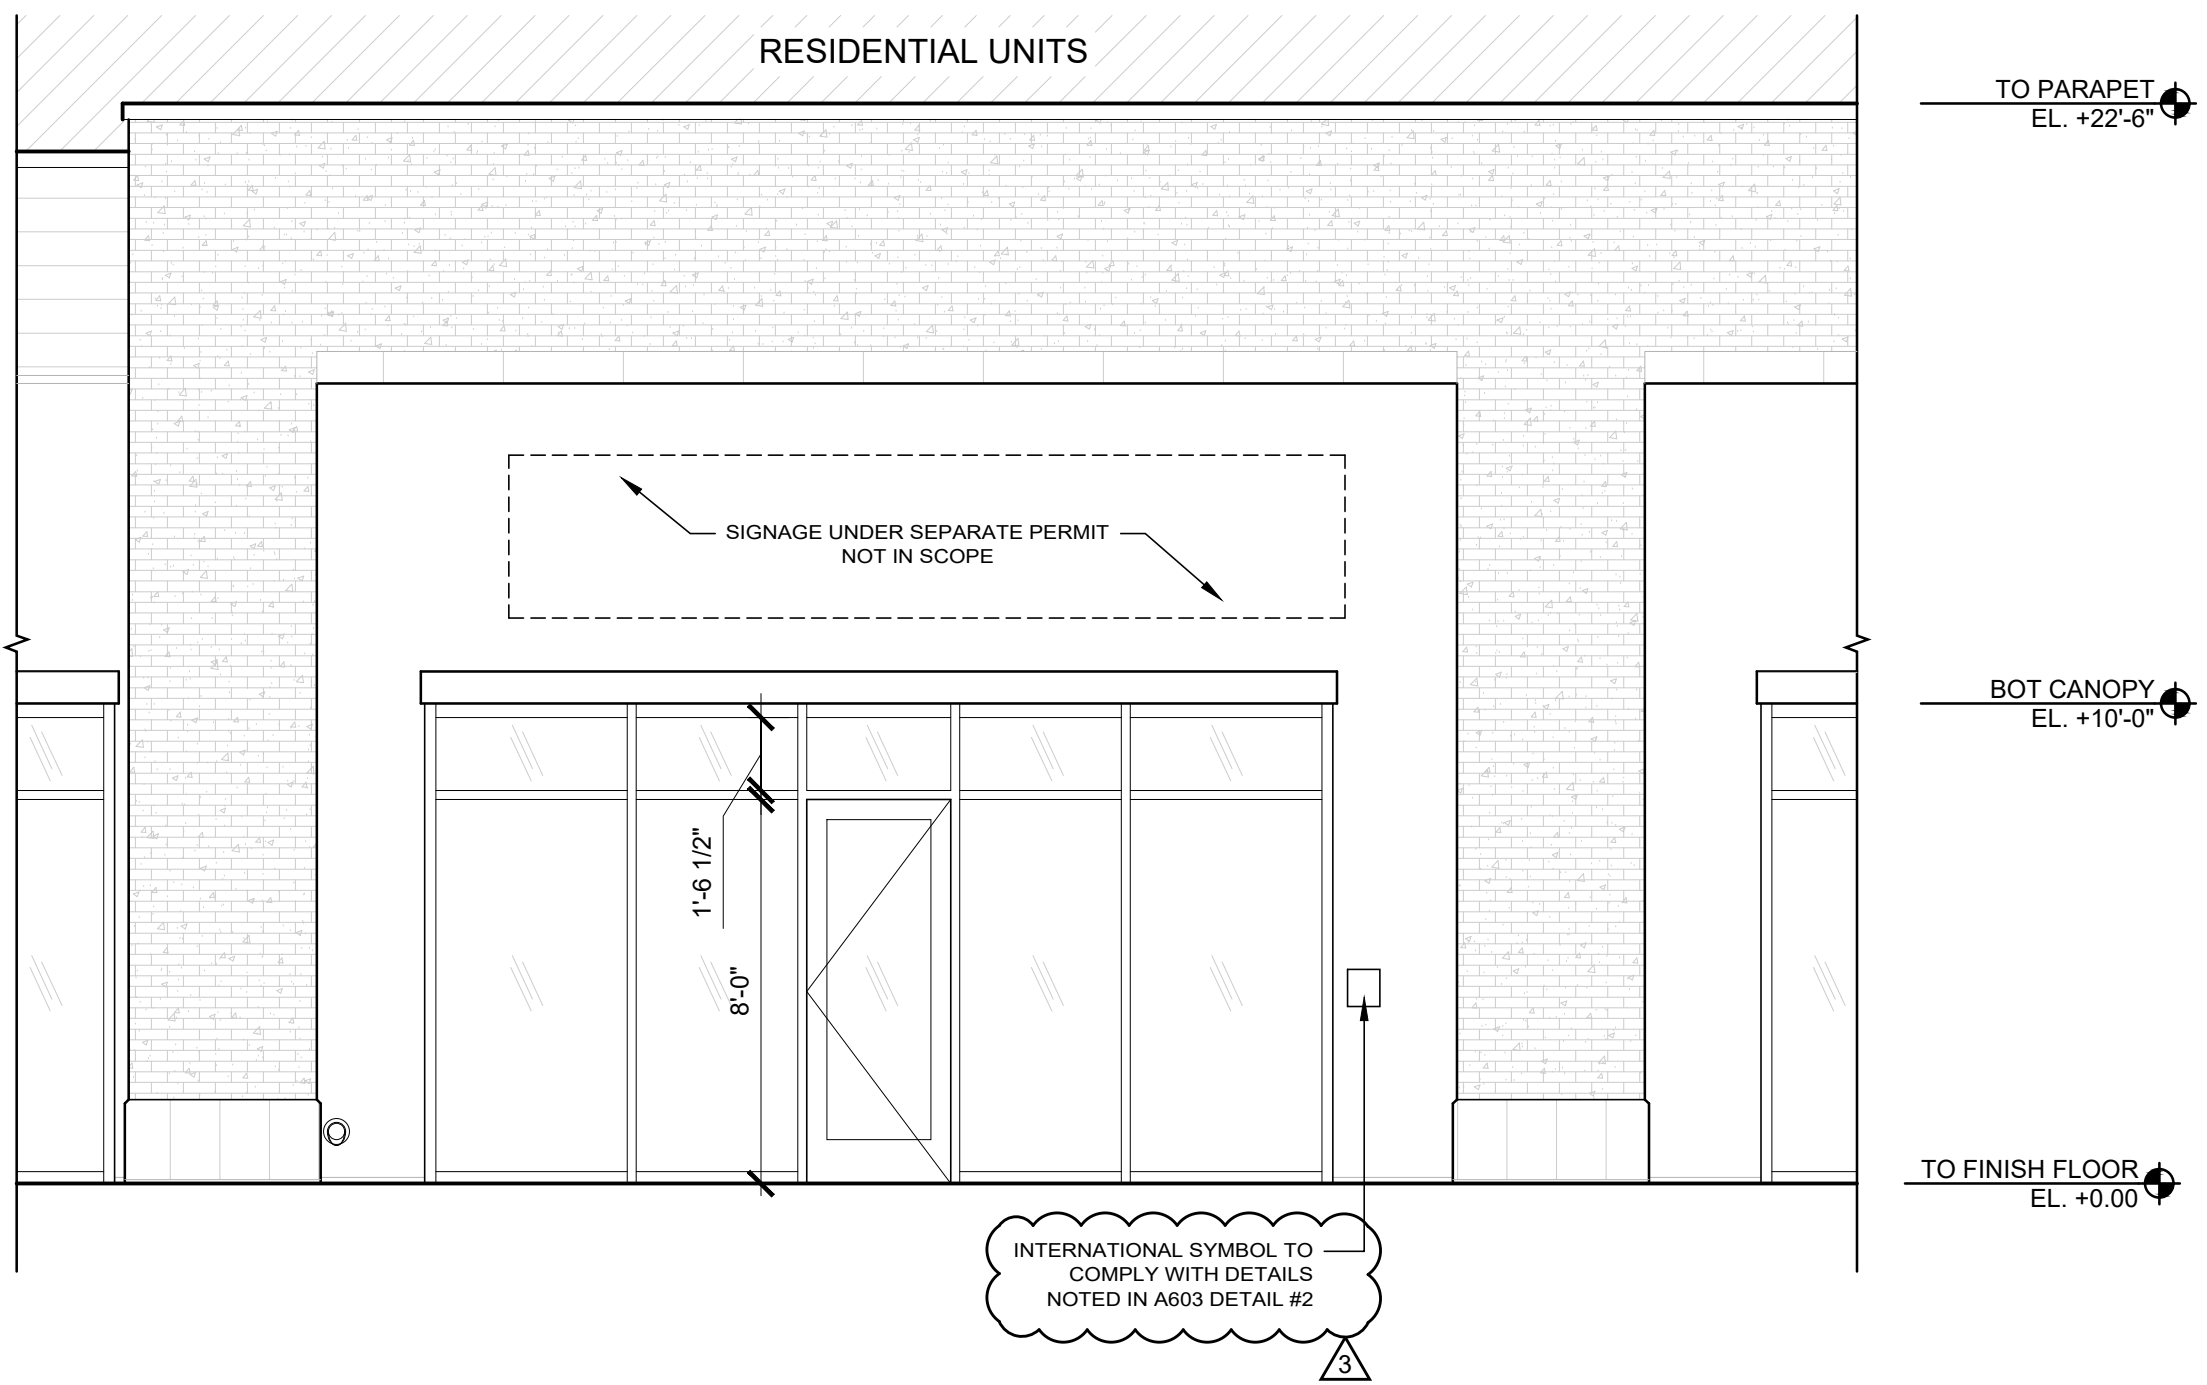

INTERNATIONAL SYMBOL TO
COMPLY WITH DETAILS
NOTED IN A603 DETAIL #2

NOTE: ALL ELEMENTS IN ELEVATION
ARE EXISTING TO REMAIN, UNLESS
NOTED OTHERWISE

EXISTING EXTERIOR ELEVATION

SCALE
1/4\"/>

1

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Stamp:



Project Owner:

HYDRATION ROOM
— IV AND INJECTION THERAPY —

Project Address:

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CITY DATE AND APPROVAL STAMP

CITY DATE AND APPROVAL STAMP

PERMIT SET

Issue Date:

05.08.25

Revisions:

| NO. | DESCRIPTION | DATE |
|-----|-------------------------|----------|
| 1 | BUILDING DEPT. COMMENTS | 05.15.25 |
| 2 | BUILDING DEPT. COMMENTS | 06.26.25 |
| 3 | BUILDING DEPT. COMMENTS | 07.25.25 |

Principal in Charge:

Project Manager:
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Drawn By:

AEC

Project Number 27998

Sheet Title:

EXTERIOR
ELEVATIONS

Sheet Number:

A603